GENERAL NOTES

THE ARCHITECT AND HIS AUTHORIZED REPRESENTATIVES AND AGENTS SHALL HAVE ACCESS TO AND BE PERMITTED TO INSPECT ALL WORK, MATERIALS AND OTHER RELEVANT DATA AND RECORDS WHEREVER THEY ARE IN PREPARATION AND PROGRESS. WHEN REQUESTED, THE CONTRACTOR SHALL FURNISH DUPLICATE COPIES OF THE AFOREMENTIONED DATA.

THE GENERAL CONTRACTOR WILL MAKE EVERY EFFORT TO EXPEDITIOUSLY COORDINATE ALL PHASES OF THE WORK TO OBTAIN THE END RESULT WITHIN THE FULL PURPOSE AND INTENT OF THE DRAWINGS FOR THE PROJECT.

ANY DISCREPANCIES IN THE CONSTRUCTION DOCUMENT DRAWINGS OR SPECIFICATIONS SHALL BE BROUGHT TO THE ARCHITECT'S / CONTRACTOR'S ATTENTION PRIOR TO COMMENCEMENT OF WORK OR CONSTRUCTION, SO THAT CORRECTIVE MEASURES MAY BE TAKEN. ANY UNFORESEEN CONDITIONS IN FIELD AFFECTING THE DESIGN CONCEPT OF THE BUILDING, OR THAT ARE IN CONFLICT WITH THE DRAWINGS SHALL BE BROUGHT TO THE ARCHITECT'S ATTENTION.

ALL CONSTRUCTION SHALL BE IN ACCORDANCE WITH THE FLORIDA BUILDING CODE 2020 EDITION AND ALL APPLICABLE NATIONAL, STATE, AND LOCAL RULES, REGULATIONS AND ORDINANCES.

ALL WORK DONE UNDER THE SUPERVISION OF THE GENERAL CONTRACTOR IS TO BE DONE IN A NEAT AND WORKMANLIKE MANNER.

THE GENERAL CONTRACTOR SHALL VERIFY ALL DIMENSIONS AND CONDITIONS IN THE FIELD, AND SHALL COORDINATE WORK OR CONSTRUCTION BETWEEN TRADES. THE CONTRACTOR SHALL SUBMIT FOR APPROVAL BY THE ARCHITECT

SIX (6) PRINTS OF DETAIL SHOP DRAWINGS OF ALL APPLICABLE CONSTRUCTION, SUCH DRAWINGS SHALL SHOW THE DESIGN, DIMENSIONS CONNECTIONS AND OTHER DETAILS NECESSARY TO INSURE THAT THEY ACCURATELY INTERPRET THE DRAWINGS. THE CONTRACTOR WILL RETAIN RESPONSIBILITY FOR FURNISHING THE MATERIALS, APPARATUS, DEVICES, ETC. OF PROPER DIMENSION, SIZE, QUANTITY, AND QUALITY AS SHOWN ON THE DRAWINGS AND THE RESPONSIBILITY FOR ANY ERRORS OF THE SHOP DRAWINGS. ALLOW TWO WEEKS FOR REVIEW TIME.

PROVIDE 3-1/2" BATT SOUND INSULATION AT INTERIOR WALLS - BATHROOMS, BEDROOMS, LAUNDRY ROOMS ETC.

THE DRAWINGS ARE NOT INTENDED TO SHOW EVERY MINOR DETAIL OF CONSTRUCTION. THE CONTRACTOR IS EXPECTED TO FURNISH ALL ITEMS FOR A COMPLETE ELECTRICAL, MECHANICAL, PLUMBING AND TELEPHONE SYSTEM AND MEET ALL REQUIREMENTS NECESSARY FOR EQUIPMENT TO BE PLACED IN PROPER WORKING ORDER IN CONFORMANCE WITH LOCAL STANDARDS AND APPLICABLE CODES HAVING JURISDICTION.

DIMENSIONS INDICATED ON THE PLANS ARE FROM FACE OF FINISH WALL. VERIFY ALL DIMENSIONS IN FIELD PRIOR TO BEGINNING WORK. USE FIGURED DIM. ONLY. DO NOT SCALE DRAWINGS. DO NOT DEVIATE FROM THE WRITTEN DIM. MORE THAN I" WITHOUT WRITTEN PERMISSION FROM THE ARCHITECT. DEVIATION IS NOT PERMITTED WHERE "CLEAR" OR "HOLD" DIMENSIONS ARE INDICATED NOTIFY ARCHITECT OF ANY DIMENSIONAL DISCREPANCIES IN THE PLANS OR SPECS.

THE INTERPRETATION OF DRAWINGS, SPECIFICATIONS, OR OTHER BIDDING DOCUMENTS SHALL NOT BE MADE VERBALLY TO THE BIDDER. IF THE BIDDER IS IN DOUBT AS TO THE MEANING OF ANY DISCREPANCIES OR CONFLICT HERE IN, THE BIDDER SHALL TELEPHONE OR SUBMIT IN WRITING TO THE ARCHITECT A REQUEST FOR INTERPRETATION. IN THE EVENT THAT THE BIDDER IS DEMANDED TO HAVE ESTIMATED, THEN THE MOST EXPENSIVE WAY OF PERFORMING. THE WORK SHALL TAKE PRECEDENCE.

THESE DOCUMENTS, AS INSTRUMENTS OF SERVICE, ARE THE PROPERTY OF THE ARCHITECT AND MAY NOT BE USED OR REPRODUCED WITHOUT EXPRESSED PRIOR WRITTEN CONSENT FROM THE ARCHITECT.

THE CONTRACTOR SHALL BE RESPONSIBLE FOR THE COORDINATION OF ALL

THE CONTRACTOR SHALL PROVIDE ALL ELEMENTS OF ALL SYSTEMS SO THAT THEY ARE COMPLETE AND FULLY FUNCTIONING (EXCEPT AS NOTED HEREIN).

DO NOT SCALE THE DRAWINGS.

ALL AREA CALCULATIONS ARE APPROXIMATE.

FIELD VERIFY ALL DIMENSIONS.

ALL INTERIOR FINISHES TO BE SUPPLIED BY CONTRACTOR AND APPROVED BY OWNER, U.N.O.,

THE CONTRACTOR SHALL PROVIDE THE OWNER/ ARCHITECT WITH A WORK SCHEDULE AND ANY ANTICIPATED CHANGES THAT MAY OCCUR IN IT.

THE CONTRACTOR SHALL BE RESPONSIBLE TO THE OWNER/ARCHITECT FOR THE ACTS AND OMISSIONS OF ITS COMPLETION OF THE WORK.

NO SUBSTITUTIONS SHALL BE MADE WITHOUT WRITTEN APPROVAL OF THE

DETAILS MARKED AS TYPICAL APPLY TO SIMILAR CONDITIONS INCLUDING CONDITIONS NOT MARKED AS SIMILAR, UNO. TYPICAL DETAILS NOT SHOWN BUT NECESSARY FOR CONFORMANCE WITH APPLICATION.

PROVIDE A WEATHER-RESISTIVE BARRIER AT ALL OPENINGS AND PENETRATIONS OF THE BUILDING ENVELOPE. WATERPROOF ALL WEATHER-EXPOSED SURFACES AND INSTALL ALL THERMAL BARRIERS AS TO FORM A COMPLETE INSULATING BLANKET AROUND THE HEATED AREAS OF THE BUILDING, INSULATE ALL HEAT-BEARING PIPES, DUCTS, OR OTHER FIXTURES THAT PENETRATE THE INSULATED BLANKET. INSTALL ALL OTHER WATER PIPES IN A MANNER TO PREVENT FREEZING.

ALL WOOD IN CONTACT WITH CONCRETE OR MASONRY TO BE PRESSURE TREATED. ALL METAL FASTENERS, NAILS, AND BOLTS TO BE HOT DIPPED GALVANIZED. FLASHING, CRICKETS, DRIPS, ETC. TO BE 16 OZ. COPPER, OR SIMILAR MATERIAL TO ROOFING SYSTEM.

PROVIDE FIRE STOPPING AT ROOF, WALLS, AND CEILING AS REQUIRED. ELEVATIONS ARE TAKEN FROM AN ASSUMED DATUM OF 0'-0" TOP OF CONCRETE SLAB. (1825' N.A.V.D. FOR GROUND LEVEL)

THESE PLANS AS DRAWN AND NOTED COMPLY WITH THE BUILDING ENVELOPE ENERGY CODE REQUIREMENTS OF THE FLORIDA MODEL ENERGY CODE. CONTRACTOR SHALL FAMILIARIZE HIMSELF WITH THE GOVERNING CODE IN ITS ENTIRETY AND BUILD IN ACCORDANCE WITH ALL PROVISIONS OF THIS CODE WHICH MAY NOT BE SPECIFICALLY ADDRESSED ON THE PLANS AND NOTES. - NOTE ALL CEILING PENETRATIONS - LIGHTS, VENTS, ETC. TO BE SEALED @ EDGES AS PER FLORIDA BUILDING CODE 2020 EDITION.

ALL CBS EXTERIOR BLOCK WALLS TO RECEIVE "COREFILL 500" BY TAILORED FOAM OF FLORIDA & APPROVED R-7.0 (MIN.) INSULATION, WOOD STUD, (METAL STUDS) WALLS TO RECEIVE R-11 BATT. R-19 FOR 6" AND 8" WALLS INSULATION (NOTE: ROOF TO BE "CLOSED SYSTEM" USING BLOWN ON R-30 "ICYNENE" INSULATION BY "GALE INSULATION" OR EQUAL TO THE UNDERSIDE OF ROOF DECK (TYP.), NOTE: ALL "ICYNENE FOAM" TO BE PROTECTED WITH DC-315 COATING AS PER MANUFACTURE'S SPECIFICATIONS & THE FLORIDA BUILDING CODE 2020 - THERMAL BARRIER.

INSTALL PVC PLASTER STOPS AROUND PERIMETER OF ALL AREAS WHERE PLASTER ABUTS OTHER MATERIAL. STOPS SHALL BE CAREFULLY MITERED AT CORNERS. ALL EXTERIOR CORNERS AND WINDOW AND DOOR OPENING TO RECEIVE PYC CORNER BEADS.

ALL GYPSUM WALLBOARD TO BE SCREW APPLIED AS PER THE GYPSUM CONSTRUCTION HANDBOOK, LATEST EDITION.

OR USED FACILITIES AND DAILY OPERATIONS.

MADE IN SPECIFIED EQUIPMENT, MATERIALS AND COLORS.

HEPTACHLOR, TECHNICAL CHLORDANE, OR OTHER APPROVED CHEMICALS SHALL BE USED IN CONCENTRATIONS AS PER MANUFACTURER'S PUBLISHED INSTRUCTIONS IN COMPLIANCE WITH E.P.A. REGULATIONS. (ALL PRODUCTS TO BE NON-YOC).

DRYWALL PRODUCTS BY GOLD BOND, USG, CELOTEX, GEORGIA PACIFIC, MILCOR PRODUCTS ARE ACCEPTABLE.

ALL EXTERIOR DEPICTED PAINT COLORS TO BE SELECTED BY ARCHITECT AND OWNER. COLORS ON PLANS FOR PRICING PURPOSES ONLY. (PAINTING SUBCONTRACTOR TO PROVIDE PAINT SAMPLES).

ALL WORK, MATERIAL, AND EQUIPMENT SHALL BE GUARANTEED FOR A MINIMUM OF ONE YEAR FROM THE CLOSING DATE. TRAFFIC: CONDUCT DEMOLITION OPERATIONS AND REMOVAL OF DEBRIS TO ENSURE MINIMUM INTERFERENCE WITH ROADS, STREETS, WALKS, AND OTHER ADJACENT OCCUPIED

DISPOSAL: CONTRACTOR IS RESPONSIBLE FOR REMOVAL FROM SITE ALL DEBRIS, RUBBISH AND OTHER MATERIALS RESULTING FROM DEMOLITION OPERATIONS. CONTRACTOR SHALL OBTAIN WRITTEN APPROVAL OF ARCHITECT FOR SUBSTITUTIONS

THE CONTRACTOR SHALL PROVIDE THE OWNER WITH A WRITTEN GUARANTEE FOR ALL WORK UNDER THIS CONTRACT FOR A MINIMUM PERIOD OF ONE YEAR FROM THE DATE OF ACCEPTANCE BY OWNER.

NOTES:

1. DO NOT SCALE DRAWINGS! 2. FIELD VERIFY ALL DIMENSIONS! 3. CONTRACTOR TO VERIFY ALL EXISTING CONDITIONS, AND NOTIFY ARCHITECT

IF ANY DISCREPANCY W/ DRAWINGS.

(SEE GENERAL NOTES)

4. ALL AREA CALCULATIONS ARE APPROX.



APPLICABLE CODES

2020 FLORIDA BUILDING CODE 2020 FLORIDA PLUMBING CODE 2020 FLORIDA ELECTRICAL CODE

2020 FLORIDA MECHANICAL CODE

RESIDENTIAL DUPLEX LOT 1 130, 134 & 148 SE 1ST AVENUE DELRAY BEACH PALM BEACH COUNTY, FL

OCCUPANCY CLASSIFICATION

GROUP R3 - DUPLEX

TYPE OF CONSTRUCTION

TYPE VB UNPROTECTED / UNSPRINKLERED

				SHEET SCHEDL	ILE		
SHEET NO.	SHEET TITLE		SHEET NO.	SHEET TITLE			
	SURVEY	SCALE: " = 20'-0"		CIVIL			
	ARCHITECTURA		10=9	CIVIL SITE IMPROVEMENTS PLAN	SCALE: 1" = 20'-0"		
A1.00E	EXISTING SITE PLAN (FOR REFERENCE ONLY)	SCALE: 1" = 20'-0"	2 OF 9	PAVING & DRAINAGE PLAN	SCALE: 1" = 10'-0"		
A1.00	PROPOSED SITE PLAN	SCALE: 1" = 20'-0"	3 OF 9	PAVING & DRAINAGE PLAN	SCALE: 1" = 10'-0"		
A1.01A	PROPOSED LOT I PLAN	9CALE: 1/8" = 1'-0"	4 OF 9	PAVING & DRAINAGE DETAILS	SCALE: N.T.S.		
A1.Ø2	ARCHITECTURAL CONTEXT PLAN	SCALE: 1/32" = 1'-0"	5 OF 9	PAVING & DRAINAGE DETAILS	SCALE: N.T.S.		
A2.00A	PROPOSED LOT I GROUND FLOOR PLAN	SCALE: 3/16"=1'-0"	6 OF 9	GENERAL NOTES	SCALE: N.T.S.		
A2.Ø1A	PROPOSED LOT I SECOND FLOOR PLAN	SCALE: 3/16"=1'-0"	7 0 = 9	WATER & WASTEWATER DETAILS	SCALE: N.T.S.		
A2.Ø2A	PROPOSED LOT I ROOF PLAN	SCALE: 3/16"=1'-0"	80 = 9	DEMOLITION PLAN	SCALE: 1" = 20'-0"		
A3.00A	PROPOSED LOT I ELEVATIONS	SCALE: 3/16"=1'-0"	9 OF 9	POLLUTION PREVENTION PLAN	SCALE: 1" = 20'-0"		
A3.Ø1A	PROPOSED LOT I ELEVATIONS	SCALE: 3/16"=1'-0"	1 OF 1	COMPOSITE UTILITY PLAN	SCALE: 1" = 20'-0"		
A3.Ø2A	VISUAL COMPATIBILITY PROPOSAL	SCALE: 3/16"=1'-0"					
A9.00A	PROPOSED WINDOW AND DOOR SCHEDULE	SCALE: N.T.S.					
	ELECTRICAL						
PSP-1	PROPOSED PHOTOMETRIC SITE PLAN	SCALE: 1/16"=1'-0"					
	LANDSCAPE						
LC-I	COVER SHEET	SCALE: N.T.S.					
LP-1.1	OVERALL MASTER SITE PLAN	SCALE: " = 20'-0"					
LP-1.2	LANDSCAPE PLAN - LOT I	SCALE: 1/8" = 1'-0"					
LP-1.3	LANDSCAPE DETAILS AND SPECIFICATIONS	SCALE: N.T.S.					
TD-1.1	TREE DISPOSITION PLAN - LOT I	SCALE: " = 20'-0"					

CONTRACTOR	SURVEYOR	<u>CIVIL ENGINEER</u>	LANDSCAPE ARCHITECT	PHOTOMETRICS	ARCHITECTS	
SEASIDE BUILDERS 185 NORTHEAST 4TH AVE, SUITE 104 Delray Beach, FL. 33483	ENGLE LAND SURVEYING LLC 955 N.W. 17th Ave Suite K-1 Delray Beach, FL. 33445	ENVIRODESIGN ASSOCIATES 298 PINEAPPLE GROVE WAY Delray Beach, FL. 33444	LDS Landscape Deign Studio Paul Weinstein 9581 N.W. 11th St. Plantation, FL. 33322	TYEC 902 CLIENT MOORE ROAD, SUITE 142 Boca Raton, FL. 33487	ge architecture, inc. 1045 e. atlantic ave. delray beach, fl. 33483 fl. lic. AA-26002044	
PH. (561) 272-9958 FAX (561) 272-8941	PH. (561) 276-4501 FAX (561) 276-2390	PH. (561) 274-6500 FAX (561) 274-8558	PH. (561) 254-3397 FAX (954) 846-9523	PH. (561) 274-0200	PH. (561) 276-6011 FAX (561) 276-6129	architec

CORRECTION OF ANY DEFECTS SHALL BE COMPLETED WITHOUT ADDITIONAL CHARGE AND SHALL INCLUDE REPLACEMENT OR REPAIR OF ANY PORTION OF THE WORK WHICH HAS BEEN DAMAGED. REPLACE ANY WORK THAT FAILS TO CONFORM TO THE DRAWINGS AND DETAILS. CORRECT ANY DEFECTS DUE TO FAULTY MATERIALS AND WORKMANSHIP WHICH APPEAR WITHIN ONE YEAR OF OWNER ACCEPTANCE OF CONSTRUCTION.

IT IS THE RESPONSIBILITY OF THE CONTRACTOR TO COORDINATE AND OBTAIN ACCESS TO THE SITE WITH OWNER ..

THE CONTRACTOR SHALL OBTAIN AND BEAR THE COST OF ALL REQUIRED PERMITS, LICENSES AND APPROVALS NECESSARY FOR THE COMPLETION OF THE WORK.

ALL REQUIRED INSURANCE SHALL BE PROVIDED FOR PROTECTION OF OWNER AGAINST PUBLIC LIABILITY OR PROPERTY DAMAGE FOR THE DURATION OF THE WORK.

THE CONTRACTOR AND SUBCONTRACTORS SHALL COORDINATE WITH EACH OTHER TO PREVENT OVERSTEPPING EACH OTHER. THE CONTRACTOR SHALL PROVIDE LABOR \$ MATERIALS NECESSARY TO MAINTAIN CONSTRUCTION SCHEDULING. THE SUB -CONTRACTOR SHALL BE RESPONSIBLE TO MEET THE SCHEDULE AS PROVIDED AND AGREED TO WITH THE CONTRACTOR PRIOR TO CONSTRUCTION.

ALL WORK SHALL BE PERFORMED BY A LICENSED CONTRACTOR IN A FIRST CLASS WORKMANLIKE MANNER. THE COMPLETED SYSTEM SHALL BE FULLY OPERATIVE. ACCEPTANCE BY THE ENGINEER /ARCHITECT MUST BE A CONDITION OF THE CONTRACT BETWEEN THE GEN. CONTRACTOR AND OWNER.

THE CONTRACTOR IS RESPONSIBLE FOR THE FOLLOWING WORK: - MAKE-WAY/HOOK UP SCHEDULING OF ALL TRADES AND WORK

(INCLUDING WORK OF OTHERS WHERE NO CONTRACTUAL RELATIONSHIP EXIST). . PROVIDING BARRICADES, TEMPORARY POWER, LIGHTING TELEPHONE SERVICES, ETC. AS REQ'D. TO COMPLETE WORK.

- TEMPORARY UTILITIES, CONNECTIONS AND PAYMENT OF ALL UTILITY CHARGES DURING

. COORDINATION WITH OWNER OR AGENT OF DELIVERY AND REMOVAL IF MATERIALS, EQUIPMENT, AND OTHER ITEMS TO / FROM SITE.

REMOVAL OF TRASH AND DEBRIS. PLACE IN DESIGNATED CONTAINERS AS DIRECTED BY OWNER /AGENT. REMOVE ALL TRASH FROM PREMISES.

. ISSUE ALL ADDENDUMS, REVISIONS AND UPDATES TO SUBCONTRACTORS IN A TIMELY - ALL DRAWINGS, SPECIFICATIONS, AND COPIES THEREOF FURNISHED BY THE ARCHITECT ARE AND SHALL REMAIN THE ARCHITECTS PROPERTY. THE CONTRACTOR SHALL

MAINTAIN A FULL SET OF COMPLETE AND CURRENT DRAWINGS AVAILABLE FOR REVIEW

AT THE JOBSITE AT ALL TIMES. ALL FIELD MODIFICATIONS TO THE ORIGINAL DESIGN

DOCUMENTS SHALL BE NOTED AND MAINTAINED FOR THE OWNERS RECORD COPY. ALL WORK SHALL BE LAID OUT TRUE, SQUARE AND PLUMB TO EXACT AND CORRECT DIMENSIONS, IF DISCREPANCIES ARE DISCOVERED, THE CONTRACTOR MUST NOTIFY THE OWNER/ ARCHITECT IN WRITING PRIOR TO PROCEEDING. THE ARCHITECT WILL 199UE A DIMENSIONAL OR LAYOUT CORRECTION NOTICE. THE CONTRACTOR SHALL BE

ALL MATERIALS USED IN THE PERMANENT CONSTRUCTION OF THE WORK MUST BE NEW AND UNUSED (U.N.O.), FIRST QUALITY, FREE FROM DEFECTS AND INSTALLED PER THE MANUFACTURERS RECOMMENDATIONS FOR THE APPLICATION AT HAND. ALL

WORKMANSHIP SHALL BE OF FIRST CLASS QUALITY. CONTRACTOR SHALL PROVIDE CUT-SHEETS AND SPECIFICATIONS OF ALL ITEMS FOR SUBMISSION TO ARCHITECT FOR APPROVAL PRIOR TO ORDERING OR INSTALLING. PRODUCT MANUFACTURERS INDICATED IN SCHEDULES AND/OR ON PLANS WERE SELECTED BASED UPON QUALITY, STYLE, SIZE, COLOR, ETC. AND ARE NOT IN- TENDED TO RESTRICT THE COMPETITIVE BIDDING, PRODUCTS EQUAL TO OR IN- TENDED TO BE

USED AS SUBSTITUTES ARE SUBJECT TO ARCHITECTS APPROVAL IN WRITING PRIOR TO

PURCHASE OR INSTALLATION. ALL DOOR FRAMES TO BE LOCATED 5" TO 6" FROM ADJACENT PARTITIONS, UN.O. ALL DRYWALL PARTITIONS WILL BE TAPED, SPAKLED, SANDED,

PRIMED AND PAINTED W/ LEVEL Y FINISH. CONCEAL ALL FASTENERS AND ATTACHMENTS FROM VIEW.

RESPONSIBLE TO CORRECT DIMENSIONAL ERRORS.

OWNER SHALL REVIEW THESE CONSTRUCTION DOCUMENTS AND VERIFY THAT THEY ARE CORRECT AND COMPLETE PRIOR TO BIDDING AND START OF CONSTRUCTION. OWNER SHALL APPROVE ALL MATERIAL AND FINISH SAMPLES ALONG WITH ALL EQUIPMENT SPECIFICATIONS PRIOR TO ORDERING AND INSTALLATION.

ALL DOORS & WINDOWS TO BE IMPACT RESISTANT AND COMPLY W/ ALL DADE COUNTY IMPACT AND WIND CYCLING TESTING REQUIREMENTS ("PGT" OR EQUAL) ALL INTERIOR WALLS THAT RECEIVE TILE /MARBLE - TO BE BACKED W/ 5/8" "DENS-SHIELD" OR EQUAL.

ALL WALKWAYS TO BE SLOPED AWAY FROM BUILDING FOR POSITIVE DRAINAGE. (MIN. 2% - SEE CIVIL DRAWINGS.)

ALL GROUND FLOOR SHOWERS TO HAVE MIN. 4" DEPRESSED SLAB. SECOND FLOOR HOLLOW-CORE PLANKS - ELIMINATE 2" TOPPING FOR ALL SECOND FLOOR SHOWERS. ALL DOMESTIC HOT WATER PIPING SHALL BE INSULATED 1/2" THICK FIBERGLASS PIPE

CONTRACTOR TO PROVIDE DRAWINGS TO TRUSS MANUFACTURER, MECHANICAL SUBCONTRACTOR TO COORDINATE ALL REQUIRED AC-DUCT WORK PENETRATIONS

THROUGH THE ENTIRE STRUCTURE. ALL TRUSSES, & GIRDERS SHALL BE ANCHORED TO BEARING PARTITIONS, WALLS, AND/OR TIE BEAMS WITH APPROVED ANCHORS. - SEE STRUCTURAL DWGS.

ALL INTERIOR DEPICTED PAINT COLORS TO BE SELECTED BY ARCHITECT AND OWNER. COLORS ON PLANS FOR PRICING PURPOSES ONLY. (NOTE: ALL PRODUCTS TO BE "NON-VOC").

NOTE: PRODUCTS BY ANY OF THESE MANUFACTURERS ARE ACCEPTABLE COATINGS: BENJAMIN MOORE, SHERWIN WILLIAMS, PITTSBURGH, DEVOE, DUPONT, 4 PORTER ARE CONSIDERED EQUAL. (ALL ARE TO BE NON-YOC). CONTRACTOR SHALL DELIVER TO OWNER PRIOR TO FINAL PAYMENT ALL APPLICABLE

GUARANTEES, WARRANTIES AND OPERATING MANUALS.

PROVIDE MOISTURE RESISTANT GYPSUM WALL BOARD "MOLD TOUGH" IN ALL BATHROOMS, KITCHEN & LAUNDRY RMS.

ALL CONTRACTORS AND SUBCONTRACTORS SHALL VISIT THE SITE AND VERIFY EXISTING CONDITIONS PRIOR TO SUBMITTING PROPOSALS, VERIFY EXIST'G CONDITIONS COMPLY WITH CURRENT CODE REQUIREMENTS. NOTIFY ARCHITECT IN WRITING IF CHANGES ARE NECESSARY. NO EXTRAS WILL BE GIVEN. REPORT ANY DISCREPANCIES IN THE DOCUMENTS TO THE ARCHITECT PRIOR TO SUBMITTING PROPOSAL. - NOTE: CONTRACTOR SHALL BE RESPONSIBLE FOR REMOVING ANY AND ALL ABANDEN UNDER GROUND UTILITIES, PIPES, WIRES TREE ROOTS SEPTIC TANK ETC - PRIOR TO COMPACTING SITE.

	REQUIRED	PROPOSED GROUND FLOOR	PROPOSED SECOND FLOC
FRONT	25'-Ø"	+/-25'-1"	+/-25'-1"
SIDE INTERIOR (NORT	TH) 7'-6"	+/-7'-8"	+/-7'-8"
SIDE STREET (SOUTH)	15'-Ø"	+/-15'-1"	+/-15'-1"
REAR	10'-0"	+/-13'-10"	+/-13'-10"
ALLOWABLE HT. (ABOVE FBC - FREEE	35'-Ø" (MEAN ROOF F BOARD / ELEVATION)		" (MEAN ROOF H

SCOPE OF WORK

FLOOD ZONE: X (MIN. 18" ABOVE


DEMOLISH EXISTING 4-PLEX STRUCTURE & CONSTRUCT NEW TWO STORY DUPLEX-MONOLITHIC FOUNDATION, CBS MASONRY WALLS, HOLLOW CORE PLANKS & WOOD ROOF TRUSSES WITH 1HR RATED SEPARATION WALL.

CROWN OF ROAD)

REVISED 5/22/23 AS PER H.P.B COMMENTS: 1. PROPOSED SITE PLAN FOR EACH UNIT IS NOW LISTED AS FIRST PAGE IN THE SET 2. RELABELED DRAWINGS FROM "MASTER PLAN" TO "OVERALL" SITE 3. PROPOSED OVERALL SITE PLAN

IS NOW ONLY SHOWN AT 1" = 20'-0".

THIS DRAWING IS NOT FOR CONSTRUCTION. IT HAS BEEN ISSUED FOR GOVERNMENTAL REVIEW AND/OR PRELIMINARY PRICING

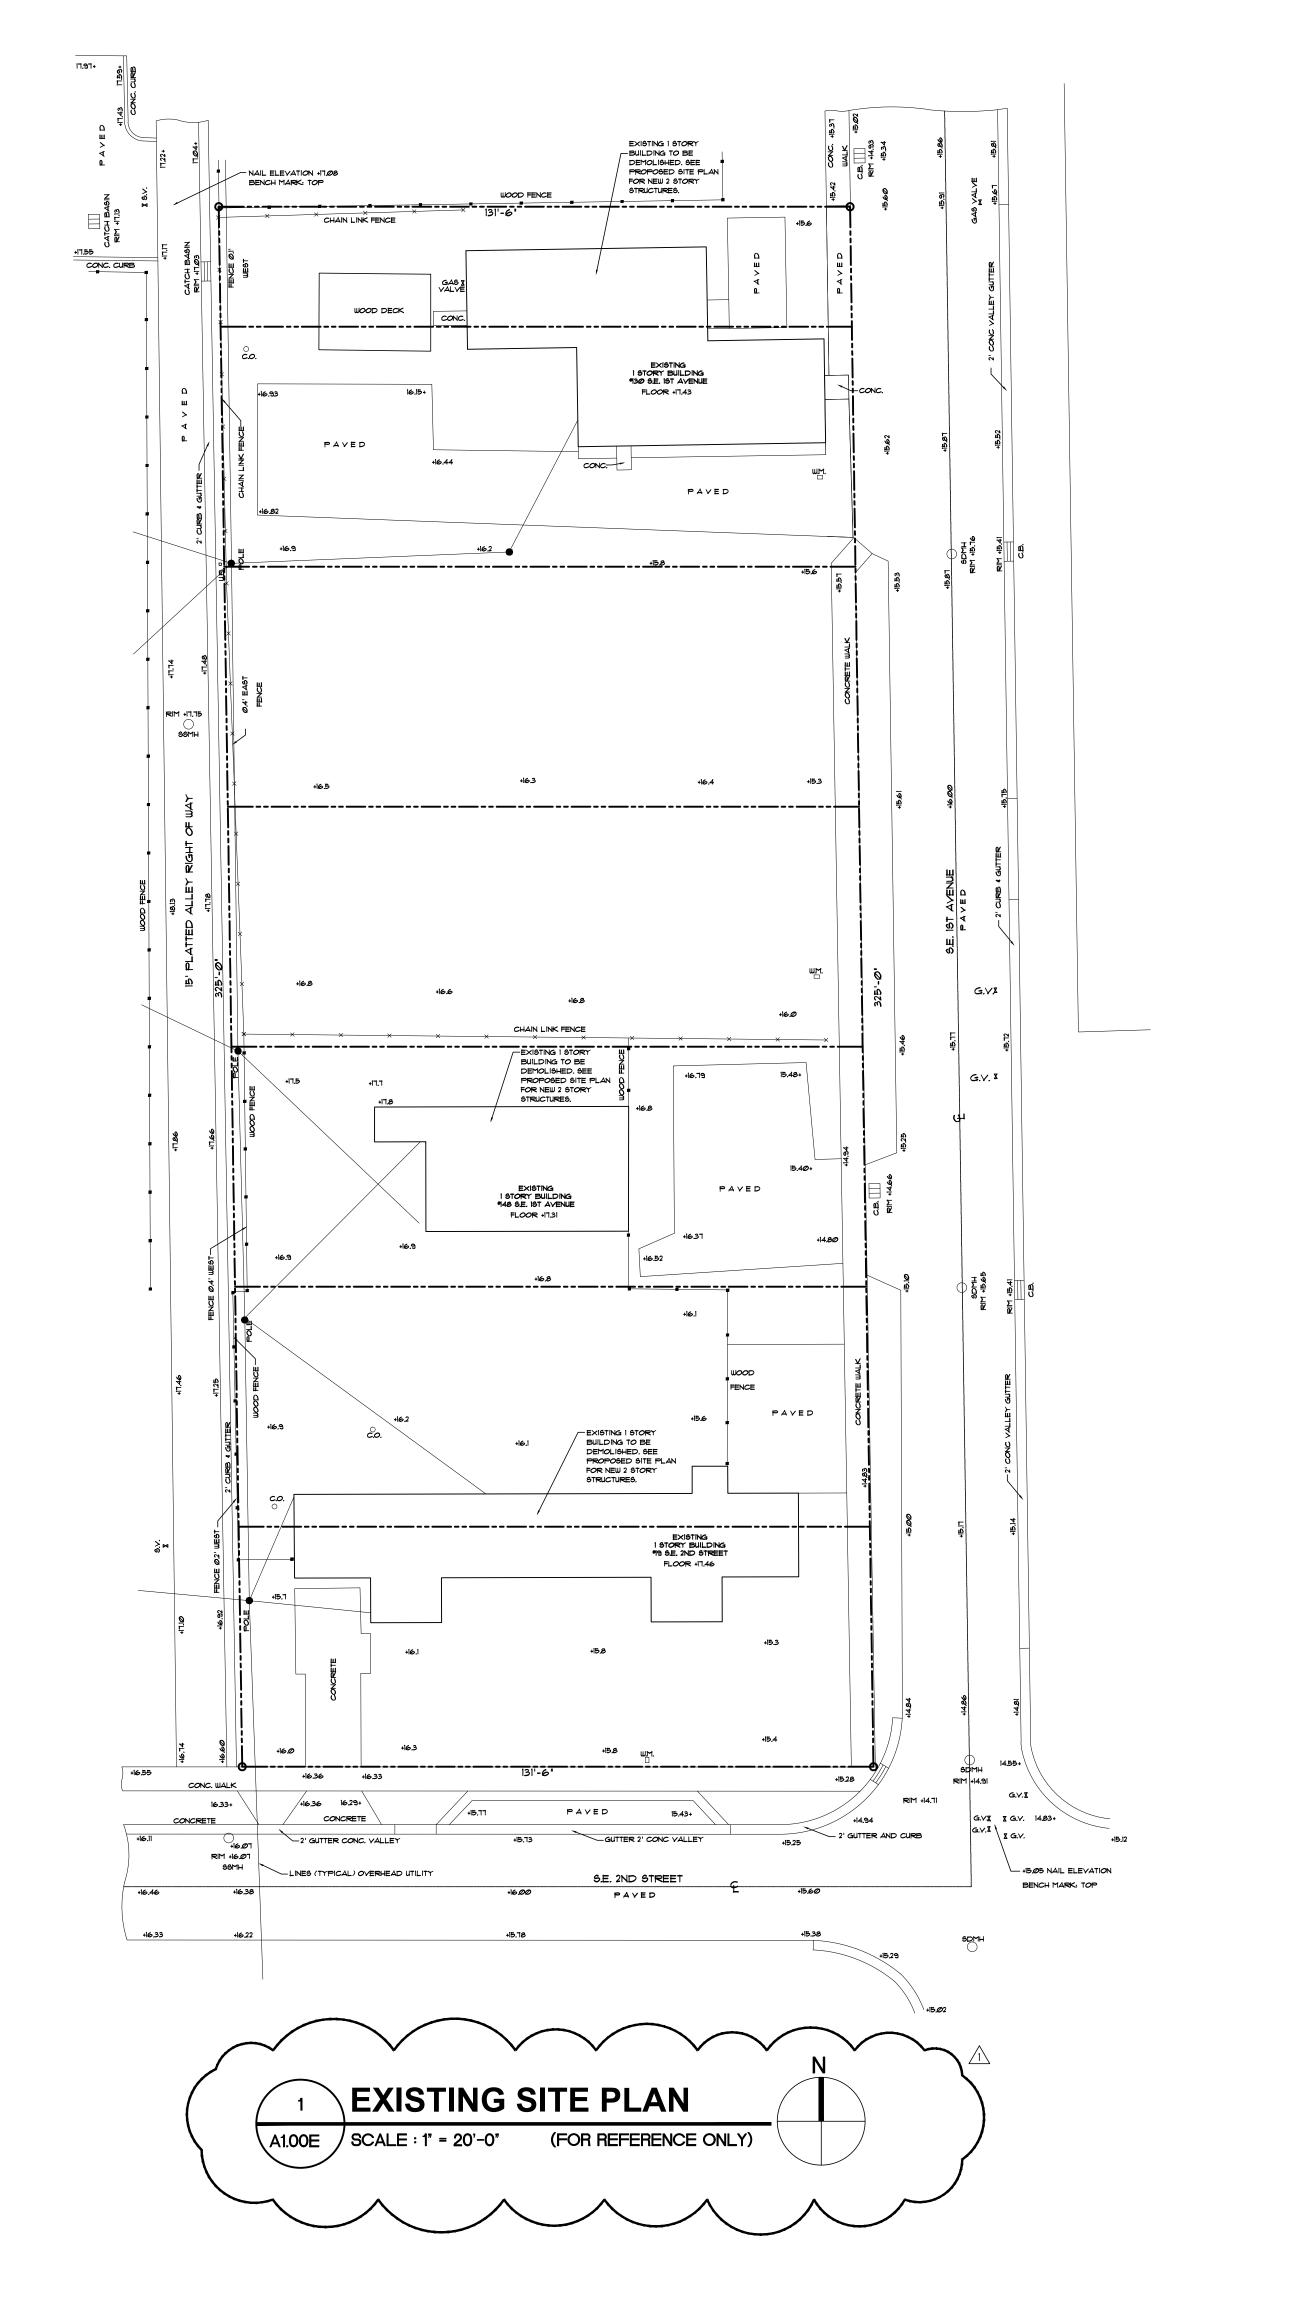



- PROPOSED PROJECT IS LOCATED ON THE EAST SIDE OF SWINTON AVE. VICINITY MAP

GENERAL NOTES:

1. IT IS THE INTENT OF THE ARCHITECT THAT THIS WORK BE IN CONFORMANCE WITH ALL REQUIREMENTS OF THE BUILDING AUTHORITIES HAVING JURISDICTION OVER THIS TYPE OF CONSTRUCTION AND OCCUPANCY. ALL CONTRACTORS SHALL DO THEIR WORK IN CONFORMANCE WITH ALL APPLICABLE CODES AND REGULATIONS. 2. THE CONTRACTOR SHALL VERIFY ALL CONDITIONS AND DIMENSIONS AT THE JOBSITE PRIOR TO COMMENCING WORK. THE CONTRACTOR SHALL REPORT ALL DISCREPANCIES BETWEEN THE DRAWINGS AND EXISTING CONDITIONS TO THE ARCHITECT PRIOR TO COMMENCING WORK. 3. CONTRACTOR SHALL SUPPLY LOCATE AND BUILD INTO THE WORK ALL INSERTS, ANCHORS, ANGLES, PLATES, OPENINGS, SLEEVES, HANGERS, SLAB DEPRESSIONS AND PITCHES AS MAY BE REQUIRED TO ATTACH AND ACCOMMODATE OTHER WORK. 4. ALL DETAILS AND SECTIONS SHOWN ON THE DRAWINGS ARE INTENDED TO BE TYPICAL AND SHALL BE CONSTRUED TO APPLY TO ANY SIMILAR SITUATION ELSEWHERE IN THE WORK EXCEPT WHERE A DIFFERENT DETAIL IS SHOWN. 5. THESE DOCUMENTS, AS INSTRUMENTS OF SERVICE, ARE THE PROPERTY OF THE ARCHITECT AND MAY NOT BE USED OR REPRODUCED WITHOUT EXPRESSED PRIOR WRITTEN CONSENT FROM THE ARCHITECT.

DESCRIPTION:

THE SOUTH HALF OF LOT 13 AND ALL OF LOTS 14 THROUGH 19, INCLUSIVE, BLOCK 10, AMENDED PLAT OF SUNDY AND CROMER'S SUBDIVISION OF BLOCK 10 ORIGINAL TOWN OF LINTON, ACCORDING TO THE PLAT THEREOF AS RECORDED IN PLAT BOOK 6, PAGE 11, PUBLIC RECORDS OF PALM BEACH COUNTY, FLORIDA. CONTAINING 42,735 SQUARE FEET OR 0.9811 ACRES MORE OR LESS.

I. DO NOT SCALE DRAWINGS! 2. FIELD VERIFY ALL DIMENSIONS! 3. CONTRACTOR TO VERIFY ALL EXISTING CONDITIONS, AND NOTIFY ARCHITECT IF ANY DESCRIPANCY W/ DRAWINGS. (SEE GENERAL NOTES)

NOTES:

4. ALL AREA CALCULATIONS ARE APPROX.

TOTAL SITE AREA	8,0
TOTAL BLDG FOOTPRINT	3,50
TOTAL LOT COVERAGE =	3,503 / 8,031 =
TOTAL IMPERVIOUS VS PERVIOUS AREA:	
TOTAL IMPERVIOUS AREA: (BUILDING FOOTPRINT, PAVERS, POOL ET	5, ⁻ C.)
TOTAL PERVIOUS AREA (LANDSCAPING)	2,2
TOTAL IMPERVIOUS AREA :	5,753 / 8,031
TOTAL PERVIOUS AREA =	2,278 / 8, 0 31 =
TOTAL PERVIOUS + IMPERVIOUS AREA:	5,753 + 2,278 = 8, 0 31
(REQUIRED OPEN SPACE 25% - PROVIDED 28	,4% OPEN SPACE)
PROPOSED SETBACKS:	

FRONT 25'-0' +/-25'-1' +/-25'-1' SIDE INTERIOR (NORTH) 1'-6' SIDE STREET (SOUTH) 15'-0' +/-7'-8" +/-15'-1" +/-13'-1@" ALLOWABLE HT. 35'-0' (MEAN ROOF HT.) 28'-2' (MEAN ROOF HT.) (ABOVE FBC - FREEBOARD / ELEVATION) ZONING OSSHAD

AREA CALCULATIONS (LOT 2 AND 4)

TOTAL SITE AREA	8, 0 34
TOTAL BLDG FOOTPRINT	3,854 S/F
TOTAL LOT COVERAGE =	3,854 / 8, 0 34 = 47.9%
TOTAL IMPERVIOUS VS PERVIOUS AREA:	
TOTAL IMPERVIOUS AREA: (BUILDING FOOTPRINT, PAVERS, POOL ETC.)	5,892 S/F
TOTAL PERVIOUS AREA (LANDSCAPING)	2,142 9/F
TOTAL IMPERVIOUS AREA =	5,892 / 8,Ø34 = 73.3%
TOTAL PERVIOUS AREA =	2,142 / 8,034 = 26.79
TOTAL PERVIOUS + IMPERVIOUS AREA:	2,142 + 5,892 = 8,034 = 100%
(REQUIRED OPEN SPACE 25% - PROVIDED 26.7% OF	EN SPACE)

PROPOSED SETBACKS:

	REQUIRED	PROPOSED GROUND FLOOR	PROPOSED SECOND FLO
FRONT	25'- @'	+/-25'-3"	+/-25'-3"
SIDE INTERIOR (NORTH)	7'-6"	+/-7'-6"	+/-7'-6"
SIDE INTERIOR (SOUTH)	7'-6"	+/-7'-7"	+/-7'-7"
REAR	10'-0"	+/-12'-10"	+/-12'-10"
ALLOWABLE HT.	35'-0' (MEAN	ROOF HT.) 28'-4	O' (MEAN ROOF
(ABOVE FBC - FREEBO	ARD / ELEVATIO	N)	
ZONING OS	SHAD		

AREA CALCULATIONS (LOT 3 AND 5) TOTAL BLDG FOOTPRINT TOTAL LOT COVERAGE = TOTAL IMPERVIOUS VS PERVIOUS AREA: TOTAL PERVIOUS AREA (LANDSCAPING) TOTAL IMPERVIOUS AREA = 5,892 / 8,034 = 73.3% 2,142 / 8,034 = 26.7% 2,142 + 5,892 = 8,034 = 10,0% TOTAL PERVIOUS AREA =

IDIAL PERVIOUS AREA -			2,142 / 0,000 - 2
TOTAL PERVIOUS + IMPERVI	IOUS AREA=	2,142	5,892 = 8,034 = k
(REQUIRED OPEN SPACE 25	% - PROVIDED	26.7% OPEN SPACE)	
PROPOSED SE	TBACKS:		
	REQUIRED	PROPOSED GROUND FLOOR	PROPOSED SECOND FLOO
FRONT	25'-Ø'	+/-25'-3"	+/-25'-3"
SIDE INTERIOR (NORTH)	7'-6"	+/-7'-6"	+/-7'-6"
SIDE INTERIOR (SOUTH)	7'-6"	+/-7'-7"	+/-7'-7"
REAR	10'-0"	+/-12'-1@"	+/-12'-10"
ALLOWABLE HT. (ABOVE FBC - FREEBO		. ,	9" (MEAN ROOF

ZONING OSSHAD

THIS DRAWING IS NOT FOR CONSTRUCTION, IT HAS BEEN ISSUED FOR GOVERNMENTAL REVIEW AND/OR PRELIMINARY PRICING

FILE NUMBER 109A100E

EXISTING SITE PLAN (FOR REF. ONLY)

GE/MJ 2.16.23 20230109

DRAWING NUMBER



2.24.23

PERMIT


CONSTRUCTION

PROJECT TITLE RESIDENTIAL DUPLEX

130 SE 1ST AVENUE **DELRAY BEACH, FL**

REVISIONS REVISED 5/22/23 AS PER H.P.B.
COMMENTS:

I. RELABELED DRAWING FROM
'MASTER PLAN' TO EXISTING SITE
PLAN.
2. ROTATE PLANS IN ORDER TO SHOW
NORTH POINT TOWARD TOP OF PAGE.

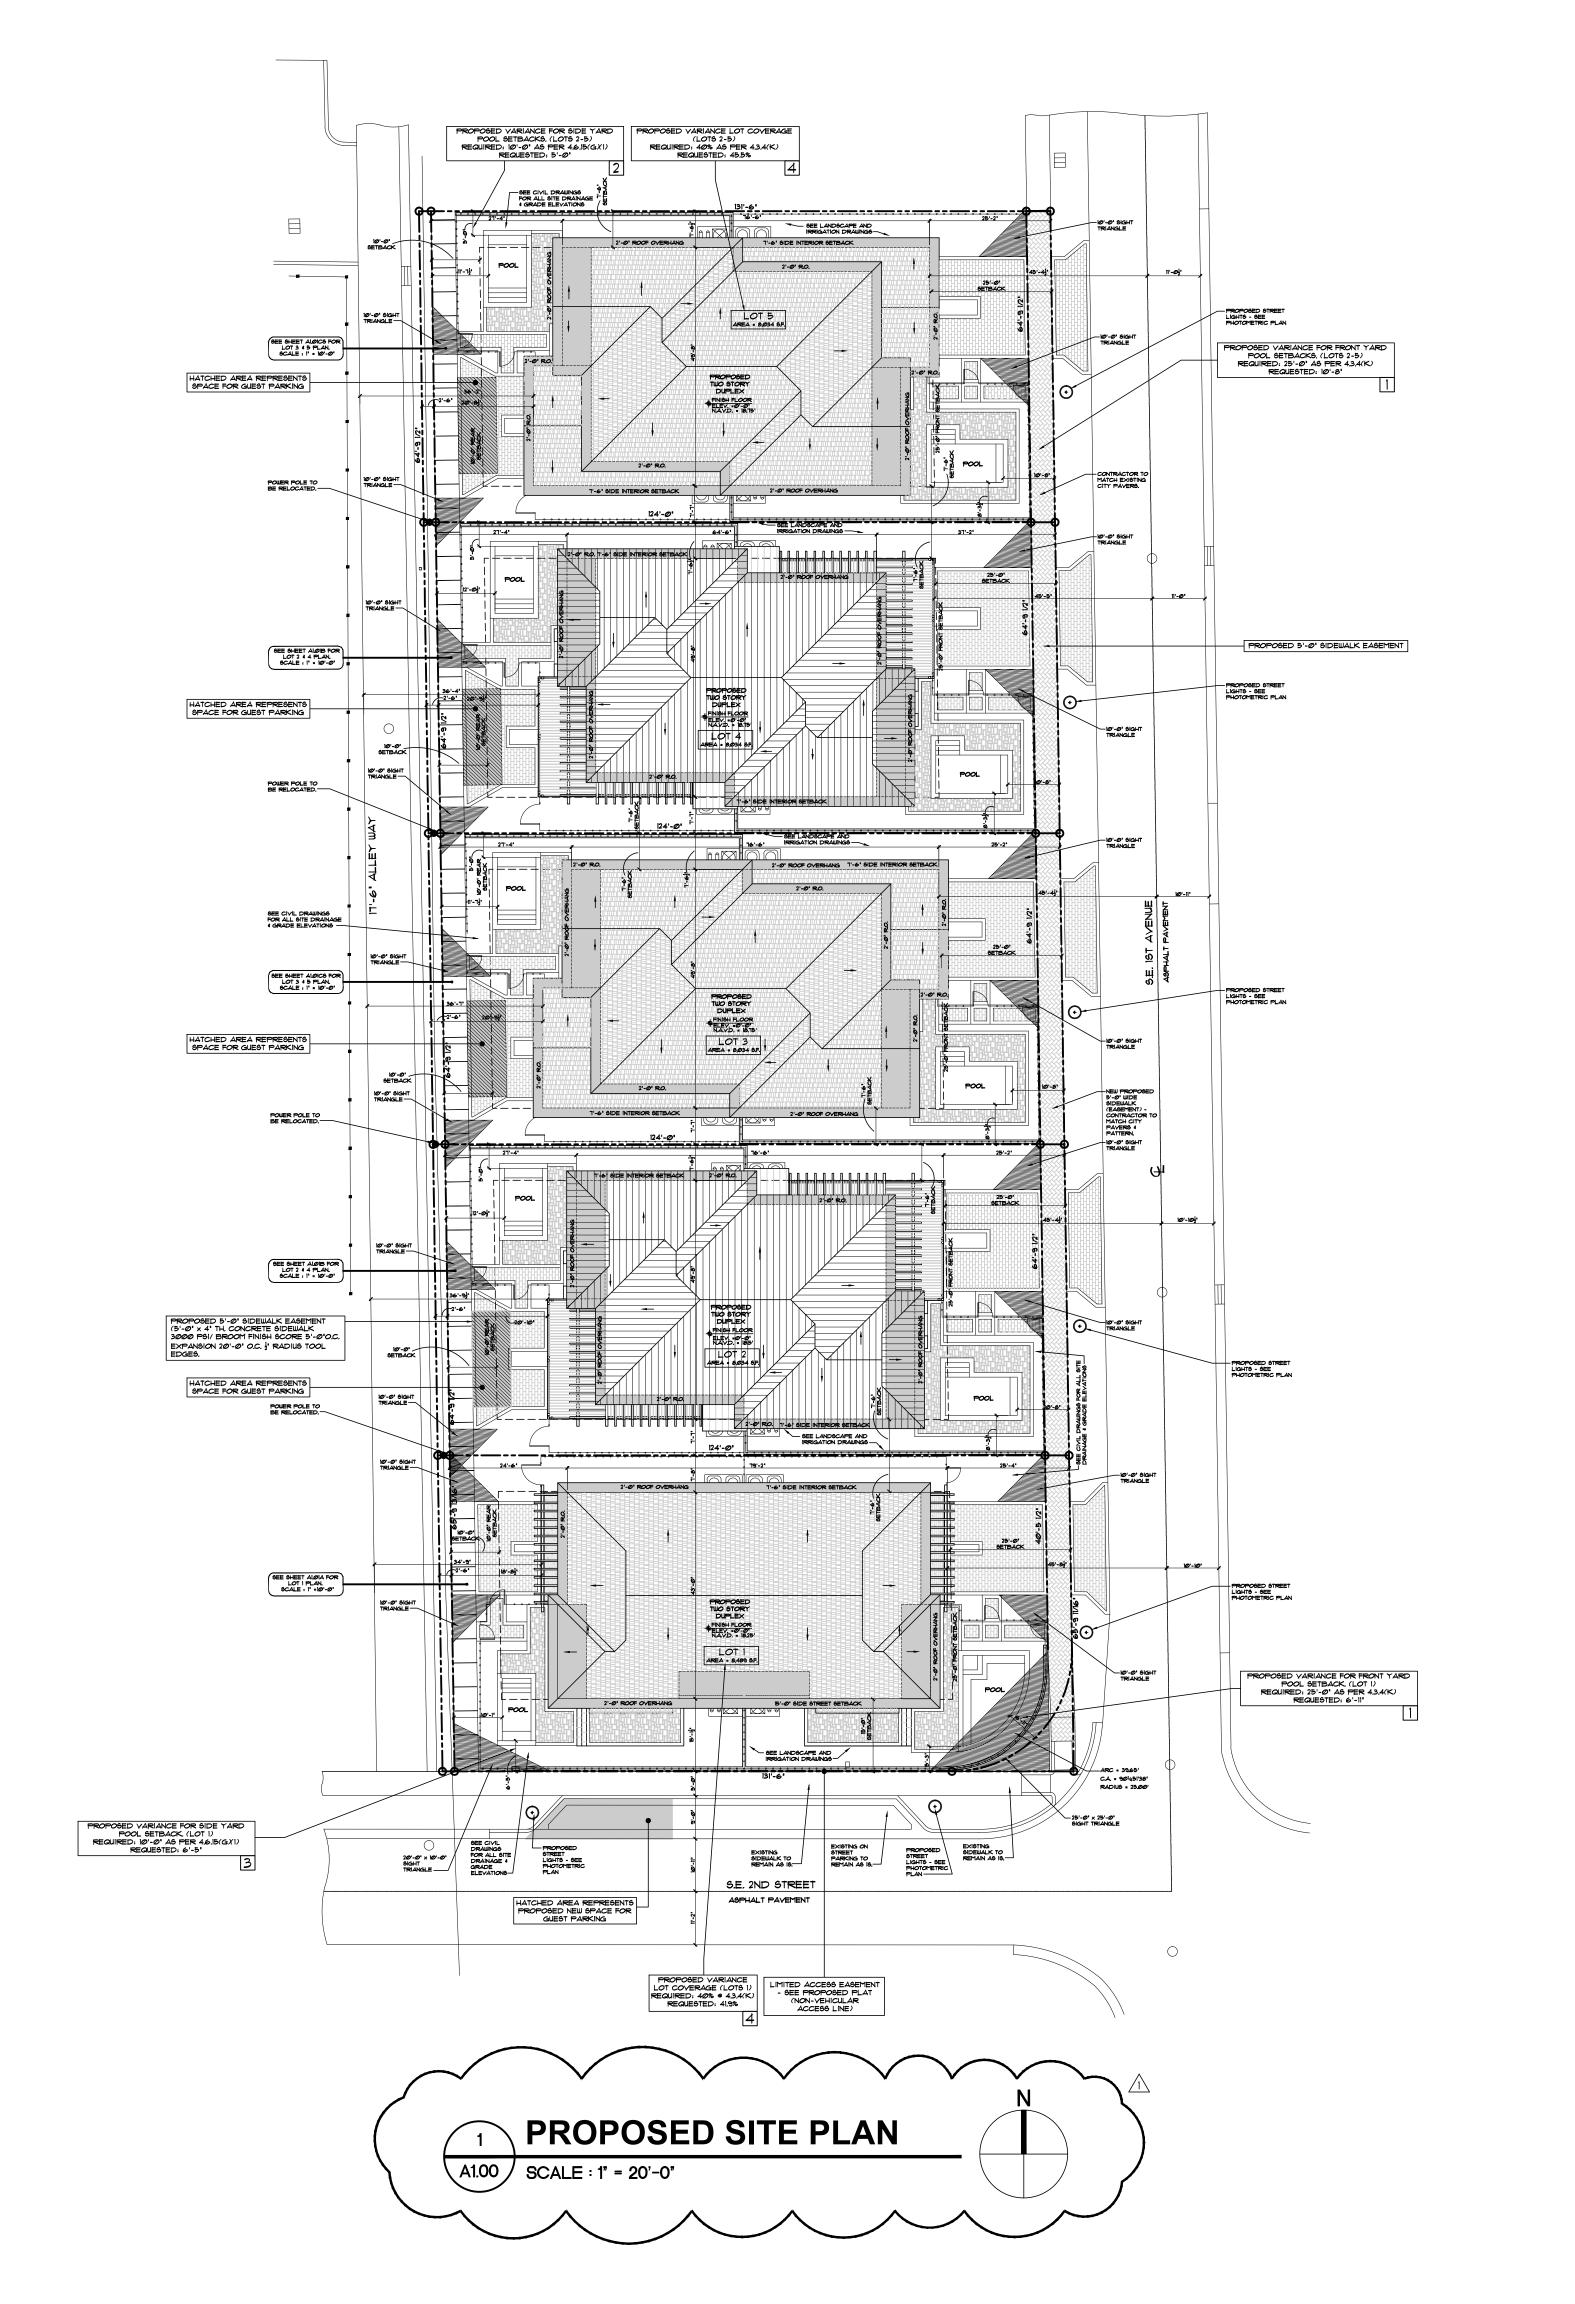

DESCRIPTION: THE SOUTH HALF OF LOT 13 AND ALL OF LOTS 14 THROUGH 19, INCLUSIVE, BLOCK 10, AMENDED PLAT OF SUNDY AND CROMER'S SUBDIVISION OF BLOCK 10 ORIGINAL TOWN OF LINTON, ACCORDING TO THE PLAT THEREOF AS RECORDED IN PLAT BOOK 6, PAGE 17, PUBLIC RECORDS OF PALM BEACH COUNTY, FLORIDA, CONTAINING 42,135 SQUARE FEET OR 0.9811 ACRES MORE OR LESS.

NOTES: I. DO NOT SCALE DRAWINGS!

2. FIELD VERIFY ALL DIMENSIONS! 3. CONTRACTOR TO VERIFY ALL EXISTING CONDITIONS, AND NOTIFY ARCHITECT IF ANY DESCRIPANCY W/ DRAWINGS. (SEE GENERAL NOTES) 4. ALL AREA CALCULATIONS ARE APPROX.




- PROPOSED PROJECT IS LOCATED ON NW CORNER OF SW 2ND STREET AND SE IST AVE. N VICINITY MAP

GENERAL NOTES:

I. IT IS THE INTENT OF THE ARCHITECT THAT THIS WORK BE IN CONFORMANCE WITH ALL REQUIREMENTS OF THE BUILDING AUTHORITIES HAVING JURISDICTION OVER THIS TYPE OF CONSTRUCTION AND OCCUPANCY. ALL CONTRACTORS SHALL DO THEIR WORK IN CONFORMANCE WITH ALL APPLICABLE CODES AND REGULATIONS. 2. THE CONTRACTOR SHALL VERIFY ALL CONDITIONS AND DIMENSIONS AT THE JOBSITE PRIOR TO COMMENCING WORK. THE CONTRACTOR SHALL REPORT ALL DISCREPANCIES BETWEEN THE DRAWINGS AND EXISTING CONDITIONS TO THE ARCHITECT PRIOR TO COMMENCING WORK. 3. CONTRACTOR SHALL SUPPLY LOCATE AND BUILD INTO THE WORK ALL INSERTS, ANCHORS, ANGLES, PLATES, OPENINGS, SLEEVES, HANGERS, SLAB DEPRESSIONS AND PITCHES AS MAY BE REQUIRED TO ATTACH AND ACCOMMODATE OTHER WORK. 4. ALL DETAILS AND SECTIONS SHOWN ON THE DRAWINGS ARE INTENDED TO BE TYPICAL AND SHALL BE CONSTRUED TO APPLY TO ANY SIMILAR SITUATION ELSEWHERE IN THE WORK EXCEPT WHERE A DIFFERENT DETAIL IS SHOWN. 5. THESE DOCUMENTS, AS INSTRUMENTS OF SERVICE, ARE THE PROPERTY OF THE ARCHITECT AND MAY NOT BE USED OR REPRODUCED WITHOUT EXPRESSED PRIOR WRITTEN CONSENT FROM THE ARCHITECT.

PROJECT VARIANCE REQUEST ITEMS:

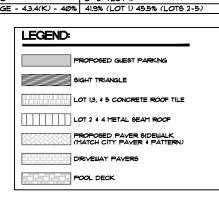



architecture, planning and design

1045 East Atlantic Ave. Suite 303 Delray Beach, Florida 33483 TEL: 561-276-6011 FAX: 561-276-6129

ISSUED FOR

BIDS

PERMIT CONSTRUCTION

PROJECT TITLE RESIDENTIAL

DUPLEX

130 SE 1ST AVENUE **DELRAY BEACH, FL**

REVISIONS REVISED 5/22/23 AS PER H.P.B.
COMMENTS:

1. RELABELED DRAWING FROM
"MASTER PLAN" PROPOSED SITE
BLAN

'MASTER PLAN' PROPOSED SITE PLAN.
2. SIGHT TRIANGLE HAS BEEN INCREASED FROM 20'x20' TO 25'x25'.
3. ROTATE PLANS TO SHOW SITE ORIENTED WITH NORTH TO THE TOP OF THE PAGE.
4. DIMENSION STRINGS FOR ALL SETBACKS ADDED.
5. LOT DIMENSIONS SWITCHED TO FEET AND INCHES.
6. DIMENSION STRING ADDED TO LOT LOT I POOL FOR FRONT SETBACK.

FILE NUMBER 109A100


DRAWING TITLE **PROPOSED** SITE PLAN


2.16.23

20230109

DRAWN BY GE/MJ

DRAWING NUMBER

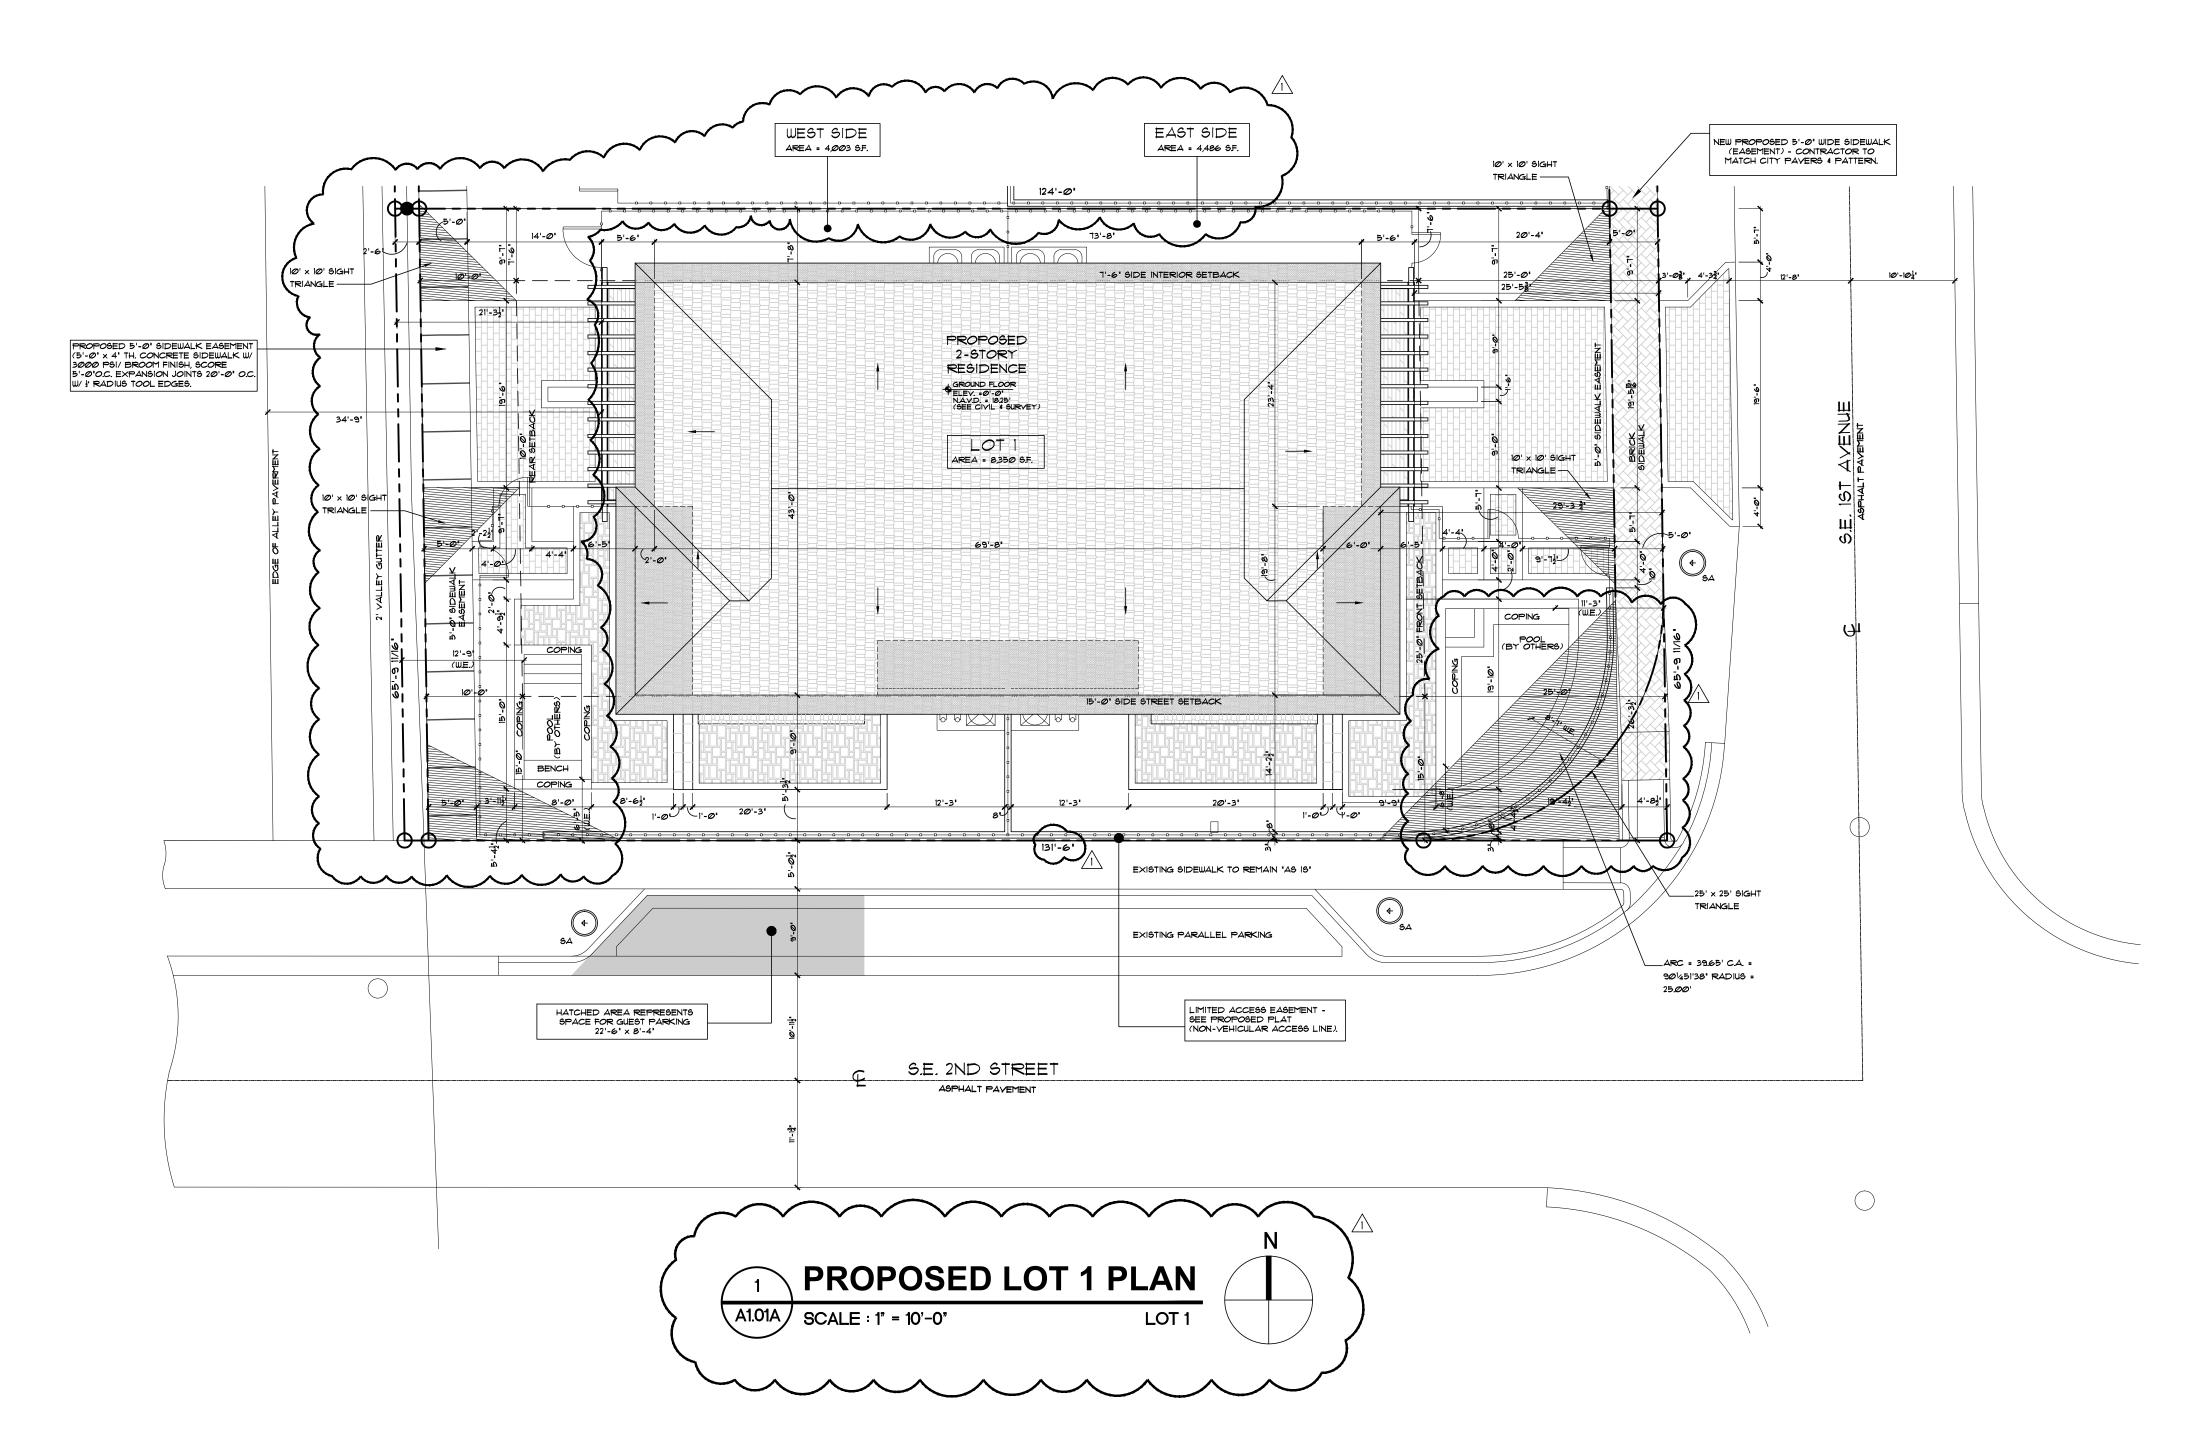

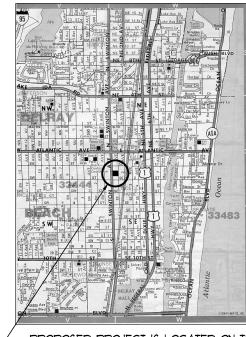

PROPOSED PROJECT IS LOCATED ON THE NW CORNER OF SW SECOND STREET AND SE FIRST AVENUE. VICINITY MAP

- I. DO NOT SCALE DRAWINGS! 2. FIELD VERIFY ALL DIMENSIONS!
- 3. CONTRACTOR TO VERIFY ALL EXISTING CONDITIONS, AND NOTIFY ARCHITECT IF ANY DESCRIPANCY W/ DRAWINGS. (SEE GENERAL NOTES)
- 4. ALL AREA CALCULATIONS ARE APPROX.
- CONTRACTOR TO FIELD COORDINATE ALL ALL PROPOSED GRADE ELEVATIONS W/ CIVIL DRAWINGS.

GENERAL NOTES:

1. IT IS THE INTENT OF THE ARCHITECT THAT THIS WORK BE IN CONFORMANCE WITH ALL REQUIREMENTS OF THE BUILDING AUTHORITIES HAVING JURISDICTION OVER THIS TYPE OF CONSTRUCTION AND OCCUPANCY. ALL CONTRACTORS SHALL DO THEIR WORK IN CONFORMANCE WITH ALL APPLICABLE CODES AND REGULATIONS. 2. THE CONTRACTOR SHALL VERIFY ALL CONDITIONS AND DIMENSIONS AT THE JOBSITE PRIOR TO CONTRENCING WORK. THE CONTRACTOR SHALL REPORT ALL DISCREPANCIES BETWEEN THE DRAWINGS AND EXISTING CONDITIONS TO THE ARCHITECT PRIOR TO COMMENCING WORK.

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5. THESE DOCUMENTS, AS INSTRUMENTS OF SERVICE, ARE THE PROPERTY OF THE ARCHITECT AND MAY NOT BE USED OR REPRODUCED WITHOUT EXPRESSED PRIOR WRITTEN CONSENT FROM THE ARCHITECT.

TWO STORY DUPLEX (PER UNIT)	
PROPOSED FIRST FLOOR AREA UNDER A/C	1,Ø75 S/F
PROPOSED 2 CAR GARAGE PROPOSED FRONT COVERED PORCH PROPOSED SIDE TERRACE	558 S/F 118 S/F 199 S/F
PROPOSED FIRST FLOOR UNDER ROOF	1,751 S/F
PROPOSED SECOND FLOOR UNDER A/C	1,339 6/F
PROPOSED FRONT COVERED PORCH	118 S/F
PROPOSED TRELLIS / TERRACE PORCH	128 5/F
PROPOSED SIDE COVERED PORCH	114 S/F
PROPOSED SECOND FLOOR UNDER ROOF	1,5-TI S/F
TOTAL FLOOR UNDER A/C	2,414 S/F
TOTAL FLOOR UNDER ROOF	3,322 S/F
TOTAL SITE AREA	8,35Ø 6/F
TOTAL BLDG FOOTPRINT	3,502 S/F
TOTAL LOT COVERAGE =	3,502 / 8,350 = 41.9%
TOTAL IMPERVIOUS VS PERVIOUS AREA:	
TOTAL IMPERVIOUS AREA: (BUILDING FOOTPRINT, PAVERS, POOL ETC.)	6,141 S/F
TOTAL PERVIOUS AREA (LANDSCAPING)	2,2 0 9
TOTAL IMPERVIOUS AREA =	6,141 / 8,350 = 73.5%
TOTAL PERVIOUS AREA =	2,209 / 8,350 = 26.5%
TOTAL PERVIOUS + IMPERVIOUS AREA=	6,141 + 2,209 = 8,350 = 100%
(REQUIRED OPEN SPACE 25% - PROVIDED 26.5% OPEN	SPACE)


	<u> </u>	<u> </u>			<u> </u>			'
FAR CA	LCUL	ATIONS						
TOTAL FLOOR	AREA						6,644 9	3/F
TOTAL LOT AR	EΑ						8,350 \$	3/⊨
FLOOR AREA F	RATIO =					6,644 /	8,350 = 0.8	ø
		$\overline{}$	$\overline{\mathcal{L}}$	人	へ	$\overline{}$	$\overline{\mathcal{L}}$	<u>=</u>
PROPOS	SED S	BETBACK	(S:					
		REQUIRED	>	PROPO	SED	PR	OPOSED	

	REQUIRED	PROPOSED GROUND FLOC	
FRONT	25'-Ø"	25'-6" TO 29'-5	" 29'-5' TO 31'-2
SIDE INTERIOR (NORTH)	7'-6"	7'-8 '	T'-8 '
SIDE STREET (SOUTH)	15'-@"	15'-1"	15'-1"
REAR	10'-0"	13'-11" TO 16'-6"	16'-6" TO 19'-5"
ALLOWABLE HT. (ABOVE FBC - FREEBOA	35'-Ø" (MEAN RD / ELEVATIO		28'-2" (MEAN ROOF H
ZONING OSS	BHAD		

LIGHTING LEGEND:

4 54	MANUFACTURER: SPRING CITY *DLR-LEØ95-2G2-4Ø-CR3-GRI8-HSS

REQUEST:		
CODE SECTION	REQUIREMENT	PROPOSED REQUEST
FRONT YARD SETBACK	4.3.4(K) - 25'	6'-11"
SIDE YARD SETBACK	4.6.15(G)(1) - 10'	6'-5'
REAR YARD SETBACK	STREET - 4.6.15(GX1) - 10'	5'-Ø"
LOT COVERAGE	LOT COVERAGE - 4.3.4(K) - 40%	41.9%

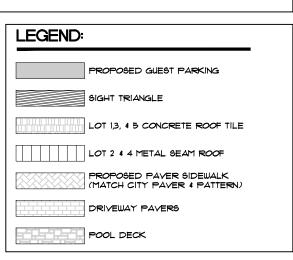

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ISSUED FOR

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PERMIT CONSTRUCTION

PROJECT TITLE RESIDENTIAL **DUPLEX** LOT 1

130 SE 1ST AVENUE DELRAY BEACH, FL

REVISIONS

REVISED 5/22/23 AS PER H.P.B.
COMMENTS:
I. ROTATE PLANS TO SHOW SITE
ORIENTED WITH NORTH TO THE TOP
OF THE PAGE.
2. PROPERTY DIMENSIONS HAVE
BEEN CHANGED TO BE IN FEET 4
INCLES

BEEN CHANGED TO BE IN FEET 4
INCHES.
3. DIMENSION STRINGS ADDED TO
WATERS EDGE AT POOLS.
4. 5'-0' SIDEWALK EASEMENT
DENOTED ON SE IST AVENUE AND
ALLEY SIDES OF LOTS.
5. EAST AND WEST SIDES OF LOTS
AREAS HAVE BEEN NOTED.
6. ADDED FAR CALCULATION TABLE.


FILE NUMBER 109A101A


DRAWING TITLE **PROPOSED LOT 1 PLAN**

DRAWN BY

GE/MJ 2.16.23 JOB NUMBER 20230109

DRAWING NUMBER

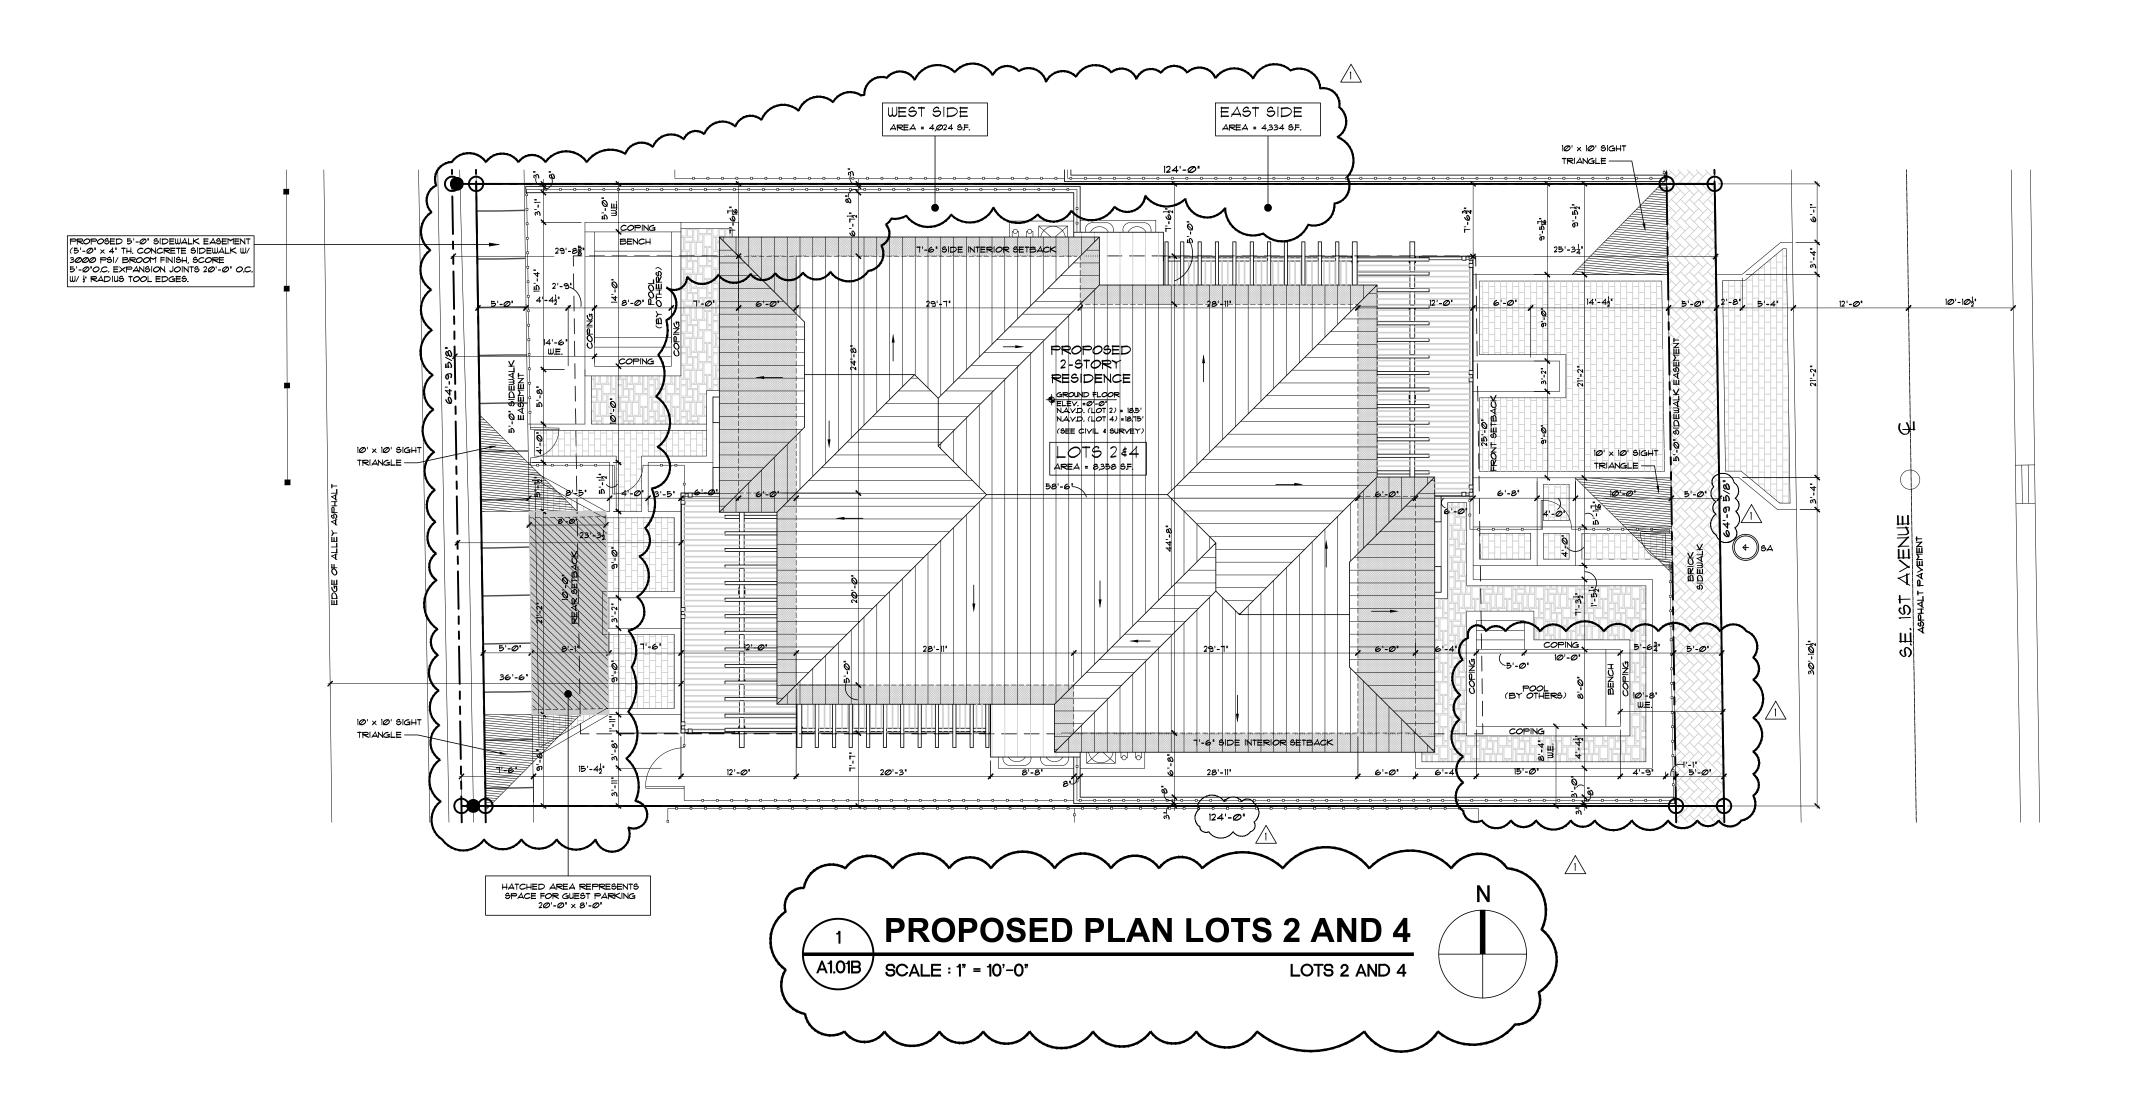

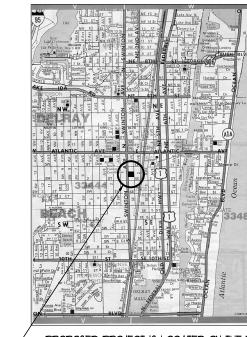

PROPOSED PROJECT IS LOCATED ON THE NW CORNER OF SW SECOND STREET AND SE FIRST AVENUE. N VICINITY MAP

NOTES:

- 1. DO NOT SCALE DRAWINGS!
 2. FIELD VERIFY ALL DIMENSIONS!
 3. CONTRACTOR TO VERIFY ALL EXISTING CONDITIONS, AND NOTIFY ARCHITECT IF ANY DESCRIPANCY W/ DRAWINGS, (SEE GENERAL NOTES)
- ALL AREA CALCULATIONS ARE APPROX.
 CONTRACTOR TO FIELD COORDINATE ALL ALL PROPOSED GRADE ELEVATIONS W/ CIVIL DRAWINGS.

I. IT IS THE INTENT OF THE ARCHITECT THAT THIS WORK BE IN CONFORMANCE WITH ALL REQUIREMENTS OF THE BUILDING AUTHORITIES HAVING JURISDICTION OVER THIS TYPE OF CONSTRUCTION AND OCCUPANCY. ALL CONTRACTORS SHALL DO THEIR WORK IN CONFORMANCE WITH ALL APPLICABLE CODES AND REGULATIONS. 2. THE CONTRACTOR SHALL VERIFY ALL CONDITIONS AND DIMENSIONS AT THE JOBSITE PRIOR TO COMMENCING WORK. THE CONTRACTOR SHALL REPORT ALL DISCREPANCIES BETWEEN THE DRAWINGS AND EXISTING CONDITIONS TO THE ARCHITECT PRIOR TO COMMENCING WORK. 3. CONTRACTOR SHALL SUPPLY LOCATE AND BUILD INTO THE WORK ALL INSERTS, ANCHORS, ANGLES, PLATES, OPENINGS, SLEEVES, HANGERS, SLAB DEPRESSIONS AND PITCHES AS MAY BE REQUIRED TO ATTACH AND ACCOMMODATE OTHER WORK. 4. ALL DETAILS AND SECTIONS SHOWN ON THE DRAWINGS ARE INTENDED TO BE TYPICAL AND SHALL BE CONSTRUCT TO APPLY TO ANY SIMILAR SITUATION ELSEWHERE IN THE WORK EXCEPT WHERE A DIFFERENT DETAIL IS SHOWN. 5. THESE DOCUMENTS, AS INSTRUMENTS OF SERVICE, ARE THE PROPERTY OF THE ARCHITECT AND MAY NOT BE USED OR REPPRODUCED WITHOUT EXPRESSED PRIOR WRITTEN CONSENT FROM THE ARCHITECT.

AREA CALCULATIONS	
TWO STORY DUPLEX (PER UNIT)	
PROPOSED FIRST FLOOR AREA UNDER A/C	
PROPOSED 2 CAR GARAGE PROPOSED FRONT COVERED PORCH	
PROPOSED FIRST FLOOR UNDER ROOF	
PROPOSED SECOND FLOOR UNDER A/C	
PROPOSED FRONT COVERED PORCH PROPOSED TRELLIS / TERRACE PORCH	
PROPOSED SECOND FLOOR UNDER ROOF	
TOTAL FLOOR UNDER A/C	
TOTAL FLOOR UNDER ROOF	
TOTAL SITE AREA	
TOTAL BLDG FOOTPRINT	
TOTAL LOT COVERAGE =	3,804 / 8,35
TOTAL IMPERVIOUS VS PERVIOUS AREA:	
TOTAL IMPERVIOUS AREA: (BUILDING FOOTPRINT, PAVERS, POOL ETC.)	
TOTAL PERVIOUS AREA (LANDSCAPING)	
TOTAL IMPERVIOUS AREA =	6,263 / 8,35
	2, 095 / 8,35
TOTAL PERVIOUS AREA =	· · · · ·


	TOTAL FLOOR AREA			6,584 SA
7	TOTAL LOT AREA			8,358 5/
	FLOOR AREA RATIO =			6,584 / 8,358 = 0.79
1				
	PROPOSED SE	TBACKS:		
		REQUIRED	PROPOSED GROUND FLOOR	PROPOSED SECOND FLOOR
	FRONT	25'-Ø"	25'-3" TO 33'-11"	33'-11" TO 39'-4"
	SIDE INTERIOR (NORTH)	7'-6"	7'-6"	7'-6"
	SIDE INTERIOR (SOUTH)	7'-6"	יד-יד י	"ד-יד
	REAR	10'-0"	11'-7" TO 20'-2"	20'-2" TO 25'-7"
	ALLOWABLE HT. (ABOVE FBC - FREEBO)			-Ø" (MEAN ROOF HT.
	ZONING OS	SHAD		

FAR CALCULATIONS

LIGHTING LEGEND:

(+) 5A	MANUFACTURER: SPRING CITY *DLR-LEØ95-2G2-4Ø-CR3-GRIB-HSS
Γ VARIANCE RE	EQUEST ITEMS:

REQUEST:		
CODE SECTION	REQUIREMENT	PROPOSED REQUEST
FRONT YARD SETBACK	4.3.4(K) - 25'	10'-8 "
SIDE YARD SETBACK	4.6.15(G)(1) - 10'	5'-0"
REAR YARD SETBACK	STREET - 4.6.15(GX1) - 10'	5'-Ø"
LOT COVERAGE	LOT COVERAGE - 4.3.4(K) - 40%	45.5%

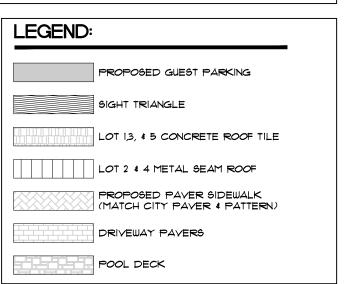

architecture, inc.

architecture, planning and design

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ISSUED FOR

BIDS

PERMIT

CONSTRUCTION

RESIDENTIAL
DUPLEX
LOTS 2 AND 4

130 SE 1ST AVENUE DELRAY BEACH, FL

REVISIONS

REVISED 5/22/23 AS PER H.P.B.
COMMENTS:

1. ROTATE PLANS TO SHOW SITE
ORIENTED WITH NORTH TO THE TOP
OF THE PAGE.

2. PROPERTY DIMENSIONS HAVE
BEEN CHANGED TO BE IN FEET 4
INCHES.

3. DIMENSION STRINGS ADDED TO
WATERS EDGE AT POOLS.

4. 5'-Ø' SIDEWALK EASEMENT
DENOTED ON SE IST AVENUE AND
ALLEY SIDES OF LOTS.

5. EAST AND WEST SIDES OF LOTS
AREAS HAVE BEEN NOTED.

6. ADDED FAR CALCULATION TABLE.

FILE NUMBER 109A101B

DRAWING TITLE

DRAWING TITLE

PROPOSED


PLAN

2.16.23 DRAWN BY GE/MJ

JOB NUMBER 20230109

LOTS 2 AND 4

A1.01B

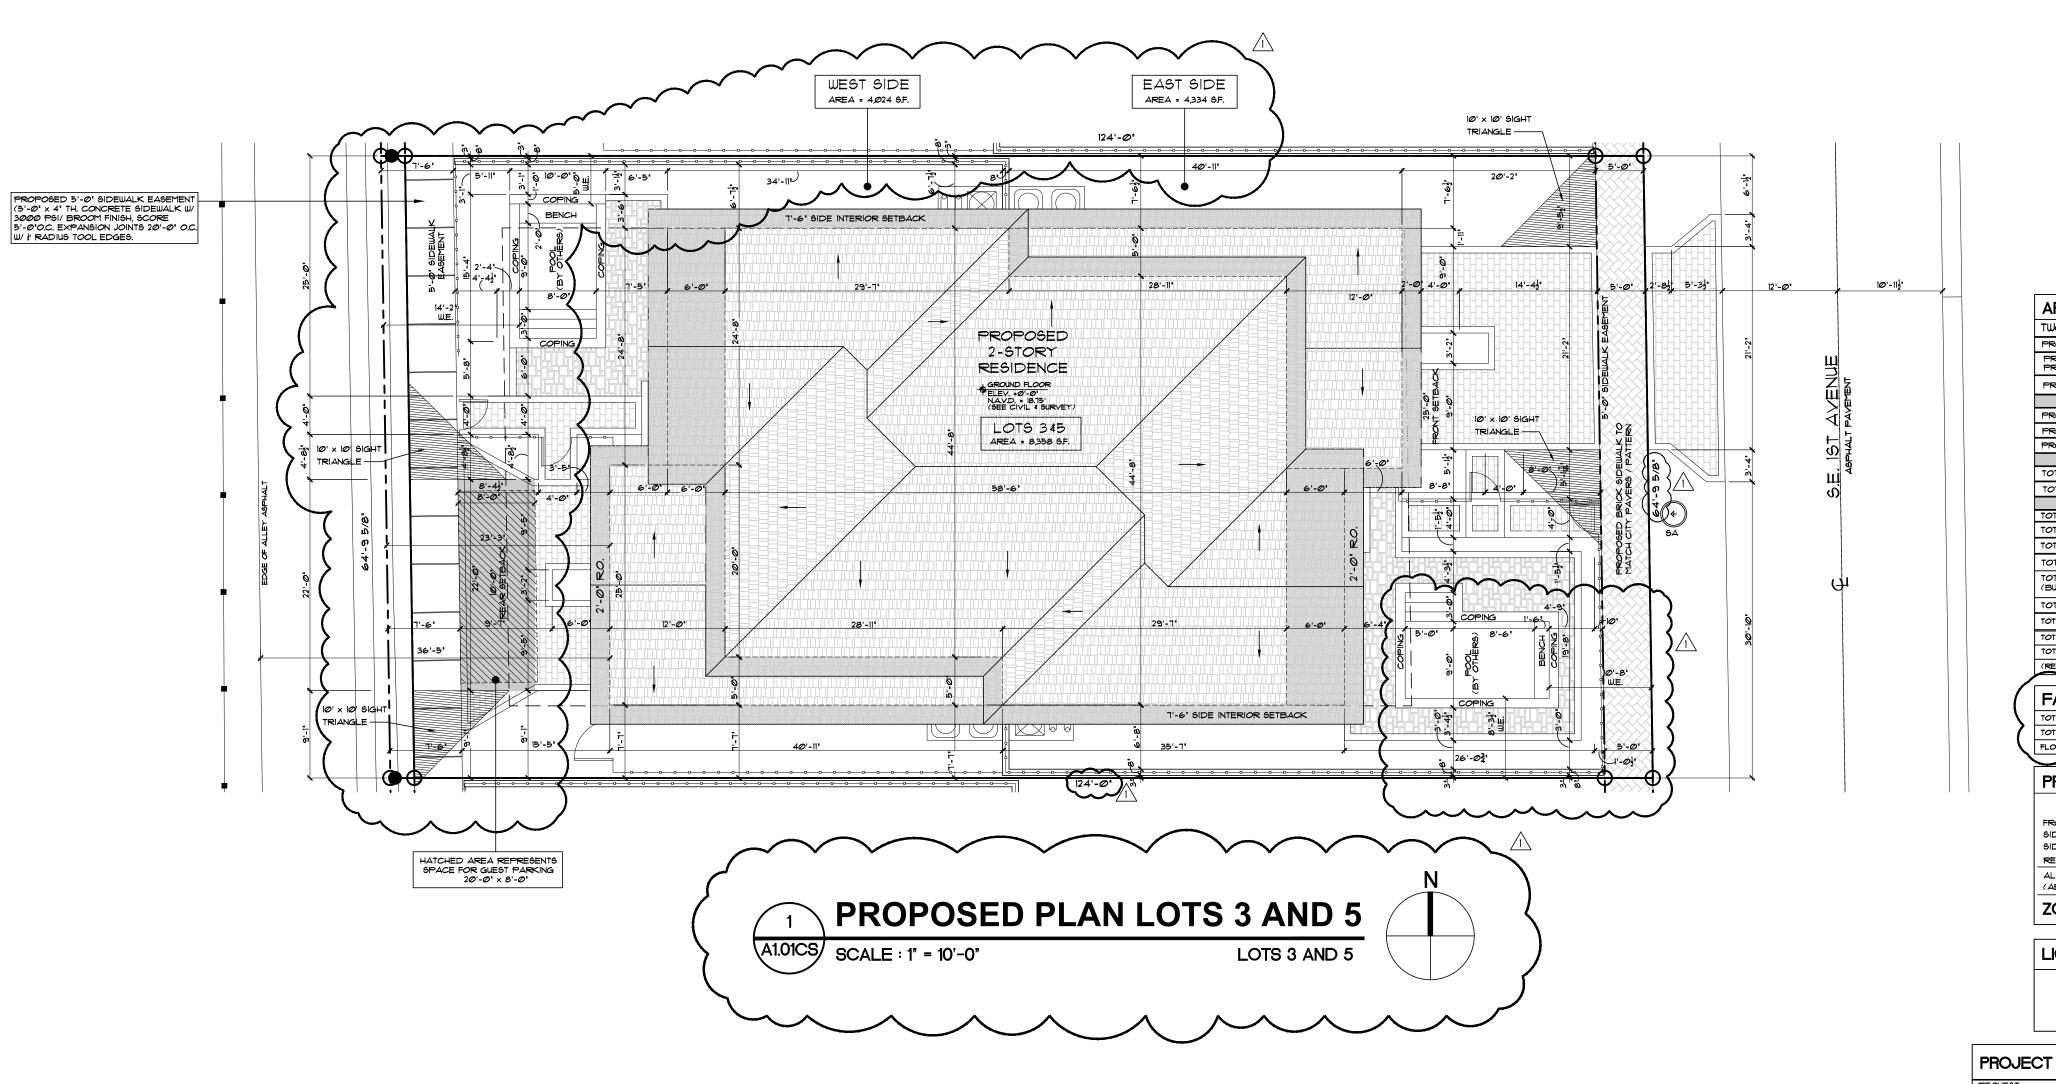



- PROPOSED PROJECT IS LOCATED ON THE NW
CORNER OF SW SECOND STREET AND SE FIRST
AVENUE.

VICINITY MAP

NOTES:

- DO NOT SCALE DRAWINGS!
 FIELD VERIFY ALL DIMENSIONS!
 CONTRACTOR TO VERIEY ALL EVIST.
- 3. CONTRACTOR TO VERIFY ALL EXISTING CONDITIONS, AND NOTIFY ARCHITECT IF ANY DESCRIPANCY W/ DRAWINGS. (SEE GENERAL NOTES)

 4. ALL AREA CALCULATIONS ARE APPROX.
- CONTRACTOR TO FIELD COORDINATE ALL ALL PROPOSED GRADE ELEVATIONS W/ CIVIL DRAWINGS.

GENERAL NOTES:

I. IT IS THE INTENT OF THE ARCHITECT THAT THIS WORK BE IN CONFORMANCE WITH ALL REQUIREMENTS OF THE BUILDING AUTHORITIES HAVING JURISDICTION OVER THIS TYPE OF CONSTRUCTION AND OCCUPANCY. ALL CONTRACTORS SHALL DO THEIR WORK IN CONFORMANCE WITH ALL APPLICABLE CODES AND REGULATIONS.

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4. ALL DETAILS AND SECTIONS SHOWN ON THE DRAWINGS ARE INTENDED TO BE TYPICAL AND SHALL BE CONSTRUED TO APPLY TO ANY SIMILAR SITUATION ELSEWHERE IN THE WORK EXCEPT WHERE A DIFFERENT DETAIL IS SHOWN.

5. THESE DOCUMENTS, AS INSTRUMENTS OF SERVICE,
ARE THE PROPERTY OF THE ARCHITECT AND MAY NOT
BE USED OR REPRODUCED WITHOUT EXPRESSED
BRIDE UBLITTENT COMEDITE FROM THE ARCHITECT

AREA CALCULATIONS	
TWO STORY DUPLEX (PER UNIT)	
PROPOSED FIRST FLOOR AREA UNDER A/C	1,192 S
PROPOSED 2 CAR GARAGE PROPOSED FRONT COVERED PORCH	562 S 148 S
PROPOSED FIRST FLOOR UNDER ROOF	1,902 8
PROPOSED SECOND FLOOR UNDER A/C	1,242 5.
PROPOSED FRONT COVERED PORCH	148 S
PROPOSED SECOND FLOOR UNDER ROOF	1,390 8
TOTAL FLOOR UNDER A/C	2,434 5.
TOTAL FLOOR UNDER ROOF	3,292 6
TOTAL SITE AREA	8,358 6.
TOTAL BLDG FOOTPRINT	3 <i>80</i> 4 9
TOTAL LOT COVERAGE =	3,804 / 8,358 = 45.1
TOTAL IMPERVIOUS VS PERVIOUS AREA:	
TOTAL IMPERVIOUS AREA: (BUILDING FOOTPRINT, PAVERS, POOL ETC.)	6263 9
TOTAL PERVIOUS AREA (LANDSCAPING)	2, 0 95 8
TOTAL IMPERVIOUS AREA =	6,263 / 8,358 = 75.0
TOTAL PERVIOUS AREA =	2,095 / 8,358 = 25.0
TOTAL PERVIOUS + IMPERVIOUS AREA=	2,095 + 6,263 = 8,358 = 109

PROPOSED SETBACKS:

> MANUFACTURER: SPRING CITY *DLR-LE095-2G2-40-CR3-GR18-HSS

LIGHTING LEGEND:


Ф 5А

PROJECT VARIANCE REQUEST ITEMS:

REQUEST:

CODE SECTION REQUIREMENT PROPOSED REQUEST

REQUEST: CODE SECTION REQUIREMENT PROPOSED REQUEST FRONT YARD SETBACK 4.3.4(K) - 25' 10'-8' SIDE YARD SETBACK 4.5.15(GXI) - 10' 5'-0' REAR YARD SETBACK STREET - 4.6.15(GXI) - 10' 5'-0' LOT COVERAGE LOT COVERAGE - 4.3.4(K) - 40% 45.5% W.E. = WATER EDGE (POOL). LEGEND: PROPOSED GUEST PARKING

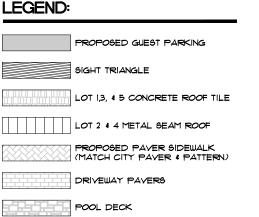



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CONSTRUCTION

RESIDENTIAL DUPLEX

LOTS 3 AND 5

130 SE 1ST AVENUE DELRAY BEACH, FL

REVISIONS

REVISED 5/22/23 AS PER H.P.B.
COMMENTS:

1. ROTATE PLANS TO SHOW SITE
ORIENTED WITH NORTH TO THE TOP
OF THE PAGE.

2. PROPERTY DIMENSIONS HAVE
BEEN CHANGED TO BE IN FEET 4
INCHES.

3. DIMENSION STRINGS ADDED TO
WATERS EDGE AT POOLS.

4. 5'-2' SIDEWALK EASEMENT
DENOTED ON SE 1ST AVENUE AND
ALLEY SIDES OF LOTS.

5. EAST AND WEST SIDES OF LOTS
AREAS HAVE BEEN NOTED.

6. ADDED FAR CALCULATION TABLE.

FILE NUMBER

109A101C

DRAWING TITLE

PROPOSED

PLAN
LOTS 3 AND 5

DATE
2.16.23 DRAWN BY
GE/MJ

^{.R} **20230109**

A1.01CS





1 1045 East Atlantic Ave. Suite 303 E Delray Beach, Florida 33483 ETL: 561-276-6011 FAX: 561-276-6129

ISSUED FOR

BIDS

PERMIT CONSTRUCTION

VICINITY MAP

1. DO NOT SCALE DRAWINGS!
2. FIELD VERIFY ALL DIMENSIONS!
3. CONTRACTOR TO VERIFY ALL
EXISTING CONDITIONS, AND NOTIFY
ARCHITECT IF ANY DESCRIPANCY W/
DRAWINGS. (SEE GENERAL NOTES)
4. ALL AREA CALCULATIONS ARE APPROX.

PROJECT TITLE

RESIDENTIAL DUPLEX

130 SE 1ST AVENUE DELRAY BEACH, FL

REVISIONS

REVISED 5/22/23 AS PER H.P.B.
COMMENTS:

1. ROTATE PLAN TO SHOW SITE
ORIENTED WITH NORTH TO THE TOP
OF THE PAGE.

2. LOCATION OF DRIVEWAYS OF
ADJACENT PROPERTIES HAVE BEEN
LABELED.

3. APPROXIMATE LOCATION OF
SURROUNDING STRUCTURES ADDED
TO DRAWING.

FILE NUMBER 109A102


DRAWING TITLE

ARCHITECTURAL CONTEXT PLAN

GE/BM 3.31.23

20230109

AREA CALCULATIONS - FOR UNITS A AND B	
PROPOSED FIRST FLOOR UNDER A/C	1,Ø75 S/F
PROPOSED 2 CAR GARAGE	558 S/F
PROPOSED FRONT COVERED PORCH	118 S/F
PROPOSED SIDE TERRACE	199 S/F
PROPOSED FIRST FLOOR UNDER ROOF	1,751 S/F
PROPOSED SECOND FLOOR UNDER A/C	1,339 S/F
PROPOSED FRONT COVERED PORCH	118 S/F
PROPOSED TRELLIS / TERRACE PORCH	128 S/F
PROPOSED SIDE COVERED PORCH	114 S/F
PROPOSED SECOND FLOOR UNDER ROOF	1,571 S/F
TOTAL FLOOR UNDER A/C	2,414 S/F
TOTAL FLOOR UNDER ROOF	3,322 S/F

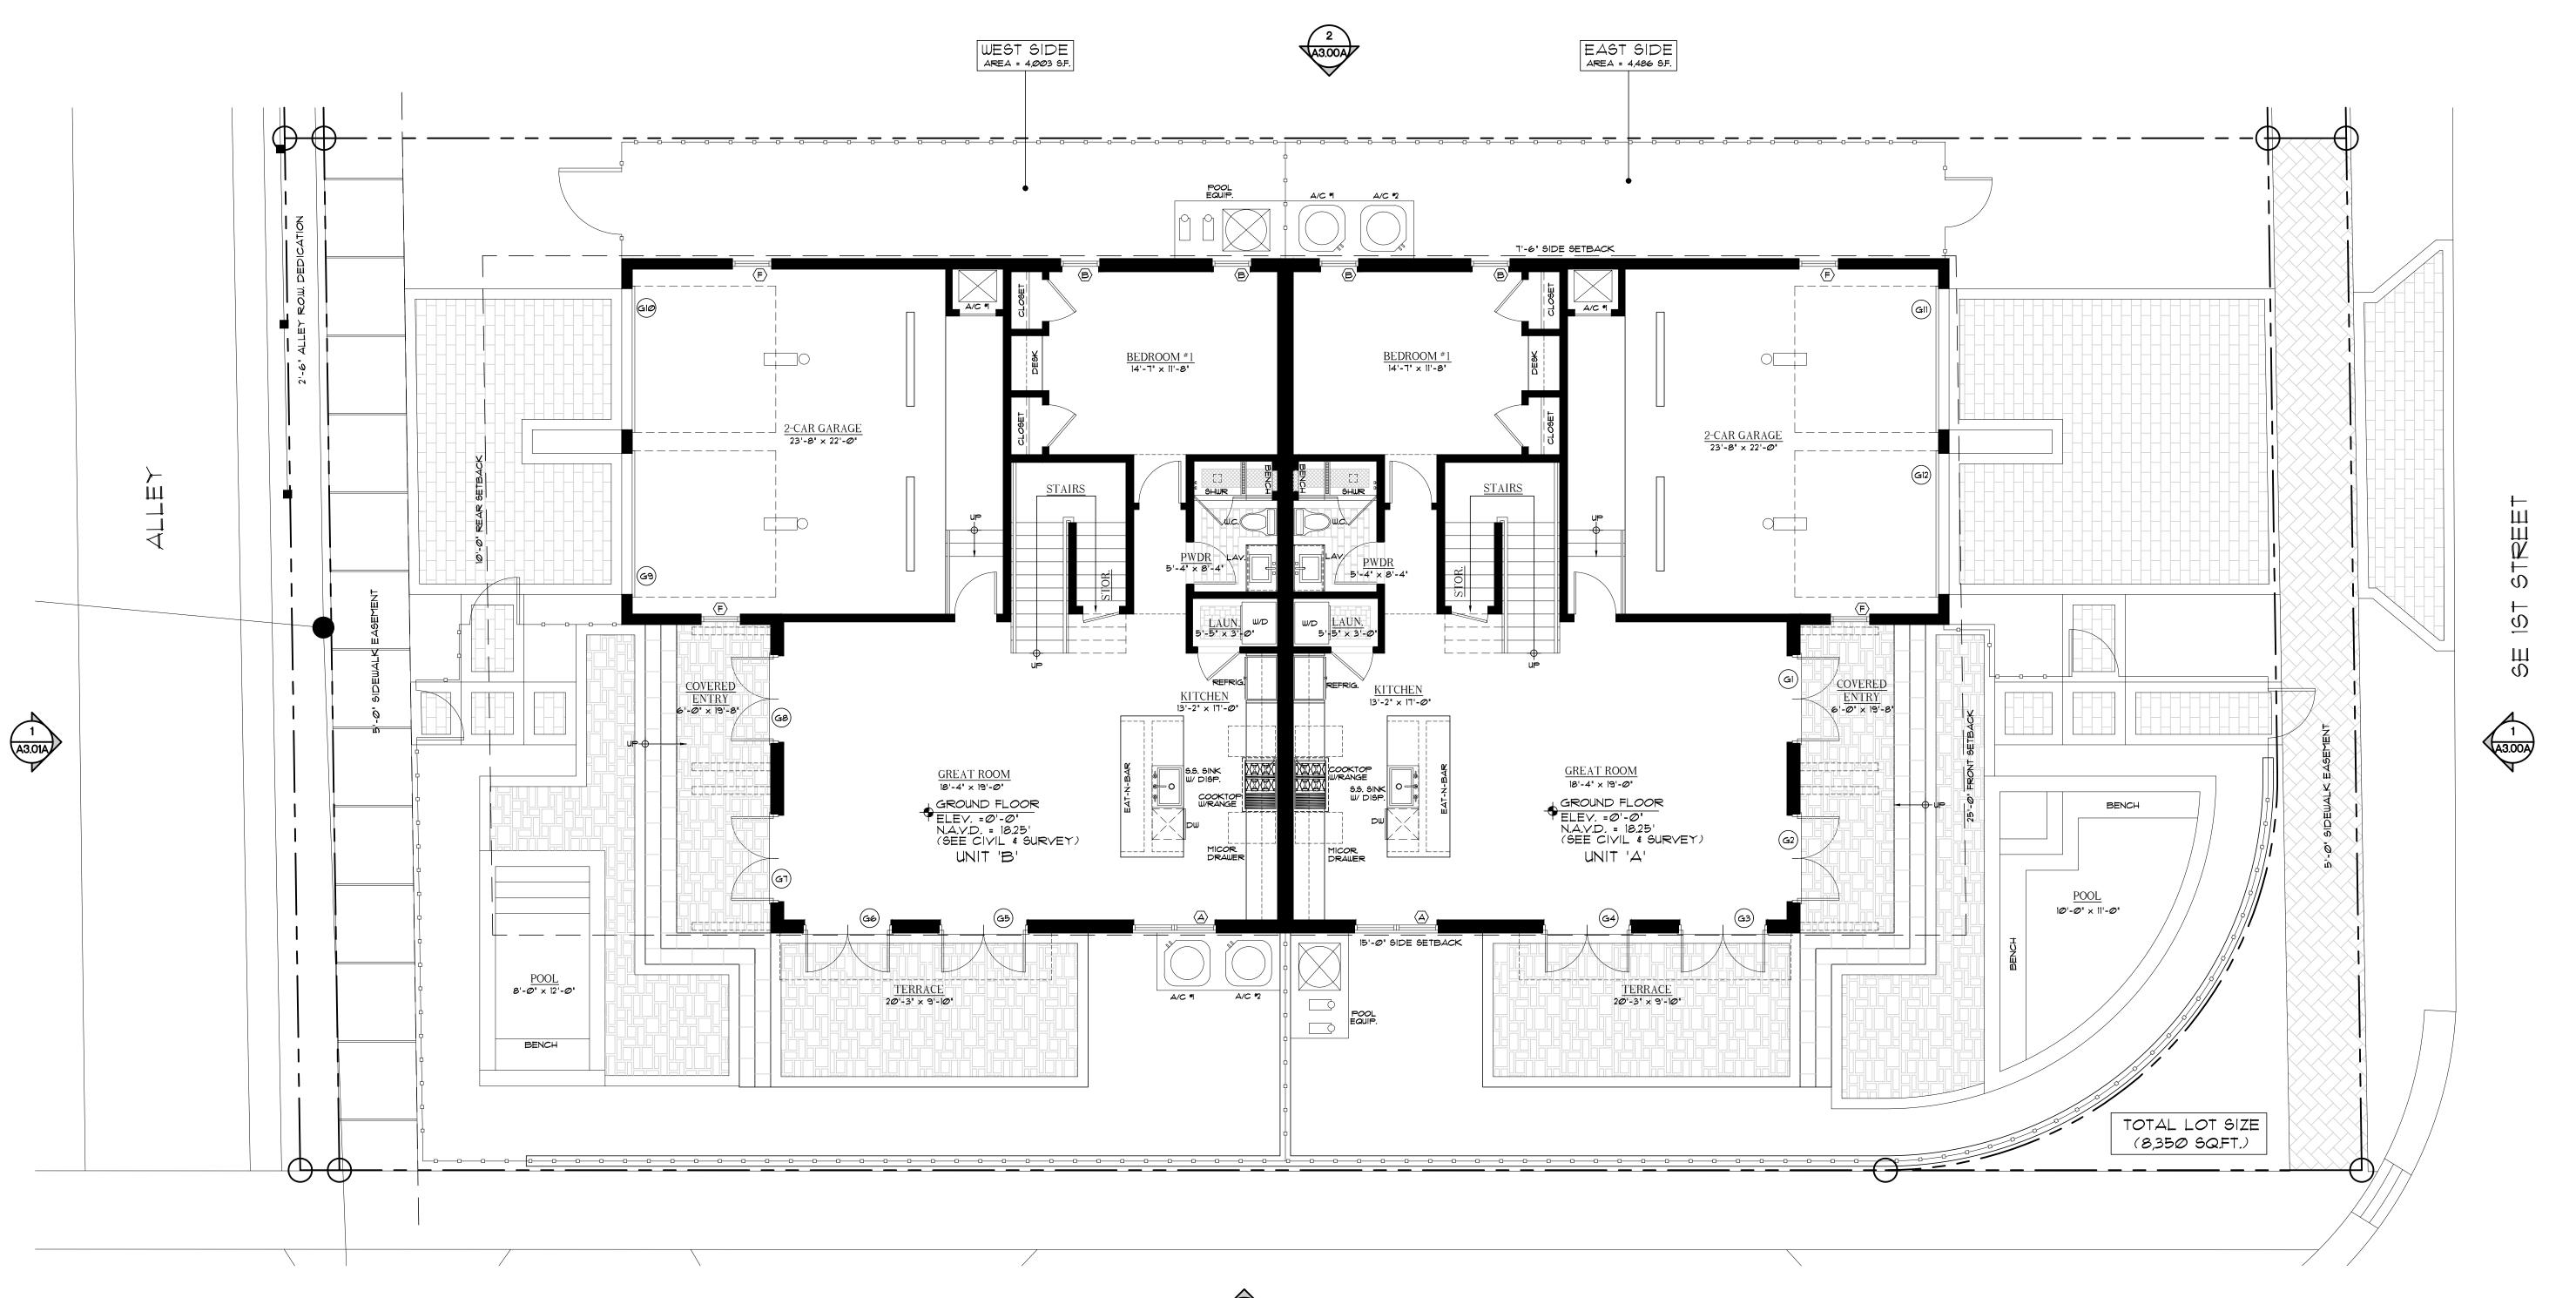



NOTES:

1. DO NOT SCALE DRAWINGS! 2. FIELD VERIFY ALL DIMENSIONS! 3. CONTRACTOR TO VERIFY ALL EXISTING CONDITIONS, AND NOTIFY ARCHITECT IF ANY DESCRIPANCY W/ DRAWINGS. (SEE GENERAL NOTES)

4. ALL AREA CALCULATIONS ARE APPROX.



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ISSUED FOR

BIDS

PERMIT

CONSTRUCTION

PROJECT TITLE **RESIDENTIAL DUPLEX**

LOT 1

130 SE 1ST AVENUE DELRAY BEACH, FL

REVISIONS

FILE NUMBER 109A200


DRAWING TITLE PROPOSED GROUND **FLOOR PLAN** LOT 1


GE/MJ 1-31-23 JOB NUMBER 20230109

DRAWING NUMBER

A2.00A

AREA CALCULATIONS	
PROPOSED FIRST FLOOR UNDER A/C	1,Ø75
PROPOSED 2 CAR GARAGE	558
PROPOSED FRONT COVERED PORCH	118
PROPOSED SIDE TERRACE	199
PROPOSED FIRST FLOOR UNDER ROOF	1,751
PROPOSED SECOND FLOOR UNDER A/C	1,339
PROPOSED FRONT COVERED PORCH	118
PROPOSED TRELLIS / TERRACE PORCH	128
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PROPOSED SECOND FLOOR UNDER ROOF	1,571 \$
TOTAL FLOOR UNDER A/C	2,414
TOTAL FLOOR UNDER ROOF	3.322

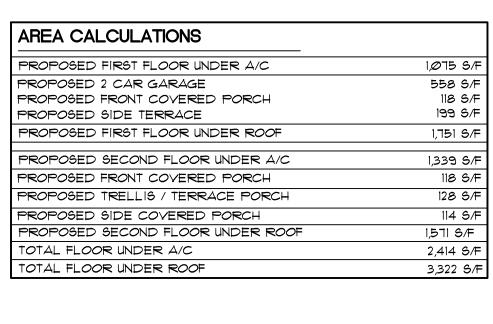

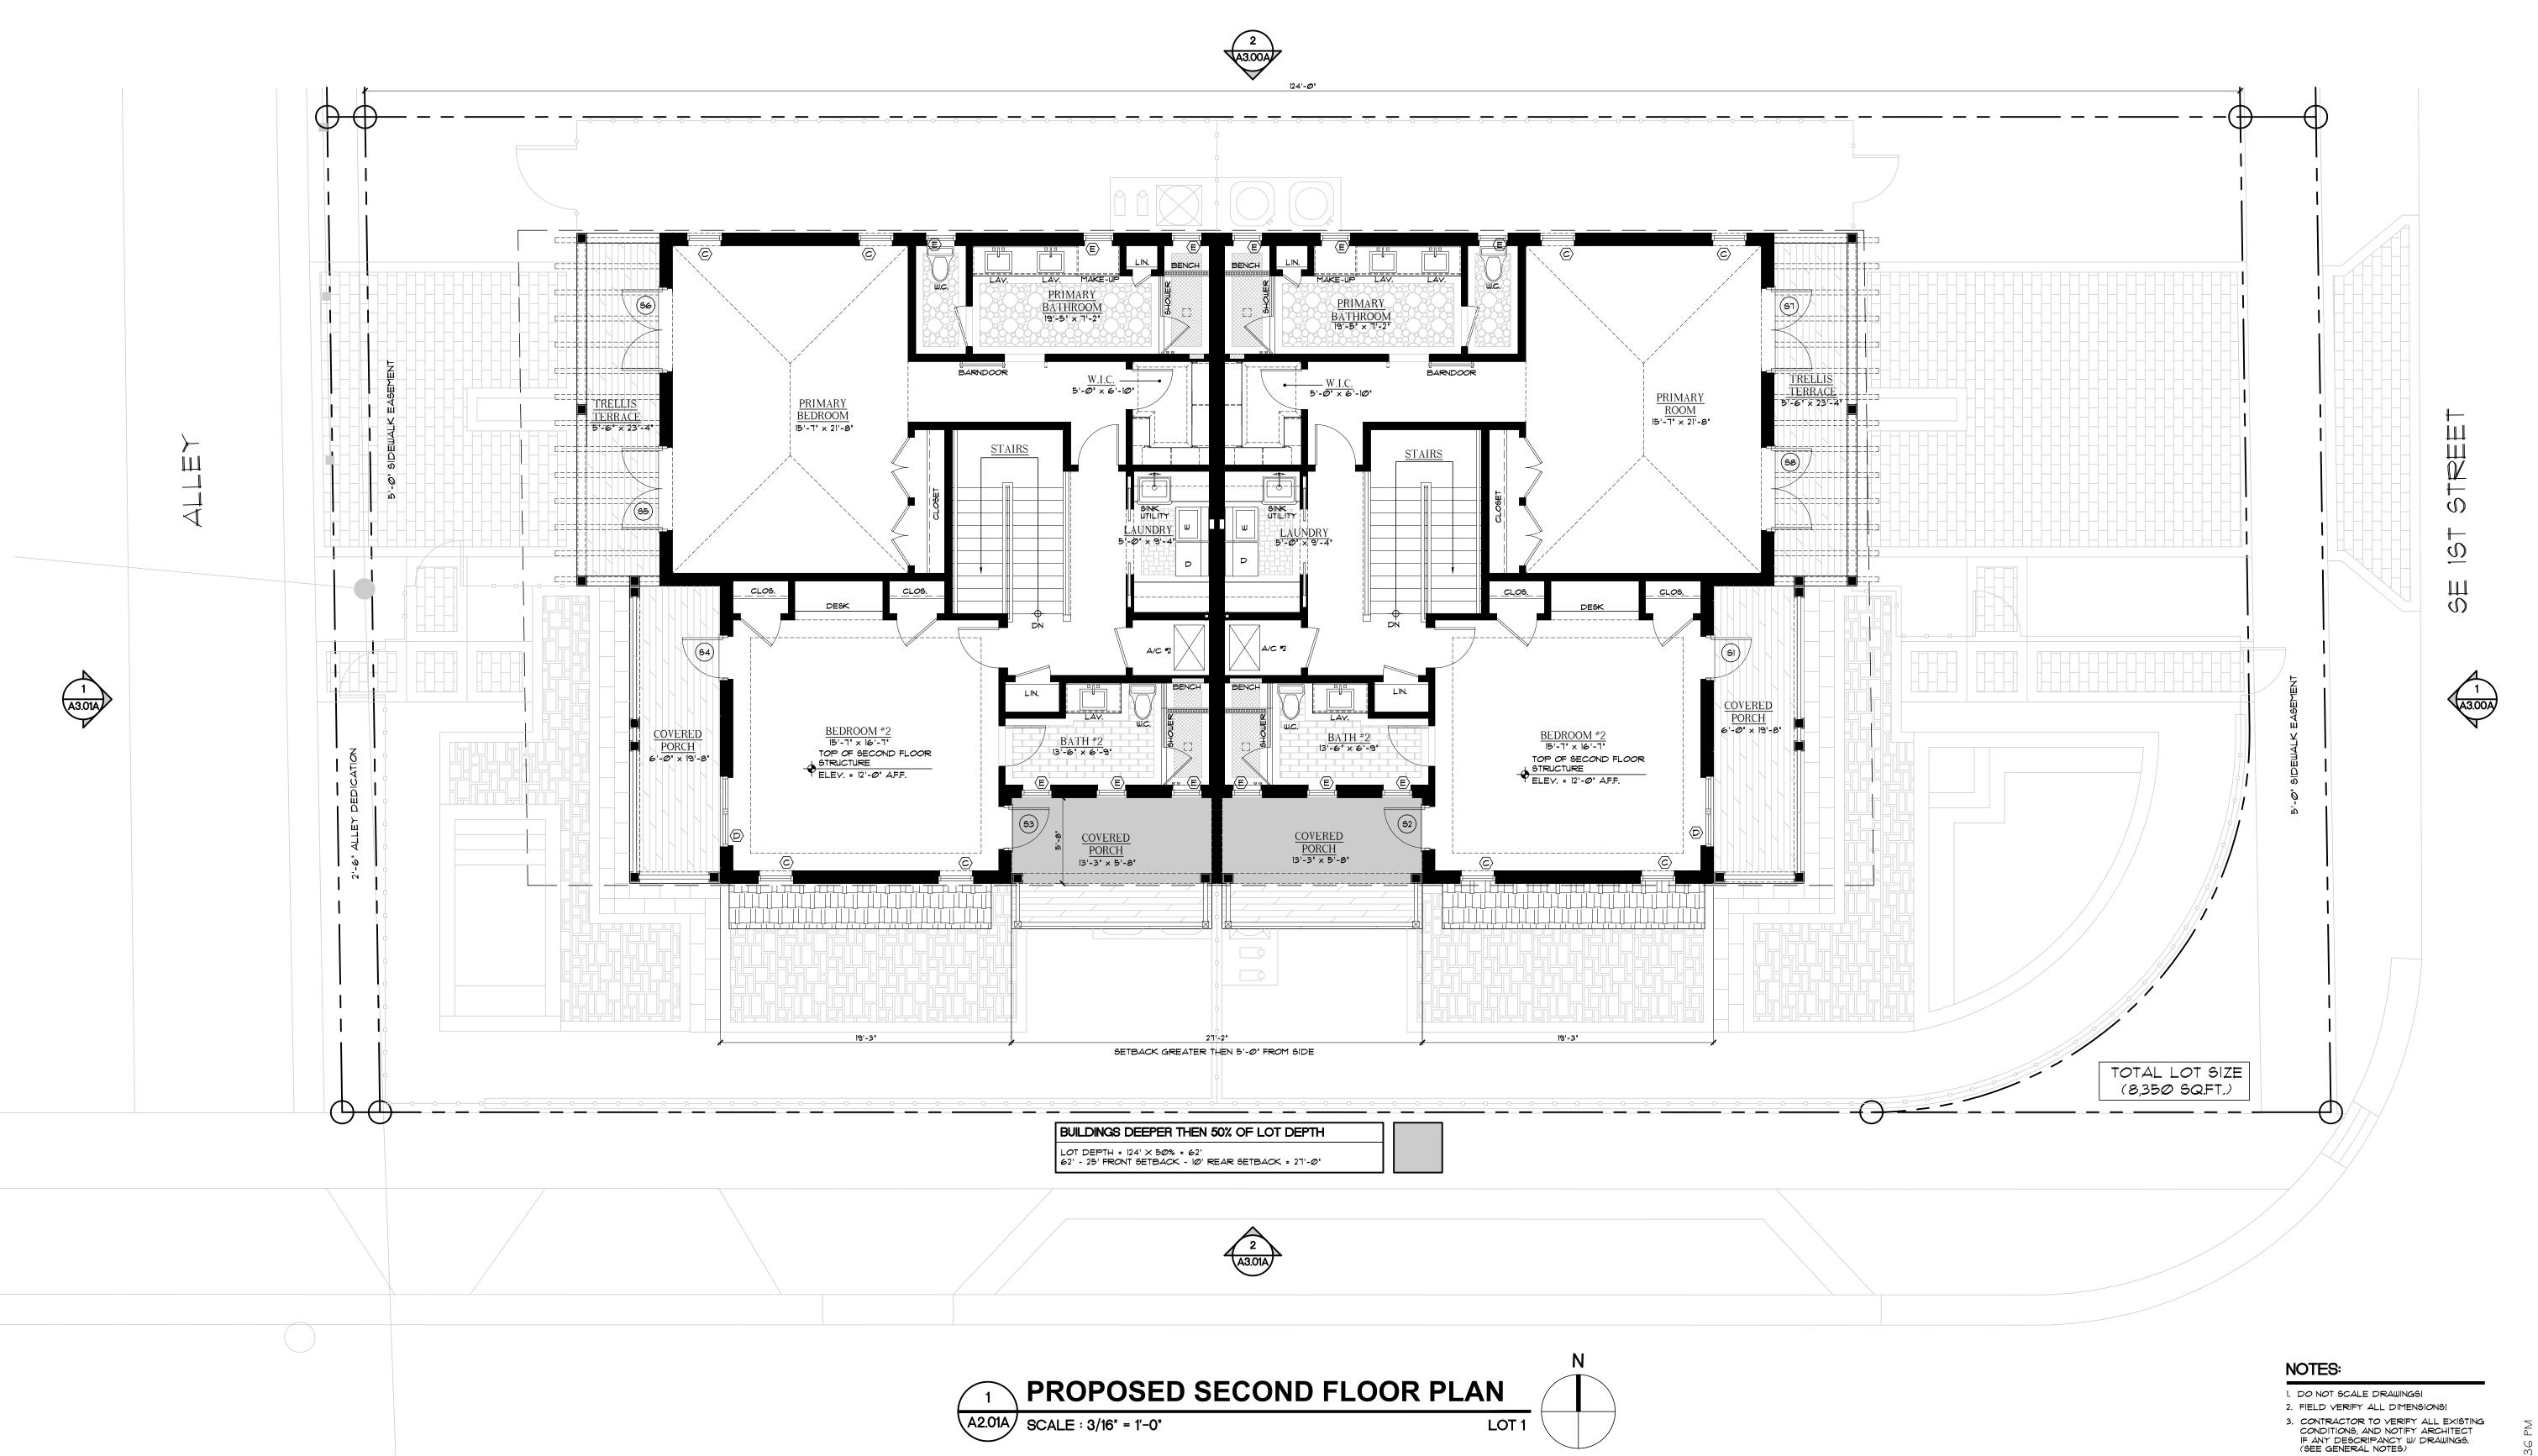

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CONSTRUCTION

PROJECT TITLE

RESIDENTIAL DUPLEX LOT 1

130 SE 1ST AVENUE DELRAY BEACH, FL

REVISIONS

FILE NUMBER 109A200

, DRAWING TITLE


PROPOSED SECOND FLOOR PLAN LOT 1

1-31-23 GE/MJ

20230109

4. ALL AREA CALCULATIONS ARE APPROX.

A2.01A

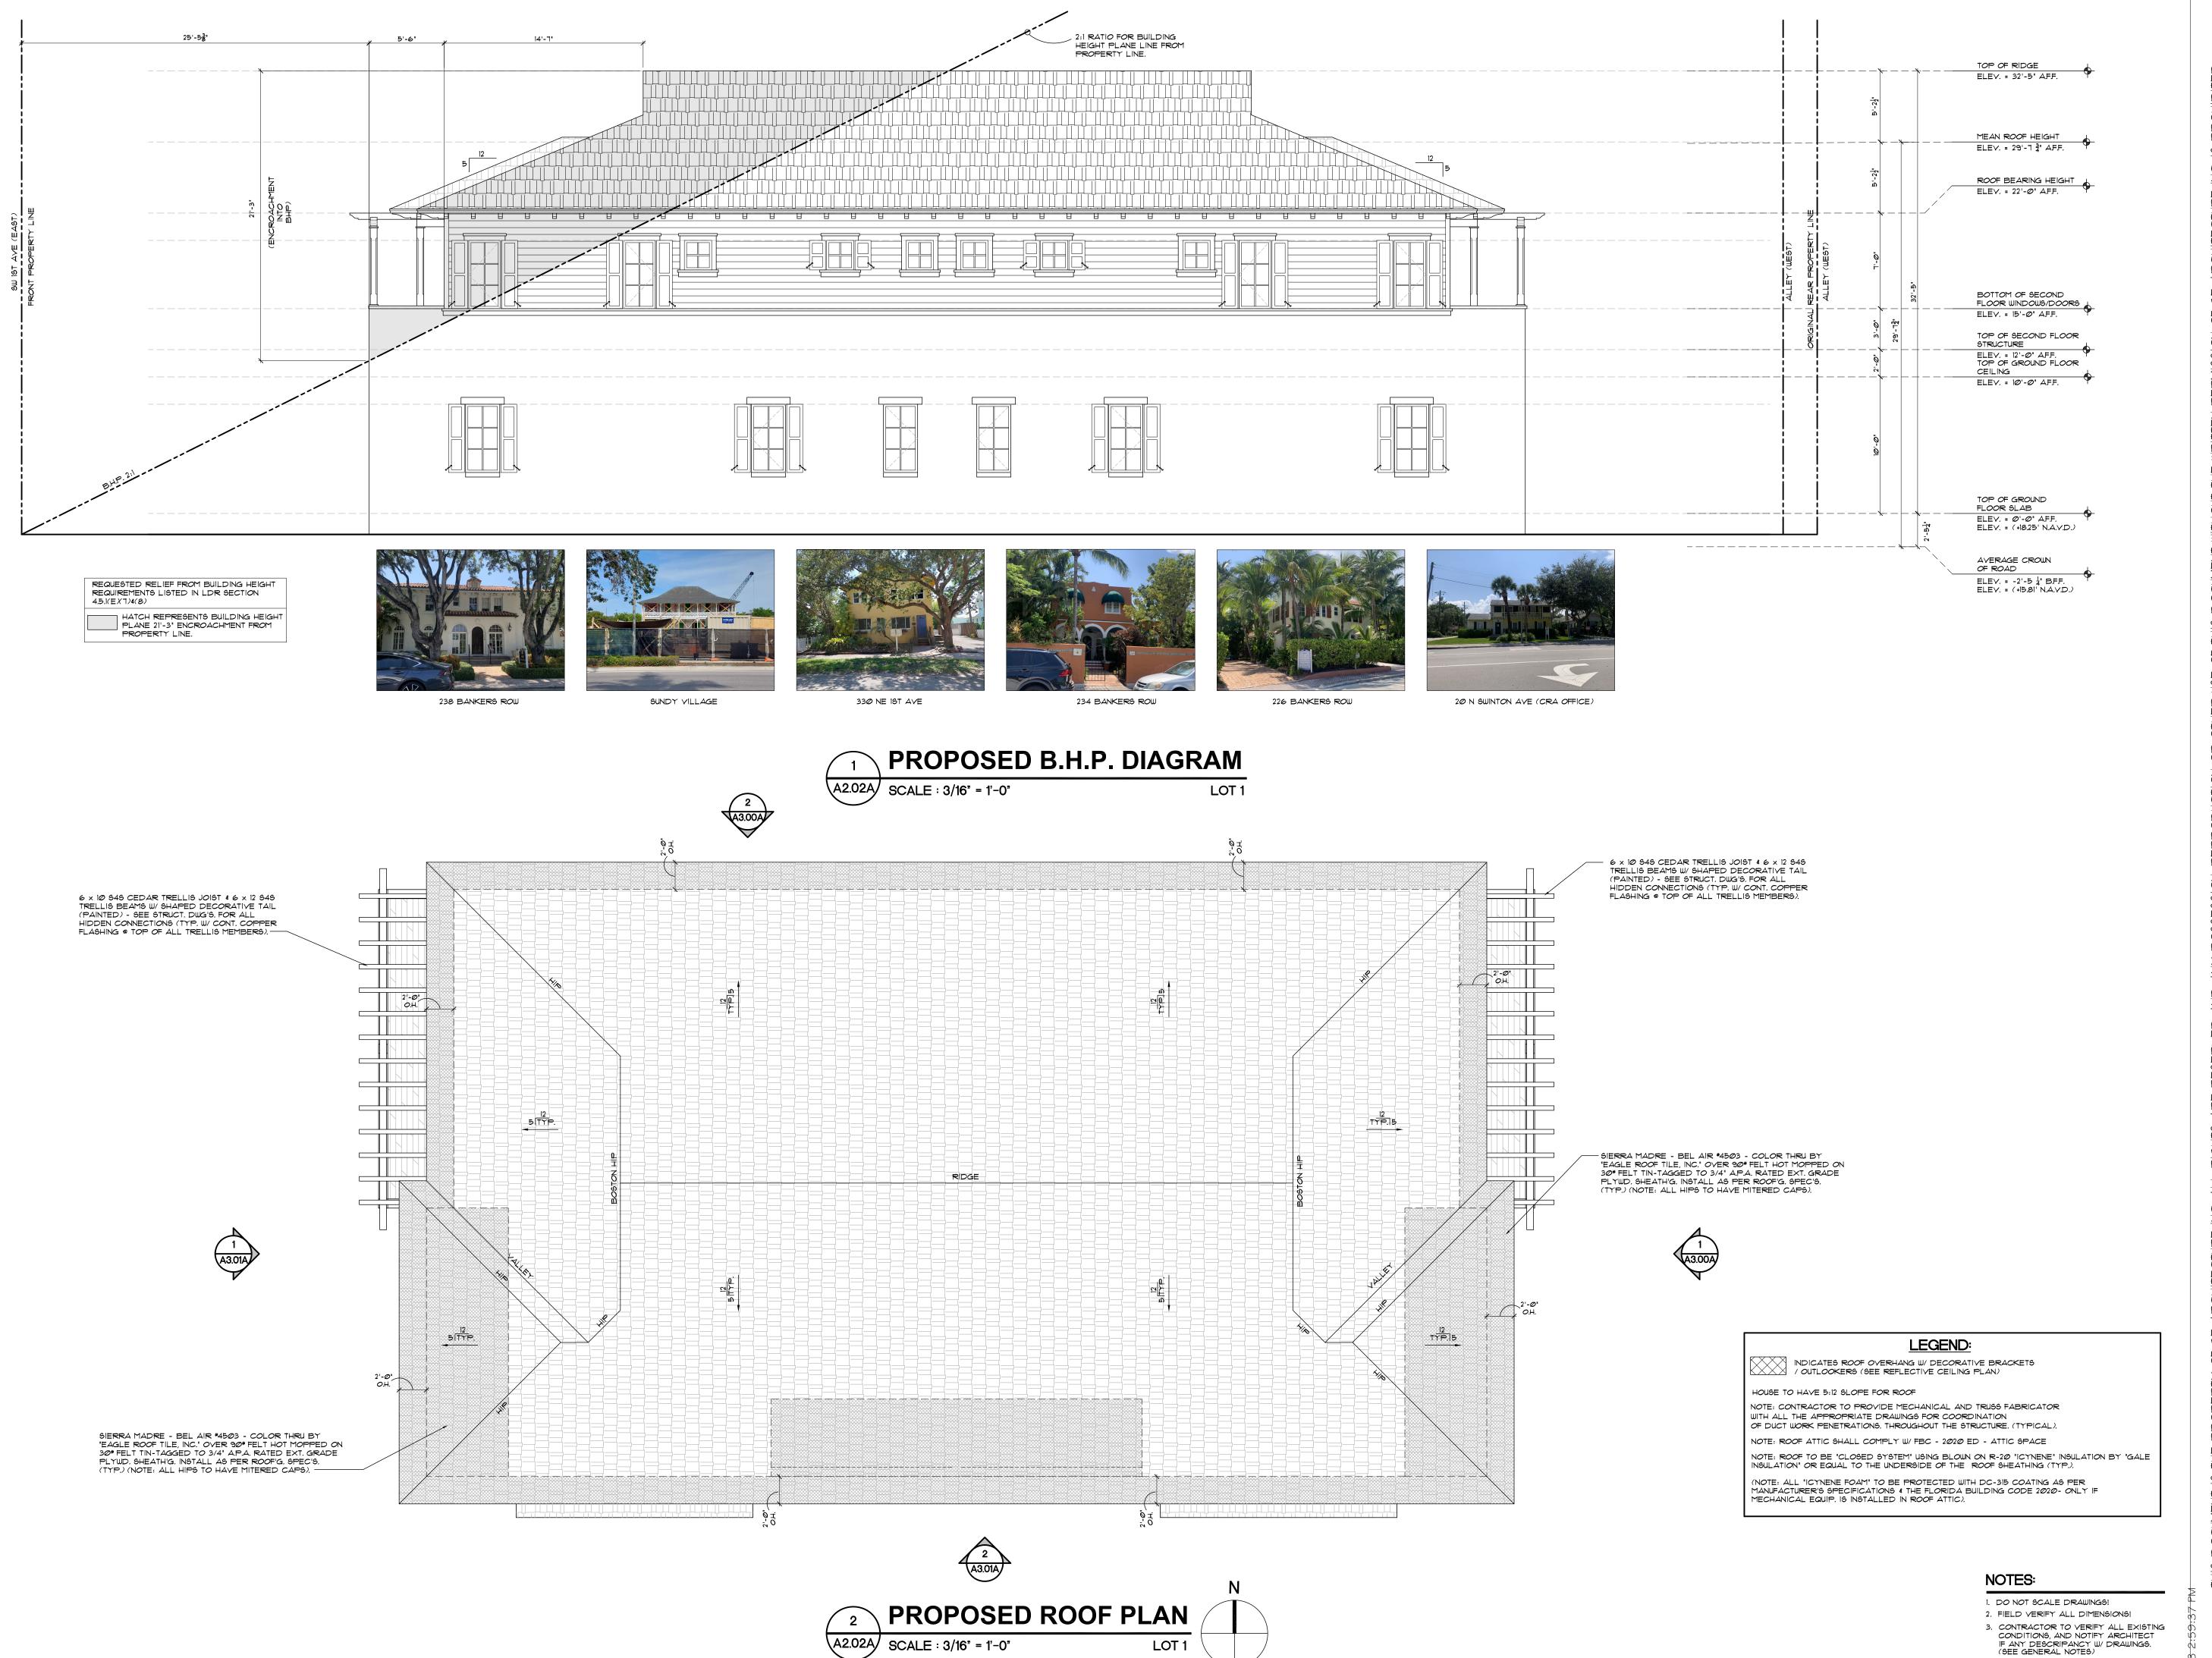

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PROJECT TITLE

RESIDENTIAL DUPLEX LOT 1

130 SE 1ST AVENUE DELRAY BEACH, FL

REVISIONS

FILE NUMBER

109A202A

DRAWING TITLE

PROPOSED ROOF PLAN LOT 1

1-31-23

4. ALL AREA CALCULATIONS ARE APPROX.


JOB NUMBER 20230109


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GE/MJ

DRAWING NUMBER

A2.02A



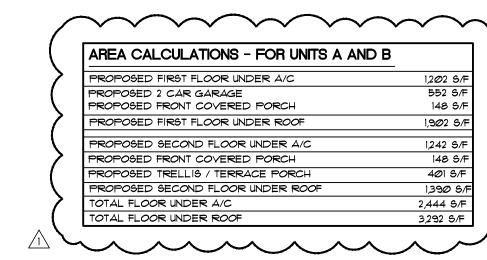

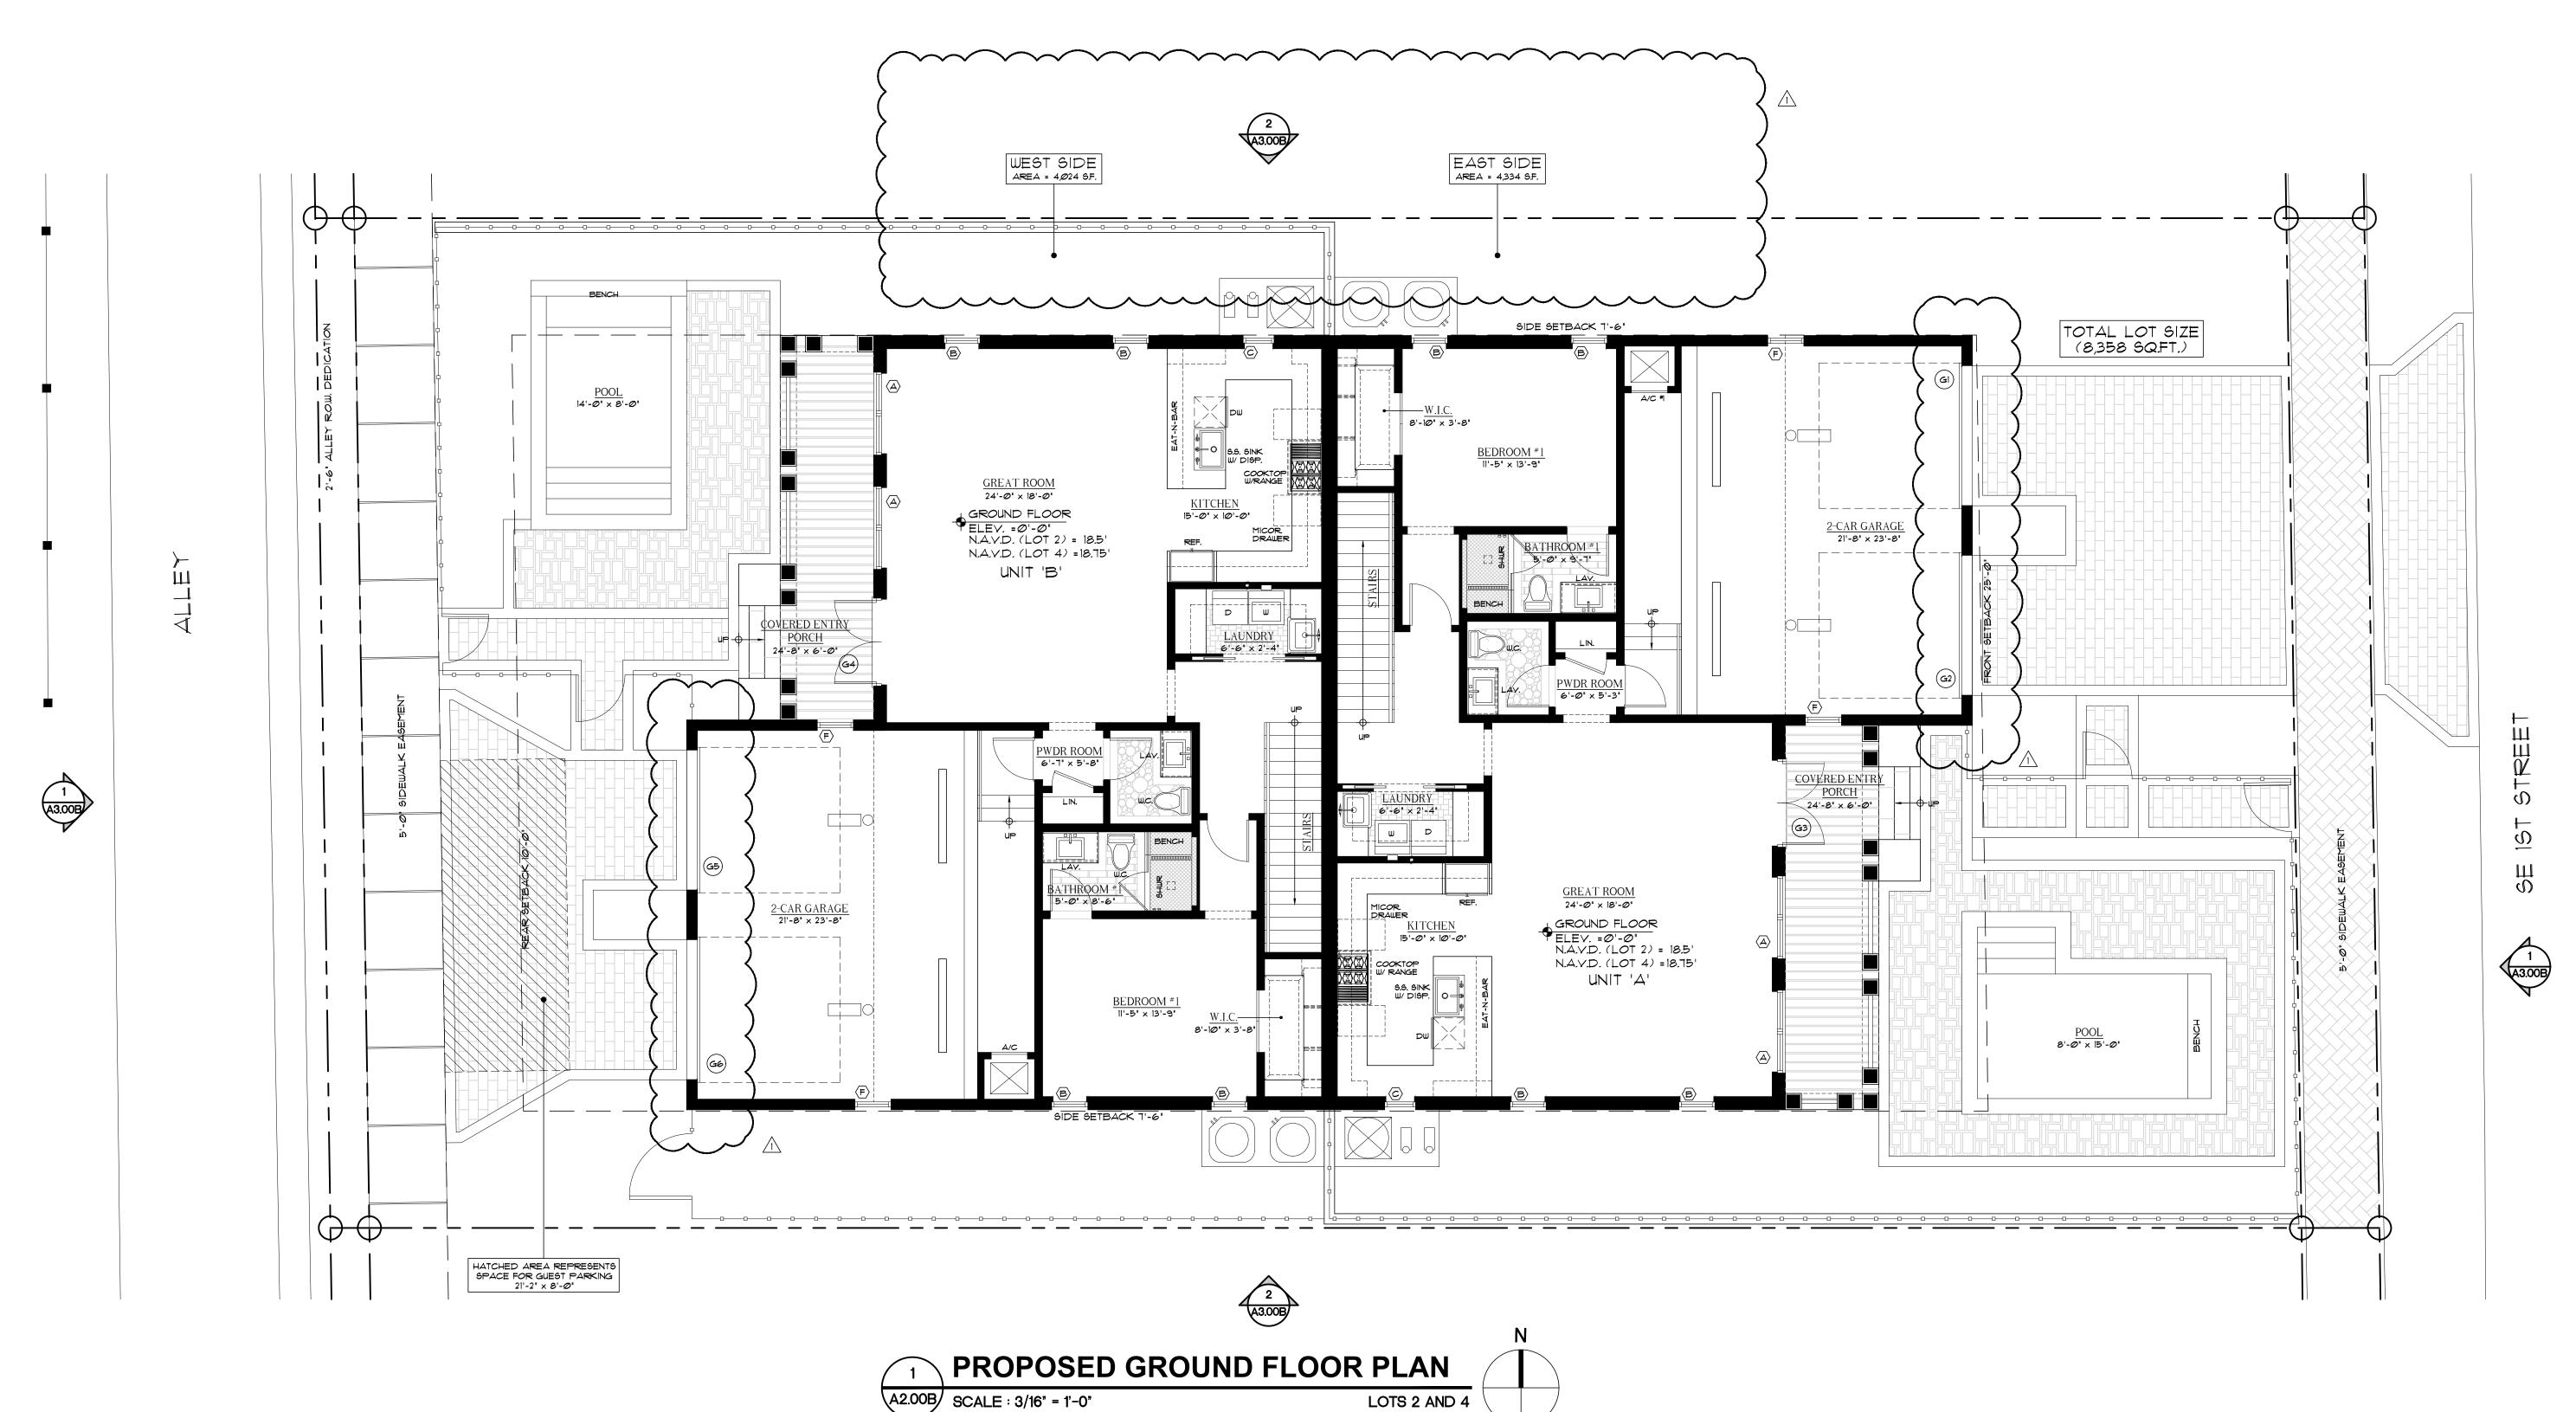1. DO NOT SCALE DRAWINGS! 2. FIELD VERIFY ALL DIMENSIONS! 3. CONTRACTOR TO VERIFY ALL EXISTING CONDITIONS, AND NOTIFY ARCHITECT IF ANY DESCRIPANCY W/ DRAWINGS. (SEE GENERAL NOTES)

4. ALL AREA CALCULATIONS ARE APPROX.

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CONSTRUCTION

PROJECT TITLE RESIDENTIAL DUPLEX

LOTS 2 AND 4

130 SE 1ST AVENUE **DELRAY BEACH, FL**

REVISIONS

REVISED 5/22/23 AS PER H.P.B.

COMMENTS:

I. DUPLEX PLANS HAVE BEEN
MODIFIED IN ORDER TO MEET 4,000
SF DUPLEX LOT REQUIREMENT.

FILE NUMBER 109A200B

DRAWING TITLE **PROPOSED** GROUND **FLOOR PLAN** LOTS 2 AND 4


> GE/MJ 2.15.23 JOB NUMBER

20230109 DRAWING NUMBER

A2.00B

AREA CALCULATIONS	
PROPOSED FIRST FLOOR UNDER A/C	1,202 \$
PROPOSED 2 CAR GARAGE	552 9
PROPOSED FRONT COVERED PORCH	148 9
PROPOSED FIRST FLOOR UNDER ROOF	1,902 9
PROPOSED SECOND FLOOR UNDER A/C	1,242 6
PROPOSED FRONT COVERED PORCH	148 9
PROPOSED TRELLIS / TERRACE PORCH	402 9
PROPOSED SECOND FLOOR UNDER ROOF	1,390 \$
TOTAL FLOOR UNDER A/C	2,444 \$
TOTAL FLOOR UNDER ROOF	3,292 \$



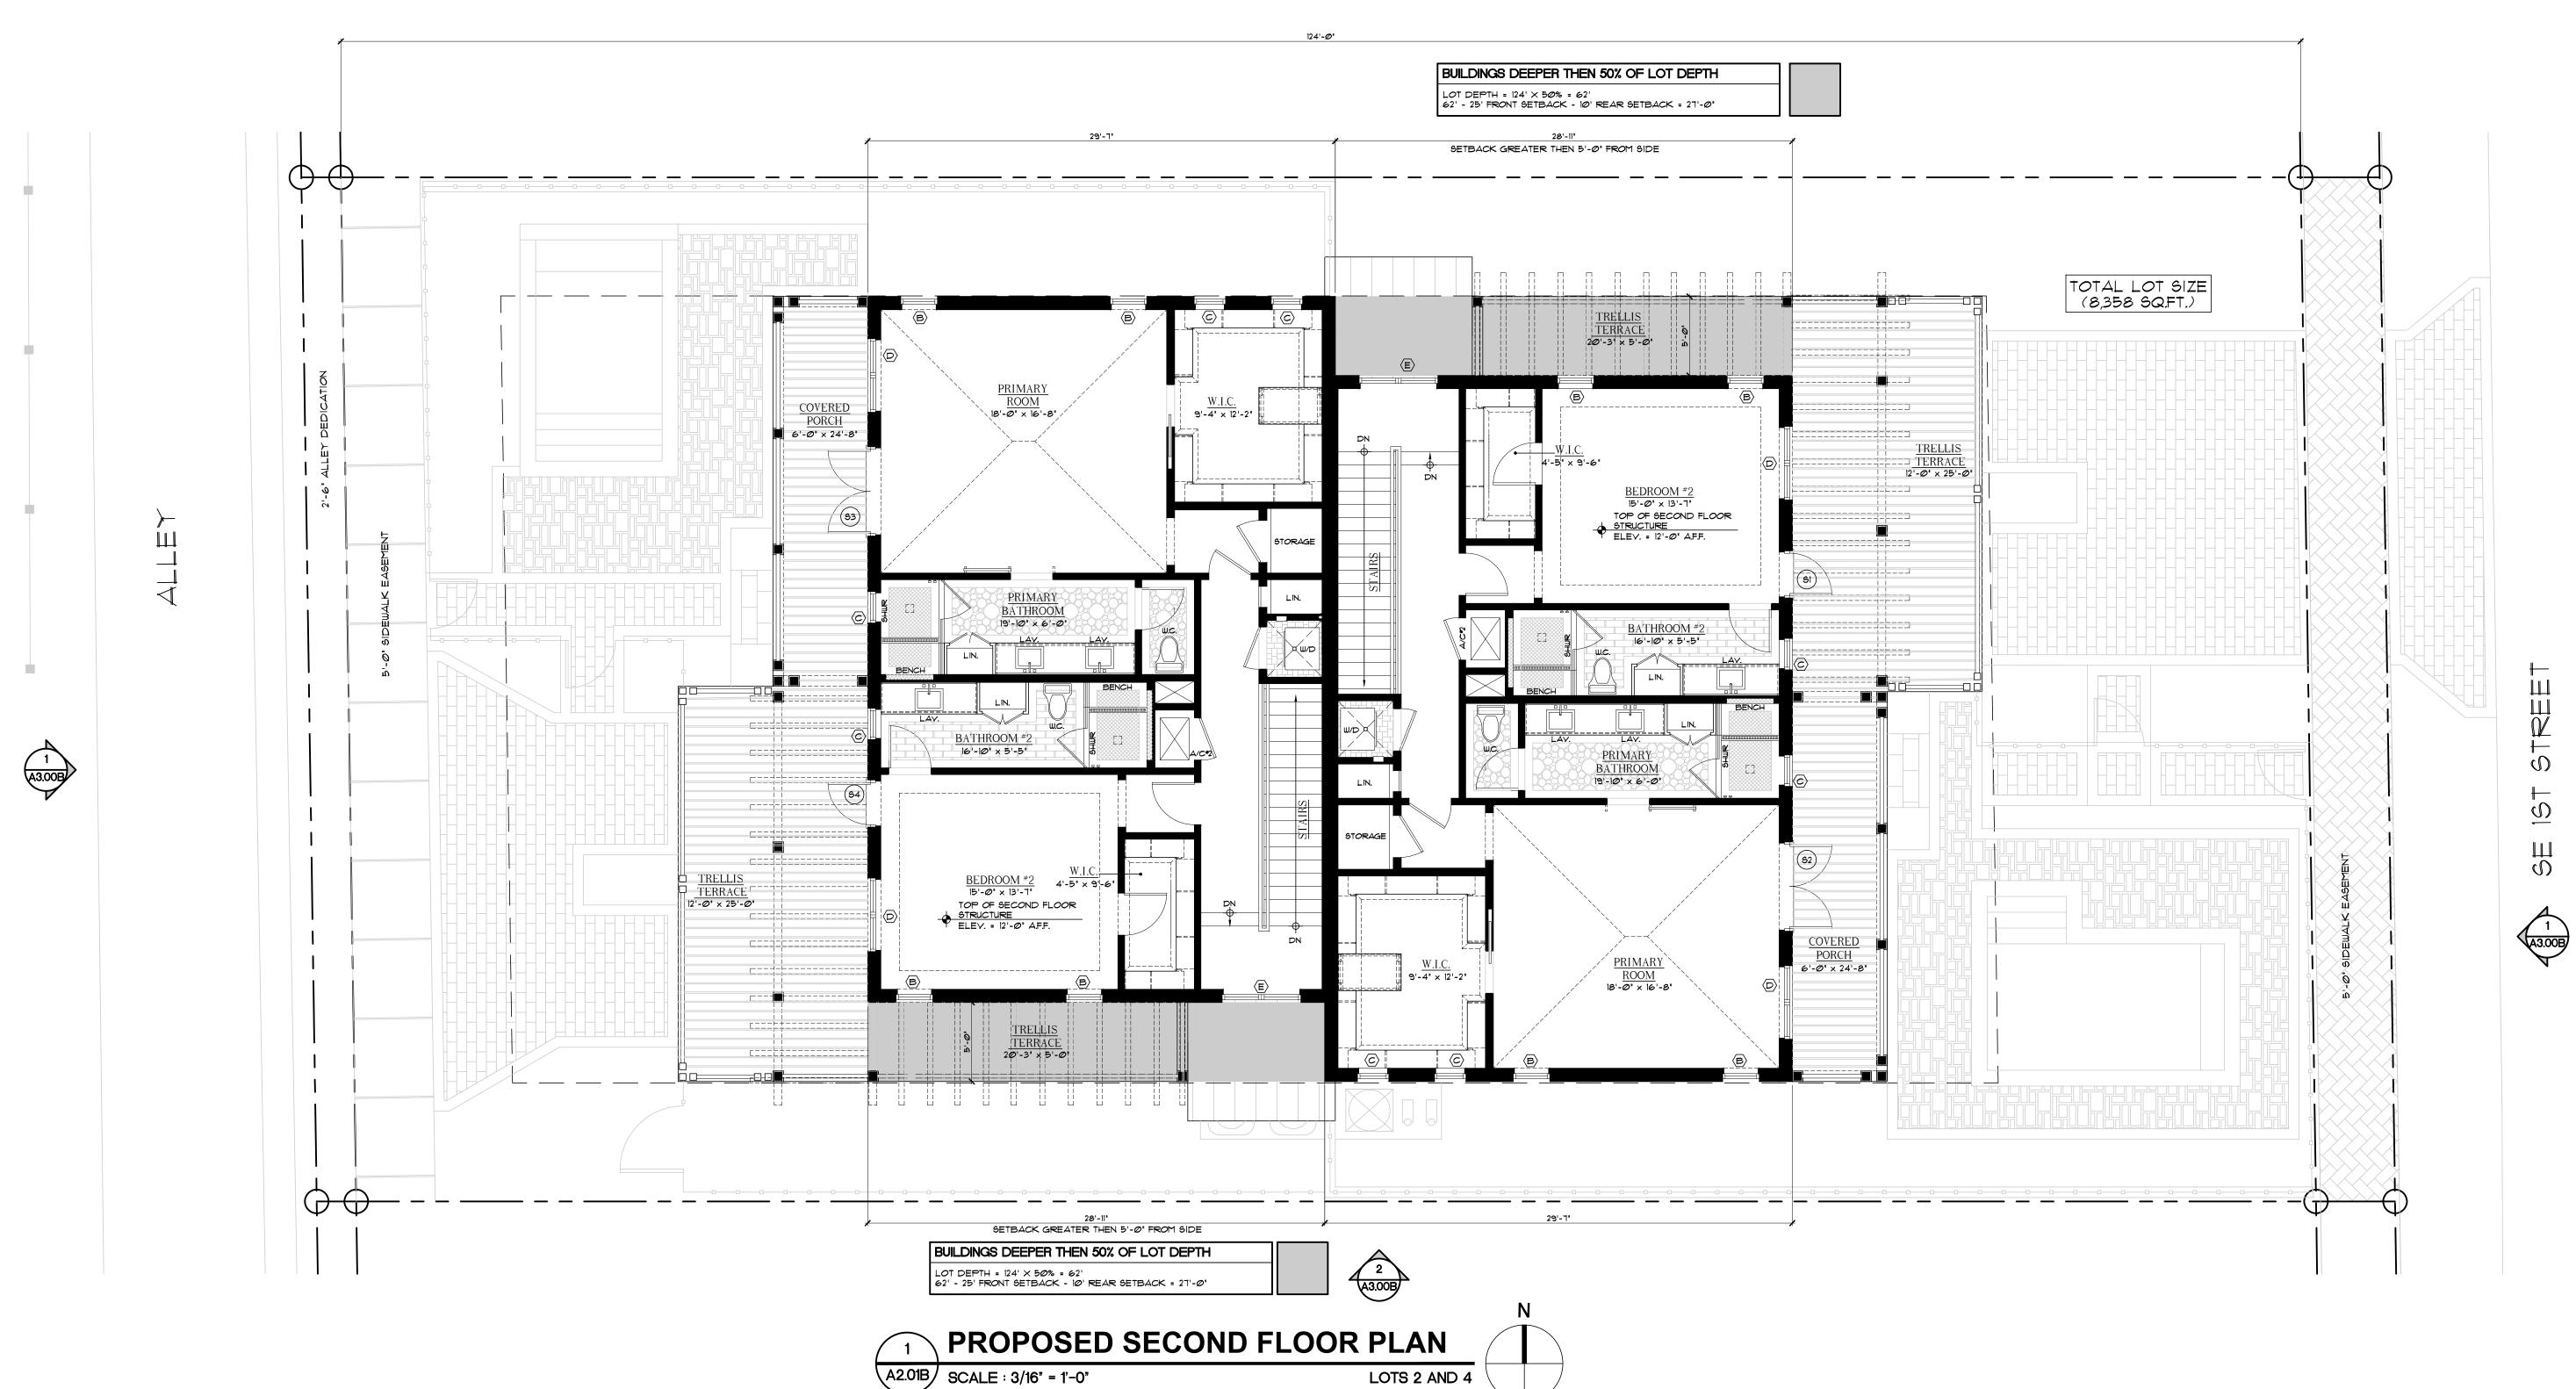

NOTES:

- DO NOT SCALE DRAWINGS!
 FIELD VERIFY ALL DIMENSIONS!
- 3. CONTRACTOR TO VERIFY ALL EXISTING CONDITIONS, AND NOTIFY ARCHITECT IF ANY DESCRIPANCY W/ DRAWINGS. (SEE GENERAL NOTES)
- 4. ALL AREA CALCULATIONS ARE APPROX.

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CONSTRUCTION

PROJECT TITLE

RESIDENTIAL

DUPLEX LOTS 2 AND 4

130 SE 1ST AVENUE DELRAY BEACH, FL

REVISIONS

FILE NUMBER 109A201B

PROPOSED

SECOND

L

FLOOR PLAN

DATE
2.15.23 DRAWN BY
GE/MJ

LOTS 2 AND 4

JOB NUMBER **20230109**

DRAWING NUMBER

A2.01B



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CONSTRUCTION

PROJECT TITLE

RESIDENTIAL DUPLEX LOTS 2 AND 4

130 SE 1ST AVENUE **DELRAY BEACH, FL**

REVISIONS

FILE NUMBER 109A201B

DRAWING TITLE


PROPOSED ROOF PLAN LOTS 2 AND 4

DRAWN BY 2.15.23 JOB NUMBER

GE/MJ 20230109

DRAWING NUMBER

AREA CALCULATIONS - FOR UNITS A AND B	
PROPOSED FIRST FLOOR UNDER A/C	1,192 S/F
PROPOSED 2 CAR GARAGE	562 S/F
PROPOSED FRONT COVERED PORCH	148 S/F
PROPOSED FIRST FLOOR UNDER ROOF	1,902 S/F
PROPOSED SECOND FLOOR UNDER A/C	1,242 S/F
PROPOSED FRONT COVERED PORCH	148 S/F
PROPOSED SECOND FLOOR UNDER ROOF	1,390 S/F
TOTAL FLOOR UNDER A/C	2,434 S/F
TOTAL FLOOR UNDER ROOF	3,292 S/F

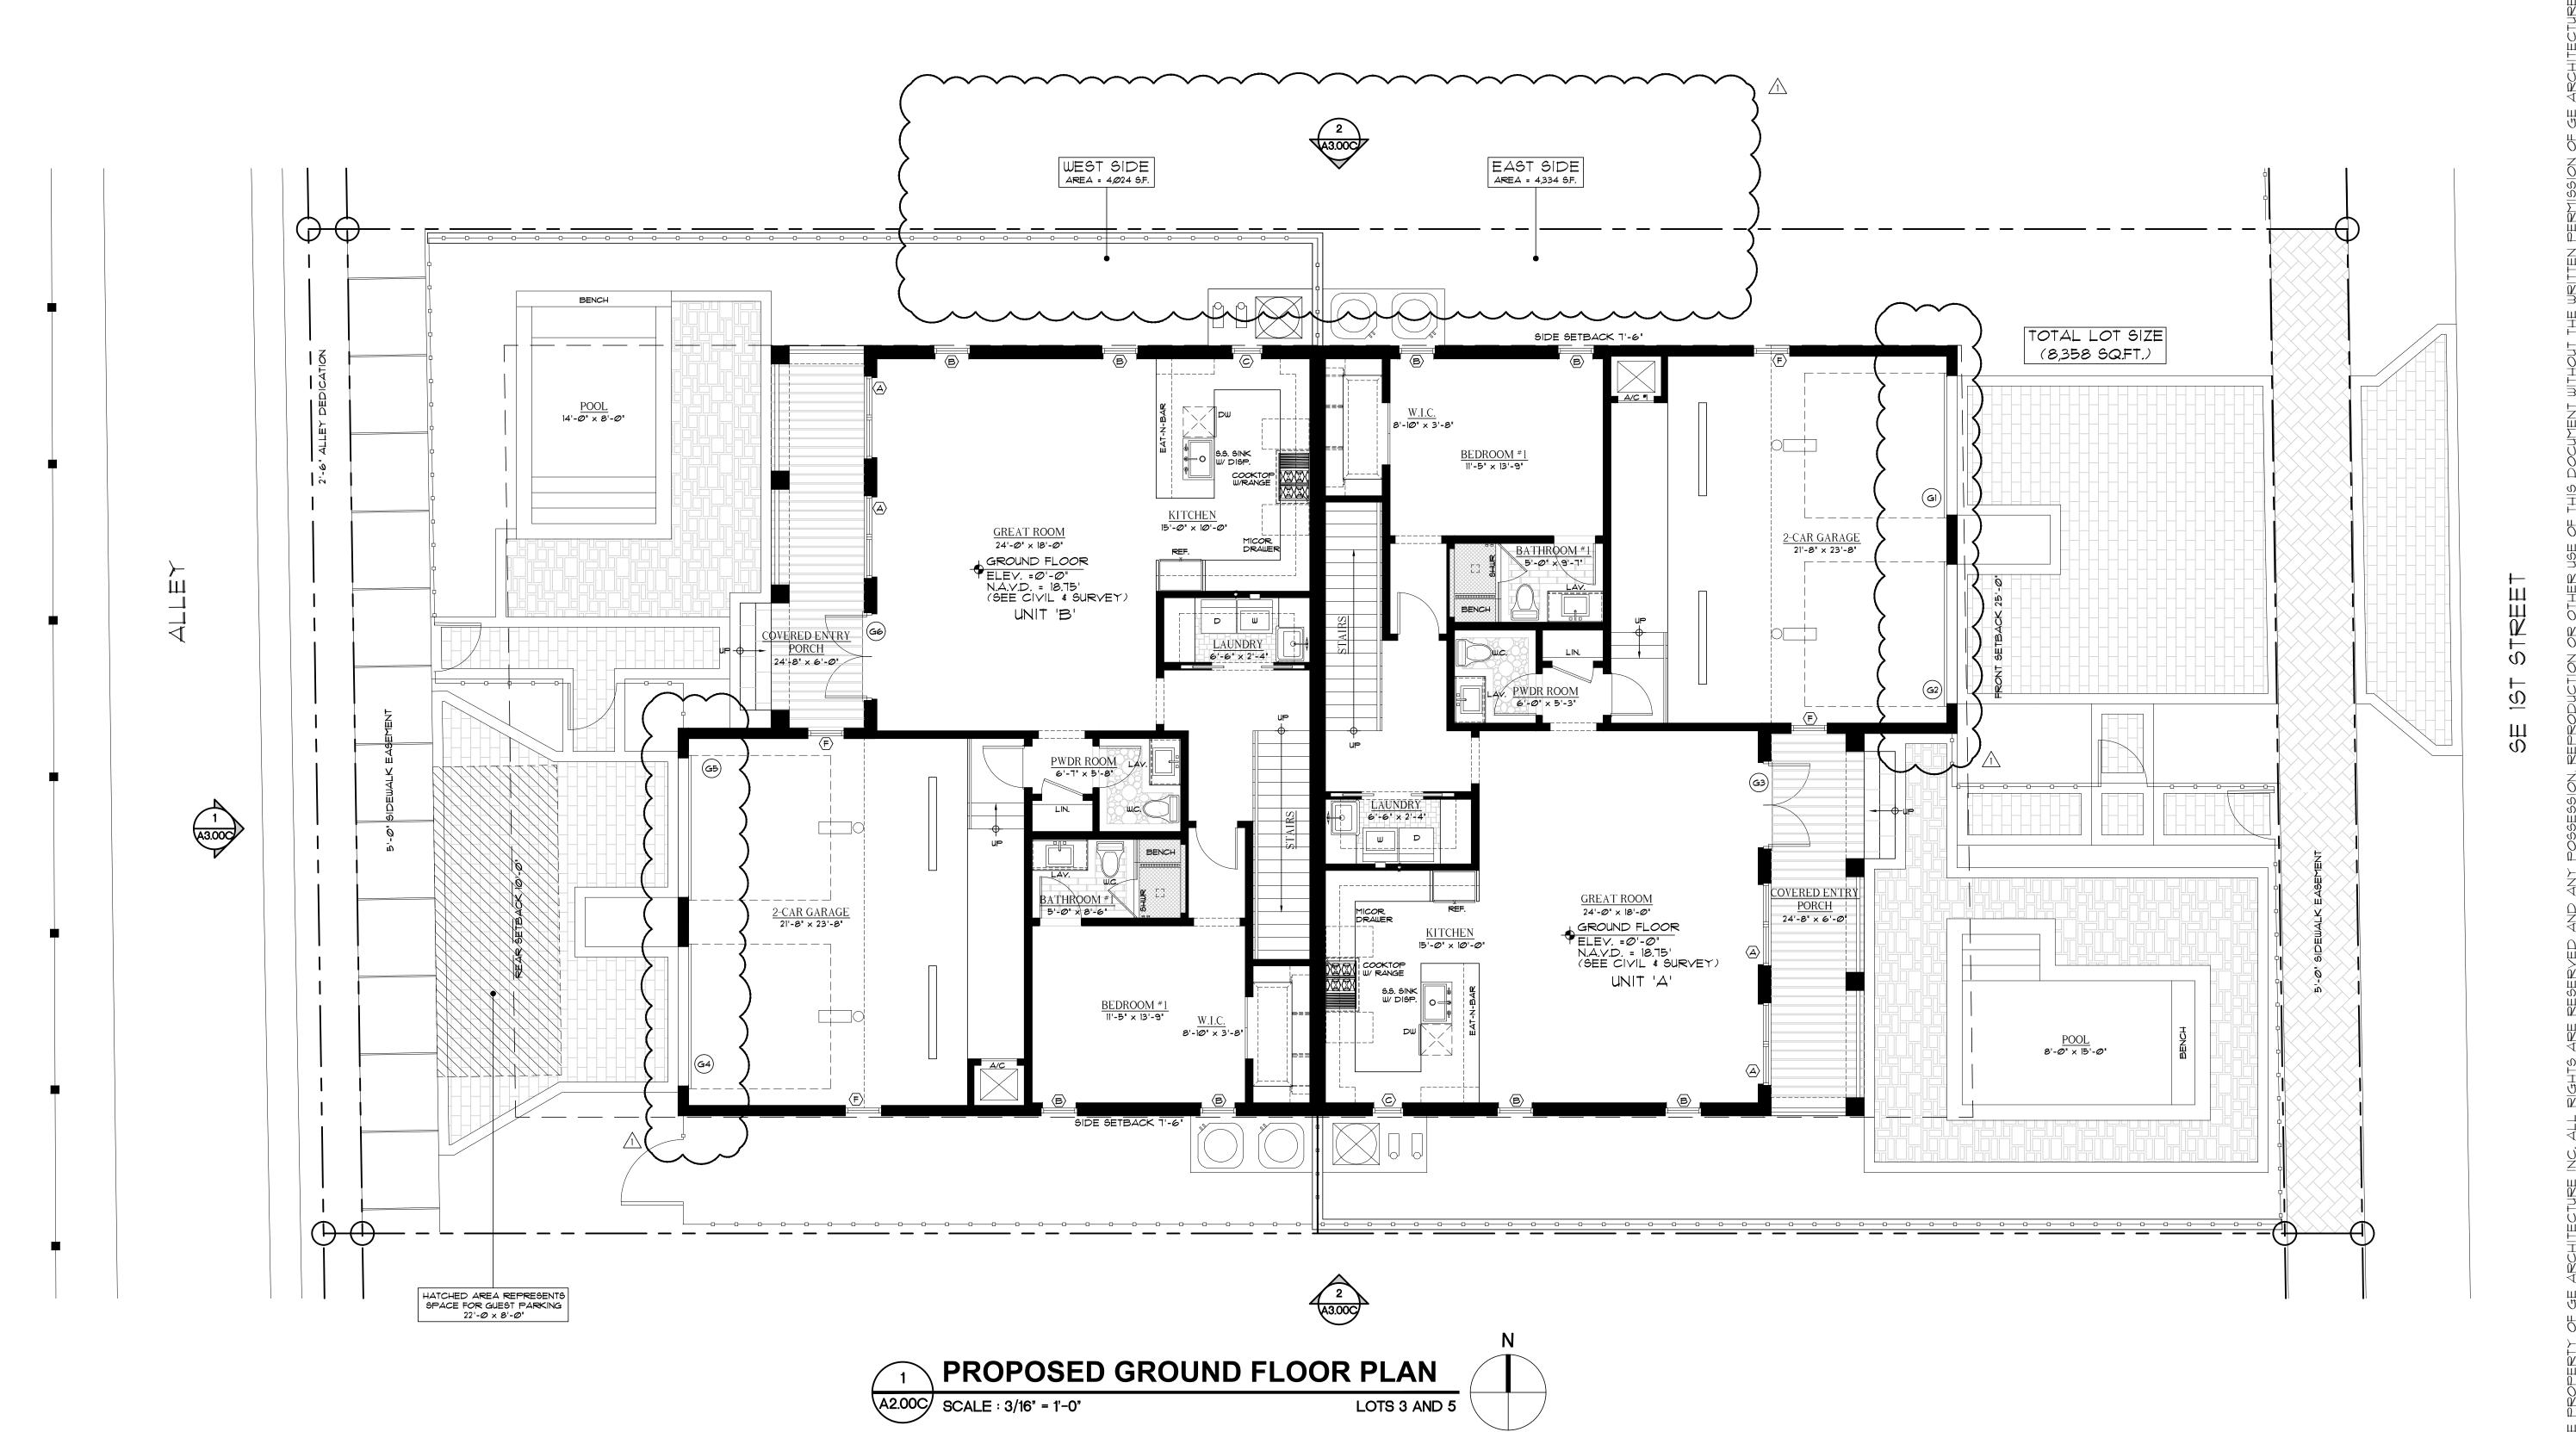

NOTES:

 DO NOT SCALE DRAWINGS!
 FIELD VERIFY ALL DIMENSIONS!
 CONTRACTOR TO VERIFY ALL EXISTING CONDITIONS, AND NOTIFY ARCHITECT IF ANY DESCRIPANCY W/ DRAWINGS. (SEE GENERAL NOTES)

(SEE GENERAL NOTES)

4. ALL AREA CALCULATIONS ARE APPROX.

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RESIDENTIAL DUPLEX

LOTS 3 AND 5

130 SE 1ST AVENUE DELRAY BEACH, FL

REVISIONS

REVISED 5/22/23 AS PER H.P.B.

COMMENTS:

I. DUPLEX PLANS HAVE BEEN

MODIFIED IN ORDER TO MEET 4,000

SF DUPLEX LOT REQUIREMENT.

FILE NUMBER 109A200C

PROPOSED
GROUND

FLOOR PLAN
LOTS 3 AND 5
DATE | DRAWN BY

2.15.23 GE/MJ


JOB NUMBER

20230109

DRAWING NUMBER

A2.00C

AREA CALCULATIONS (PER UNIT)	
<u> </u>	Hon
PROPOSED FIRST FLOOR UNDER A/C	1,192
PROPOSED 2 CAR GARAGE	56
PROPOSED FRONT COVERED PORCH	148
PROPOSED FIRST FLOOR UNDER ROOF	1,90
PROPOSED SECOND FLOOR UNDER A/C	1,24
PROPOSED FRONT COVERED PORCH	148
PROPOSED SECOND FLOOR UNDER ROOF	1,390
TOTAL FLOOR UNDER A/C	2,434
TOTAL FLOOR UNDER ROOF	3,29

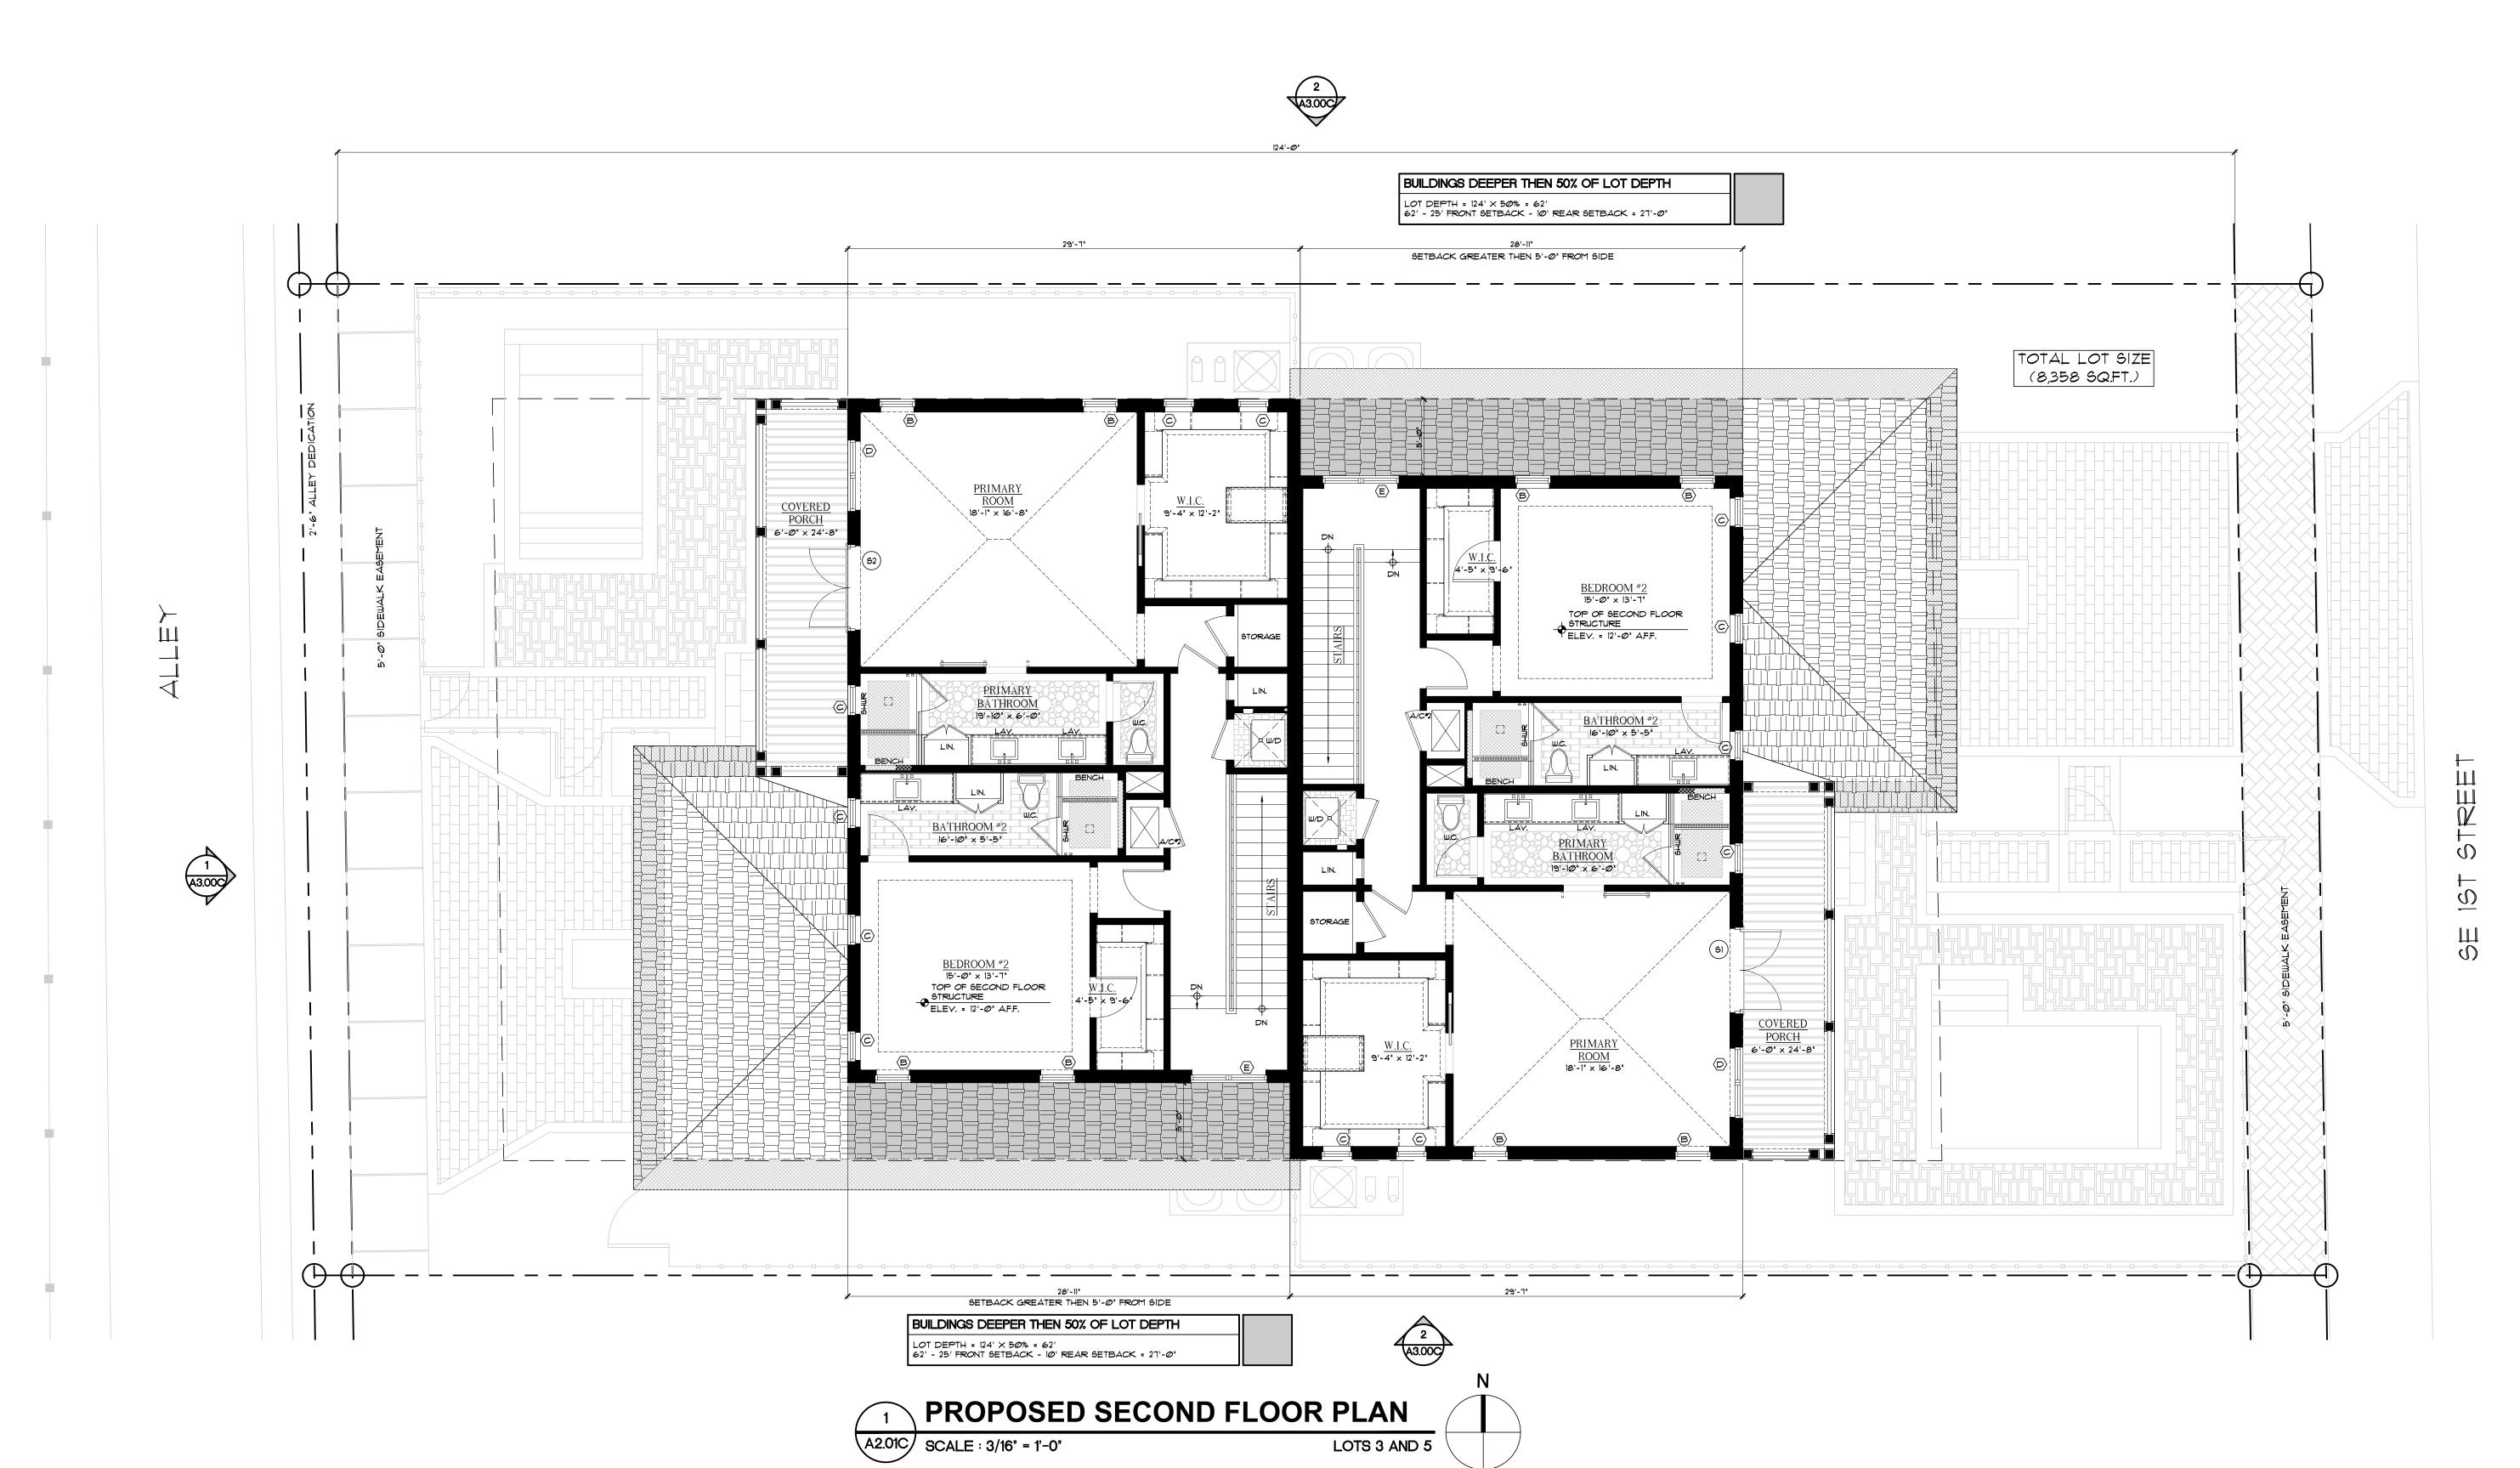

- 1. DO NOT SCALE DRAWINGS! 2. FIELD VERIFY ALL DIMENSIONS!
- 3. CONTRACTOR TO VERIFY ALL EXISTING CONDITIONS, AND NOTIFY ARCHITECT IF ANY DESCRIPANCY W/ DRAWINGS. (SEE GENERAL NOTES)
- 4. ALL AREA CALCULATIONS ARE APPROX.



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CONSTRUCTION

PROJECT TITLE RESIDENTIAL DUPLEX LOTS 3 AND 5

130 SE 1ST AVENUE DELRAY BEACH, FL

REVISIONS

FILE NUMBER 109A201C

DRAWING TITLE PROPOSED SECOND **FLOOR PLAN**


2.15.23 GE/MJ

LOTS 3 AND 5

JOB NUMBER 20230109

DRAWING NUMBER

A2.01C

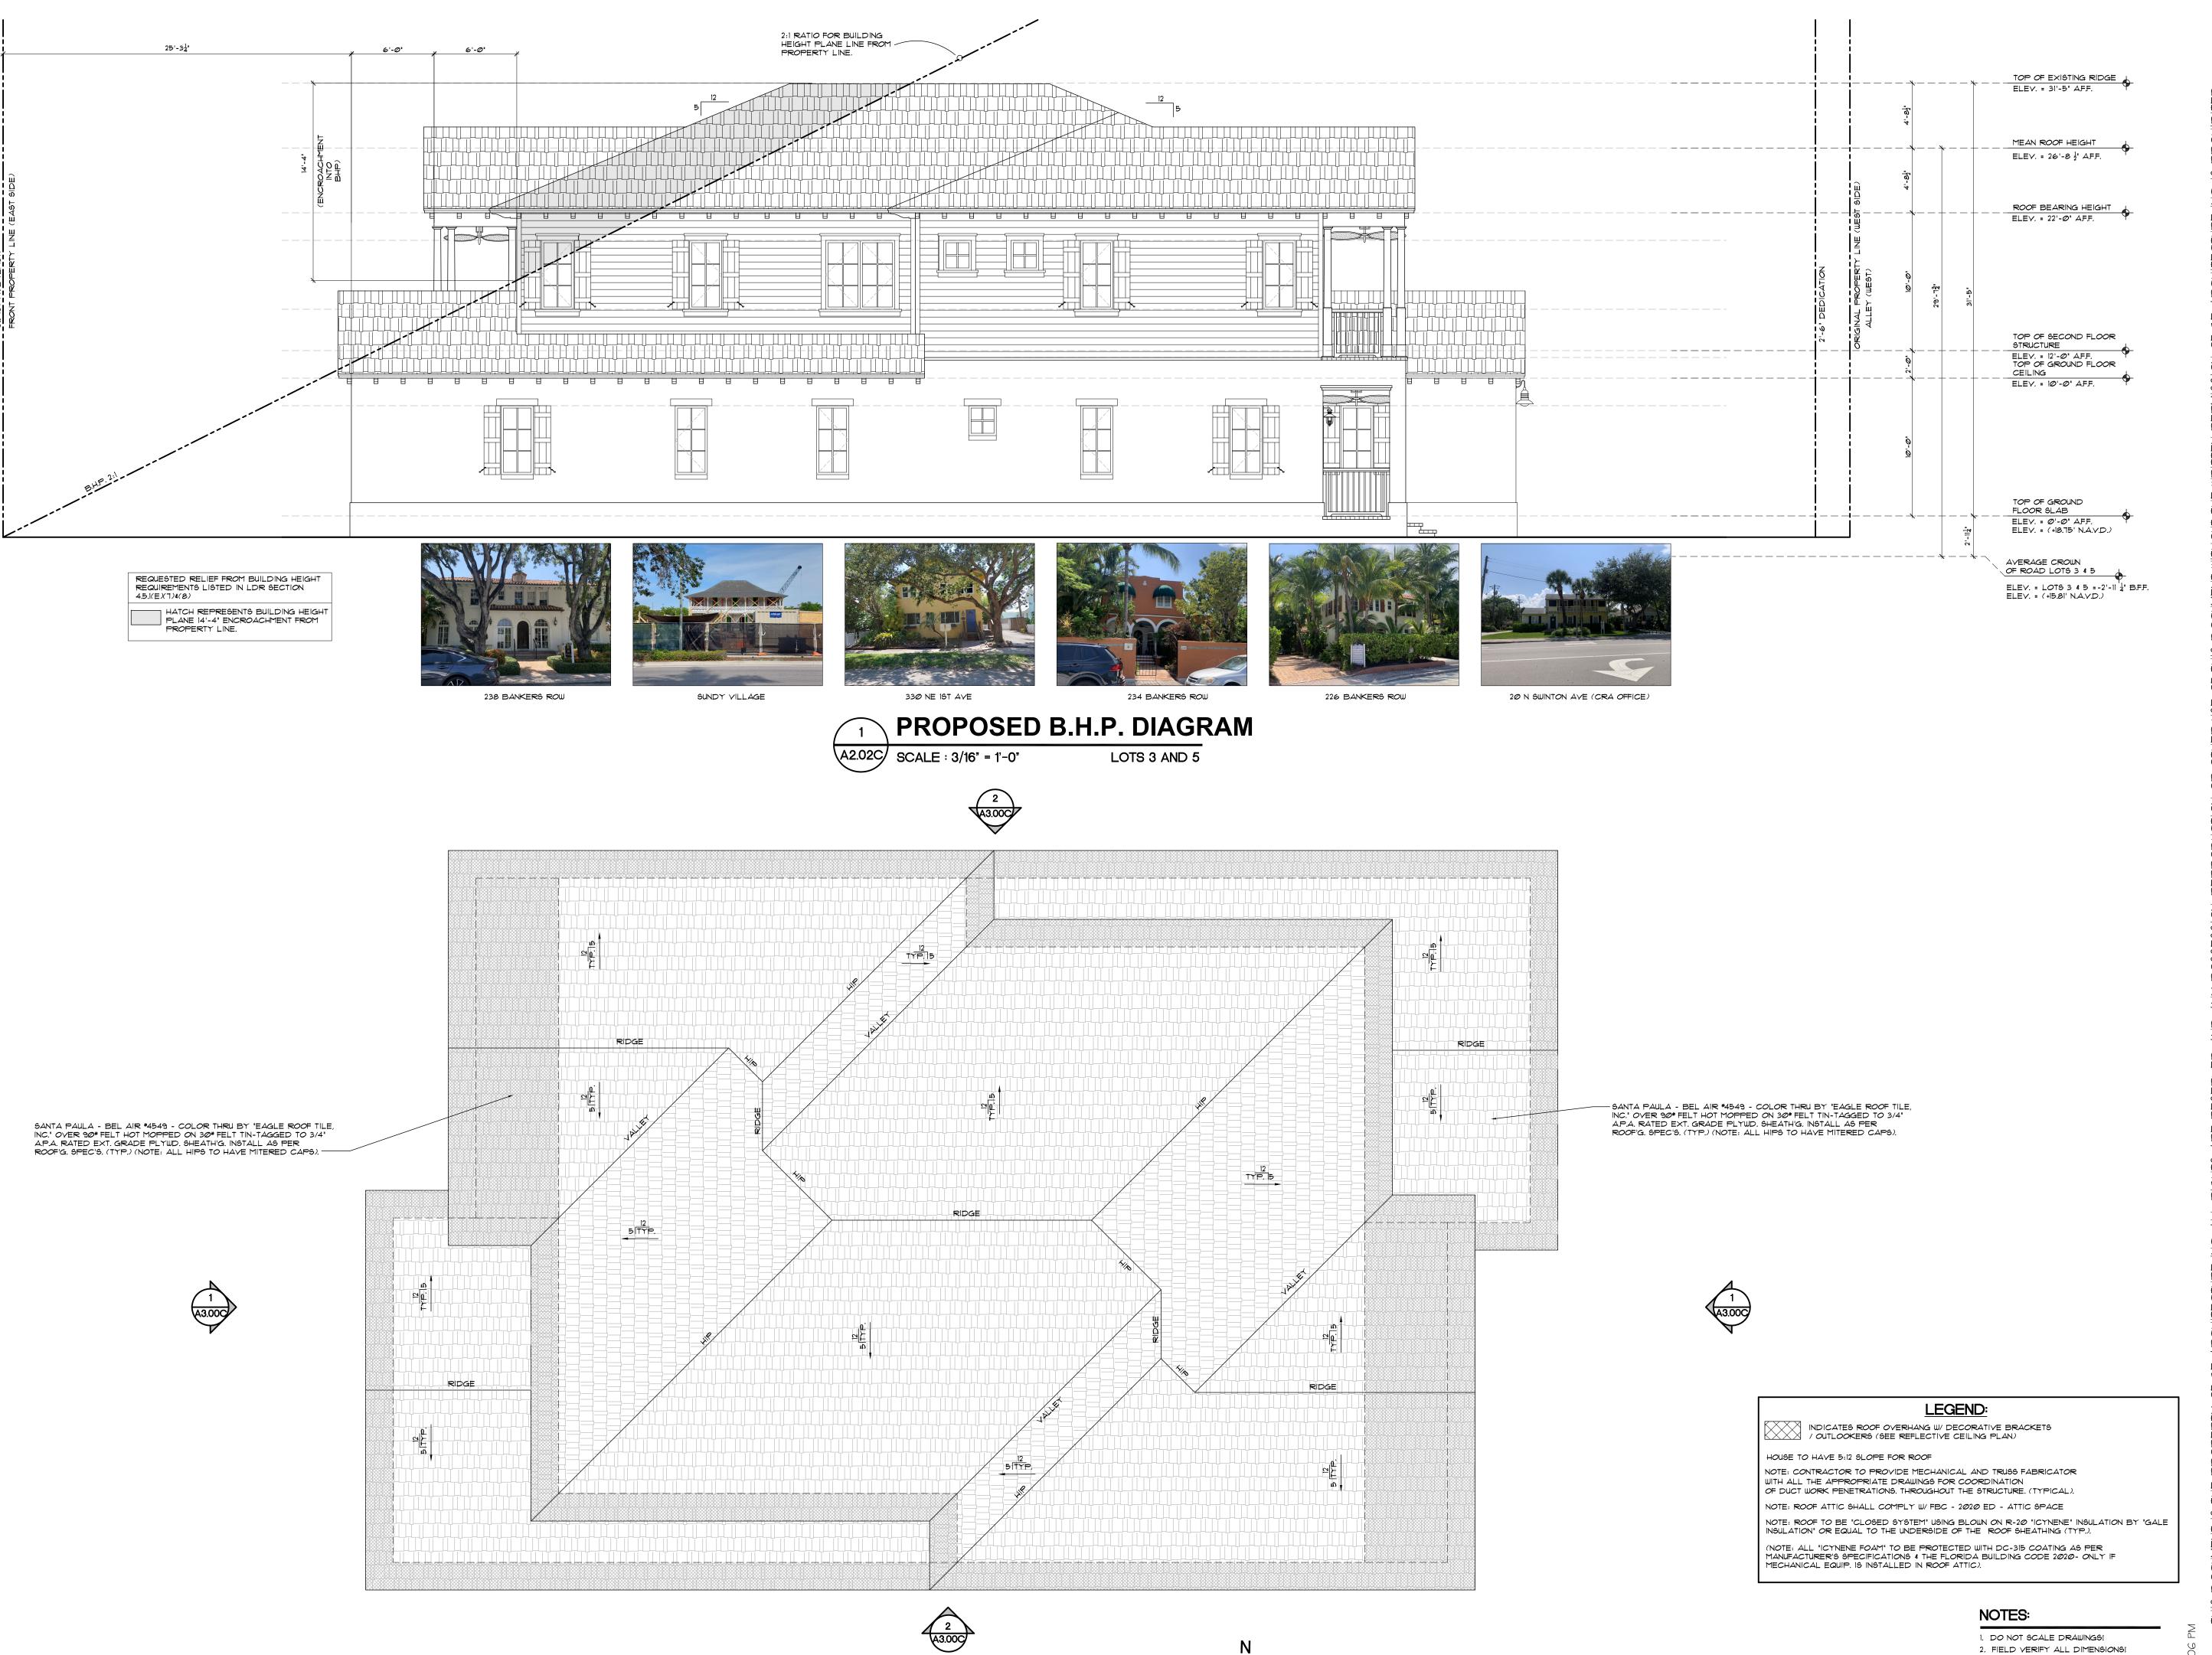

PROPOSED ROOF PLAN

LOTS 3 AND 5

A2.02C/ SCALE : 3/16" = 1'-0"

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PROJECT TITLE

RESIDENTIAL **DUPLEX** LOTS 3 AND 5

130 SE 1ST AVENUE DELRAY BEACH, FL

REVISIONS

FILE NUMBER 109A202C

DRAWING TITLE

PROPOSED ROOF PLAN LOTS 3 AND 5


DRAWN BY 2.15.23


CONTRACTOR TO VERIFY ALL EXISTING CONDITIONS, AND NOTIFY ARCHITECT IF ANY DESCRIPANCY W/ DRAWINGS. (SEE GENERAL NOTES)

4. ALL AREA CALCULATIONS ARE APPROX.

GE/MJ JOB NUMBER 20230109

DRAWING NUMBER

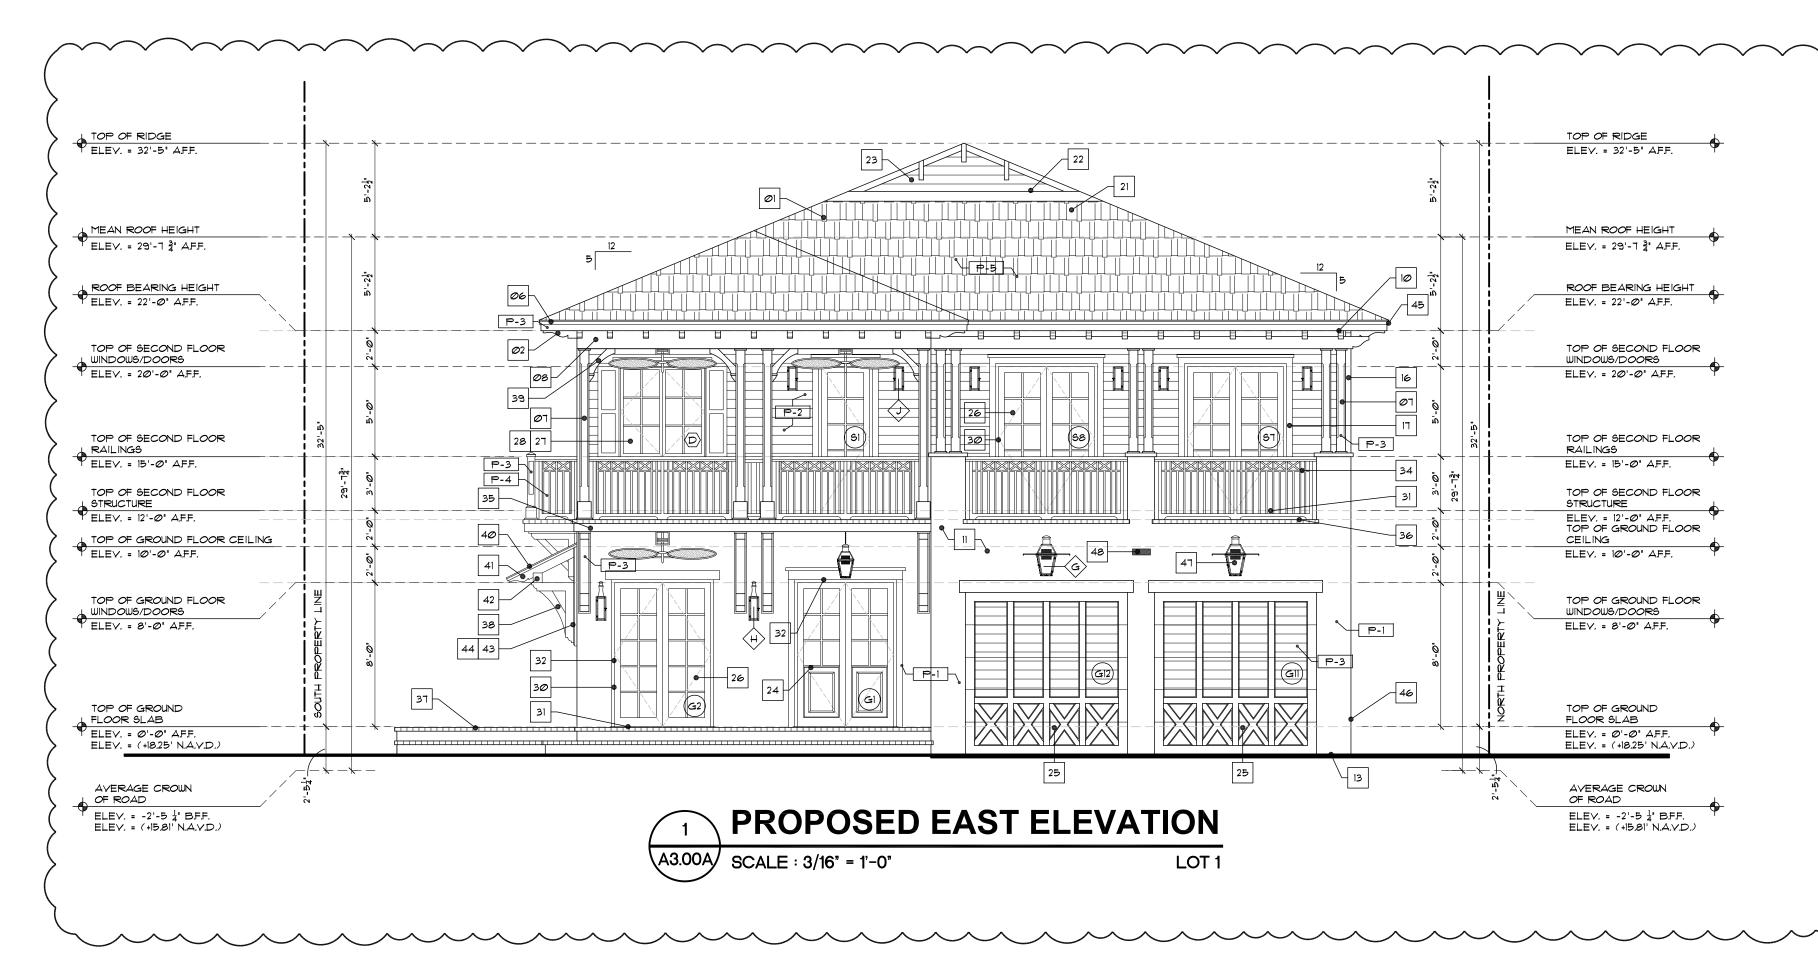

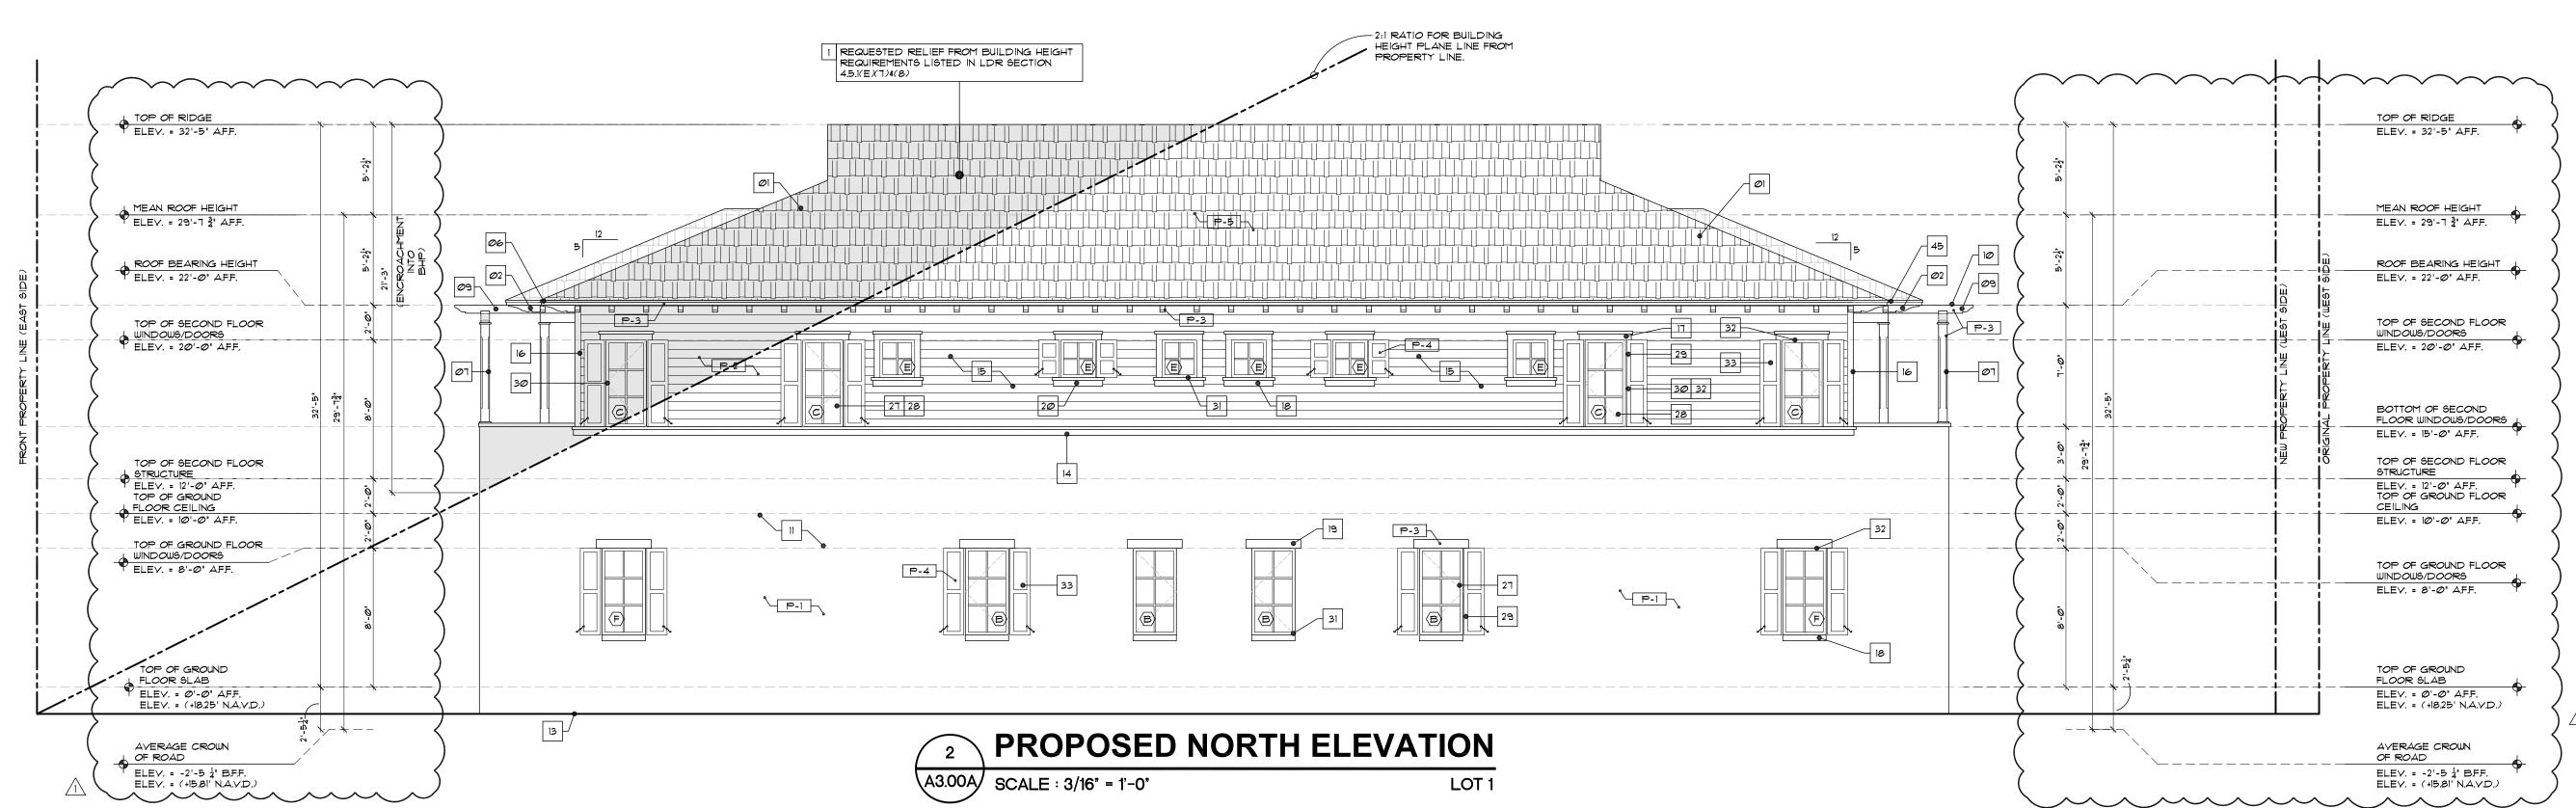

ELEVATION NOTES LOT 1

- SIERRA MADRE BEL AIR *4503 COLOR THRU BY "EAGLE ROOF TILE, INC." OVER 90# FELT HOT MOPPED ON 30# FELT TIN-TAGGED TO 3/4" A.P.A. RATED EXT. GRADE PLYWD. SHEATH'G. INSTALL AS PER ROOF'G. SPEC'S. (TYP.) (NOTE: ALL HIPS TO HAVE MITERED CAPS).
- 30" x 3" x 6" DECORATIVE OUTRIGGERS (NOTE: KING OUTRIGGERS 42") W/ 'CELLOFOAM' HIGH DENSITY FOAM SHAPED COATED W/ POLYURETHANE RESIN *UTC-5067 URETHANE ELASTROMER COATING OR EQUAL. -PAINTED. - CONTRACTOR TO ATTACHED DECORATIVE BRACKET W/ "DOW ENERFOAM" FOAM SEALANT. - (UNDERSIDE OF SOFFIT TO BE 3" 3-COATS SMOOTH STUCCO FINISH W/ 1" x 6" T&G PATTERN - PAINTED -SEE REFLECTED CEILING PLAN FOR LAYOUT).
- SEE ROOF PLAN FOR BUILT-UP CRICKET FOR POSITIVE DRAINAGE -(NOTE ALL CRICKETS TO HAVE MIN. 2 LAYERS SMOOTH MODIFIED PLUS A CLASS "A" MODIFIED CAP SHEET - TYP.).
- BLOCK WALLS ALONG 2ND FLOOR & ROOF CRICKETS TO BE 04. PROTECTED W/ 'SIKA ROOFPRO' BY SIKA OR EQUAL - INSTALLED AS PER MANUF SPEC'S.
- PROVIDE KICK OUT FLASHING TO DIVERT ROOF WATER FLOW AWAY 05. PROVIDE K FROM WALL
- CONT. ALUM. DRIP EDGE ON CONT. P.T. 1 \times 2 ON CONT. 2 \times 4 SMOOTH CLEAR CEDAR FASCIA -PAINTED - TYP. AT
- 01. AND 1" 'A7FK" TRIM OR EQ. 4FF 6TD OF TO THE STORY AND 1" "AZEK" TRIM OR EQ. - SEE STRUCT, DRAWINGS FOR HIDDEN CONNECTIONS. CONTRACTOR TO SUBMIT SHOP DRAWINGS FOR APPROVAL.

- 6 x 12 \$4\$ \$MOOTH CLEAR CEDAR BEAM PAINTED (TYP. @ SECOND FLOOR COVERED PORCH CONDITIONS). -SEE REFLECTED CEILING PLAN & SECTION. - ALL CONNECTION TO BE HIDDEN -VERIFY W/ STRUCTURAL DWGS.
- 6 x 10 545 CEDAR TRELLIS JOIST \$ 6 x 12 545 TRELLIS BEAMS W/ SHAPED DECORATIVE TAIL (PAINTED) - SEE STRUCT. DWG'S. FOR ALL HIDDEN CONNECTIONS (TYP. W/ CONT. COPPER FLASHING @ TOP OF ALL TRELLIS MEMBERS).
- 2 x 2 \$4\$ CLEAR CEDAR SLEEPERS @ 12' O.C. PAINTED WHITE (TYP. AT ALL TRELLIS LOCATIONA)
- 11. 2-COAT 5/8" SMOOTH STUCCO FINISH, PAINTED TYP.
- CONT. 14" RAISED SMOOTH STUCCO BASE, "WATER-TABLE" - TYP. AT PERIMETER OF ENTIRE HOUSE
- EXTERIOR STUCCO TO EXTEND A MIN. 1'-0" BELOW GRADE (TYP. @ ENTIRE PERIMETER).
- 2" HT. W/ 1 1/2" PROJECTION SMOOTH STUCCO BANDING-
- TYP. AT BOTT. OF STUCCO "LAPSIDING". 7/8" 3-COAT SMOOTH STUCCO W/ 6" LAP SIDING- FINISH-15. PAINTED (NOTE: SCRATCH COAT APPLIED DIRECTLY TO BLOCK PRIOR TO LAP SIDING PVC TRIM) - PVC TO BE AN
- INTEGRAL COMPONENT TO THE STUCCO SIDING-(TYP.). 2" x 4" SMOOTH STUCCO- PAINTED (TYP. @ ALL CORNERS AND WINDOW SURROUNDS AT STUCCO LAPSIDING).

- 1"TH x 4"W SMOOTH RAISED STUCCO WINDOW / DOOR SURROUND W/ 1" x 1 1/2" TH. RAISED STUCCO BANDING AT HEADER - PAINTED (TYP. AT SECOND FLOOR LAPSIDING). 1" TH. x 4"HT. RAISED SMOOTH STUCCO WINDOW SILL BANDING - PAINTED (TYP.).
- EXTENSION BEYOND WINDOW JAMB, PAINTED (TYP.). (2) LAYER STEP SILL BANDING 2" HT. W/ 1 1/2" PROJECTION SMOOTH STUCCO BANDING- (LOWER BAND 4" HT. W/ 3/4" PROJECTION @ STUCCO) - PAINTED (TYP. @ WINDOWS /
- LAPSIDING) SLOPED FOR POSITIVE DRAINAGE. 2" x 6" SMOOTH CLEAR CEDAR FACIA BOARD - PAINTED -TYP. AT ALL BOSTON HIP ROOFS (PROVIDE ALT. PRICE FOR

1"TH. \times 6"HT. SMOOTH RAISED STUCCO WINDOW HEADER W/ 4"

21. TYP. AT ALL BOSTON 22. (3) 3 × 12 RIDGE RAFTER TAIL- TYP. AT "BOSTON HIP" ROOF.

"COASTAL SUPPLY" OR EQ. PROVIDE CERTIFICATE OF

ALL "BOSTON HIP" END ROOF CONDITIONS TO RECEIVE 23. ADDITIONAL ANGLED TRUSS BRACING TO MEET WIND → CYCLING REQUIREMENTS. -SEE STRUCTURAL DWGS. FRONT DOOR TO BE "SIGNATURE DOOR INC." STAINED MAHOGANY" (VERIFY W/ BUILDER ON STAIN) - INSTALLED BY

COMPLIANCE W/ WIND & IMPACT REQ'MNTS.

- ALL OVERHEAD INSULATED GARAGE DOORS ARE TO MEET DADE COUNTY WIND CYCLING AND IMPACT TESTING REQUIREMENTS. PROVIDE CERTIFICATE OF COMPLIANCE (TYPICAL). GARAGE DOOR BY "EDL" OR EQUAL - OFFSE" DOORS FOR DECORATIVE "BORAL" APPLIED PANELS OR EQUAL (TO BE SELECTED BY BUILDER - SEE EXTERIOR ELEVATIONS). ELEVATIONS). "PGT" 150 SERIES ALUM. FRENCH DOORS (COLOR WHITE) W/GRAY TINT - GLASS TO BE IMPACT RESISTANT AND
- COMPLY W/ ALL DADE COUNTY IMPACT AND WIND CYCLING TESTING REQUIREMENTS. CONTRACTOR TO PROVIDE CERTIFICATE OF COMPLIANCE (TYP.). - SEE DOOR SCHEDULE "PGT" CASEMENT & FIXED (SEE MEANS OF EGRESS) ALUM. WINDOWS W/ GRAY TINT - GLASS (ALUM. FRAME COLOR -WHITE) TO BE IMPACT RESISTANT AND COMPLY WALL DADE, COUNTY IMPACT AND WIND CYCLING TESTING REQUIREMENTS CONTRACTOR TO PROVIDE CERTIFICATE OF COMPLIANCE
- (TYP.). SEE WINDOW SCHEDULE FOR ALL TRANSOM WINDOW/ EGRESS TYPE WINDOW SHALL BE OPERABLE FROM THE INSIDE WITHOUT THE USE OF TOOLS AND PROVIDE A CLEAR OPENING OF NOT LESS THAN 20" W./ 24"HT. AND 5.1 90. FT., AREA THE BOTTOM OF THE OPENING SHALL BE NOT MORE THAN 44" FROM THE FINISH FLOOR LEVEL NOR SHALL ANY PART OF THE OPERATING MECHANISM BE

ALL WINDOWS TO HAVE IX P.T. WD BUCKS ANCHORED

TO CONC AS PER PRODUCT APPROVAL.

- BY SIKA AND OR MANUF. PLACED HIGHER THAN 54" FROM THE FIN. FLOOR.
- ALL EXTERIOR DOORS & WINDOWS TO HAVE "SIKAFLEX #150" OR EQUAL CAULKING @ BUCK/CMU/ALUM. FRAME CONDITIONS (TYP) ALL ALUM. EXT. DOOR THRESHOLDS & WINDOW SILLS TO BE 37. SET IN "SIKAFLEX PRO" OR EQUAL & CONC. THRESHOLD/ ALL DOOR & WINDOW CORNERS, HDR'S. & JAMBS TO BE WRAPPED W/ "SIKA TOP SEAL 107" OR EQ. THEN - APPLY
 - "SIKAFLEX 102 EVERFLASH MEMBRANE" OR EQ. OVER ALL WOOD BUCKS W/ A MIN. 8" AT THE INTERIOR SIDE OF ALL OPENINGS AND 12" ON THE FACE OF ALL THE OPENINGS INSTALLED AS PER MANUF, SPEC'S BY "SIKA" OR EQ. -NOTE: CONTRACTOR TO REQUEST "ADHESION TEST"
 - DECOR. ALUMINUM WINDOW SHUTTERS W/ ALL CONCEALED CONNECTION AND 2 × SPACERS @ REAR FOR PROTECTION FROM BUILD'G W/ E.S.P PAINTED - (BM) "KENDAL CHARCOAL - HC-166 FOR SHUTTERS AND "BLACK SHUTTER DOGS" OR EQUAL (COLORS TO BE APPROVED BY BUILDER). ALUMINUM DECORATIVE 'X' RAIL W/ E.S.P. POWDER COAT FINISH (COLOR (BM) KENDAL CHARCOAL - HC-166)- TOP OF RAIL MIN. 42" WITH PLEX- GLASS INSERTS TO BLOCK PASSAGE OF 4" SPHERE. (BOTTOM RAIL MAX. 2" A.F.F. -TYP.) PROVIDE SHOP DRAWINGS/ SAMPLE. BY "JC ORNAMENTAL IRON WORK" OR EQUAL. PROVIDE SHOP DRAWINGS FOR STYLE, SIZES AND DESIGN SAFETY / SAMPLE, (NOTE: ALL EXTERIOR RAILINGS SHALL COMPLY W/ F.B.C. 2020 EDITION). POURED IN PLACE CONC SLAB. SEE STRUC DWGS (TYP.) ALL 43.

COVERED PORCHES TO SLOPE 1/8"/FT.

- CONT 1 1/4"HT. x 4" COPPER DRIP EDGE @ ALL BALCONIES. . PORCHES TO RECEIVE "STONE PAVERS" MUDSET BY "ARTISTIC PAVERS" OR EQUAL. NON-SLIP W/ SQUARE EDGE AT THE OUTER EDGE, DECK TO BE MUDSET OVER 125" LIQUID WATERPROOFING ON CONC. DECK. "SIKALASTIC 710/715" OR EQ (REQ. SAMPLE FOR OWNER / INTERIOR DESIGNER APPROVAL). CONTRACTOR TO USE A POLYMER MODIFIED, NON EFFLORESCENCE MUDSET OR THINSET GROUT.
- 4 x 10 K.D.A.T. P.T. PINE DECORATIVE BRACKET & BASE W/ ALL COUNTERSUNK & FILLED ANCHORS - PAINTED (BM) BRILLIANT WHITE (TYP. AT FRONT COVERED ENTRANCE).
- 3 x 4 SMOOTH CLEAR CEDAR DECORATIVE BRACKETS W/ DECORATIVE CORBELS - PAINTED (BM) BRILLIANT WHITE (TYP. AT SECOND FLOOR COVERED PORCH). SIERRA MADRE - BEL AIR *4503 - COLOR THRU ROOFING SYSTEM BY "EAGLE ROOF TILE, INC. ON "ICE & WATER SHIELD"
- OVER 30* FELT, T.T. TO 2×6 P.T. T&G WOOD DECKING (TYP. AT LOWER LEVEL SHED ROOF). $3 \times 6 \times 4'$ -6" LONG P.T. \$45 WOOD ROOF JOIST - PAINTED (TYP. AT LOWER LEVEL SHED ROOF). $4 \, 1/4 \times 4 \, 1/4$ K.D.A.T. P.T. WOOD BEAM - PAINTED (TYP. AT LOWER LEVEL SHED ROOF).
- 4 x 10 K.D.A.T. P.T. PINE DECORATIVE BRACKET & BASE W/ ALL COUNTERSUNK & FILLED ANCHORS - PAINTED (BM) BRILLIANT WHITE (TYP. AT LOWER LEVEL SHED ROOF).

- 2×6 K.D.A.T. P.T. BACK PLATE PAINTED (BM) BRILLIANT WHITE
- (TYP. AT EACH BRACKET) CONTRACTOR TO PROVIDE PRICE FOR ENTIRE STRUCTURE TO RECEIVE 6" HALF ROUND WHITE ALUM. GUTTERS WITH DECORATIVE LEADER CONDUCTOR HEADS - (WITH DECORATIVE GUTTER HANGERS / BRACKETS) - 4" ROUND
- DOWNSPOUTS RAINSAVER GUTTER SYSTEM INC. OR EQUAL PROVIDE HOSE BIB SEE DETAIL ON PLUMBING SHT. - HEIGHT AND LOCATIONS TO BE COORDINATED W/ OWNER (NOTE: ALL SECOND FLOOR PORCHES TO RECEIVE HOSE BIBS)
- SEE ELECTRICAL DRAWINGS FOR ALL EXTERIOR LIGHTING FIXTURES & SPECS. (NOTE: ALL FIXTURES TO BE APPROVED BY BUILDER PRIOR TO PURCHASE)
 - ADDRESS NUMBERS & LOCATION TO BE SELECTED BY OWNER. (NOTE: NUMBERS MUST BE MIN. 4" IN HEIGHT AND
- ON A CONTRASTING BACKGROUND). CONCRETE PRIVACY WALL TO HAVE 2" HT. W/ 1" PROJECTION
- SMOOTH STUCCO BANDING SEE SITE PLAN. SELF-CLOSING, SELF LATCHING LOCKING DECORATIVE ALUMINUM
- 50. GATE (MIN. 48" HT.) W/ LATCH LOCATED A MIN. OF 54" HT. ABOVE BOTT. OF GATE. -SEE SITE PLAN AND DOOR SCHEDULE (NOTE: GATE TO OPEN IN AN OUTWARD DIRECTION). DECORATIVE ALUMINUM FENCE - (MIN. 48" HT.) ALONG FRONT OF DUPLEX - W/ E.S.P. PAINTED - (BM) COLOR - "WHITE" -
- VERIFY STYLE WITH BUILDER SEE SITE PLAN. SEE SITE PLAN FOR PROPOSED LOCATIONS AT PERIMETER OF PROPERTY FOR 48" MIN. HIGH CHAINLINK FENCE W/ BLACK VINYL COATING - VERIFY W/ BUILDER ON FENCE COLOR / LOCATION).



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PAINT LEGEND LOT 1 ALL SURFACES TO BE CLEANED 4 PRIMED AS PER BENJAMIN MOORE.

P-1 ACADIA WHITE *AC-41 - (MAIN BODY OF STRUCTURE - LOWER | EVEL AMOOT!) STRUCTURE - LOWER LEVEL SMOOTH

NOTES:

1. DO NOT SCALE DRAWINGS! 2. FIELD VERIFY ALL DIMENSIONS! 3. CONTRACTOR TO VERIFY ALL EXISTING CONDITIONS, AND NOTIFY ARCHITECT IF ANY DESCRIPANCY W/ DRAWINGS. (SEE GENERAL NOTES)

4. ALL AREA CALCULATIONS ARE APPROX

LIGHT FIXTURES (BY TROY LIGHTING OR EQUAL) TROY LIGHTING "LARCHMONT"

OUTDOOR WALL SCONCE 4 LIGHT.
OVER GARAGE DOORS: 32"ht -

TROY LIGHTING "LARCHMONT"

(H) OUTDOOR WALL SCONCE -3 LIGHT.

ENTRY PORCH: 25"ht - AGED

TROY LIGHTING "LARCHMONT"
OUTDOOR WALL SCONCE 2 LIGHT

AT SECOND FLOOR: 19"ht AGED

ALL EXTERIOR LUMINARIES WATTAGE TO BE

ALL EXTERIOR LUMINARIES MUST HAVE A

SHIELD WHICH RESTRICTS THE LIGHT LEVELS

BETWEEN 20-50, 580 NM WAYELENGTH AND AVOID SPILLING INTO ADJACENT PROPERTIES.

BETWEEN 20 TO 50 WATTS. (NOT TO EXCEED 50

AGED PEWTER #133213.

ALL LIGHT FIXTURES TO BE APPROVED BY

PEWTER #B3211.

BUILDER / ARCHITECT

- P-2 GLACIER WHITE * OC-37 (STUCCO LAPSIDING AT SECOND FLOOR LEVEL).
- P-3 BRILLIANT WHITE FASCIA BOARDS, OUTLOOKERS, COLUMNS, BRACKETS WINDOW / DOORS AND TRELLIS. P-4 OLD NAVY *2063-10 (DECORATIVE RAILINGS AND SHUTTERS).
- 9-5 SIERRA MADRE BEL AIR *4503 COLOR THRU BY "EAGLE ROOF TILE, INC."
- NOTE: ALL COLORS ARE FOR PRICING PURPOSES ONLY, CONTRACTOR TO PROVIDE SAMPLES FOR BUILDER APPROVAL.

REQUESTED RELIEF FROM BUILDING HEIGHT REQUIREMENTS LISTED IN LDR SECTION

HATCH REPRESENTS BUILDING HEIGHT PLANE 21'-3" ENCROACHMENT FROM PROPERTY LINE.

PROJECT TITLE

RESIDENTIAL **DUPLEX**

130 SE 1ST AVENUE DELRAY BEACH, FL

REVISIONS

REVISED 5/22/23 AS PER H.P.B. COMMENTS: *1 ADDED AVERAGE CROWN OF ROAD DIMENSION ADDED.ADDED HEIGHT DIMENSIONS FROM AVERAGE CROWN *2 MEAN ROOF HEIGHT DIMENSIONED FROM AVERAGE CROWN OF ROAD.

*3 CHANGED RAILING STYLE.

*4 ADDED LOUVERED DETAIL TO
GARAGE DOOR PANELS.

*5 CHANGED ROOF SLOPE FROM 6 OVER 12 TO 5/12. *6 WINDOWS HAVE BEEN CHANGED FROM LOW - E TO GRAY TINT.

FILE NUMBER 109A300A

DRAWING TITLE


LOT 1

PROPOSED ELEVATIONS

DRAWN BY

GE/MJ 2.15.23 JOB NUMBER

20230109

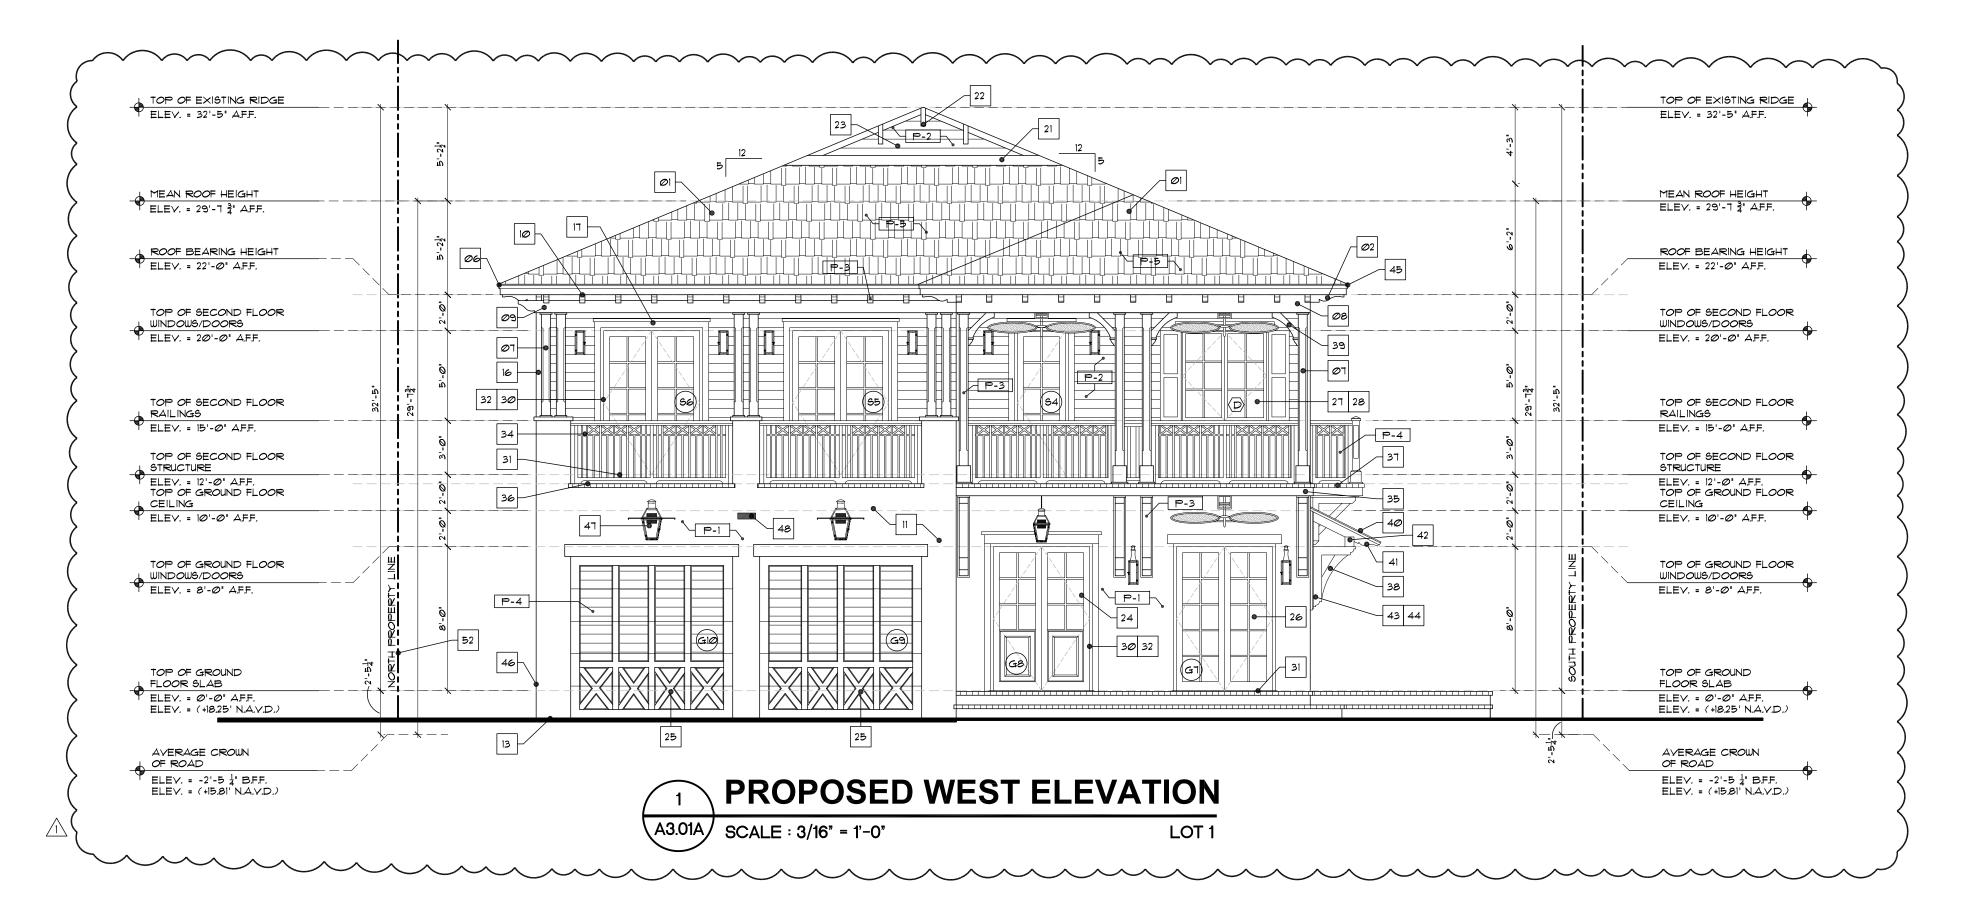

NOTES:

1. DO NOT SCALE DRAWINGS 2. FIELD VERIFY ALL DIMENSIONS! 3. CONTRACTOR TO VERIFY ALL EXISTING CONDITIONS, AND NOTIFY ARCHITECT

IF ANY DESCRIPANCY W/ DRAWINGS. (SEE GENERAL NOTES) 4. ALL AREA CALCULATIONS ARE APPROX

LIGHT FIXTURES

(BY TROY LIGHTING OR EQUAL) TROY LIGHTING "LARCHMONT

- G OUTDOOR WALL SCONCE 4 LIGHT. OVER GARAGE DOORS: 32 ht -AGED PEWTER #133213. TROY LIGHTING "LARCHMONT" (H) OUTDOOR WALL SCONCE -3 LIGHT
- ENTRY PORCH: 25"ht AGED PEWTER #B3212. TROY LIGHTING "LARCHMONT" OUTDOOR WALL SCONCE 2 LIGHT AT SECOND FLOOR: 19 ht AGED

PEWTER #B3211 ALL LIGHT FIXTURES TO BE APPROVED BY BUILDER / ARCHITECT.

- ALL EXTERIOR LUMINARIES WATTAGE TO BE BETWEEN 20 TO 50 WATTS. (NOT TO EXCEED 50
- ALL EXTERIOR LUMINARIES MUST HAVE A SHIELD WHICH RESTRICTS THE LIGHT LEVELS BETWEEN 20-50, 580 NM WAVELENGTH AND AVOID SPILLING INTO ADJACENT PROPERTIES.
- PAINT LEGEND LOT 1 ALL SURFACES TO BE CLEANED 4

PRIMED AS PER BENJAMIN MOORE. ACADIA WHITE *AC-41 - (MAIN BODY OF

GLACIER WHITE * OC-31 (STUCCO - LAPSIDING - AT SECOND FLOOR LEVEL). BRILLIANT WHITE - FASCIA BOARDS, OUTLOOKERS, COLUMNS, BRACKETS WINDOW / DOORS AND TRELLIS.

STRUCTURE - LOWER LEVEL SMOOTH


- OLD NAVY \$2063-10 (DECORATIVE RAILINGS AND SHUTTERS).
- P-5 SIERRA MADRE BEL AIR *4503 COLOR THRU BY "EAGLE ROOF TILE, INC."

REQUESTED RELIEF FROM BUILDING HEIGHT

NOTE: ALL COLORS ARE FOR PRICING PURPOSES ONLY, CONTRACTOR TO PROVIDE SAMPLES FOR BUILDER APPROVAL.

REQUIREMENTS LISTED IN LDR SECTION 4.5.I(E)(T)(8) HATCH REPRESENTS BUILDING HEIGHT PLANE 21'-3" ENCROACHMENT FROM

PROPERTY LINE.

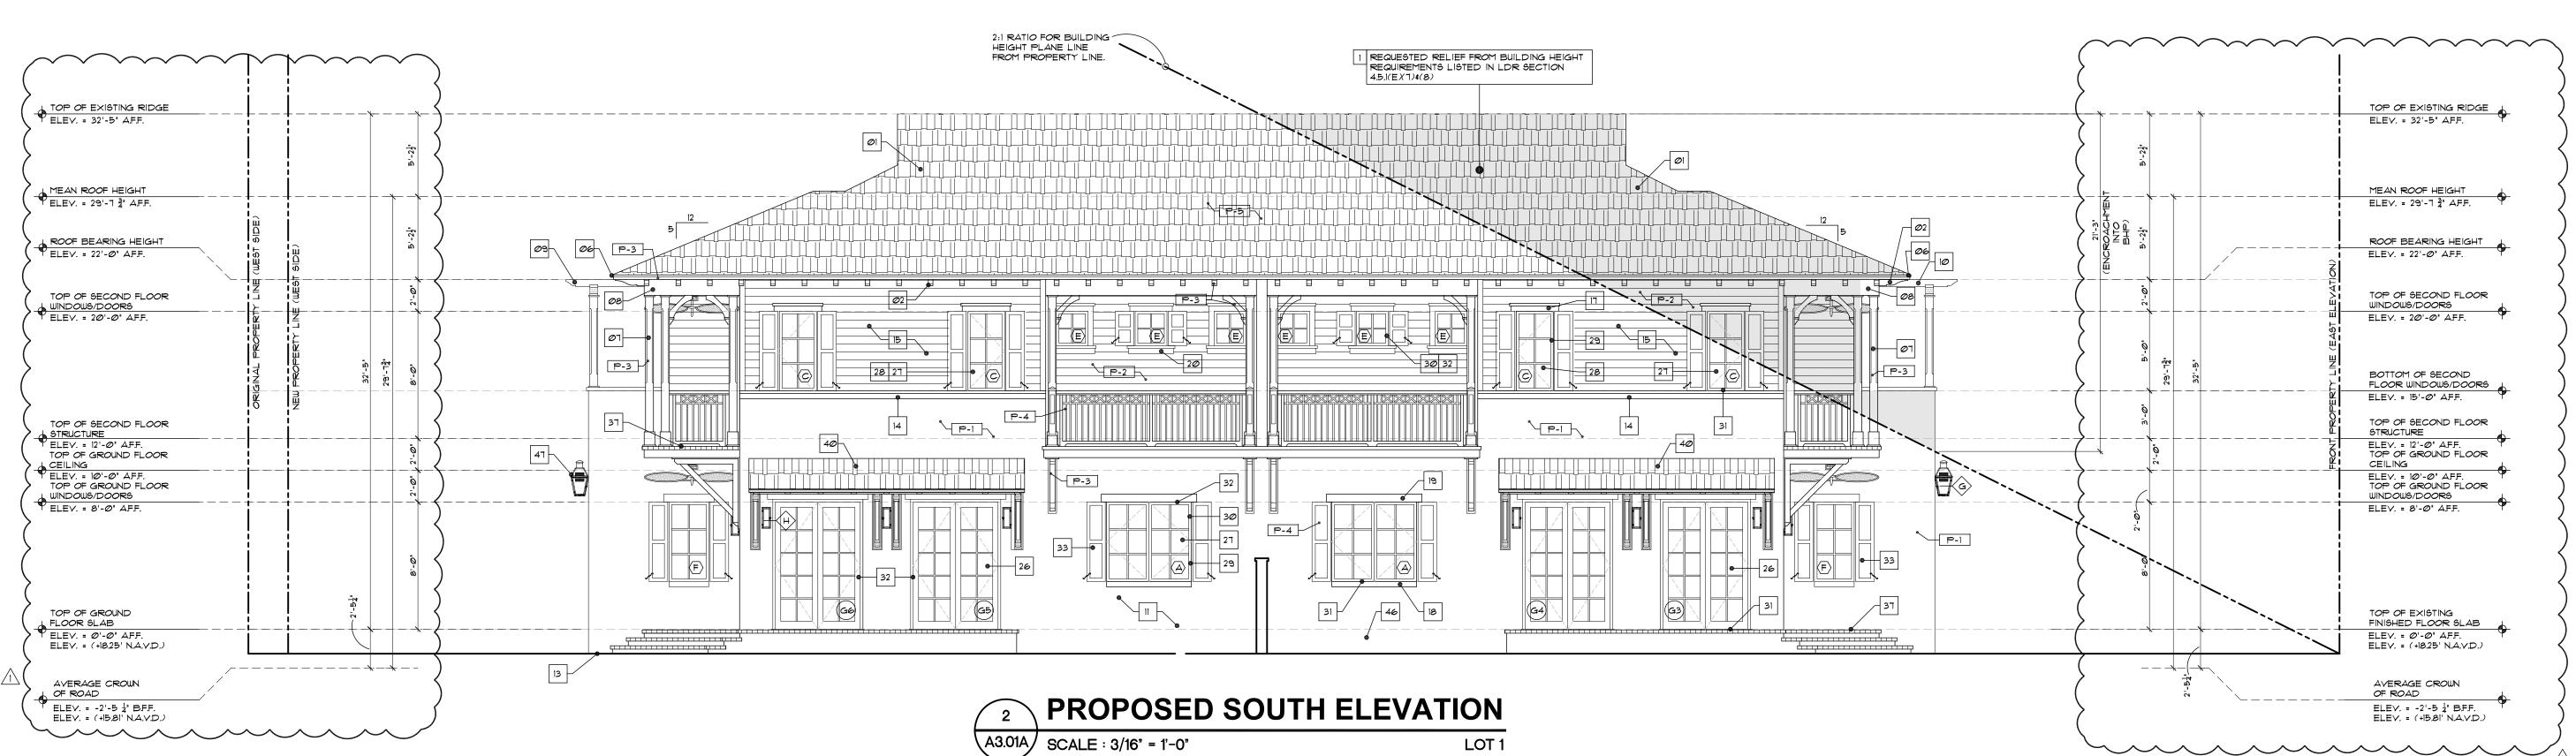

ELEVATION NOTES LOT 1

TILE, INC." OVER 90# FELT HOT MOPPED ON 30# FELT TIN-TAGGED TO 3/4" A.P.A. RATED EXT. GRADE PLYWD. SHEATH'G. INSTALL AS PER ROOF'G. SPEC'S. (TYP.) (NOTE: ALL HIPS TO HAVE MITERED CAPS). 30" x 3" x 6" DECORATIVE OUTRIGGERS (NOTE: KING OUTRIGGERS 42") W/ "CELLOFOAM" HIGH DENSITY FOAM SHAPED COATED W/ POLYURETHANE RESIN *UTC-5067 URETHANE ELASTROMER COATING OR EQUAL PAINTED. - CONTRACTOR TO ATTACHED DECORATIVE BRACKET W/ 'DOW ENERFOAM" FOAM SEALANT. - (UNDERSIDE OF SOFFIT TO BE 3" 3-COATS SMOOTH STUCCO FINISH W/ 1" x 6" T&G PATTERN - PAINTED -SEE

SIERRA MADRE - BEL AIR *4503 - COLOR THRU BY "EAGLE ROOF

- REFLECTED CEILING PLAN FOR LAYOUT). SEE ROOF PLAN FOR BUILT-UP CRICKET FOR POSITIVE DRAINAGE -03. (NOTE ALL CRICKETS TO HAVE MIN. 2 LAYERS SMOOTH MODIFIED PLUS
- \longrightarrow A CLASS "A" MODIFIED CAP SHEET TYP.). BLOCK WALLS ALONG 2ND FLOOR & ROOF CRICKETS TO BE 04. PROTECTED W/ 'SIKA ROOFPRO' BY SIKA OR EQUAL - INSTALLED AS PER MANUF SPEC'S.
- PROVIDE KICK OUT FLASHING TO DIVERT ROOF WATER FLOW AWAY 05. PROVIDE KI
- CONT. ALUM. DRIP EDGE ON CONT. P.T. I \times 2 ON CONT. 2 \times 4 9MOOTH CLEAR CEDAR FASCIA -PAINTED TYP. AT
- 6' x 6' SMOOTH CLEAR CEDAR COLUMN W/ CHAMFERED EDGES AND 1" "AZEK" TRIM OR EQ. - SEE STRUCT. DRAWINGS FOR HIDDEN CONNECTIONS. CONTRACTOR TO SUBMIT SHOP DRAWINGS FOR APPROVAL.

- TI 6 x 12 S4S SMOOTH CLEAR CEDAR BEAM PAINTED (TYP. @ 08. SECOND FLOOR COVERED PORCH CONDITIONS). -SEE REFLECTED CEILING PLAN & SECTION. - ALL CONNECTION TO BE HIDDEN -VERIFY W/ STRUCTURAL DWGS.
- 09. W SHAPED DECORATIVE TAIL (PAINTED) SEE STRUCT. DWG'S. FOR ALL HIDDEN CONNECTIONS (TYP. W/ CONT. COPPER FLASHING @ TOP OF ALL TRELLIS MEMBERS).
- 2 x 2 949 CLEAR CEDAR SLEEPERS @ 12" O.C. PAINTED WHITE (TYP. AT ALL TRELLIS LOCATIONS). 11. 2-COAT 5/8" SMOOTH STUCCO FINISH, PAINTED TYP.
- 12. CONT. 12" RAISED SMOOTH STUCCO BASE, "WATER-TABLE" TYP. AT PERIMETER OF ENTIRE HOUSE.
- EXTERIOR STUCCO TO EXTEND A MIN. 1'-0" BELOW GRADE (TYP. @ ENTIRE PERIMETER) 2" HT. W/ 1 1/2" PROJECTION SMOOTH STUCCO BANDING-
- TYP. AT BOTT. OF STUCCO "LAPSIDING". 7/8" 3-COAT SMOOTH STUCCO W/ 6" LAP SIDING- FINISH-15. PAINTED (NOTE: SCRATCH COAT APPLIED DIRECTLY TO BLOCK PRIOR TO LAP SIDING PVC TRIM) - PVC TO BE AN
- INTEGRAL COMPONENT TO THE STUCCO SIDING-(TYP.). 2" x 4" SMOOTH STUCCO- PAINTED (TYP. @ ALL CORNERS AND WINDOW SURROUNDS AT STUCCO LAPSIDING).

- 1"TH x 4"W SMOOTH RAISED STUCCO WINDOW / DOOR SURROUND W/ 1" x 1 1/2" TH. RAISED STUCCO BANDING AT HEADER - PAINTED (TYP. AT SECOND FLOOR LAPSIDING). " TH. × 4"HT. RAISED SMOOTH STUCCO WINDOW SILL BANDING - PAINTED (TYP.).
- 1"TH. \times 6"HT. SMOOTH RAISED STUCCO WINDOW HEADER W/ 4" EXTENSION BEYOND WINDOW JAMB, PAINTED (TYP.). (2) LAYER STEP SILL BANDING 2" HT. W/ 1 1/2" PROJECTION SMOOTH STUCCO BANDING- (LOWER BAND 4" HT. W/ 3/4"
- LAPSIDING) SLOPED FOR POSITIVE DRAINAGE. 2" x 6" SMOOTH CLEAR CEDAR FACIA BOARD - PAINTED -TYP. AT ALL BOSTON HIP ROOFS (PROVIDE ALT. PRICE FOR "AZEK" OR EQUAL).

PROJECTION @ STUCCO) - PAINTED (TYP. @ WINDOWS /

 $\fbox{22.}$ (3) 3 \times 12 RIDGE RAFTER TAIL- TYP. AT "BOSTON HIP" ROOF. ALL "BOSTON HIP" END ROOF CONDITIONS TO RECEIVE

COMPLIANCE W/ WIND & IMPACT REQ'MNTS.

- 23. ADDITIONAL ANGLED TRUSS BRACING TO MEET WIND CYCLING REQUIREMENTS. -SEE STRUCTURAL DWGS. FRONT DOOR TO BE "SIGNATURE DOOR INC." STAINED 24. MAHOGANY" (VERIFY W/ BUILDER ON STAIN) - INSTALLED BY "COASTAL SUPPLY" OR EQ. PROVIDE CERTIFICATE OF
- (TYPICAL), GARAGE DOOR BY "EDL" OR EQUAL OFFSET DOORS FOR DECORATIVE "BORAL" APPLIED PANELS OR EQUAL (TO BE SELECTED BY BUILDER - SEE EXTERIOR ELEVATIONS). "PGT" 750 SERIES ALUM. FRENCH DOORS (COLOR WHITE) -W/ GRAY TINT - GLASS TO BE IMPACT RESISTANT AND COMPLY W/ ALL DADE COUNTY IMPACT AND WIND CYCLING TESTING REQUIREMENTS. CONTRACTOR TO PROVIDE CERTIFICATE OF COMPLIANCE (TYP.). - SEE DOOR SCHEDULE "PGT" CASEMENT & FIXED (SEE MEANS OF EGRESS) ALUM.

DADE COUNTY WIND CYCLING AND IMPACT TESTING

REQUIREMENTS. PROVIDE CERTIFICATE OF COMPLIANCE

- WINDOWS W/ GRAY TINT GLASS (ALUM. FRAME COLOR -WHITE) TO BE IMPACT RESISTANT AND COMPLY W/ALL DADE COUNTY IMPACT AND WIND CYCLING TESTING REQUIREMENTS CONTRACTOR TO PROVIDE CERTIFICATE OF COMPLIANCE (TYP.). - SEE WINDOW SCHEDULE FOR ALL TRANSOM WINDOW EGRESS TYPE WINDOW SHALL BE OPERABLE FROM THE
 - INSIDE WITHOUT THE USE OF TOOLS AND PROVIDE A CLEAR OPENING OF NOT LESS THAN 20" W/ 24"HT. AND 5.1 SQ FT AREA THE BOTTOM OF THE OPENING SHALL BE NOT MORE THAN 44" FROM THE FINISH FLOOR LEVEL NOR SHALL ANY PART OF THE OPERATING MECHANISM BE PLACED HIGHER THAN 54" FROM THE FIN. FLOOR. ALL WINDOWS TO HAVE I x P.T. WD BUCKS ANCHORED TO CONC AS PER PRODUCT APPROVAL.
- ALL EXTERIOR DOORS & WINDOWS TO HAVE "SIKAFLEX ALL OVERHEAD INSULATED GARAGE DOORS ARE TO MEET #150" OR EQUAL CAULKING @ BUCK/CMU/ALUM. FRAME CONDITIONS (TYP.) ALL ALUM. EXT. DOOR THRESHOLDS & WINDOW SILLS TO BE 37SET IN "SIKAFLEX PRO" OR EQUAL & CONC. THRESHOLD/
 - ALL DOOR & WINDOW CORNERS, HDR'S. & JAMBS TO BE WRAPPED W/ "SIKA TOP SEAL 107" OR EQ. THEN - APPLY "SIKAFLEX 102 EVERFLASH MEMBRANE" OR EQ. OVER ALL WOOD BUCKS W/ A MIN. 8" AT THE INTERIOR SIDE OF ALL OPENINGS AND 12" ON THE FACE OF ALL THE OPENINGS INSTALLED AS PER MANUF. SPEC'S BY "SIKA" OR EQ. -NOTE: CONTRACTOR TO REQUEST "ADHESION TEST" BY SIKA AND OR MANUF.
 - DECOR. ALUMINUM WINDOW SHUTTERS W/ ALL CONCEALED CONNECTION AND 2 x SPACERS @ REAR FOR PROTECTION FROM BUILD'G W/ E.S.P PAINTED - (BM) "KENDAL CHARCOAL HC-166 FOR SHUTTERS AND 'BLACK SHUTTER DOGS' OR EQUAL (COLORS TO BE APPROVED BY BUILDER). ALUMINUM DECORATIVE 'X' RAIL W/ E.S.P. POWDER COAT FINISH (COLOR (BM) KENDAL CHARCOAL - HC-166)- TOP OF RAIL MIN. 42" WITH PLEX- GLASS INSERTS TO BLOCK PASSAGE OF 4" SPHERE. (BOTTOM RAIL MAX. 2" A.F.F. -TYP.) - PROVIDE SHOP DRAWINGS/ SAMPLE. BY "JC ORNAMENTAL IRON WORK' OR EQUAL, PROVIDE SHOP DRAWINGS FOR

35. COVERED PORCHES TO SLOPE 1/FT.

- STYLE, SIZES AND DESIGN SAFETY / SAMPLE. (NOTE: ALL EXTERIOR RAILINGS SHALL COMPLY W/ F.B.C. 2020 EDITION). POURED IN PLACE CONC SLAB. SEE STRUC DWGS (TYP.) ALL 43.
- 36. CONT | 1/4"HT. x 4" COPPER DRIP EDGE @ ALL BALCONIES. ALL PORCHES TO RECEIVE "STONE PAVERS" MUDSET BY "ARTISTIC PAYERS" OR EQUAL, NON-SLIP W/ SQUARE EDGE AT THE OUTER EDGE. DECK TO BE MUDSET OVER .125" LIQUID WATERPROOFING ON CONC. DECK, "SIKALASTIC 710/715" OR EQ
- REQ. SAMPLE FOR OWNER / INTERIOR DESIGNER APPROVAL). CONTRACTOR TO USE A POLYMER MODIFIED, NON EFFLORESCENCE MUDSET OR THINSET GROUT. 4 \times 10 K.D.A.T. P.T. PINE DECORATIVE BRACKET & BASE W/ ALL COUNTERSUNK & FILLED ANCHORS - PAINTED (BM) BRILLIANT WHITE (TYP. AT FRONT COVERED ENTRANCE).
- 3 x 4 SMOOTH CLEAR CEDAR DECORATIVE BRACKETS W/ DECORATIVE CORBELS - PAINTED (BM) BRILLIANT WHITE (TYP. AT SECOND FLOOR COVERED PORCH). SIERRA MADRE - BEL AIR *4503 - COLOR THRU ROOFING
- SYSTEM BY "EAGLE ROOF TILE, INC. ON "ICE & WATER SHIELD" OVER 30* FELT, T.T. TO 2 x 6 P.T. T&G WOOD DECKING (TYP. - AT LOWER LEVEL SHED ROOF). $3 \times 6 \times 4'$ -6" LONG P.T. 545 WOOD ROOF JOIST - PAINTED (TYP. AT LOWER LEVEL SHED ROOF).
 - $4\,\%$ × $4\,\%$ K.D.A.T. P.T. WOOD BEAM PAINTED (TYP. AT LOWER LEVEL SHED ROOF). 4 x 10 K.D.A.T. P.T. PINE DECORATIVE BRACKET & BASE W/ ALL COUNTERSUNK & FILLED ANCHORS - PAINTED (BM) BRILLIANT

WHITE (TYP. AT LOWER LEVEL SHED ROOF).

- 44. 2 x 6 K.D.A.T. P.T. BACK PLATE PAINTED (BM) BRILLIANT WHITE (TYP, AT EACH BRACKET) CONTRACTOR TO PROVIDE PRICE FOR ENTIRE STRUCTURE
 - TO RECEIVE 6" HALF ROUND WHITE ALUM. GUTTERS WITH DECORATIVE LEADER CONDUCTOR HEADS - (WITH DECORATIVE GUTTER HANGERS / BRACKETS) - 4" ROUND DOWNSPOUTS - RAINSAVER GUTTER SYSTEM INC. OR EQUAL
 - PROVIDE HOSE BIB SEE DETAIL ON PLUMBING SHT. HEIGHT AND LOCATIONS TO BE COORDINATED W/ OWNER (NOTE: ALL SECOND FLOOR PORCHES TO RECEIVE HOSE BIBS).
 - SEE ELECTRICAL DRAWINGS FOR ALL EXTERIOR LIGHTING FIXTURES & SPECS. (NOTE: ALL FIXTURES TO BE APPROVED BY BUILDER PRIOR TO PURCHASE).
 - ADDRESS NUMBERS & LOCATION TO BE SELECTED BY OWNER. (NOTE: NUMBERS MUST BE MIN. 4" IN HEIGHT AND ON A CONTRASTING BACKGROUND).
 - CONCRETE PRIVACY WALL TO HAVE 2" HT. W/ I" PROJECTION SMOOTH STUCCO BANDING SEE SITE PLAN. SELF-CLOSING, SELF LATCHING LOCKING DECORATIVE ALUMINUM GATE - (MIN. 48" HT.) W/ LATCH LOCATED A MIN. OF 54" HT. ABOVE BOTT. OF GATE. -SEE SITE PLAN AND DOOR SCHEDULE

SEE SITE PLAN FOR PROPOSED LOCATIONS AT PERIMETER

VINYL COATING - VERIFY W/ BUILDER ON FENCE COLOR /

OF PROPERTY FOR 48" MIN. HIGH CHAINLINK FENCE W/ BLACK

(NOTE: GATE TO OPEN IN AN OUTWARD DIRECTION). DECORATIVE ALUMINUM FENCE - (MIN. 48" HT.) ALONG FRONT OF DUPLEX - W/ E.S.P. PAINTED - (BM) COLOR - "WHITE" -VERIFY STYLE WITH BUILDER - SEE SITE PLAN.

LOCATION).



architecture, planning and design

1045 East Atlantic Ave. Suite 303 Delray Beach, Florida 33483 TEL: 561-276-6011 FAX: 561-276-6129

ISSUED FOR

BIDS

PERMIT

CONSTRUCTION

PROJECT TITLE

RESIDENTIAL **DUPLEX**

130 SE 1ST AVENUE DELRAY BEACH, FL

REVISIONS

REVISED 5/22/23 AS PER H.P.B. COMMENTS: M ADDED AVERAGE CROWN OF ROAD DIMENSION ADDED.ADDED HEIGHT DIMENSIONS FROM AVERAGE CROWN *2 MEAN ROOF HEIGHT DIMENSIONED FROM AVERAGE CROWN OF ROAD. *3 CHANGED RAILING STYLE.

*4 ADDED LOUVERED DETAIL TO
GARAGE DOOR PANELS.

*5 CHANGED ROOF SLOPE FROM 6 OVER 12 TO 5/12. *6 WINDOWS HAVE BEEN CHANGED

FROM LOW - E TO GRAY TINT.

FILE NUMBER 109A300A

DRAWING TITLE

PROPOSED ELEVATIONS LOT 1


> DRAWN BY GE/MJ 2.15.23

JOB NUMBER 20230109



151 NW 1ST AVE



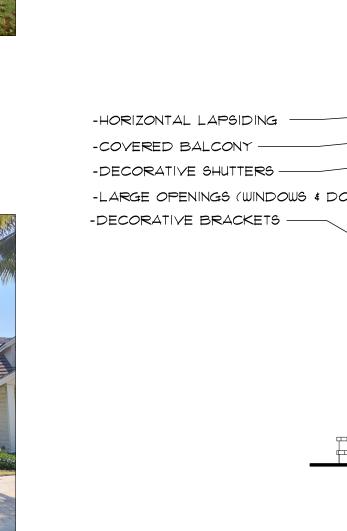


210 N SWINTON AVE



348 NE 1ST AVE




SUNDY VILLAGE

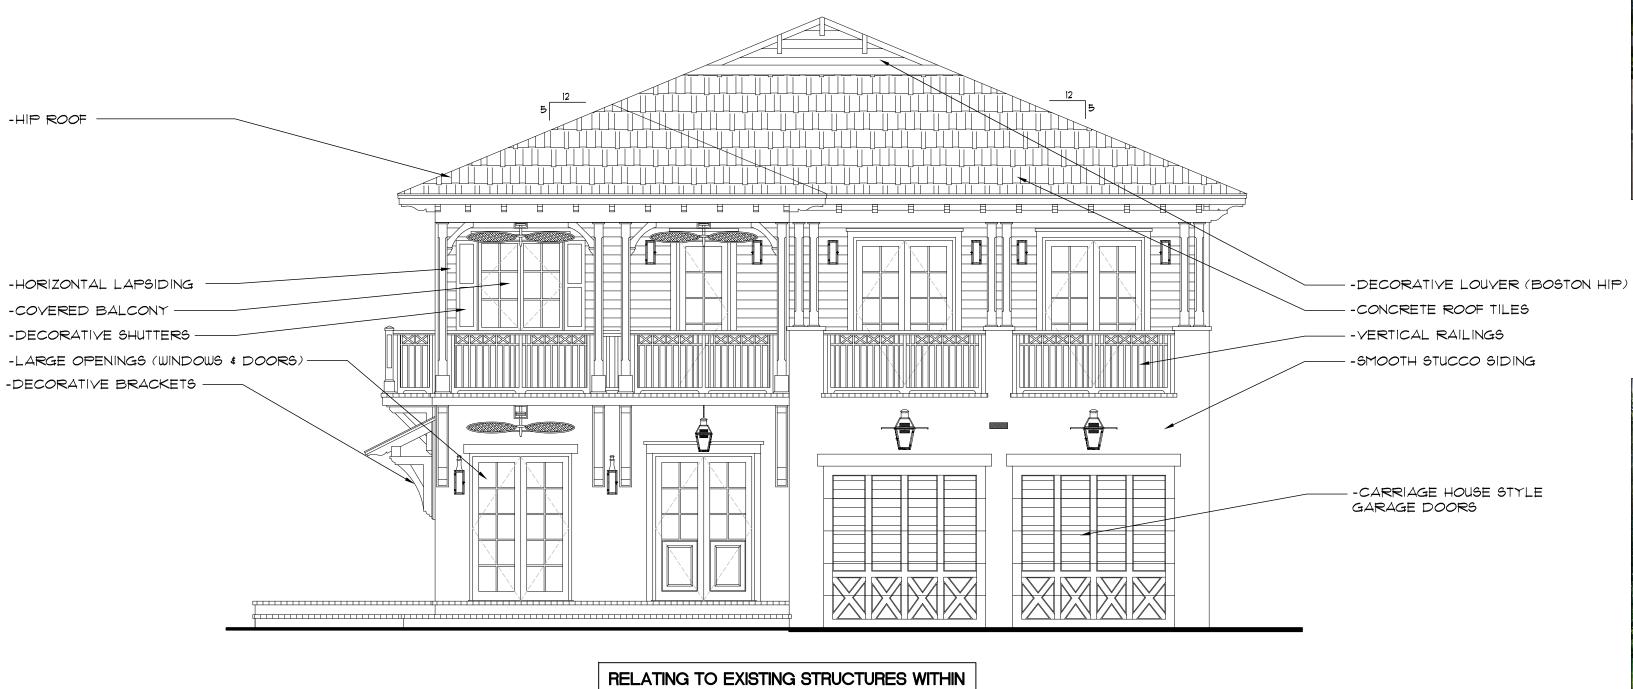

HISTORIC DISTRICT : 1. MASSING / SCALE / HEIGHT 2. FACADE / OPENINGS / RHYTHM 3. MATERIAL / COLORS



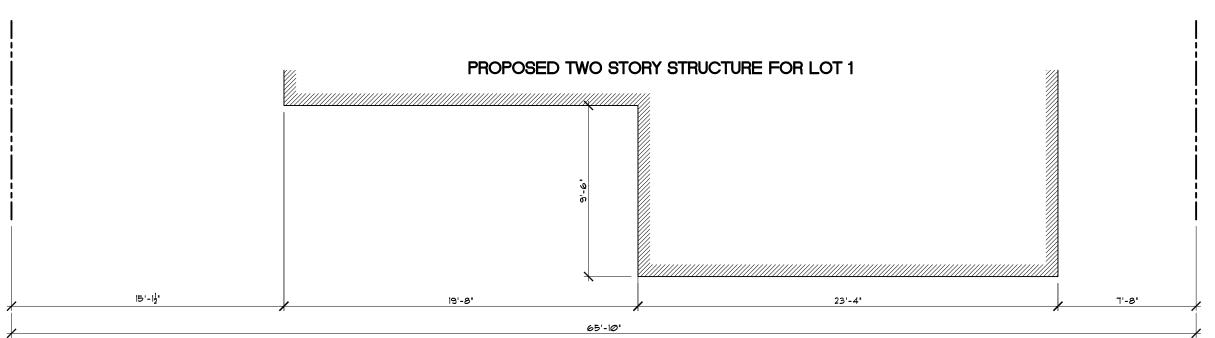

65.833' (LOT WIDTH) x 40% = 26.33' - 22.5' (SIDE SETBACKS) = 3.83' (19'-8" IS SETBACK AN ADDITIONAL 9'-6").



HISTORIC TWO STORY STRUCTURES WITHIN THE DISTRICT



334 NE 1ST AVE



20 N SWINTON AVE (CRA OFFICE)



42 N SWINTON AVE



300 N SWINTON AVE



131 NE 1ST AVE



330 NE 1ST AVE



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CONSTRUCTION

PROJECT TITLE

RESIDENTIAL **DUPLEX**

130 SE 1ST AVENUE DELRAY BEACH, FL

REVISIONS


; FILE NUMBER

DRAWING TITLE

VISUAL COMPATIBILITY **PROPOSAL**

TE DRAWN BY GE/MJ

A3.02A

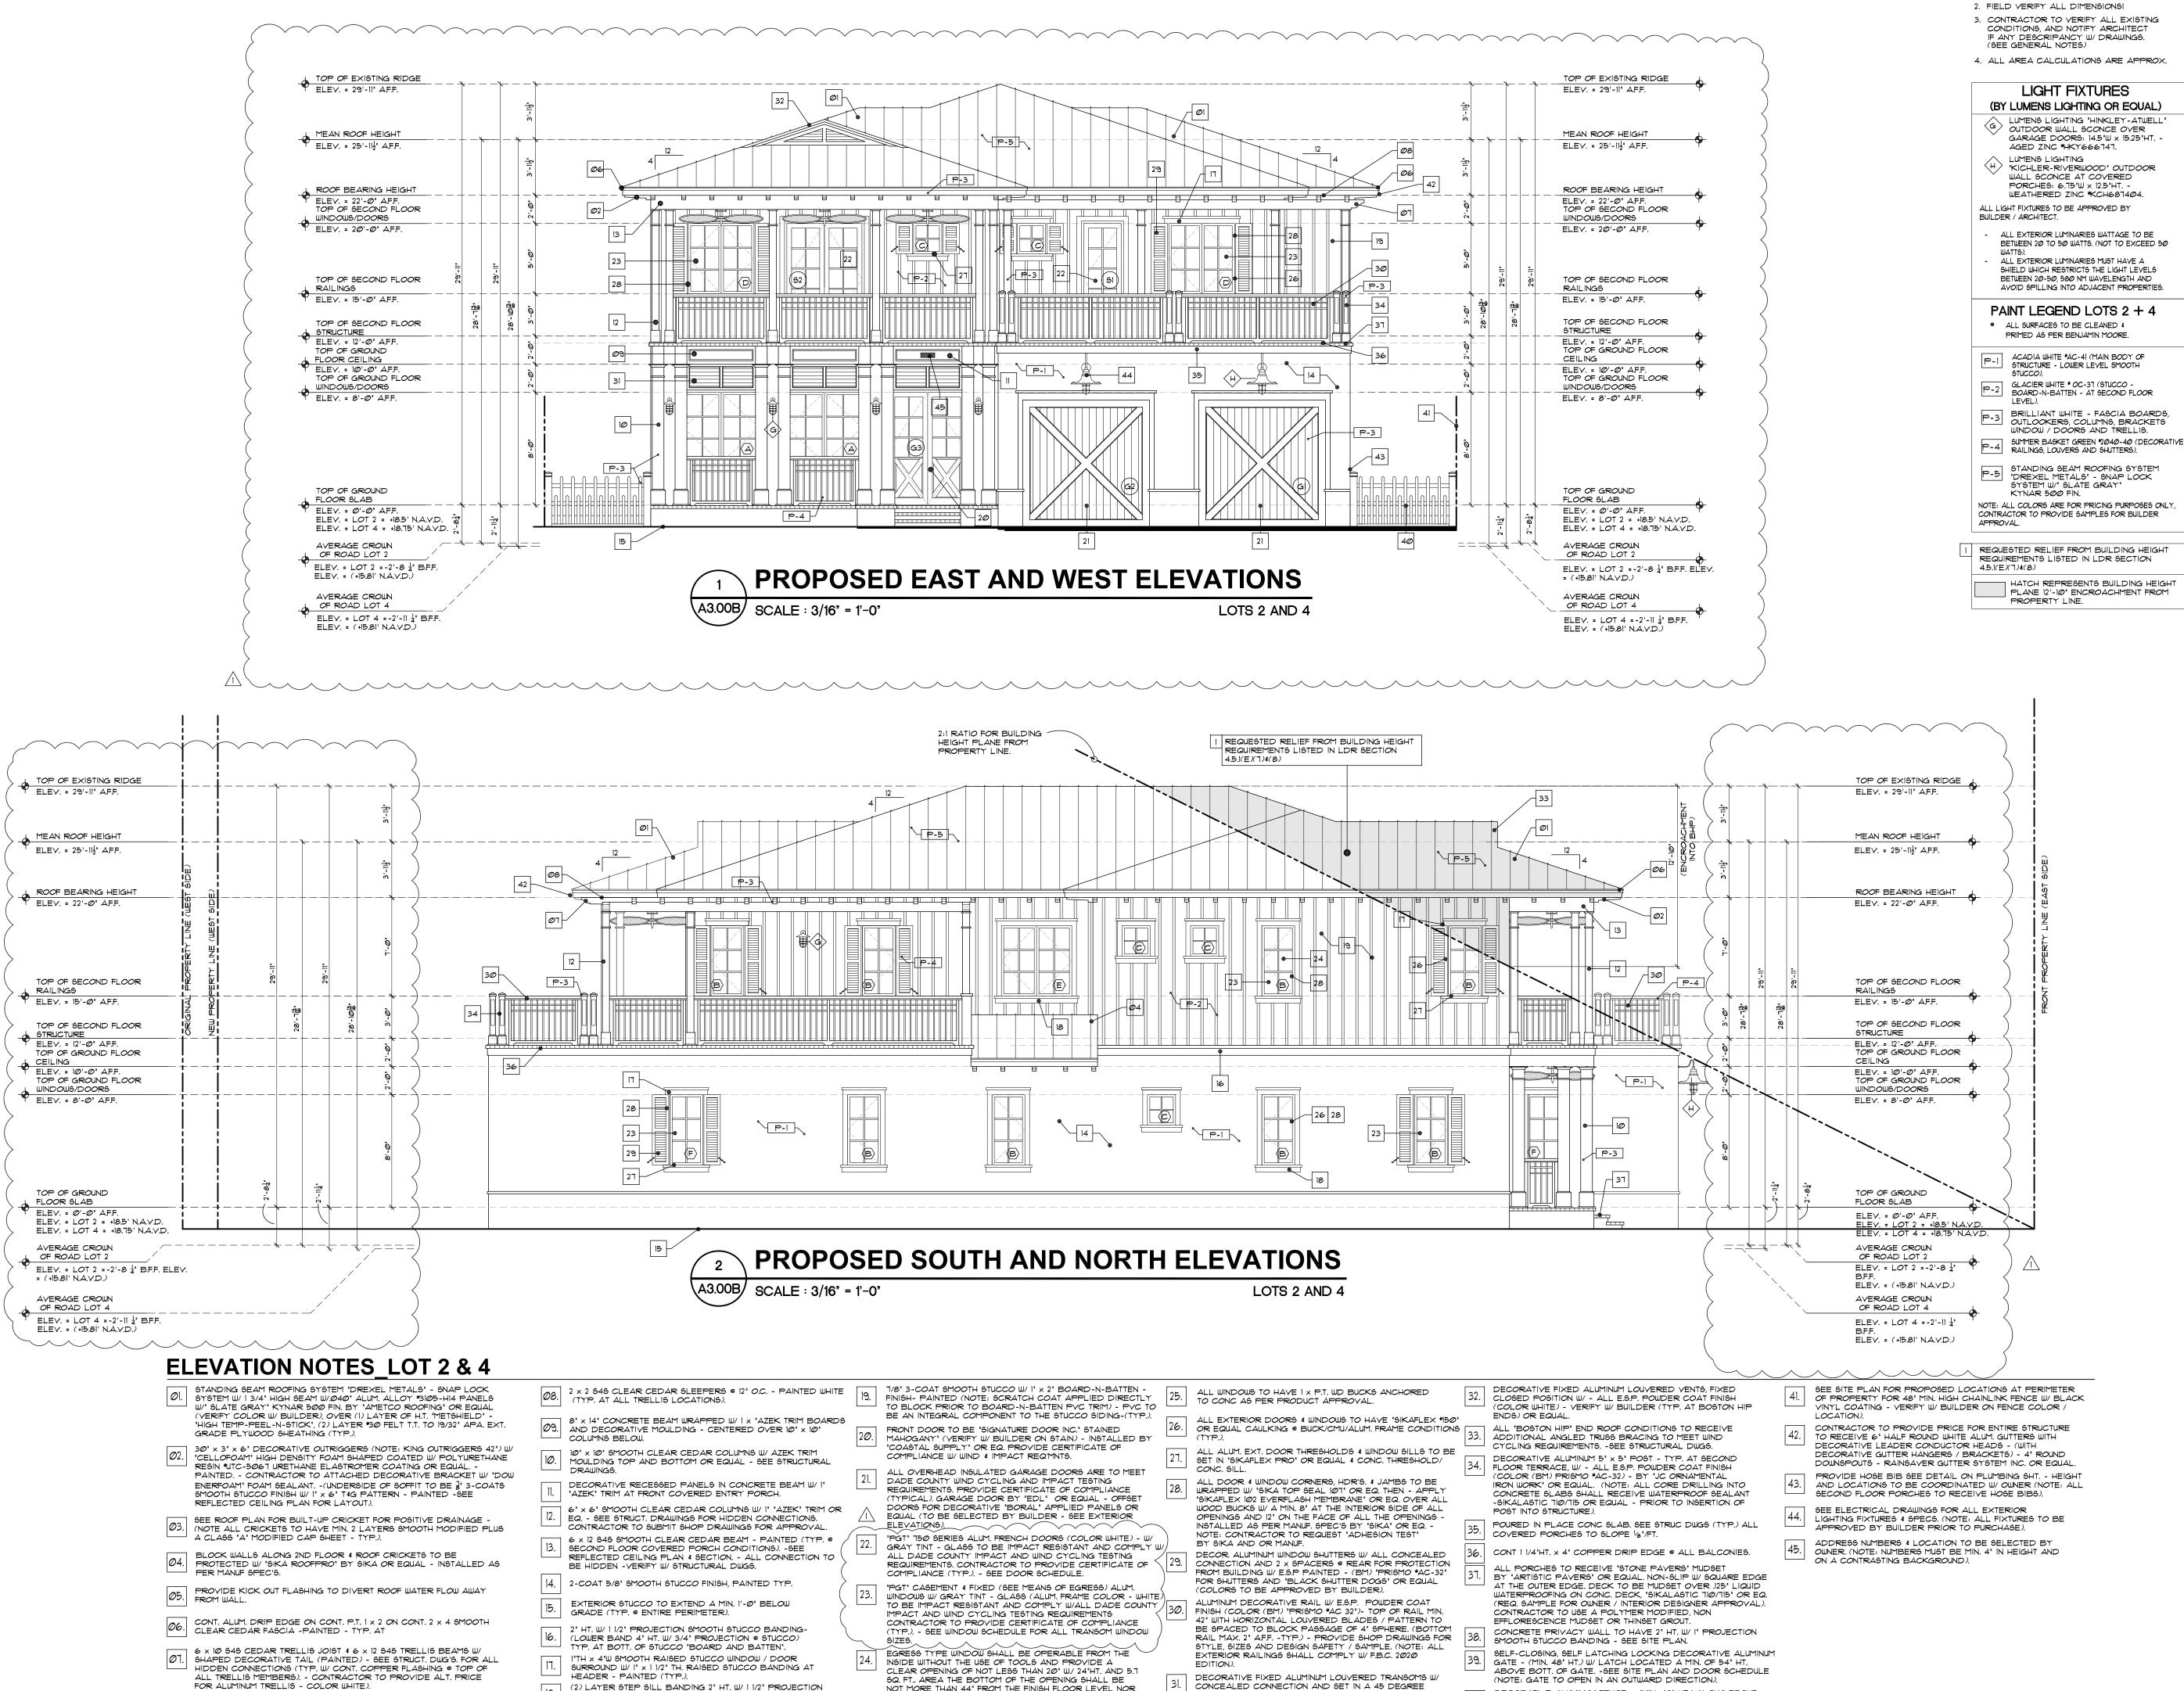

NOT MORE THAN 44" FROM THE FINISH FLOOR LEVEL NOR

SHALL ANY PART OF THE OPERATING MECHANISM BE

PLACED HIGHER THAN 54" FROM THE FIN. FLOOR.

POSITION W/ E.S.P PAINTED FIN. - COLOR (BM) PISMO

*AC-32" - VERIFY W/ BUILDING) TYP. @ GROUND FLOOR COVERED ENTRY PORCH.

SMOOTH STUCCO BANDING- (LOWER BAND 4" HT. W/ 3/4"

FOR POSITIVE DRAINAGE.

PROJECTION @ STUCCO) - PAINTED (TYP. @ WINDOWS) SLOPED

DECORATIVE ALUMINUM FENCE - (MIN. 48" HT.) ALONG FRONT

OF DUPLEX - W/ E.S.P. PAINTED - (BM) COLOR - "WHITE" -

VERIFY STYLE WITH BUILDER - SEE SITE PLAN.

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CONSTRUCTION

STANDING SEAM ROOFING SYSTEM

1. DO NOT SCALE DRAWINGS!

NOTE: ALL COLORS ARE FOR PRICING PURPOSES ONLY,

REQUESTED RELIEF FROM BUILDING HEIGHT

REQUIREMENTS LISTED IN LDR SECTION

HATCH REPRESENTS BUILDING HEIGHT

PROJECT TITLE

RESIDENTIAL **DUPLEX**

130 SE 1ST AVENUE DELRAY BEACH, FL

REVISIONS

REVISED 5/22/23 AS PER H.P.B. * ADDED AVERAGE CROWN OF ROAD DIMENSION ADDED.ADDED HEIGHT DIMENSIONS FROM AVERAGE CROWN *2 MEAN ROOF HEIGHT DIMENSIONED FROM AVERAGE CROWN OF ROAD. *3 CHANGED RAILING STYLE.

*4 ADDED LOUVERED DETAIL TO
GARAGE DOOR PANELS.

*5 CHANGED ROOF SLOPE FROM 6 /0

*6 WINDOWS HAVE BEEN CHANGED FROM LOW - E TO GRAY TINT.

FILE NUMBER

109A200B

DRAWING TITLE

PROPOSED ELEVATIONS

LOTS 2 AND 4

DRAWN BY GE/MJ 2.15.23 JOB NUMBER


20230109



227 NW 1ST AVE



RELATING TO EXISTING STRUCTURES WITHIN HISTORIC DISTRICT: 1. MASSING / SCALE / HEIGHT 2. FACADE / OPENINGS / RHYTHM 3. MATERIAL / COLORS

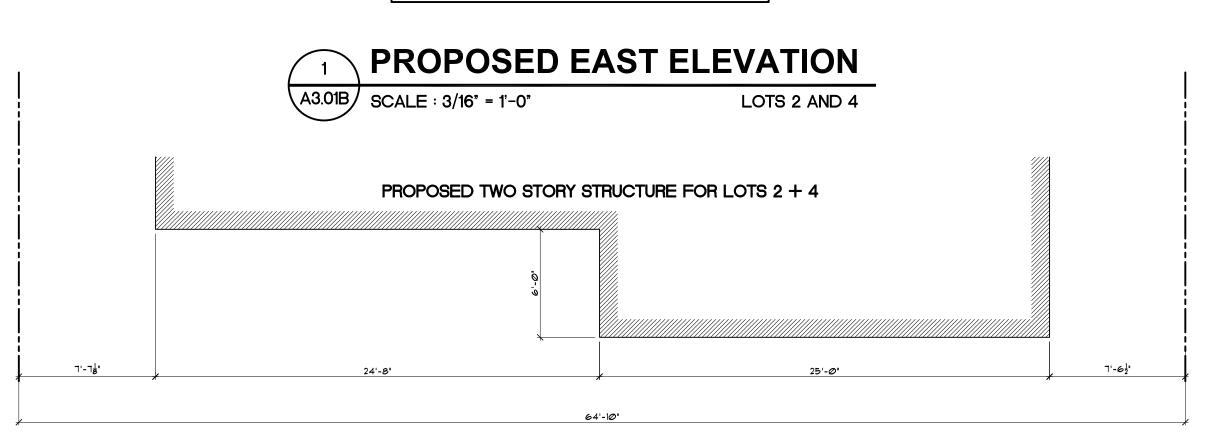

64.833' (LOT WIDTH) x 40% = 25.93' - 15' (SIDE SETBACKS) = 10.93' (24'-8" IS SETBACK AN ADDITIONAL 6'-0"). NOTE: THIS CALCULATION IS NOT REQUIRED FOR LOTS 65'-0" OR LESS.

LOT WIDTH CALCULATION

A3.01B | SCALE : 3/16" = 1'-0"





306 N SWINTON AVE

210 N SWINTON AVE



234 BANKERS ROW

LOTS 2 AND 4



226 BANKERS ROW 20 N SWINTON AVE



150 NE 1ST AVE



338 NE 1ST AVE



300 N SWINTON AVE

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BIDS

PERMIT

CONSTRUCTION

PROJECT TITLE

RESIDENTIAL **DUPLEX**

130 SE 1ST AVENUE DELRAY BEACH, FL

REVISIONS

; FILE NUMBER 109A301B


DRAWING TITLE

VISUAL COMPATIBILITY PROPOSAL

TE DRAWN BY GE/MJ

DRAWING NUMBER

A3.01B

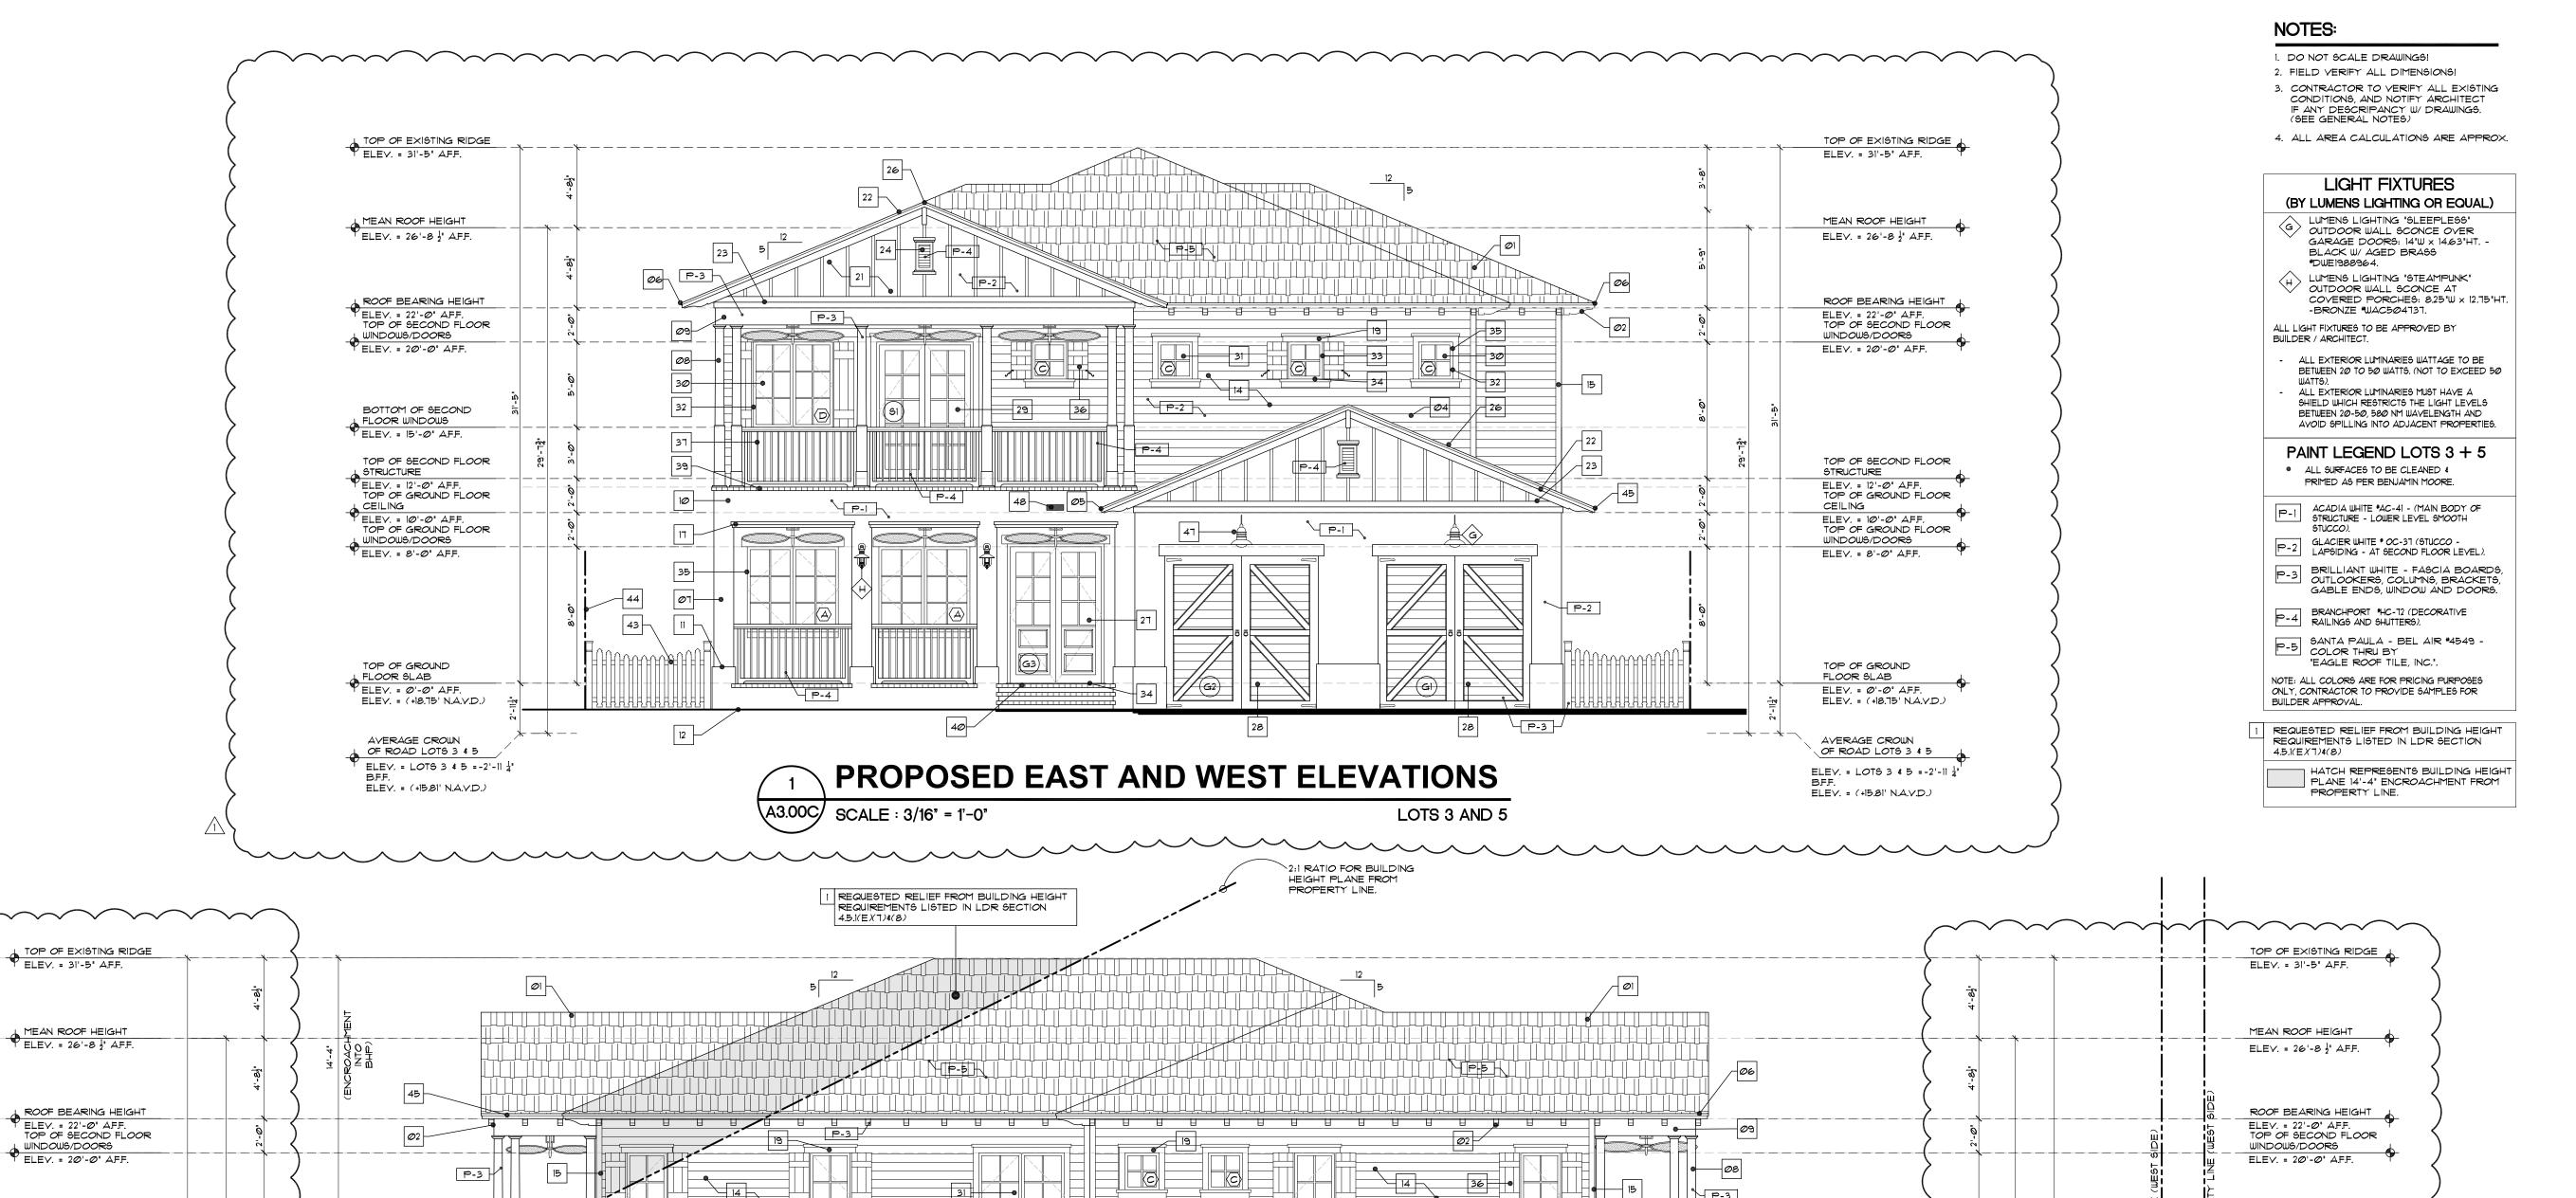

P-I

LOTS 3 AND 5

ELEVATION NOTES LOT 3 & 5

SANTA PAULA - BEL AIR *4549 - COLOR THRU BY 'EAGLE ROOF 01. TILE, INC." OVER 90* FELT HOT MOPPED ON 30* FELT TIN-TAGGED TO 3/4" A.P.A. RATED EXT. GRADE PLYWD. SHEATH'G. INSTALL AS PER ROOF'G. SPEC'S. (TYP.) (NOTE: ALL HIPS TO HAVE MITERED CAPS). 30" x 3" x 6" DECORATIVE OUTRIGGERS (NOTE: KING OUTRIGGERS 42") W/

TOP OF SECOND FLOOR

TOP OF GROUND FLOOR

TOP OF GROUND FLOOR

STRUCTURE ELEV. = 12'-0" A.F.F.

CEILING | CEILING | A.F.F.

ELEV. = 8'-0" A.F.F.

TOP OF GROUND

ELEV. = 0'-0" AFF. ELEV. = (+18.75' N.A.V.D.)

AVERAGE CROWN

OF ROAD LOTS 3 \$ 5

ELEV. = (+15.81' N.A.V.D.)

ELEV. = LOTS 3 & 5 =-2'-11 4" B.F.F.

FLOOR SLAB

- 02. CELLOFOAM' HIGH DENSITY FOAM SHAPED COATED W/ POLYURETHANE RESIN *UTC-5067 URETHANE ELASTROMER COATING OR EQUAL. -PAINTED. - CONTRACTOR TO ATTACHED DECORATIVE BRACKET W/ DOW ENERFOAM' FOAM SEALANT. - (UNDERSIDE OF SOFFIT TO BE 2 3-COATS SMOOTH STUCCO FINISH W/ 1" x 6" T&G PATTERN - PAINTED -SEE REFLECTED CEILING PLAN FOR LAYOUT)
- SEE ROOF PLAN FOR BUILT-UP CRICKET FOR POSITIVE DRAINAGE -03. (NOTE ALL CRICKETS TO HAVE MIN. 2 LAYERS SMOOTH MODIFIED PLUS A CLASS "A" MODIFIED CAP SHEET - TYP.).
- BLOCK WALLS ALONG 2ND FLOOR & ROOF CRICKETS TO BE DA. BLOCK WALLS ALONG IND FLOOR & ROOF GIVEN TO BE PROTECTED W/ 'SIKA ROOFPRO' BY SIKA OR EQUAL - INSTALLED AS PER MANUF SPEC'S.
- PROVIDE KICK OUT FLASHING TO DIVERT ROOF WATER FLOW AWAY 05. PROVIDE KION WALL.
- CONT. ALUM. DRIP EDGE ON CONT. P.T. 1 \times 2 ON CONT. 2 \times 4 5MOOTH CLEAR CEDAR FASCIA -PAINTED - TYP. AT
- 01. I4" \times I4" CONCRETE COLUMNS W/ 2-COATS \S " SMOOTH STUCCO PAINTED FINISH.

- 6' x 6' \$MOOTH CLEAR CEDAR TAPERED COLUMNS W/ I' 'AZEK' TRIM OR EQ. SEE STRUCT. DRAWINGS FOR HIDDEN - CONNECTIONS, CONTRACTOR TO SUBMIT SHOP DRAWINGS FOR
- | 6 x 12 S4S SMOOTH CLEAR CEDAR BEAM PAINTED (TYP. @ SECOND FLOOR COVERED PORCH CONDITIONS). -SEE REFLECTED CEILING PLAN & SECTION. - ALL CONNECTION TO BE HIDDEN - VERIFY W/ STRUCTURAL DWGS.
- 2-COAT 5/8" SMOOTH STUCCO FINISH, PAINTED TYP. CONT. 12" RAISED SMOOTH STUCCO BASE, "WATER-TABLE"
- TYP. AT PERIMETER OF ENTIRE HOUSE.
- EXTERIOR STUCCO TO EXTEND A MIN. 1'-0" BELOW GRADE (TYP. @ ENTIRE PERIMETER).
- 2" HT. W/ 1 1/2" PROJECTION SMOOTH STUCCO BANDING-

P-3

| 11 |

- TYP. AT BOTT. OF STUCCO "LAPSIDING". 7/8" 3-COAT SMOOTH STUCCO W/ 6" LAP SIDING- FINISH-
- PAINTED (NOTE: SCRATCH COAT APPLIED DIRECTLY TO BLOCK PRIOR TO LAP SIDING PVC TRIM) PVC TO BE AN INTEGRAL COMPONENT TO THE STUCCO SIDING-(TYP.).
- 2" x 4" SMOOTH STUCCO- PAINTED (TYP. @ ALL CORNERS AND WINDOW SURROUNDS AT STUCCO LAPSIDING). I"TH. \times 6"HT. SMOOTH RAISED STUCCO WINDOW HEADER W/ 4" 16. EXTENSION BEYOND WINDOW JAMB, PAINTED (TYP. AT BOTT.
- 2-LAYER DECORATIVE RAISED SMOOTH STUCCO BANDING OVER PORCH OPENINGS, TOP LAYER 2" HT. W/ 1 1/2" PROJECTION OVER LOWER LAYER 2" HT. W/ 1" PROJECTION - PAINTED (TYP. AT GROUND FLOOR). " TH. x 4"HT. RAISED SMOOTH STUCCO WINDOW SILL
- BANDING SLOPED FOR POSITIVE DRAINAGE PAINTED 1"TH \times 4"W SMOOTH RAISED STUCCO WINDOW / DOOR SURROUND W/ 1" \times 1 1/2" TH. RAISED STUCCO BANDING AT

SCALE: 3/16" = 1'-0"

- HEADER PAINTED (TYP. AT SECOND FLOOR LAPSIDING). (2) LAYER STEP SILL BANDING 2" HT. W/ 1 1/2" PROJECTION SMOOTH STUCCO BANDING- (LOWER BAND 4" HT. W/ 3/4" PROJECTION @ STUCCO) - PAINTED (TYP. @ WINDOWS / LAPSIDING) SLOPED FOR POSITIVE DRAINAGE. 1/8" 3-COAT SMOOTH STUCCO W/ 1" x 2" BOARD-N-BATTEN -
- FINISH- PAINTED (NOTE: SCRATCH COAT APPLIED DIRECTLY TO BLOCK PRIOR TO BOARD-N-BATTEN PVC TRIM) - PVC TC BE AN INTEGRAL COMPONENT TO THE STUCCO SIDING-(TYP. AT GABLE END ROOF). P.T. 4" x 6" SMOOTH CLEAR CEDAR FACIA BOARD W/ SHAPED ENDS - PAINTED - TYP. AT ALL GABLES ENDS (PROVIDE #30 FELT BETWEEN 4 x AND CMU - TYP.
- (PROVIDE ALT. PRICE FOR "AZEK" OR EQUAL). (3) LAYERS - 2 x 4 "AZEK" TRIM (OR EQUAL) AT PEDIMENT BASE (LOWER PORTION OF GABLE END). DECORATIVE RECESSED FIXED STUCCO LOUVERED VENT,

FIXED CLOSED POSITION (BACKED BY 6" CMU) W/ SMOOTH

RAISED STUCCO BANDING, OR EQUAL (TYP. AT GABLE ENDS)

ALL "BOSTON HIP" END ROOF CONDITIONS TO RECEIVE ADDITIONAL ANGLED TRUSS BRACING TO MEET WIND CYCLING REQUIREMENTS. - SEE STRUCTURAL DWGS. 26. 3 \times 12 RIDGE RAFTER TAIL- TYP. AT "BOSTON HIP" ROOF. FRONT DOOR TO BE 'SIGNATURE DOOR INC.' STAINED MAHOGANY' (VERIFY W/ BUILDER ON STAIN) - INSTALLED BY "COASTAL SUPPLY" OR EQ. PROVIDE CERTIFICATE OF COMPLIANCE W/ WIND & IMPACT REQ'MNTS. ALL OVERHEAD INSULATED GARAGE DOORS ARE TO MEET 33.

\[\varphi\]

PROPOSED SOUTH AND NORTH ELEVATIONS

- DADE COUNTY WIND CYCLING AND IMPACT TESTING REQUIREMENTS, PROVIDE CERTIFICATE OF COMPLIANCE YPICAL). GARAGE DOOR BY "EDL" OR EQUAL - OFFSET DOORS FOR DECORATIVE "BORAL" APPLIED PANELS OR EQUAL (TO BE SELECTED BY BUILDER - SEE EXTERIOR ELEVATIONS). "PGT" 150 SERIES ALUM. FRENCH DOORS (COLOR WHITE) -W/ GRAY TINT - GLASS TO BE IMPACT RESISTANT AND COMPLY W/ ALL DADE COUNTY IMPACT AND WIND CYCLING TESTING REQUIREMENTS, CONTRACTOR TO
- PROVIDE CERTIFICATE OF COMPLIANCE (TYP.). SEE PGT' CASEMENT & FIXED (SEE MEANS OF EGRESS) ALUM.
 WINDOWS W/ GRAY TINT - GLASS (ALUM. FRAME COLOR - WHITE)
 TO BE IMPACT RESISTANT AND COMPLY W/ALL DADE COUNTY IMPACT AND WIND CYCLING TESTING REQUIREMENTS CONTRACTOR TO PROVIDE CERTIFICATE OF COMPLIANCE (TYP.). - SEE WINDOW SCHEDULE FOR ALL TRANSOM WINDOW
- EGRESS TYPE WINDOW SHALL BE OPERABLE FROM THE INSIDE WITHOUT THE USE OF TOOLS AND PROVIDE A CLEAR OPENING OF NOT LESS THAN 20" W./ 24"HT. AND 5.7 SQ. FT., AREA THE BOTTOM OF THE OPENING SHALL BE NOT MORE THAN 44" FROM THE FINISH FLOOR LEVEL NOR

P-1

- SHALL ANY PART OF THE OPERATING MECHANISM BE PLACED HIGHER THAN 54" FROM THE FIN. FLOOR. ALL WINDOWS TO HAVE 1 x P.T. WD BUCKS ANCHORED TO CONC AS PER PRODUCT APPROVAL. ALL EXTERIOR DOORS & WINDOWS TO HAVE "SIKAFLEX #150" OR EQUAL CAULKING @ BUCK/CMU/ALUM. FRAME
- ALL ALUM. EXT. DOOR THRESHOLDS & WINDOW SILLS TO BE SET IN "SIKAFLEX PRO" OR EQUAL & CONC. THRESHOLD/ ALL DOOR & WINDOW CORNERS, HDR'S. & JAMBS TO BE WRAPPED W/ "SIKA TOP SEAL 101" OR EQ. THEN - APPLY "SIKAFLEX 102 EVERFLASH MEMBRANE" OR EQ. OVER ALL
- WOOD BUCKS W/ A MIN. 8" AT THE INTERIOR SIDE OF ALL OPENINGS AND 12" ON THE FACE OF ALL THE OPENINGS INSTALLED AS PER MANUF. SPEC'S BY "SIKA" OR EQ. -NOTE: CONTRACTOR TO REQUEST "ADHESION TEST" BY SIKA AND OR MANUF.
- DECOR. ALUMINUM WINDOW SHUTTERS W/ ALL CONCEALED CONNECTION AND 2 x SPACERS @ REAR FOR PROTECTION FROM BUILDING W/ E.S.P PAINTED - (BM) "BRANCHPORT
- BROWN *HC-72" FOR SHUTTERS AND "BLACK SHUTTER DOGS" OR EQUAL (COLORS TO BE APPROVED BY BUILDER). ALUMINUM DECORATIVE RAIL W/ E.S.P. POWDER COAT FINISH (COLOR (BM) "BRANCHPORT *HC 72")- TOP OF RAIL MIN. 42" WITH VERTICAL PICKET PATTERN TO BE SPACED TO BLOCK PASSAGE OF 4" SPHERE. (BOTTOM RAIL MAX. 2" A.F.F. - TYP.) - PROVIDE SHOP DRAWINGS FOR STYLE, SIZES AND DESIGN SAFETY / SAMPLE. (NOTE: ALL EXTERIOR
- RAILINGS SHALL COMPLY W/ F.B.C. 2020 EDITION). POURED IN PLACE CONC SLAB. SEE STRUC DWGS (TYP.) ALL COVERED PORCHES TO SLOPE 1/8"/FT.
- CONT | 1/4"HT. x 4" COPPER DRIP EDGE @ ALL BALCONIES. ALL PORCHES TO RECEIVE "STONE PAVERS" MUDSET BY "ARTISTIC PAVERS" OR EQUAL, NON-SLIP W/ SQUARE EDGE AT THE OUTER EDGE. DECK TO BE MUDSET OVER .125" LIQUID

WATERPROOFING ON CONC. DECK, "SIKALASTIC 710/715" OR EQ.

- (REQ. SAMPLE FOR OWNER / INTERIOR DESIGNER APPROVAL). CONTRACTOR TO USE A POLYMER MODIFIED NON EFFLORESCENCE MUDSET OR THINSET GROUT. CONCRETE PRIVACY WALL TO HAVE 2" HT. W/ I" PROJECTION SMOOTH STUCCO BANDING - SEE SITE PLAN.
- SELF-CLOSING, SELF LATCHING LOCKING DECORATIVE ALUMINUM 42. GATE - (MIN. 48" HT.) W/ LATCH LOCATED A MIN. OF 54" HT. ABOVE BOTT, OF GATE, -SEE SITE PLAN AND DOOR SCHEDULE

TOP OF SECOND FLOOR

ELEV. = 12'-0" A.F.F. TOP OF GROUND FLOOR

ELEV. = 10'-0" AFF. TOP OF GROUND FLOOR

ELEV. = 8'-0" A.F.F.

TOP OF GROUND

ELEV. = (+18.75' N.A.V.D.)

ELEV. = LOTS 3 & 5 =-2'-11 4" B.F.F.

FLOOR SLAB ELEV. = 0'-0" A.F.F.

AVERAGE CROWN

OF ROAD LOTS 3 & 5

ELEV. = (+15.81' N.A.V.D.)

STRUCTURE

CEILING

- (NOTE: GATE TO OPEN IN AN OUTWARD DIRECTION). DECORATIVE ALUMINUM FENCE - (MIN. 48" HT.) ALONG FRONT 43. OF DUPLEX - W/ E.S.P. PAINTED - (BM) COLOR - "WHITE" -
- VERIFY STYLE WITH BUILDER SEE SITE PLAN. SEE SITE PLAN FOR PROPOSED LOCATIONS AT PERIMETER 44. OF PROPERTY FOR 48' MIN. HIGH CHAINLINK FENCE W/ BLACK VINYL COATING - VERIFY W/BUILDER ON FENCE COLOR / LOCATION).
- CONTRACTOR TO PROVIDE PRICE FOR ENTIRE STRUCTURE 45. TO RECEIVE 6" HALF ROUND WHITE ALUM. GUTTERS WITH DECORATIVE LEADER CONDUCTOR HEADS - (WITH DECORATIVE GUTTER HANGERS / BRACKETS) - 4" ROUND DOWNSPOUTS - RAINSAVER GUTTER SYSTEM INC. OR EQUAL PROVIDE HOSE BIB SEE DETAIL ON PLUMBING SHT. - HEIGHT AND LOCATIONS TO BE COORDINATED W/ OWNER (NOTE: ALL
- SECOND FLOOR PORCHES TO RECEIVE HOSE BIBS). SEE ELECTRICAL DRAWINGS FOR ALL EXTERIOR LIGHTING FIXTURES 4 SPECS. (NOTE: ALL FIXTURES TO BE
- APPROVED BY BUILDER PRIOR TO PURCHASE). ADDRESS NUMBERS & LOCATION TO BE SELECTED BY OWNER. (NOTE: NUMBERS MUST BE MIN. 4" IN HEIGHT AND ON A CONTRASTING BACKGROUND).



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CONSTRUCTION

PROJECT TITLE

RESIDENTIAL **DUPLEX**

130 SE 1ST AVENUE DELRAY BEACH, FL

REVISIONS

REVISED 5/22/23 AS PER H.P.B. COMMENTS: * ADDED AVERAGE CROWN OF ROAD DIMENSION ADDED ADDED HEIGHT DIMENSIONS FROM AVERAGE CROWN *2 MEAN ROOF HEIGHT DIMENSIONED FROM AVERAGE CROWN OF ROAD. *4 ADDED LOUVERED DETAIL TO GARAGE DOOR PANELS. *5 CHANGED ROOF SLOPE FROM 6 OVER 12 TO 5/12. *6 WINDOWS HAVE BEEN CHANGED FROM LOW - E TO GRAY TINT.

FILE NUMBER 109A300C

DRAWING TITLE

JOB NUMBER

PROPOSED ELEVATIONS LOTS 3 AND 5

DRAWN BY GE/MJ 2.15.23

20230109




10 NE 2ND ST







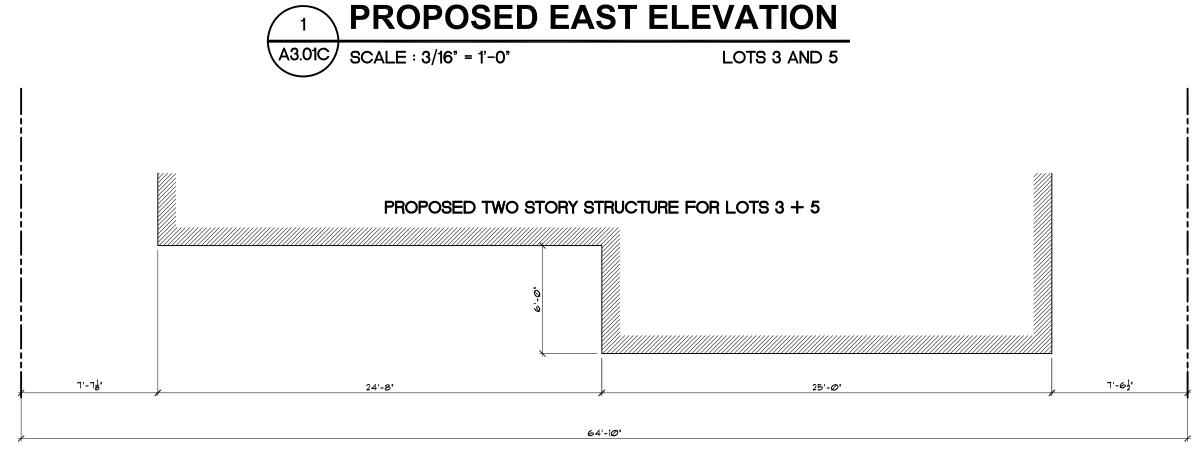

64.833' (LOT WIDTH) x 40% = 25.93' - 15' (SIDE SETBACKS) = 10.93' (24'-8" IS SETBACK AN ADDITIONAL 6'-0"). NOTE: THIS CALCULATION IS NOT REQUIRED FOR LOTS 65'-0" OR LESS.



75 NW 1ST AVE

151 NW 1ST AVE

300 N SWINTON AVE




306 N SWINTON AVE

210 N SWINTON AVE

HISTORIC TWO STORY STRUCTURES WITHIN THE DISTRICT



SUNDY VILLAGE

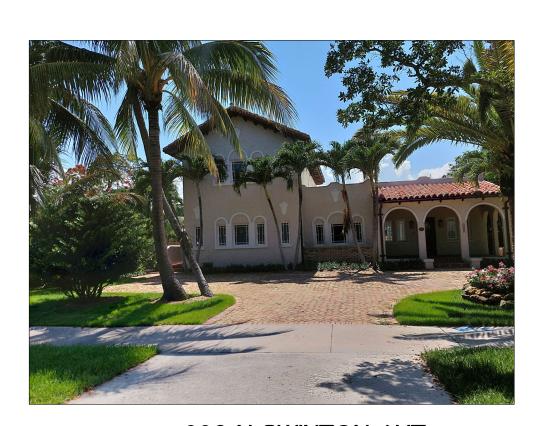

226 N SWINTON AVE



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CONSTRUCTION

PROJECT TITLE

RESIDENTIAL **DUPLEX**

130 SE 1ST AVENUE DELRAY BEACH, FL

REVISIONS

; FILE NUMBER 109A301C

DRAWING TITLE

PROPOSED VISUAL COMPATABILITY

TE DRAWN BY GE/MJ

DRAWING NUMBER

A3.01C


DOOR SCHEDULE


NOTE: ALL WINDOWS, DOORS AND GLAZING PRODUCTS AND INSTALLATION TO BE IN ACCORDANCE WITH DADE COUNTY WIND LOADING & IMPACT CODES. ANY GLAZING BELOW 18" A.F.F. TO BE TEMPERED SAFETY GLASS. NOTE: ALL EXTERIOR ALUMINUM DOORS/SLIDERS TO BE "WINDOOR", "VELOCITY" OR EQUAL. NOTE: ALL HARDWARE FOR PRICING PURPOSES ONLY — TO BE APPROVED AND SELECTED BY OWNER/INTERIOR DOORS TO BE "TRU—STILE" OR EQ.


DOOR LOCATION	TYPE	ELEV. SIZE (W x H x D)	ACTION LABEL	WIND LOAD PRESSURE	THRES.	COMMENTS/HARDWARE
G1 COVERED ENTRY #1	ALUMINUM FRENCH	A (PR.) 2'-8" x 8'-0" x 1 3/4"	LHR & RHR	T.B.D.	ALUM.	PAIR OF 10-LITE "WINDOOR" ALUM. FRENCH DOOR ESTATE SERIES OR EQUAL W/ ALUM. THRESHOLD — "EMTEK" —"HELIOS LEVER W/ SQUARE ROSETTE" — INTERIOR FINISH: CHROME; EXTERIOR FINISH: WHITE AS PER PRODUCT APPROVAL OR EQUAL. — THUMB TURN DEAD BOLT.
G2 COVERED ENTRY #2	ALUMINUM FRENCH	A (PR.) 2'-8" × 8'-0" × 1 3/4"	LHR & RHR SWING	T.B.D.	ALUM.	PAIR OF 10-LITE "WINDOOR" ALUM. FRENCH DOOR ESTATE SERIES OR EQUAL W/ ALUM. THRESHOLD — "EMTEK" —"HELIOS LEVER W/ SQUARE ROSETTE" — INTERIOR FINISH: CHROME; EXTERIOR FINISH: WHITE AS PER PRODUCT APPROVAL OR EQUAL. — THUMB TURN DEAD BOLT.
G3 COVERED TERRACE #1	ALUMINUM FRENCH	A (PR.) 2'-8" x 8'-0" x 1 3/4"	LHR & RHR	T.B.D.	ALUM.	PAIR OF 10-LITE "WINDOOR" ALUM. FRENCH DOOR ESTATE SERIES OR EQUAL W/ ALUM. THRESHOLD — "EMTEK" —"HELIOS LEVER W/ SQUARE ROSETTE" — INTERIOR FINISH: CHROME; EXTERIOR FINISH: WHITE AS PER PRODUCT APPROVAL OR EQUAL. — THUMB TURN DEAD BOLT.
COVERED TERRACE #2	ALUMINUM FRENCH	A (PR.) 2'-8" x 8'-0" x 1 3/4"	LHR & RHR SWING	T.B.D.	ALUM.	PAIR OF 10-LITE "WINDOOR" ALUM. FRENCH DOOR ESTATE SERIES OR EQUAL W/ ALUM. THRESHOLD — "EMTEK" —"HELIOS LEVER W/ SQUARE ROSETTE" — INTERIOR FINISH: CHROME; EXTERIOR FINISH: WHITE AS PER PRODUCT APPROVAL OR EQUAL. — THUMB TURN DEAD BOLT.
G5 COVERED TERRACE #1	ALUMINUM FRENCH	A (PR.) 2'-8" x 8'-0" x 1 3/4"	LHR & RHR	T.B.D.	ALUM.	PAIR OF 10-LITE "WINDOOR" ALUM. FRENCH DOOR ESTATE SERIES OR EQUAL W/ ALUM. THRESHOLD — "EMTEK" —"HELIOS LEVER W/ SQUARE ROSETTE" — INTERIOR FINISH: CHROME; EXTERIOR FINISH: WHITE AS PER PRODUCT APPROVAL OR EQUAL. — THUMB TURN DEAD BOLT.
G6 COVERED TERRACE #2	ALUMINUM FRENCH	A (PR.) 2'-8" x 8'-0" x 1 3/4"	LHR & RHR	T.B.D.	ALUM.	PAIR OF 10-LITE "WINDOOR" ALUM. FRENCH DOOR ESTATE SERIES OR EQUAL W/ ALUM. THRESHOLD — "EMTEK" —"HELIOS LEVER W/ SQUARE ROSETTE" — INTERIOR FINISH: CHROME; EXTERIOR FINISH: WHITE AS PER PRODUCT APPROVAL OR EQUAL. — THUMB TURN DEAD BOLT.
G7 COVERED ENTRY #1	ALUMINUM FRENCH	A (PR.) 2'-8" x 8'-0" x 1 3/4"	LHR & RHR	T.B.D.	ALUM.	PAIR OF 10-LITE "WINDOOR" ALUM. FRENCH DOOR ESTATE SERIES OR EQUAL W/ ALUM. THRESHOLD — "EMTEK" —"HELIOS LEVER W/ SQUARE ROSETTE" — INTERIOR FINISH: CHROME; EXTERIOR FINISH: WHITE AS PER PRODUCT APPROVAL OR EQUAL. — THUMB TURN DEAD BOLT.
G8 COVERED ENTRY #2	ALUMINUM FRENCH	A (PR.) 2'-8" x 8'-0" x 1 3/4"	LHR & RHR	T.B.D.	ALUM.	PAIR OF 10-LITE "WINDOOR" ALUM. FRENCH DOOR ESTATE SERIES OR EQUAL W/ ALUM. THRESHOLD - "EMTEK" -"HELIOS LEVER W/ SQUARE ROSETTE" - INTERIOR FINISH: CHROME; EXTERIOR FINISH: WHITE AS PER PRODUCT APPROVAL OR EQUAL THUMB TURN DEAD BOLT.
G9 2-CAR GARAGE	H.M. PANEL (BY EDL)	C 9'-0" × 9'-0" × 2 1/4"	OVERHEAD —	T.B.D.		4-PANEL-"PINCH PROOF" DESIGN BY "EDL" OR EQUAL- ELECT. OPENER W/LIGHT — HANDLE & KEY LOCK". TO BE PAINTED, SEE EXTERIOR ELEVATIONS FOR COLOR. (CONTRACTOR TO VERIFY PROPER CLEARANCE REQUIRED FOR APPLIED 'BORAL' DECORATIVE PANELS ON EXT. SIDE. TEXTURE : SMOOTH W/ ROUNDED EDGES)
G10 2-CAR GARAGE	H.M. PANEL (BY EDL)	C 9'-0" x 9'-0" x 2 1/4"	OVERHEAD —	T.B.D.		4-PANEL-"PINCH PROOF" DESIGN BY "EDL" OR EQUAL- ELECT. OPENER W/LIGHT - HANDLE & KEY LOCK". TO BE PAINTED, SEE EXTERIOR ELEVATIONS FOR COLOR. (CONTRACTOR TO VERIFY PROPER CLEARANCE REQUIRED FOR APPLIED BORAL DECORATIVE PANELS ON EXT. SIDE. TEXTURE: SMOOTH W/ ROUNDED EDGES)
G11 2-CAR GARAGE	H.M. PANEL (BY EDL)	C 9'-0" x 9'-0" x 2 1/4"	OVERHEAD —	T.B.D.		4-PANEL-"PINCH PROOF" DESIGN BY "EDL" OR EQUAL- ELECT. OPENER W/LIGHT - HANDLE & KEY LOCK". TO BE PAINTED, SEE EXTERIOR ELEVATIONS FOR COLOR. (CONTRACTOR TO VERIFY PROPER CLEARANCE REQUIRED FOR APPLIED BORAL DECORATIVE PANELS ON EXT. SIDE. TEXTURE: SMOOTH W/ ROUNDED EDGES)
G12 2-CAR GARAGE	H.M. PANEL (BY EDL)	C 9'-0" x 9'-0" x 2 1/4"	OVERHEAD —	T.B.D.		4-PANEL-"PINCH PROOF" DESIGN BY "EDL" OR EQUAL- ELECT. OPENER W/LIGHT - HANDLE & KEY LOCK". TO BE PAINTED, SEE EXTERIOR ELEVATIONS FOR COLOR. (CONTRACTOR TO VERIFY PROPER CLEARANCE REQUIRED FOR APPLIED BORAL DECORATIVE PANELS ON EXT. SIDE. TEXTURE: SMOOTH W/ ROUNDED EDGES)

S1	COVERED PORCH #1	ALUMINUM FRENCH	В 2	2'-8" × 8'-0" × 1 3/4"	RHR SWING -	T.B.D.	ALUM. 10-LITE "WINDOOR" ALUM. FRENCH DOOR ESTATE SERIES OR EQUAL W/ ALUM. THRESHOLD — "EMTEK" —"HELIOS LEVER W/ SQUARE ROSETTE" — INTERIOR FINISH: CHROME; EXTERIOR FINISH: WHITE AS PER PROD APPROVAL OR EQUAL. — THUMB TURN DEAD BOLT.
S2	COVERED PORCH #2	ALUMINUM FRENCH	В 2	2'-8" x 8'-0" x 1 3/4"	LHR SWING	T.B.D.	ALUM. 10-LITE "WINDOOR" ALUM. FRENCH DOOR ESTATE SERIES OR EQUAL W/ ALUM. THRESHOLD — "EMTEK" —"HELIOS LEVER W/ SQUARE ROSETTE" — INTERIOR FINISH: CHROME; EXTERIOR FINISH: WHITE AS PER PROD APPROVAL OR EQUAL. — THUMB TURN DEAD BOLT.
r S3	COVERED PORCH #2	ALUMINUM FRENCH	В 2	2'-8" x 8'-0" x 1 3/4"	RHR SWING	T.B.D.	ALUM. 10-LITE "WINDOOR" ALUM. FRENCH DOOR ESTATE SERIES OR EQUAL W/ ALUM. THRESHOLD - "EMTEK" -"HELIOS LEVER W/ SQUARE ROSETTE" - INTERIOR FINISH: CHROME; EXTERIOR FINISH: WHITE AS PER PROD APPROVAL OR EQUAL THUMB TURN DEAD BOLT.
O S4	COVERED PORCH #1	ALUMINUM FRENCH	В 2	2'-8" x 8'-0" x 1 3/4"	LHR SWING	T.B.D.	ALUM. 10-LITE "WINDOOR" ALUM. FRENCH DOOR ESTATE SERIES OR EQUAL W/ ALUM. THRESHOLD — "EMTEK" —"HELIOS LEVER W/ SQUARE ROSETTE" — INTERIOR FINISH: CHROME; EXTERIOR FINISH: WHITE AS PER PROD APPROVAL OR EQUAL. — THUMB TURN DEAD BOLT.
ON S5	TRELLIS TERRACE #1	ALUMINUM FRENCH	Α ((PR.) 2'-8" x 8'-0" x 1 3/4"	LHR & RHR	T.B.D.	ALUM. PAIR OF 10-LITE "WINDOOR" ALUM. FRENCH DOOR ESTATE SERIES OR EQUAL W/ ALUM. THRESHOLD - "EMTEK" -"HELIOS LEVER W/ SQUARE ROSETTE" - INTERIOR FINISH: CHROME; EXTERIOR FINISH: WHITE AS FOR PRODUCT APPROVAL OR EQUAL THUMB TURN DEAD BOLT.
S6	TRELLIS TERRACE #2	ALUMINUM FRENCH	Α ((PR.) 2'-8" x 8'-0" x 1 3/4"	LHR & RHR	T.B.D.	ALUM. PAIR OF 10-LITE "WINDOOR" ALUM. FRENCH DOOR ESTATE SERIES OR EQUAL W/ ALUM. THRESHOLD — "EMTEK" —"HELIOS LEVER W/ SQUARE ROSETTE" — INTERIOR FINISH: CHROME; EXTERIOR FINISH: WHITE AS F PRODUCT APPROVAL OR EQUAL. — THUMB TURN DEAD BOLT.
S7	TRELLIS TERRACE #1	ALUMINUM FRENCH	Α ((PR.) 2'-8" x 8'-0" x 1 3/4"	LHR & RHR	T.B.D.	ALUM. PAIR OF 10-LITE "WINDOOR" ALUM. FRENCH DOOR ESTATE SERIES OR EQUAL W/ ALUM. THRESHOLD — "EMTEK" —"HELIOS LEVER W/ SQUARE ROSETTE" — INTERIOR FINISH: CHROME; EXTERIOR FINISH: WHITE AS FOR PRODUCT APPROVAL OR EQUAL. — THUMB TURN DEAD BOLT.
S8	TRELLIS TERRACE #2	ALUMINUM FRENCH	Α ((PR.) 2'-8" x 8'-0" x 1 3/4"	LHR & RHR	T.B.D.	ALUM. PAIR OF 10-LITE "WINDOOR" ALUM. FRENCH DOOR ESTATE SERIES OR EQUAL W/ ALUM. THRESHOLD — "EMTEK" —"HELIOS LEVER W/ SQUARE ROSETTE" — INTERIOR FINISH: CHROME; EXTERIOR FINISH: WHITE AS F PRODUCT APPROVAL OR EQUAL. — THUMB TURN DEAD BOLT.

DOOR ELEVATIONS

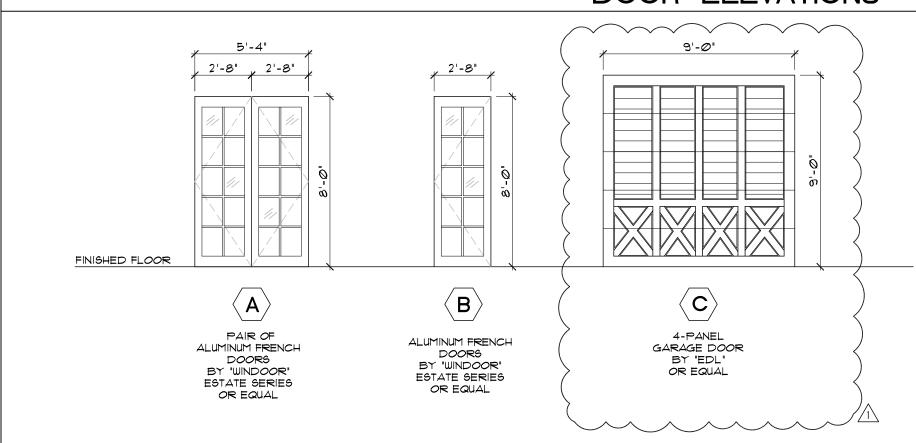

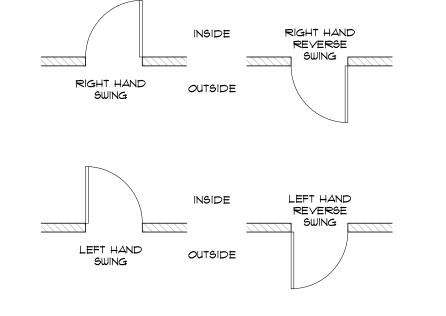

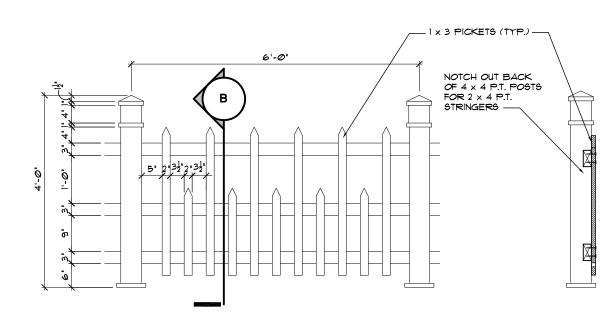





WINDOW SCHEDULE

ALL WINDOWS TO BE "WINDOOR ESTATE" SERIES W/ WHITE FINISH OR EQUAL (CONTRACTOR TO PROVIDE SHOP DRAWINGS FOR APPROVAL).

WINDOW	SIZE (WxH)	QTY.	SERIES	WALL TYPE	FRAME	SILL	\ \ \ \ \ \	FRAME COLOR	COMMENT
А	(PR.) 2'-8" x 5'-0"	2	238	MASONRY	ALUM./PTD	WD/PTD	GRAY TINT	WHITE	PAIR OF "WINDOOR" ESTATE SERIES CASEMENT W/ 6 LITE
В	2'-6" x 5'-0"	4	238	MASONRY	ALUM./PTD		V / L/AIVI		
С	2'-4" × 5'-0"	8	238	MASONRY	ALUM./PTD	WD/PTD	GRAY TINT	WHITE	"WINDOOR" ESTATE SERIES CASEMENT W/ 6-LITE
D	(PR.) 2'-4" x 5'-0"	2	238		ALUM./PTD		/ LAW	1	PAIR OF "WINDOOR" ESTATE SERIES CASEMENT W/ 6 LITE
E	2'-0" × 2'-2"	12	238	MASONRY	ALUM./PTD	1	II / LAW	3	
F	2'-6" x 5'-0"	4	238	MASONRY	ALUM./PTD	WD/PTD	GRAY TINT /LAM	WHITE	"WINDOOR" ESTATE SERIES FIXED W/ 6-LITE

EXTERIOR WINDOW ELEVATIONS

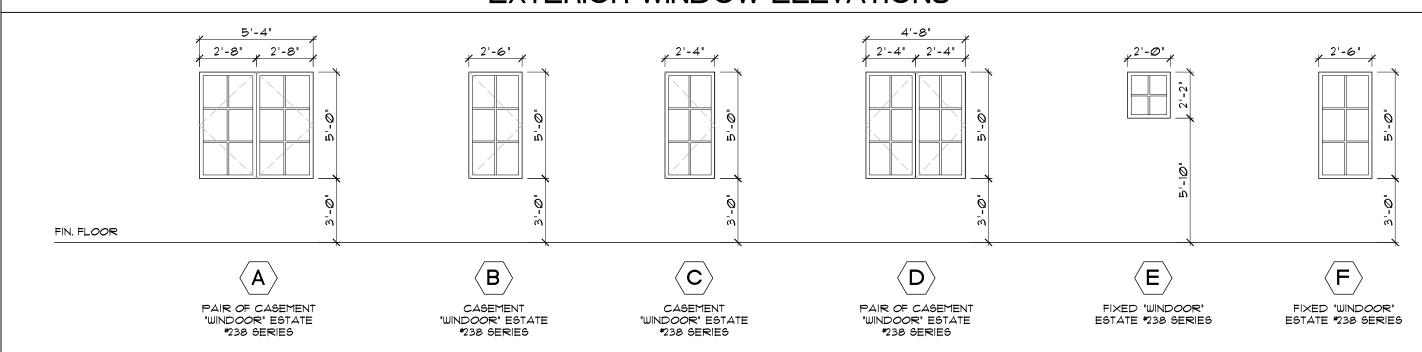

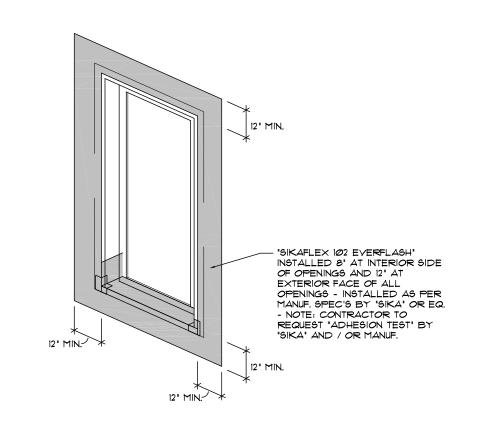

NOTE: VERIFY ALL INTERIOR DOORS & INTERIOR WINDOW TRIMS/CASING/TREATMENTS W/ OWNER / DESIGNER

NOTE:
WATER TEST TO BE CONDUCTED AT RANDOMLY SELECTED EXTERIOR WINDOW AND DOOR ASSEMBLIES AT INITIAL CONSTRUCTION PHASE TO CONFIRM WATER INFILTRATION ISSUES, IF WINDOWS OR DOORS FAIL, CONTRACTOR WILL BE RESPONSIBLE FOR COST OF TESTS & CORRECTIONS TO DOORS & WINDOWS.

- ALL WINDOWS, DOORS AND GLAZING PRODUCTS AND INSTALLATION TO BE IN ACCORDANCE WITH DADE COUNTY IMPACT AND WIND LOADING CODES. (WINDOOR OR EQUAL)

- ALL GLAZING BELOW IS' AFF. TO BE TEMPERED SAFETY GLASS.-CONTRACTOR TO PROVIDE DATED CURRENT APPROVAL DOCUMENTATION/CERTIFICATION.

- VERIFY ALL WINDOWS WITH PROPOSED FLOOR PLAN FOR WINDOW TYPES.

- ALL W/ WHITE E.S.P. PAINT FINISH OR EQUAL - VERIFY W/ OWNER / DESIGNER.

- VERIFY W/ OWNERMEP'S IF GLASS IS LOW 'E'.



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CONSTRUCTION

PROJECT TITLE

RESIDENTIAL DUPLEX LOT 1

130 SE 1ST AVENUE DELRAY BEACH, FL

REVISIONS

REVISED 5/22/23 AS PER H.P.B.
COMMENTS:

*I WINDOWS HAVE BEEN CHANGED
FROM LOW - E TO GRAY TINT.

*2 GARAGE DOORS HAVE BEEN
UPDATED TO SHOW ADDITIONAL
ARCHITECTURAL DETAIL.

FILE NUMBER **20230109A**

DRAWING TITLE

PROPOSED DOOR & WINDOW SCHEDULE

DATE DRAWN BY GE/BM

20230109

A9.00A