

PLAN	T LIST											
TREES	AND PALMS											
KEY	QTY. TOTAL	BOTANICAL/COMMON NAME	HEIGHT	SPREAD	CAL. INCHES	CLEAR TRK.	CONDITION/NOTE	REMARKS	NATIVE	DROUGHT TOLERANCE		
TREES		1			ļ			1	_			
CG	4	Caesalpinia granadillo Bridal Veil	14-16'	8-9'	4"	6-7'		Full Canopy		MODERATE		
PE	2	Ptychosperma macarthurii 'double' Double Alexander Palm	16-18' O.A.					double trunk Full Heads		MODERATE		
RE1	1	Roystonea regia Royal Palm		Relocated from site, #1 (See tree disposition plan)								
SHRUE	S & GOUND C	OVERS										
KEY	QTY. TOTAL	BOTANICAL/COMMON NAME	HEIGHT	SPREAD		CLEAR TRK.	SPA.	REMARKS	NATIVE	DROUGHT TOLERANCE		
FIC	12	Ficus microcarpa 'Green Island' Grren Island Ficus	16"	16"			18" o.c.	Full cont. 7 Gal.		HIGH		
LIR	44	Liriope m.'Evergreen Giant' Giant Lilyturf	10-12"	10-12"			12" o.c.	Full cont.		HIGH		
PHX	16	Philodendron 'Xanadu' Dwarf Philodendron	24"	16"			18" o.c.	Full clump 7 gal. cont.		MODERATE		
POD	4	Podocarpus macrophyllus 'Hedge' Japanese Yew Column	6'	24"			24" o.c.	Full cont. 25 Gal.		MODERATE		
SCH		Schefflera arboricola Schefflera	18"	18"			18" o.c.	Full cont.		HIGH		
TRA	21	Trachelospermum jasminoides Confederate Jasmine	6-7'					Trellis Grown, 15 gal. cont.		MODERATE		
TRI1	90	Tripsacum dactyloides 'Dwarf' Dwarf Fakahatchee Grass	24"	18"			18" o.c.	Full clump	Х	HIGH		

MISCELLANEOUS

- Sod to be St. Augustine sod.

- Planting soil –1/2 cu. yd. per tree and 4" depth at all hedges and mass planting beds.

- Sand - Palms to be planted in clean sand; ½ cu. yd. per palm.

- Mulch – 3" depth of shredded "dark brown" hybrid mulch B grade or better at all hedges and mass planting beds. GENERAL NOTES

- PER LDR SEC. 4.4.13(E)(2)(B)(5)
- The property owner shall be required to enter into a maintenance agreement, in a form acceptable to the City Attorney, requiring the property
- All trees or palms intalled in nodes within a right-of-way shall maintain a four foot offset from the face of the curb. All shrubs and ground
- All sod to be Stenotaphrum secundatum 'Flor-tam', St. Augustine solid sod.
- Any pervious area to remain that is disturbed by construction and not indicated on landscape plans to have shrubs or groundcovers shall be sodded. - All plant materials shall conform to the standards for Florida No. 1 or better as given in "Grades and Standards for
- Nursery Plants", State of Florida Department of Agriculture, Tallahassee, or thereto. Refer to the latest edition - All trees shall be properly guyed and staked at the time of planting to ensure proper establishment.
- The planting soil for all planting areas shall be composed of a minimum of 30% muck or horticulturally acceptable organic material. The minimum soil depth shall be four inches in all hedges and mass planting beds and ½ cu. yd. per tree. Palms to be planted in clean sand.
- Three inches minimum of shredded "dark brown" hybrid mulch shall be installed around each tree and palm and throughout mass planting beds, the use of Cypress mulch is strongly discourage.
- Irrigation system to provide 100% coverage to landscaped areas with 50% overlap. Irrigation to be an automatic system with a rain gauge/moisture sensor shut-off.
- For trees designated for preservation, protective barriers shall be in place prior to the start of any construction and shall remain in place until development is completed and the Planning and Zoning Division has authorized their removal.
- The relocation of any tree and necessary tree prunning must conform to ANSI A-300 Standards.
- In case of discrepancies, planting plan takes precedence over plant list.
- Landscape contractor is responsible for his own quantity take-offs.

(SABAL & WASHINGTONIA PALMS) -REMOVE 1/2 OF LOWER FRONDS, TIE REMAINING FRONDS TO PROTECT BUD. (SABAL PALMS) DEAD 'BOOTS' MAY REMAIN 1-2' BELOW LIVE FRONDS. CROWNSHAFT ON SOME SPECIES (WASHINGTONIA PALMS) 'BEARD' TO REMAIN WHERE POSSIBLE. -WRAP TRUNK WITH BURLAP DOUBLE BAND 3 MIN - 2"X4" WOOD BATTENS TO WRAPPED TRUNK -2"X4"X8' WOOD STAKES - 3 MIN PER TREE -3" LAYER OF MULCH AS SPECIFIED

3" HIGH WATERING SAUCER (REMOVE \$ REPLACE W/ SOD WHEN ESTABLISHED.

-2"X4" WOOD STAKES

-FINISH GRADE

SAND BACKFILL & FERTILIZER AS SPECIFIED

ALL SHRUBS/GROUNDCOVERS TO BE TRIANGULAR SPACING. SEE PLANT LIST FOR (O.C.) SPACING

18" MIN. SETBACK FOR SHRUBS

12" MIN. SETBACK FOR GROUNDCOVERS CURB/EDGE OF PAVEMENT/BED LINE

NOTE: THE PERIMETER OF ALL CURVED PLANTING BEDS SHALL BE PLANTED WITH A ROW OF SHRUBS AS SHOWN IN THE PLANS AND AT THE SPACING SHOWN IN THE PLANT LIST. INTERIOR PORTIONS OF EACH BED SHALL BE PLANTED AT APPROPRIATE SPACING ACCORDING TO THIS PLANT SPACING DETAIL.

3" LAYER OF MULCH AS SPECIFIED -FINISH GRADE

PLANTING SOIL BACKFILL & FERTILIZER AS SPECIFIED COMPACT SOIL TO PREVENT SETTLEMENT

PROJECT	OWNER	_	REVISIONS		PROJECT STATUS
OCEAN CITY LUMBER PROPERTY	Investments Limited	No.		Date 09-2025	LEVEL 1 - SITE PLAN FILE No. 2025-057
SUITE 100					12-20-2024
220 NE 1ST STREET, DELRAY BEACH, FL 33444	DELRAY TRIO, LLC 347 FIFTH AVENUE, SUITE 300 NEW YORK, NY 10016				PROJECT NUMBER
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DRAWING NUMBER

LP-2

DRAWING TITLE

PLANT LIST, NOTES & DETAILS

SCALE AS SHOWN DRAWN BY CHECKED BY M.I JR

6

2. Plant Materials & Protection:

- A. All plant materials shall be nursery grown unless otherwise noted.
- <u>Spread (or Spr.)</u>: Indicates average spread to midpoint of current season's growth. - Height (or O.A.): Indicates overall height from top of ball to midpoint of current seasōn's growth.

- C.T.: Indicates clear trunk measurement from top of ball to first branching (see tree \$ Palm Planting Diagrams) - Meter of Wood (or Meter of Hard Grey Wood): Indicates measurement of Palms from top of ball to top of solid trunk before start of frond stalks or green "boots". (See Palm Planting Diagram)

В. <u>Quantities:</u>

All quantities indicated on the plant list are intended as a quide for the bidders and does not relieve the bidder of his responsibility to do a comprehensive plant take off. Should a discrepancy occur between the bidder's take off and the plant list quantity, the Architect/Landscape Architect is to be notified for clarification prior to the submission of bids.

C. Quality and Sizes:

Plants shall have a habit of growth that is normal for the species and shall be healthy, vigorous and equal or exceed the measurements specified in the plant list, which are the minimum acceptable sizes. Plants shall be measured with branches in normal position. Pruning (Section IV.J.) should not reduce acceptable size and shape of tree, and should be done after acceptance of Architect/Landscape Architect. Requirements for measurements, branching, grading, quality, balling and burlapping of plants in the plant list generally follow the code of standards currently recommended by the American Association of Nurserymen, Inc., in the American Standard for Nursery Stock. Plant materials shall be graded Fancy No.1 or better as outlined under U.A.E. Grades & Standards for nursery plants. Plants that meet the requirements specified, but do not have the normal balance of height and spread typical for the respective plant, shall not be accepted. All plant material to be healthy, pest and disease free.

D. <u>Substitution:</u>

Plant substitution requests by the Contractor will be considered by the Architect/Landscape Architect only upon submission of proof that any plant is not obtainable in the type or size specified. The Landscape Architect shall determine the nearest equivalent replacement in an obtainable size and variety. The unit price of the substitute item shall not exceed the bid item replaced, without approval of the Owner.

E. <u>Protection of Plants:</u>

I. Root Protection

A. Balled and Burlapped Plants (B & B) shall be dug with natural balls of earth of sufficient diameter and depth to encompass the fibrous and feeding root system necessary for full recovery of the plant. Balls shall be firmly wrapped with burlap or similar materials and bound with twine, cord, or wire mesh. All collected plants shall be balled and burlapped.

B. Container Grown Plants: Plants grown in containers will be accepted as B & B, providing that all other specified requirements are met. Container grown plants shall meet plant sizes as specified on the plant list and on the plans, and shall not be governed by container sizes. Minimum root balls or container grown material shall be no more than 25% less proportionately in size than that stated in "Grades \$ Standards" for nursery plants. These plants shall have been arown in the container for a maximum of two years prior to installation and shall exhibit a fully developed root system when removed from the container.

2. Protection During Transporting:

All plant material shall be protected from possible bark injury or breakage of branches. All plants transported by open trucks shall be adequately covered to prevent windburn, drying or damage to plants.

3. Protection After Delivery:

Plants which cannot be planted immediately upon delivery to the site shall be covered with moist soil, mulch, or other protection from the drying of wind and sun. All plants shall be watered as necessary until accepted. Storage period shall not exceed seventy-two (72) hours.

4. Protection of Palms:

Only a minimum of fronds shall be removed from the crown of the palm trees to facilitate moving and handling. Clear trunk (C.T.) shall be as specified after the minimum of fronds have been removed. Coconut palms shall be "hard" trees grown in marl or sand. Cabbage palm buds shall be tied with a biodegradable cord to be left in place until the tree is well established in its new location. All palms shall be triple braced and staked with new, clean lumber at least 6" in length to resist tree displacement.

5. Protection During Planting:


Trees moved by winch or crane shall be thoroughly protected from chain marks, girdling or bark slippage by means of other approved methods

3. <u>Materials</u>:

• Commercial Fertilizer: Commercial fertilizer shall be organic fertilizer containing nitrogen, phosphoric acid and potash in equal percentages, 6-6-6 with micro nutrients.

- Nitrogen shall be not less than 50 % from organic source. Inorganic chemical nitrogen shall not be derived from the sodium form of nitrate. Fertilizers shall be delivered to the site in unopened original containers, each bearing the manufacturer's guaranteed analysis. Any fertilizer that becomes caked or otherwise damaged shall not be acceptable.
- The following shall be sterilized, certified and free of seed:
- Peat: Peat shall be horticultural peat composed of not less than 60% decomposed organic matter by weight, on an oven dried basin. Peat shall be delivered to the site in a workable condition, free from lumps.
- Planting Soil: Planting soil for all plantings shall be sandy loam and shall contain a 25% minimum amount of decomposed organic matter. There must be a slight acid reaction to the soil with no excess of calcium carbonate. Planting soil shall be free from clay, stones, plants, roots, and other foreign materials which might be a hindrance to planting operations or be detrimental to good plant growth and shall be delivered in a loose friable condition and applied in accordance with the planting specifications and details.

- raised planters.
- 4. Planting Operations:
- A. Soil Preparation:
- <u>Layout:</u>
- C. <u>Excavation for Planting</u>:
- D. Balled and Burlapped Plants:
- E. Container Grown Plants:
- F. Pit Sizes:
- G. <u>Backfilling</u>:
- H. <u>Setting Trees and Shrubs:</u> plant pit.
- Setting Palms: manner.
- Pruning New Plant Material:
- K. Guying Tree:
- <u>Mulching:</u>
- M. Excess Excavated Soil: expense to the Owner, at Owner's discretion.
- N. <u>Relocated Material (when applicable):</u>
- O. Disposition of Existing Material:

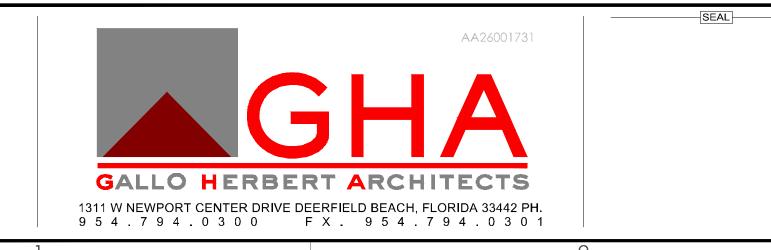

• Drainage Stone (when applicable): Drainage stone shall be gravel or crushed stone reasonably free of sharp edges - $\frac{1}{2}$ "-1 $\frac{1}{2}$ " in diameter - as required in the bottom of

• Filter Fabric: (when applicable): Filter fabric, as required between gravel and soil in planters to be Dewitt "Filter-fabric" (800)888-9669 or equal.

All existing soil and new fill/berms shall be treated with an approved weed killer such as "Round Up" according to manufacturer's specifications.

Location for plants and outlines of areas to be planted are indicated on the drawinas. All plant locations shall be staked in the field by the Contractor, to the satisfaction of the Architect/Landscape Architect. Where construction or utilities below ground or overhead are encountered or where changes have been made in the construction, necessary adjustments will be approved by the Architect/ Landscape Architect.

Excavation of holes shall extend to the required sub-grades as specified hereunder. Plant pits shall be circular in outline and shall have a profile which conforms to the "Typical Tree & Palm Planting Details" (attached). The minimum depth of plant pits specified below shall be measured from the finishing grade. Shrub planting beds shall be "bed-prepared" and not "pit-prepared".

After final setting, loosen wrappings of balled and burlapped plants and roll wrappings back from top of ball, leaving ball unbroken. Cut off excessive amounts of burlap and remove in sufficient quantity to eliminate creation of voids upon decomposition.

Container grown plants shall, when delivered, have sufficient root growth to hold earth intact when removed from container. They shall not be root bound. Containers shall be removed to prevent damage to plant or root system according to diagrams (attached). Plant pits for container materials shall be formed flat on the bottom to avoid air pockets at the bottom of root balls.

Minimum diameter (Width) and depth of planting pits for balled and burlapped, and container grown plants shall be as follows:

-Diameter-Trees: 18" greater than diameter of ball or spread of roots. -Diameter-Shrubs: 6" greater than diameter of ball or spread of roots.

-Depth-Trees and Shrubs: 4" greater than depth of ball or roots to provide 4" of topsoil backfill under the root ball. (Large, heavy trees and shrubs shall sit directly on excavated pit bottom to prevent settlement)

-Depth-Vines and Ground Covers: Pits shall be large enough for adequate planting.

When pit has been excavated as specified in Paragraph IV-C, the pit shall be backfilled with material as specified in Paragraph III. A, B, C, D, and IV. B and shown in the Typical Tree and Shrub diagrams (attached).

Unless otherwise specified, all trees and shrubs shall be planted in pits, centered and set on four inches (4") of compacted topsoil to such depths that the finished arade level of the plant after settlement shall be the same as that at which the plant was arown. They shall be planted upriaht and faced to give the best appearance or relationship to adjacent structures. No burlap shall be pulled out from under the balls. Platforms, wire and surplus binding from top and sides of the balls shall be removed All broken or frayed roots shall be cut off cleanly. Soil shall be placed and compacted thoroughly avoiding injury and shall be settled by watering. No filling around trunks will be permitted. After the ground settles, additional soil shall be filled in, to the level of the finished grade, allowing for two inches (2") of mulch. Form a shallow saucer around each plant by placing a ridge of soil along the edge of the

All palms shall be planted in sand, thoroughly washed in during planting operations and with a shallow saucer depression left at the soil line forfuture waterings. Saucer areas shall be top-dressed two inches (2") deep with topsoil raked and left in a neat, clean

Remove dead and broken branches from all plant material. Prune to retain typical growth habit of individual plants with as much height and spread as is practicable. Make all cuts with sharp instrument flush with trunk or adjacent branch, in such a manner as to insure elimination of stubs."Headback" cuts at right angles to line of growth will not be permitted. Trees shall not be poled or topped. Remove trimmings from site.

(See "Typical Tree Planting Diagram" included herein.) Guy all trees 11/2 inches in caliper and greater, in three directions with two strands of No. 12 galvanized wire attached to approved anchors driven below grade. When securing wires to trees, cover all wires which may come in contact with any part of tree with new rubber hose. Place quys not less than 1/3 of the height of tree above finished grade and above substantial limbs (one inch [1"] in diameter or more), if possible. All hoses shall be interlocked around tree trunk. Place anchors so that guys are equally spaced and at 45 degree angles to horizon. Keep guys tight until project completion.

All trees and shrub beds shall be mulched immediately after planting to a three inch (3") depth. Prevent wind displacement of mulch by thoroughly wetting down.

Excess excavated soil shall be disposed of by the Contractor at no additional

Existing material shown on the plan to be relocated shall be root-pruned as far ahead of time as necessary to move them safely, and shall be protected and treated as new material, as previously specified. Planting shall be in accord with these specifications.

All existing plant material not shown as remaining or relocated shall be removed from the site at no additional cost to the Owner, at Owner's discretion.

<u>5. Sod</u>

A. <u>Soil:</u>

The Landscape Contractor shall submit a unit price per cubic yard for the supply and distribution of planting soil as herein before specified, to be applied at a depth of one inch (1"), to all areas receiving sod. (The use of this one inch (1") of soil shall be at the discretion of the Architect/Landscape Architect after evaluation of the existing soil on the site.)

В. <u>Grades:</u>

It shall be the responsibility of the Landscape Contractor to finish (fine) grade all landscape areas, eliminating all bumps, depressions, sticks, stones and other debris to the satisfaction of the Architect/Landscape Architect

- C. The sod shall be as called for on the landscape plans. Sod shall be of firm tough texture, having a compact growth of grass with good root development, and shall contain no weeds or any other objectionable vegetation. The soil embedded in the sod shall be good earth, free from stones and debris and all sod shall be free from fungus, vermin and other diseases.
- D. Before being cut and lifted, the sod shall have been mowed at least three times with a lawn mower, with the final mowing not more than seven days before the sod is cut. The sod shall be carefully cut into uniform dimensions.
- E. Solid sod shall be laid with closely abutting joints with a tamped or rolled, even surface. It shall be the responsibility of the Contractor to bring the sod edge in a neat, clean manner to the edge of all paving and shrub areas. If, in the opinion of the Architect/Landscape Architect, top-dressing is necessary after rolling, clean sand will be evenly applied over the entire surface and thoroughly washed in.

<u>6. Clean-up:</u>

Any soil, peat or similar material which has been brought onto any paved areas shall be removed promptly keeping these areas clean as the work progresses Upon completion of the planting, all excess soil, stones and debris which has not been previously cleaned up shall be removed from the site or disposed of as directed by the Architect/Landscape Architect.

7. <u>Maintenance</u>:

- A. Maintenance shall begin immediately after each plant is planted and shall continue until all planting has passed final inspection and acceptance by the Owner. Maintenance shall include watering, weeding, cultivating, removal of dead materials, resetting plants to proper grades or upright position and restoration of the planting saucer and any other necessary operations. Proper protection to lawn areas and existing plant materials shall be provided and any damage resulting from planting operations shall be repaired promptly.
- B. The Contractor shall deep-water all trees and shrubs for a period of ninety (90) days after planting. In the event an irrigation system is operable, Contractor shall see that adequate water is supplied for that period.

8. Inspection and Acceptance:

- A. Inspection: Inspection of work to determine completion of contract, exclusive of the possible replacement of plants, will be made by the Owner and/or Landscape Architect at the conclusion of all planting and at the written request of the Contractor.
- B. <u>Acceptance:</u> After inspection, the Contractor will be notified by the Owner of the acceptance of all plant material and workmanship, exclusive of the possible replacement of plants subject to guarantee.

9. Guarantee and Replacement:

A. <u>Guarantee:</u>

The Contractor shall furnish a written guarantee warranting all materials, workmanship and plant materials, for a period specified in the General Conditions of Project Specifications. All plant materials shall be alive and in satisfactory condition and growth for each specific kind of plant at the end of guarantee period. Where vandalism is agreed by the Architect/Landscape Architect as the cause for replacement, the Contractor shall not be responsible for replacement during the quarantee after final acceptance. See General Conditions of Project Specifications for additional quarantee information.

B. <u>Replacement:</u>

During guarantee period, any plant required under this contract that is dead or not in satisfactory condition, as determined by the Architect/Landscape Architect, shall be replaced within two weeks of notification by the Architect/Landscape Architect. The Contractor shall be responsible for the full replacement cost of plant materials.

C. <u>Material and Operations:</u>

All replacements shall be plants of the same kind and size as specified in the plant list. They shall be furnished and planted as specified herein.

10. Care and Maintenance Schedule:

A. The Contractor shall furnish the Owner's Maintenance staff with a written and detailed description for the care and maintenance of all plant materials and irrigation systems at the time of final inspection. Contractor will also provide a one year Landscape Maintenance Contract, to take affect affect after Substantial Completion of the project. It will be in the Owner's discretion to accept or reject this contract.

II. Permits and Regulations:

A. The Contractor shall give all notices and comply with all laws, ordinances, rules and regulations bearing on the conduct of this work as drawn and specified.

12. Protection of Work and Property:

A. The Contractor shall continuously maintain adequate protection of all his work from damage and theft and shall protect the Öwner's property from injury and loss arising in connection with this contract, making good any such loss or injury or damage except where caused by Owner or his agents. He shall adequately provide and maintain passageways, guard fences, lights and other protections required by public authority according to State, Federal and local ordinances.

PROJECT	OWNER	_	REVISIONS		PROJEC
		No.	Description	Date	
	Investments		TAC COMMENTS - LEVEL 1	04-09-2025	LEVEL 1 -
					FILE No
OCEAN CITY LUMBER PROPERTY	Limited				C
SUITE 100					12-20
	DELRAY TRIO, LLC				
	347 FIFTH AVENUE, SUITE 300				PROJEC
220 NE 1ST STREET, DELRAY BEACH, FL 33444	NEW YORK, NY 10016				98

CT STATUS

SITE PLAN . 2025-057 DATE

0 - 2024

CT NUMBER

822

B. The Contractor shall provide protection for existing trees and other plant material as designated by drawings, by Owner's representative or by local authorities. Such protection shall consist of fencing or such devices as will prevent harm to material from excavation, breakage, chemical or other types of damage.

C. A competent superintendent, foreman or workman capable of reading drawings and acting on behalf of the Contractor shall be kept on the work during its progress.

13. Changes In The Work:

- A. The Contractor shall conduct a soil survey of the site to determine the need for any additives to overcome severe conditions not met by normal planting soil requirements. A report of any problems shall be submitted to the Owner and the Architect/Landscape Architect for approval prior to installation, along with a cost break-down of additional services needed.
- B. The Contractor shall advise the Owner and Landscape Architect of any special site conditions (high water table, light or soil conditions, etc.) that might require change of plant material or adjustment to finish elevation shown. The Owner will approve any changes thus determined.

14. Landscape Architect:

A. The Landscape Architect is the author of the design and agents for its execution. When his services are used by the Owner for supervision, he shall act impartially between the Owner and Contractor and shall have authority to reject all work and materials which do not conform to the contract. All decisions of the Landscape Architect shall be final.

The Contractor shall remove from the site all materials considered not up to specifications by the Landscape Architect and replace with suitable materials.

15. Obstructions:

A. The Contractor shall acquaint himself with the existence and location of all surface and subsurface structures, utilities and installations before commencing any work, and shall avoid any disturbance or damage to them throughout the course of the work. Repairs to any utilities, subsurface structures and installations and surface obstructions damaged by the Contractor shall be at the Contractor's own time and expense.

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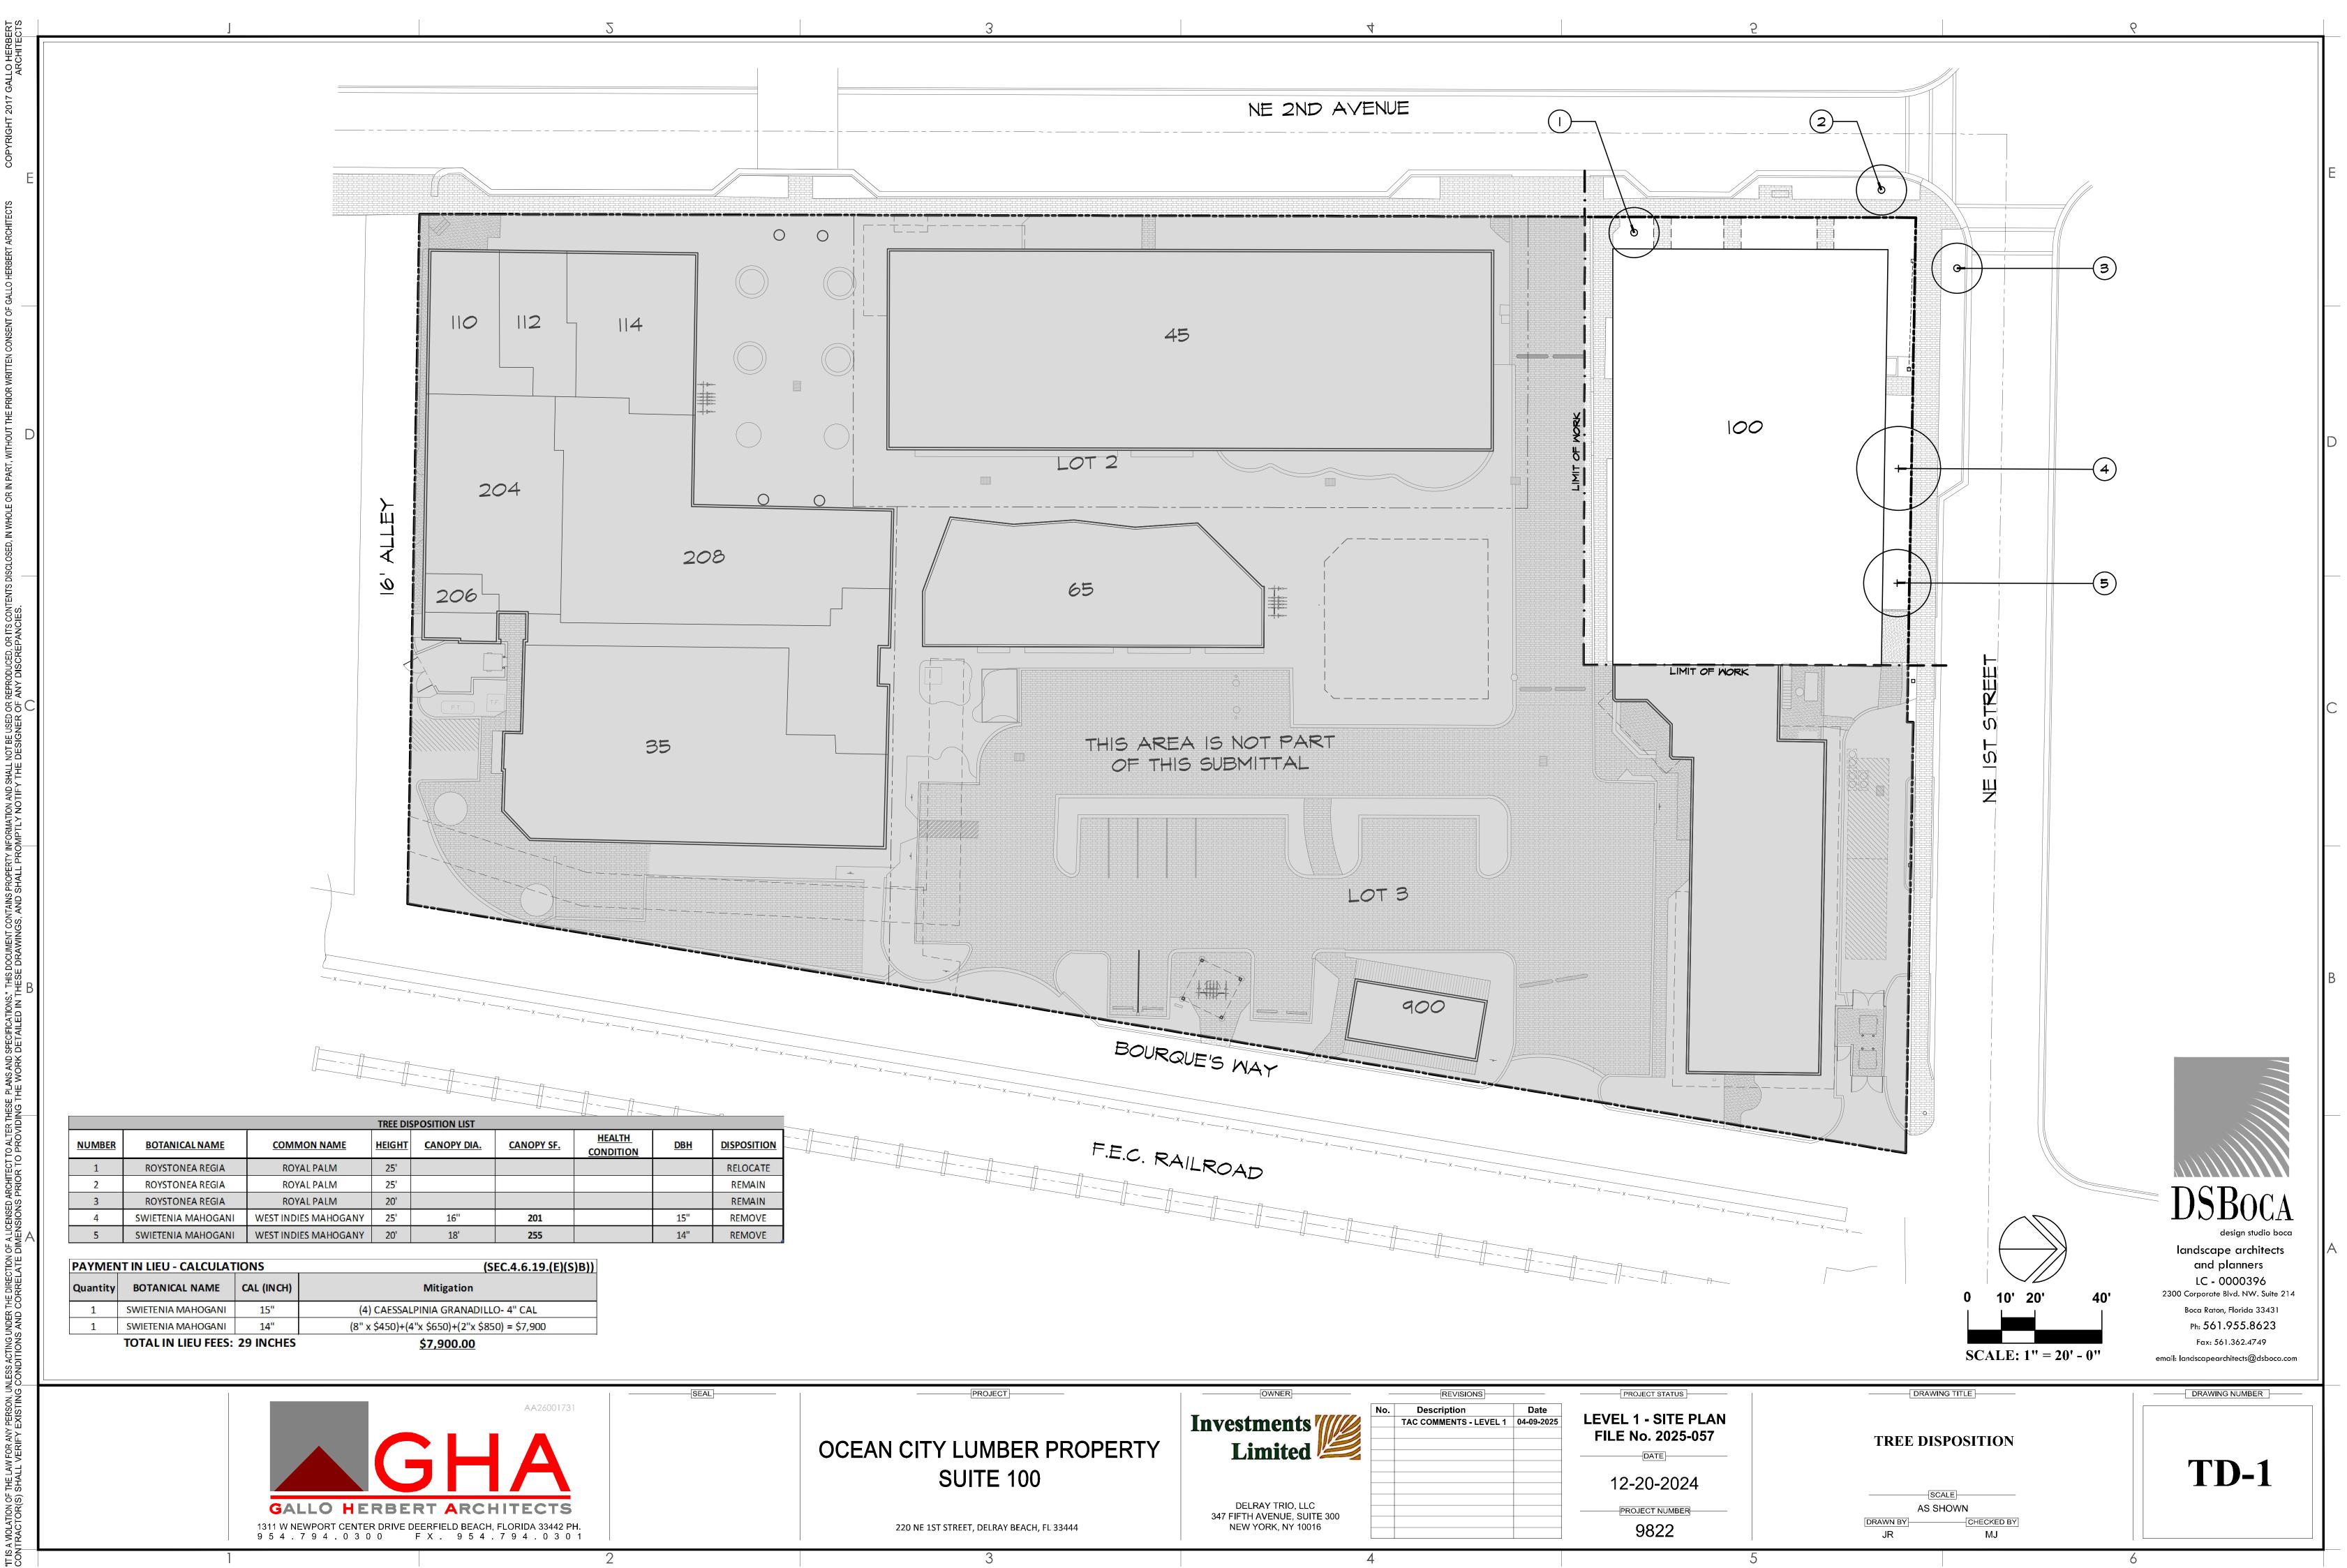
DRAWING NUMBER

LP-3

- DRAWING TITLE -

PLANTING SPECIFICATIONS

SCALE AS SHOWN DRAWN BY-CHECKED BY MJ



PAYMEN	IT IN LIEU - CALCULAT	IONS	(SEC.4.6.19.(E)(S)E				
Quantity BOTANICAL NAME CAL (INCH)		CAL (INCH)	Mitigation				
1	SWIETENIA MAHOGANI	15"	(4) CAESSALPINIA GRANADILLO- 4" CAL				
1	1 SWIETENIA MAHOGANI 14"		(8" x \$450)+(4"x \$650)+(2"x \$850) = \$7,900				
	TOTAL IN LIEU FEES:	29 INCHES	\$7,900.00				





PROJECT	OWNER	REVISIONS	PROJECT
OCEAN CITY LUMBER PROPERTY	Investments Limited	No. Description Date TAC COMMENTS - LEVEL 1 04-09-2025	LEVEL 1 - S FILE No.
SUITE 100			12-20
220 NE 1ST STREET, DELRAY BEACH, FL 33444	DELRAY TRIO, LLC 347 FIFTH AVENUE, SUITE 300 NEW YORK, NY 10016		PROJECT 98
3		4	