


NOTE: 1. ALL SIDEWALKS SHALL BE CONSTRUCTED THRU DRIVEWAYS.
 2. ALL SIDEWALKS SHALL INCLUDE ADA COMPLIANT RAMPS @ INTERSECTIONS.
 3. ALL SIDEWALKS SHALL INCLUDE CROSS SLOPE AND RUNNING SLOPE IN ACCORDANCE WITH ADA REQUIREMENTS.
 4. CURB RAMP DETECTABLE WARNING SURFACE SHALL EXTEND THE FULL WIDTH OF THE RAMP AND 24" DEEP.

RESIDENTIAL AREAS	4"
WITHIN 10' OF CROSS-STREETS, AT DRIVEWAYS & OTHER AREAS	6" @ 9"


SINGLE-FAMILY AREAS	5'
MULTI-FAMILY AREAS	5'
OTHER AREAS AS SPECIFIED BY THE CITY ENGINEER.	

TYPE	LOCATION
"A"	P.C. AND P.T. OF CURVES JUNCTION OF EXISTING & NEW SIDEWALKS & EVERY 30'
"B"	5'-0" CENTER TO CENTER ON SIDEWALKS SCORED DURING PLACEMENT OR SAWCUT WITHIN 24 HOURS OF PLACEMENT.
"A"	WHERE SIDEWALK ABUTS CONCRETE CURBS, DRIVEWAYS, AND SIMILAR STRUCTURES.

CITY of DELRAY BEACH
 ENVIRONMENTAL SERVICES DEPARTMENT
 404 SOUTH BRINTON AVENUE, DELRAY BEACH, FLORIDA 33444
 DATE: 07-02-2014
SIDEWALK CONSTRUCTION
 RT 5.1

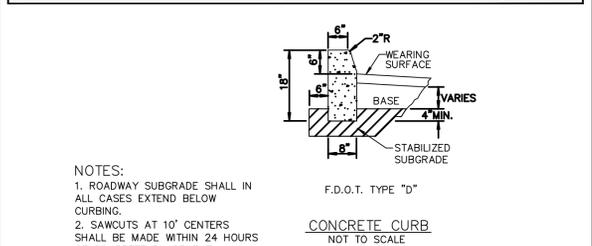

CITY of DELRAY BEACH
 ENVIRONMENTAL SERVICES DEPARTMENT
 404 SOUTH BRINTON AVENUE, DELRAY BEACH, FLORIDA 33444
 DATE: 04-08-08
CURB AND GUTTER SECTIONS
 RT 6.1

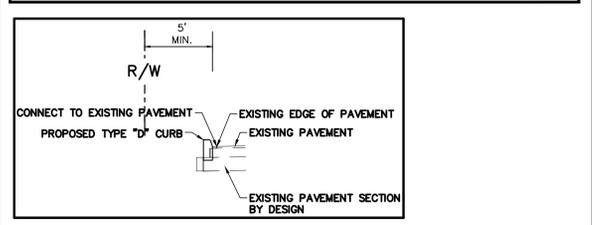

- 1) FLOOD ZONE-X
- 2) DATUM - NAVD88
- 3) UTILIZE EXISTING WATER & SEWER SERVICE




STORMWATER MANAGEMENT COMPUTATIONS

INCREASE IN IMPERVIOUS AREA

PERVIOUS/ IMPERVIOUS CALCULATION

TOTAL SITE AREA = 4865 sf.

EXISTING BLDG 2103 sf + PVMT 1551 sf	PROPOSED BLDG 2103 sf + PVMT 1524 sf
TOTAL IMPERVIOUS 3654 sf	TOTAL IMPERVIOUS 3627 sf
TOTAL PERVIOUS 1211 sf	TOTAL PERVIOUS 1238 sf

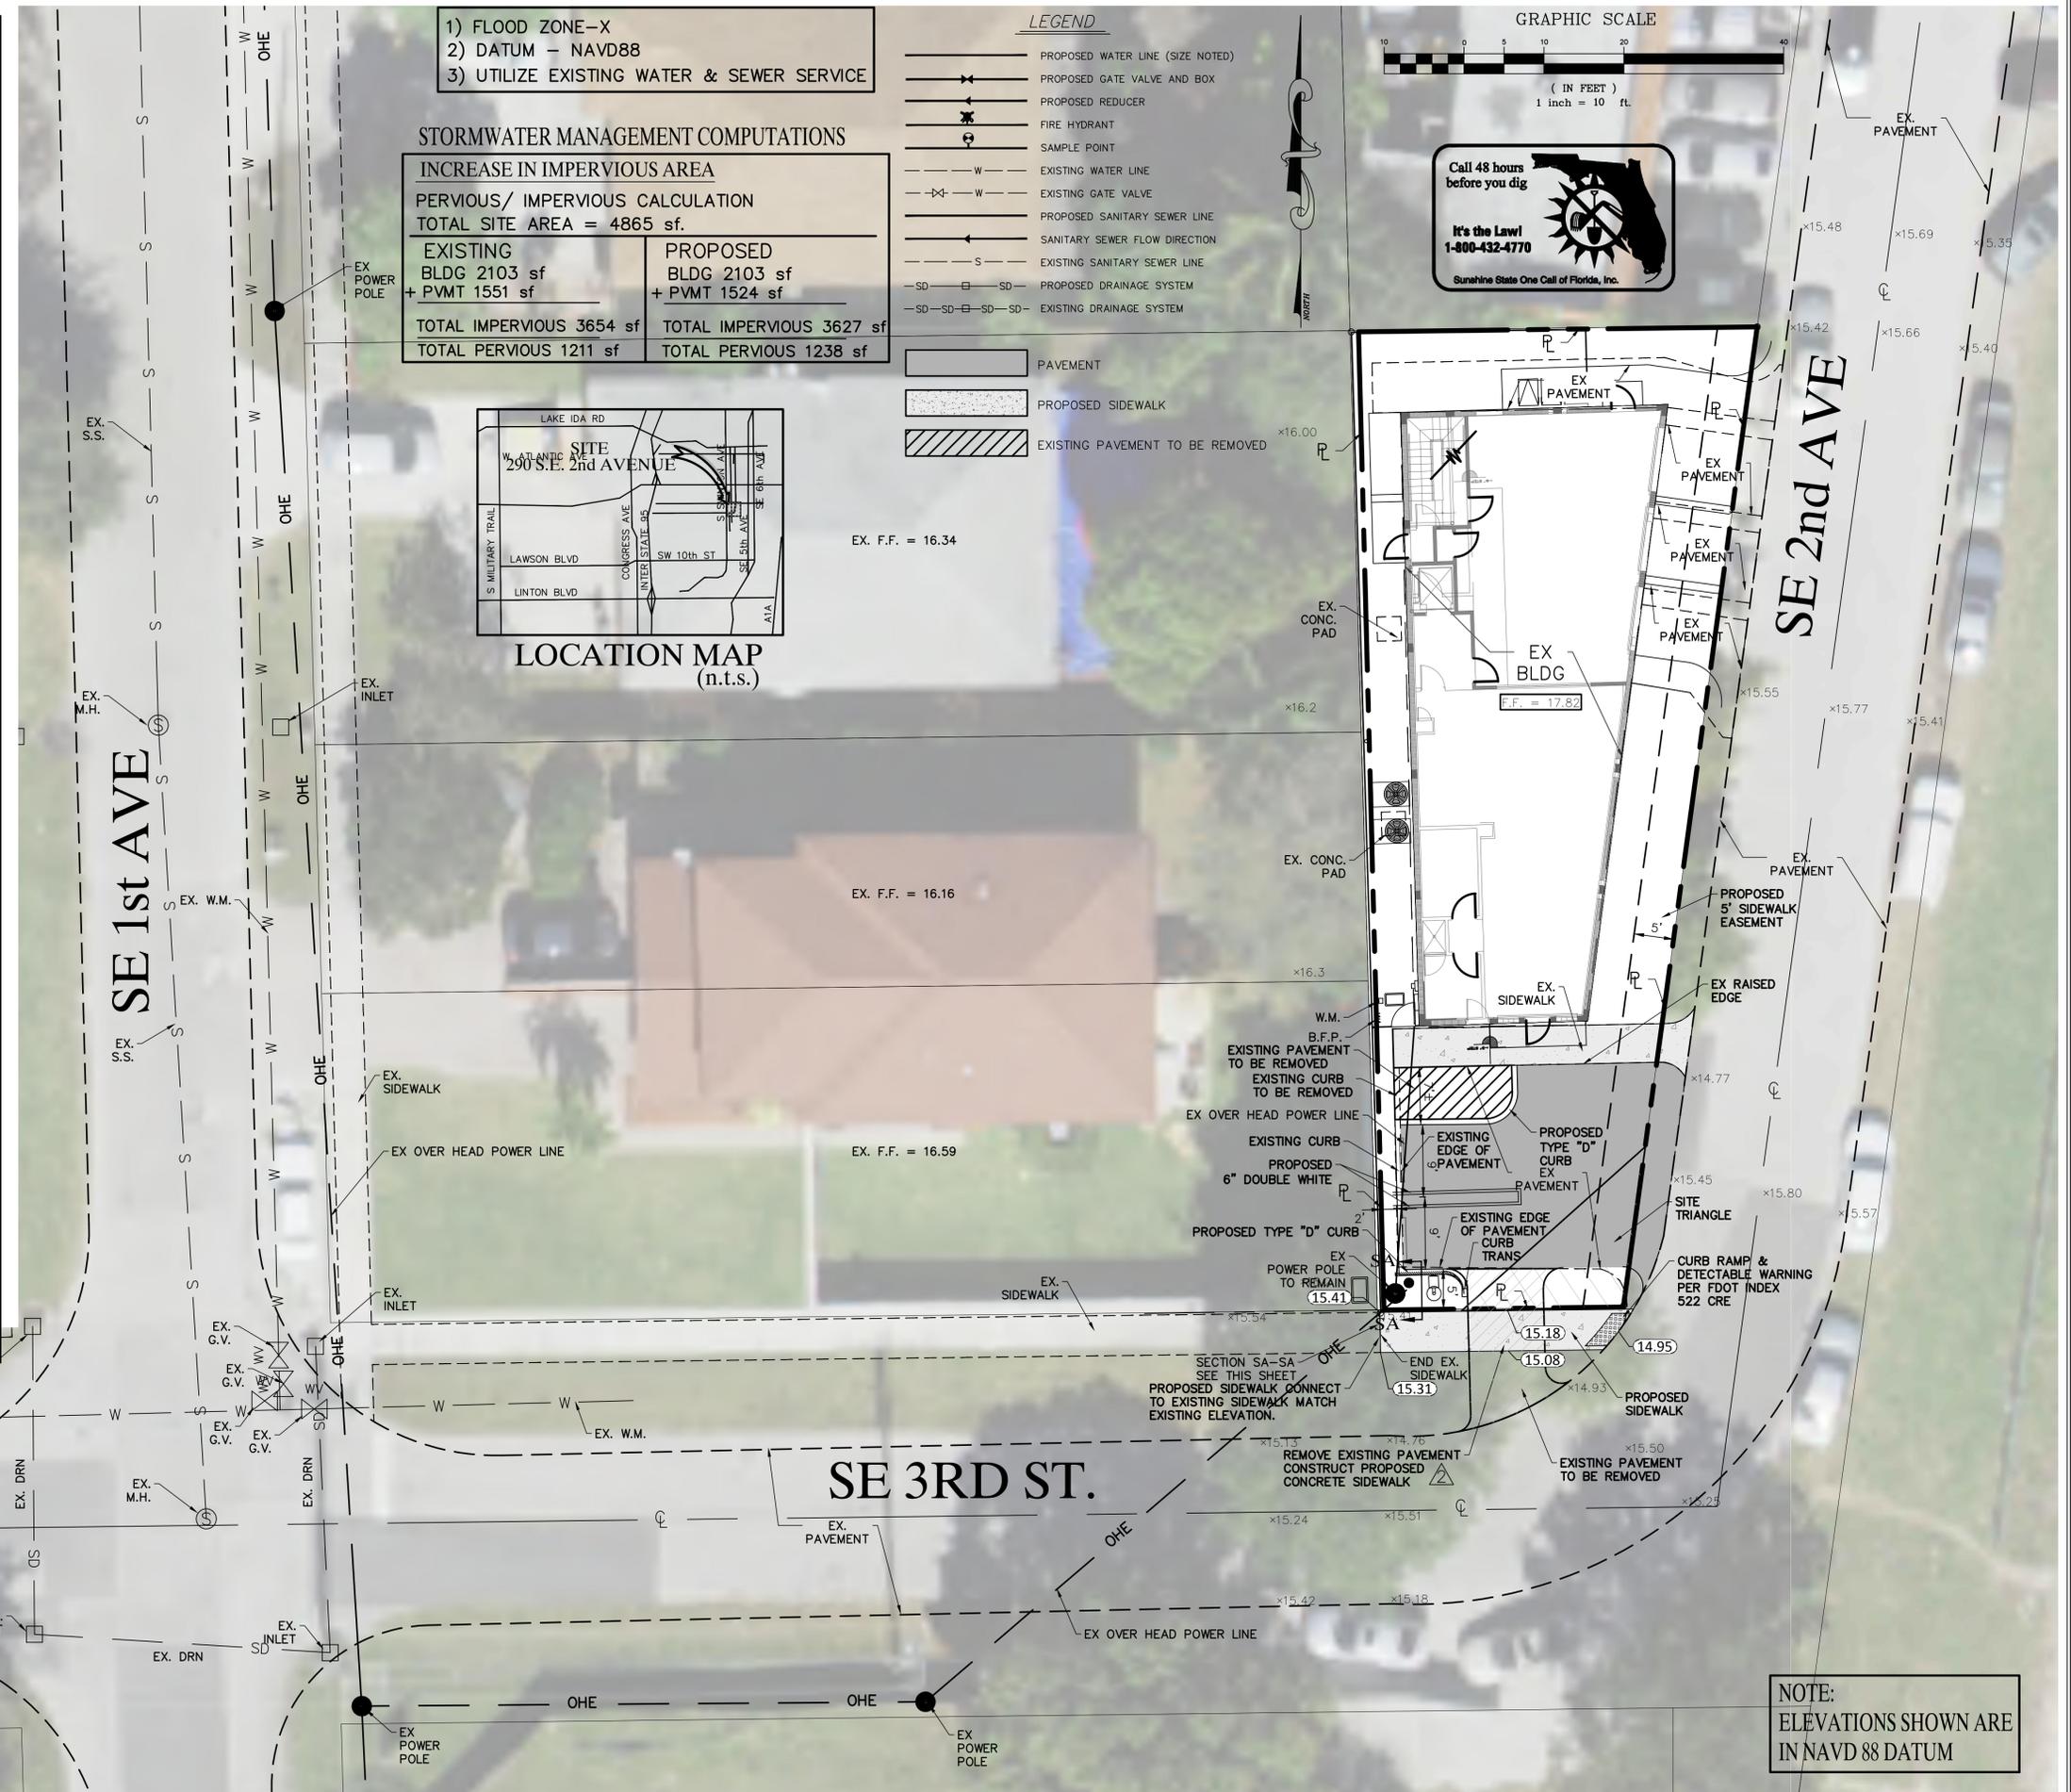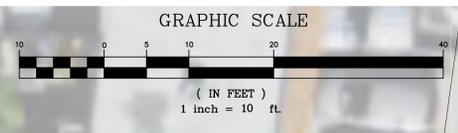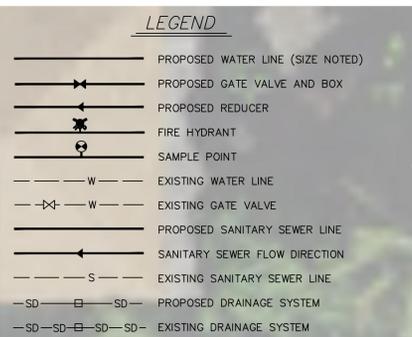

NOTE:
 ELEVATIONS SHOWN ARE
 IN NAVD 88 DATUM

DATE	11/20/20	BY	BAH
REV	10/20	DATE	10/20
REVISIONS		DATE	
FILE NAME	COORDING		

CAULFIELD & WHEELER, INC.
 CIVIL ENGINEERING - LAND PLANNING
 LANDSCAPE ARCHITECTURE - SURVEYING
 7900 GLADES ROAD - SUITE 100
 BOCA RATON, FLORIDA 33434
 PHONE (561)-392-0991 / FAX (561)-750-1452

290 S.E. 2nd AVENUE
 CIVIL PLAN
CIVIL / COMPOSITE UTILITY PLAN
 DELRAY BEACH, FLORIDA

DATE	7/7/20
DRAWN BY	BAH
F.B./ PG.	N/A
SCALE	1" = 10'

JOHN F. WHEELER
 PROFESSIONAL ENGINEER
 LICENSE NO. 25478
 STATE OF FLORIDA
 ENG. NO. EB-0003591
 DATE

JOB # 9152
 SH.T. NO.
C-1
 OF 1 SHEETS