WANG RESIDENCE

139/143 SE 7TH AVE DELRAY BEACH, FL 33483

LIST OF DRAWINGS:

CS.I COVER SHEET SPI. I EXISTING SITE PLAN SPI.2 PROPOSED SITE PLAN

SPI.3 COMPOSITE OVERLAY DEMOLIITON PLAN

A I. I FLOOR PLANS BLDG I

A I . 2 ELEVATIONS BLDG I

AI.3 ROOF PLAN

A 2 . I FLOOR PLAN(S) BLDG 2 A 2 . 2 ELEVATIONS BLDG 2

A 2 . 3 ROOF PLAN A3.1 FLOOR PLAN BLDG 3

A 3.2 ELEVATIONS BLDG 3

A3.3 ROOF PLAN A 4 . I FLOOR PLAN BUIDLING 4

A4.2 ELEVATIONS BLDG 4 \$ 3D VIEWS

A4.3 ROOF PLAN A4.4 GARAGE DEMOLITION PLAN

A 5.0 D/W SCHEDULE & HISTORIC STREETSCAPE

A 6.0 COLOR PERSPECTIVES / PHOTOMETRIC

EXISTING LANDSCAPE PLAN L-2 PROPOSED LANDSCAPE PLAN

IRRIGATION PLAN

LANDSCAPE LIGHTING PLAN

WS-I COVER

WS-2 DEMOLITION PLAN WS-3 WATER & SEWER PLAN

WS-4 WATER & SEWER DETAILS

PD-2 DEMOLITION PLAN

PD-3 PAVING, GRADING & DRAINAGE PLAN PD-4 PAVING, GRADING & DRAINAGE DETAILS

PD-5 PAVING, GRADING & DRAINAGE DETAILS


GENERAL NOTES:

I. ALL IDEAS, DRAWINGS, PLANS AND ARRANGEMENTS INDICATED OR REPRESENTED BY THESE DRAWINGS ARE OWNED BY AND THE PROPERTY OF THE ARCHITECT AND/OR ENGINEER OF RECORD. THEY WERE CREATED FOR AND DEVELOPED FOR USE ON AND IN CONNECTION WITH THE SPECIFIED PROJECT. THE IDEAS, DESIGNS, DRAWINGS, PLANS AND ARRANGEMENTS OF THE SPECIFIED PROJECT SHALL NOT BE USED BY OR DISCLOSED TO ANY PERSONS, FIRM, OR CORPORATION FOR ANY PURPOSE WHATSOEVER WITHOUT THE WRITTEN PERMISSION OF THE ARCHITECT AND ENGINEER(S) OF RECORD.

2. ALL SHOP DRAWINGS SHALL BE SUBMITTED FOR THE ARCHITECT/ENGINEER OF RECORD REVIEW ONLY AFTER THEY HAVE BEEN THOROUGHLY REVIEWED BY THE GENERAL CONTRACTOR FOR CONSTRUCTION METHODS, DIMENSIONS, FIELD CONDITIONS, "AS-CONSTRUCTED" DIMENSIONS AND OTHER TRADE REQUIREMENTS, AND STAMPED WITH THE CONTRACTOR'S APPROVAL STAMP.

3. ARCHITECT OF RECORD IS NOT RESPONSIBLE FOR ANY SURVEY OR CIVIL DWGS. THAT ARE INSERTED INTO THIS SET AND/OR LACK OF. THIS INCLUDES BUT NOT LIMITED TO PROPOSED AND/OR EXISTING CONDITIONS OF GRADING, PARKING, DRIVEWAYS, SEWER LINES, DRAINAGE, FINISH FLOOR ELEVATIONS, PROPERTY LINE LOCATIONS, EXISTING VEGETATION LOCATIONS, AND ETC.

LOCATION MAP:

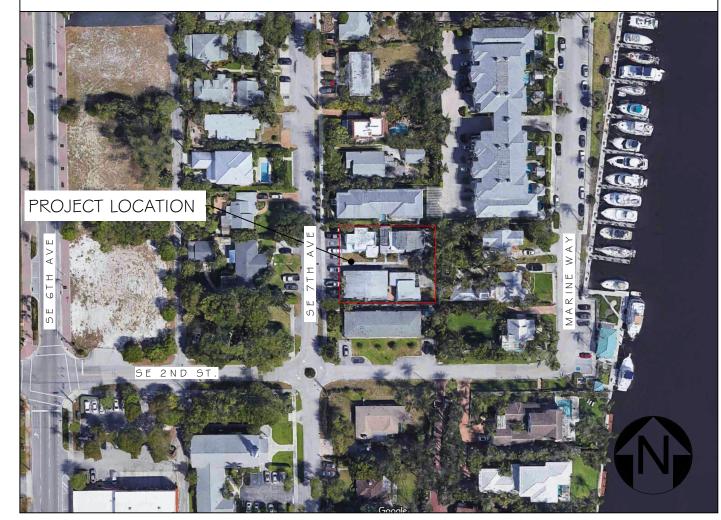

ABBREVIATIONS:

HEIGHT

HARDENER

ARCHITECTURAL RENDERING:

AT	H.C.	HOLLOE CORE
ACOUSTICAL TILE	H.M.	HOLLOW METAL
ADJUSTABLE	H.V.A.C.	HEATING, VENTILATION. \$ AI
ANCHOR BOLT		CONDITIONING
AIR CONDITIONING	INSUL.	INSULATION
ABOVE FINISH FLOOR	INV.	INVERT
ALUMINUM	LAM.	LAMINATED
ALTERNATE	MAT.	MATERIAL
BOARD		MECHANICAL CONTRACTOR
	M.C.	
BUILDING	M.H.	MAN HOLE
BENCH MARK	MLDG.	MOLDING
BRIDGING OR BEARING	MTL. MET.	METAL
CENTER TO CENTER	MIN.	MINIMUM
CENTER LINE	M.T.	METAL THRESHOLD
CABINET	N.I.C.	NOT IN CONTRACT
CATCH BASIN	NO.	NUMBER
CAST IRON	NOM.	NOMINAL
CERAMIC	O.C.	ON CENTER
CEILING	OPG.	OPENING
CLEAN OUT	O.W.	OPEN WEB
CONCRETE	P.C.	PLUMBING CONTRACTOR
COORDINATE	PL	PLATE
COLUMN	PT.	PRESSURE TREADED
CONTINUOUS	P.S.I.	POUNDS PER SQARE INCH
DETAIL	R.A.	RETURN AIR
DOWN	RM.	ROOM
DECK	REQ'D	REQUIRED
DOWN SPOUT	REIN.	REINFORCING
DRY WALL	S.B.	SPALSH BLOCK
DRAWING	SCH.	SCHEDULE
ELECTRICAL CONTRACTOR	SEC.	SECTION
ELEVATION	S.C.	SOLID CORE
ELECTRICAL	S.S.	STAINLESS STEEL
EXISTING	S.V.B.	STRAIGHT VINYL BASE
EXPOSED OR EXPANSION	SPEC.	SPECIFICATION
FIRE EXTINGUISHER	T.O.	TOP OF
FINISHED FLOOR	T.O.F.	TOP OF FOOTING
FINISH	T.O.P.	TOP OF PLATE
FLOOR	T.O.S.	TOP OF STEEL
FULL SIZE	TYP.	TYPICAL
FOOT OR FEET	THK.	THICK OR THICKNESS
FOOTING	T#G	TOUNGUE AND GROOVE
GENERAL CONTRACTOR	V.C.T.	VINYL COMPOSITION TILE
GLASS OR GLAZING	V.C.B.	VINYL COVE BASE
GLAZED PAINT	VIF	VERIFY IN FIELD
GYPSUM	W/	WITH
HOSE BIB	W.I.	WROUGHT IRON
HEIGHT	v v . 1 .	WOOD

WD.

WELDED WIRE FABRIC

WALL LEGEND:

EXISTING CMU WALL

EXISTING INTERIOR WALL

E EXISTING FIRE RATED PARTITION WALL

CMU WALL

CMU WALL, W/ ONE SIDE Ix PT FURRING & GYPSUM BOARD

CMU WALL, W/ ONE SIDE 2x PT FURRING \$ GYPSUM BOARD

CMU WALL, W/ ONE SIDE 1-5/8" MTL. STUD & GYPSUM BOARD

GYPSUM BOARD ON EACH SIDE. NOTE: FIRE RATED PARTITION WALL


PARTITION WALL (PARTTY WALL)- CMU WALL, W/ I-5/8" MTL. STUD \$ 5/8"

PARTITION WALL (PARTTY WALL)- CMU WALL, W/ 2x PT FURRING \$ 5/8" GYPSUM BOARD ON EACH SIDE. NOTE: FIRE RATED PARTITION WALL

ZZZZZ INTERIOR WALL

E=== INTERIOR FIRE RATED PARTITION WALL

ARCHITECTURAL SYMBOLS:

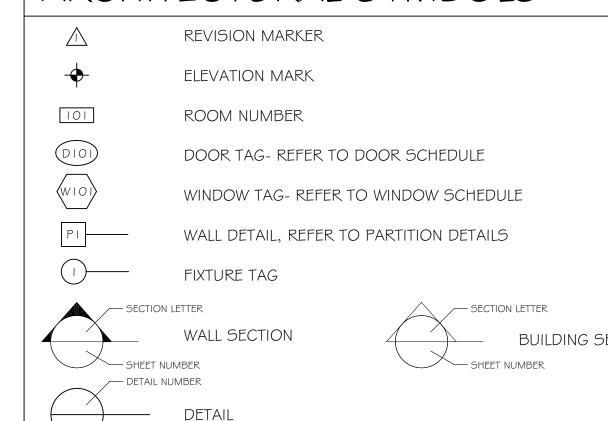

DESIGN TEAM:

139 143 SE 7TH AVENUE LLC

160 W CAMINO REAL # 168 BOCA RATON, FL 33432

STEVE SIEBERT ARCHITECTURE

STEVE@STEVESIEBERT.COM

1010 GATEWAY BLVD. BOYNTON BEACH, FL 33426

(561) 880-7894

OWNER:

ARCHITECT:

PROPERTIES AT 139 \$ 143 SE 7TH AVE.

PROJECT DESCRIPTION:

THE PROJECT CONSISTS OF AN ADDITION AND A RENOVATION OF THE INTERIOR & EXTERIOR OF FOUR EXISITNG BUILDINGS LOCATED ON THE

STEVE SIEBERT

ARCHITECTURE 1010 GATEWAY BLVD.

BOYNTON BEACH, FL 33426

PH. 561.880.7894

Steve@stevesiebert.com

www.stevesiebert.com

STEVEN W. SIEBERT

NEW JERSEY 21AI01517500

FLORIDA

C.O.A. DRAWINGS

THE WRITTEN DIMENSIONS ON THESE DRAWINGS SHALL TAKE PRECEDENCE OVER SCALED THE CONTRACTOR SHALL VERIFY AND BE RESPONSIBLE FOR ALL

DIMENSIONS AND CONDITIONS ON THE JOB, AND THIS OFFICE MUST BE NOTIFIED OF ANY VARIATION FROM THE DIMENSIONS. COPYRIGHT STEVE SIEBERT ARCHITECTURE-UNAUTHORIZED

REPRODUCTION OR ANY OTHER USE OF THIS DRAWING IS PROHIBITED.


PROJECT NO: 22-429 4.10.23 DRAWN BY:

CHECKED BY: SK 4 CITY COMMENTS (3.18.25)

6 CITY COMMENTS (8.8.25)

COVER SHEET

SITE PLAN IS ILLUSTRATIVE \$ IS SHOWN FOR BUILDING LOCATION ONLY.

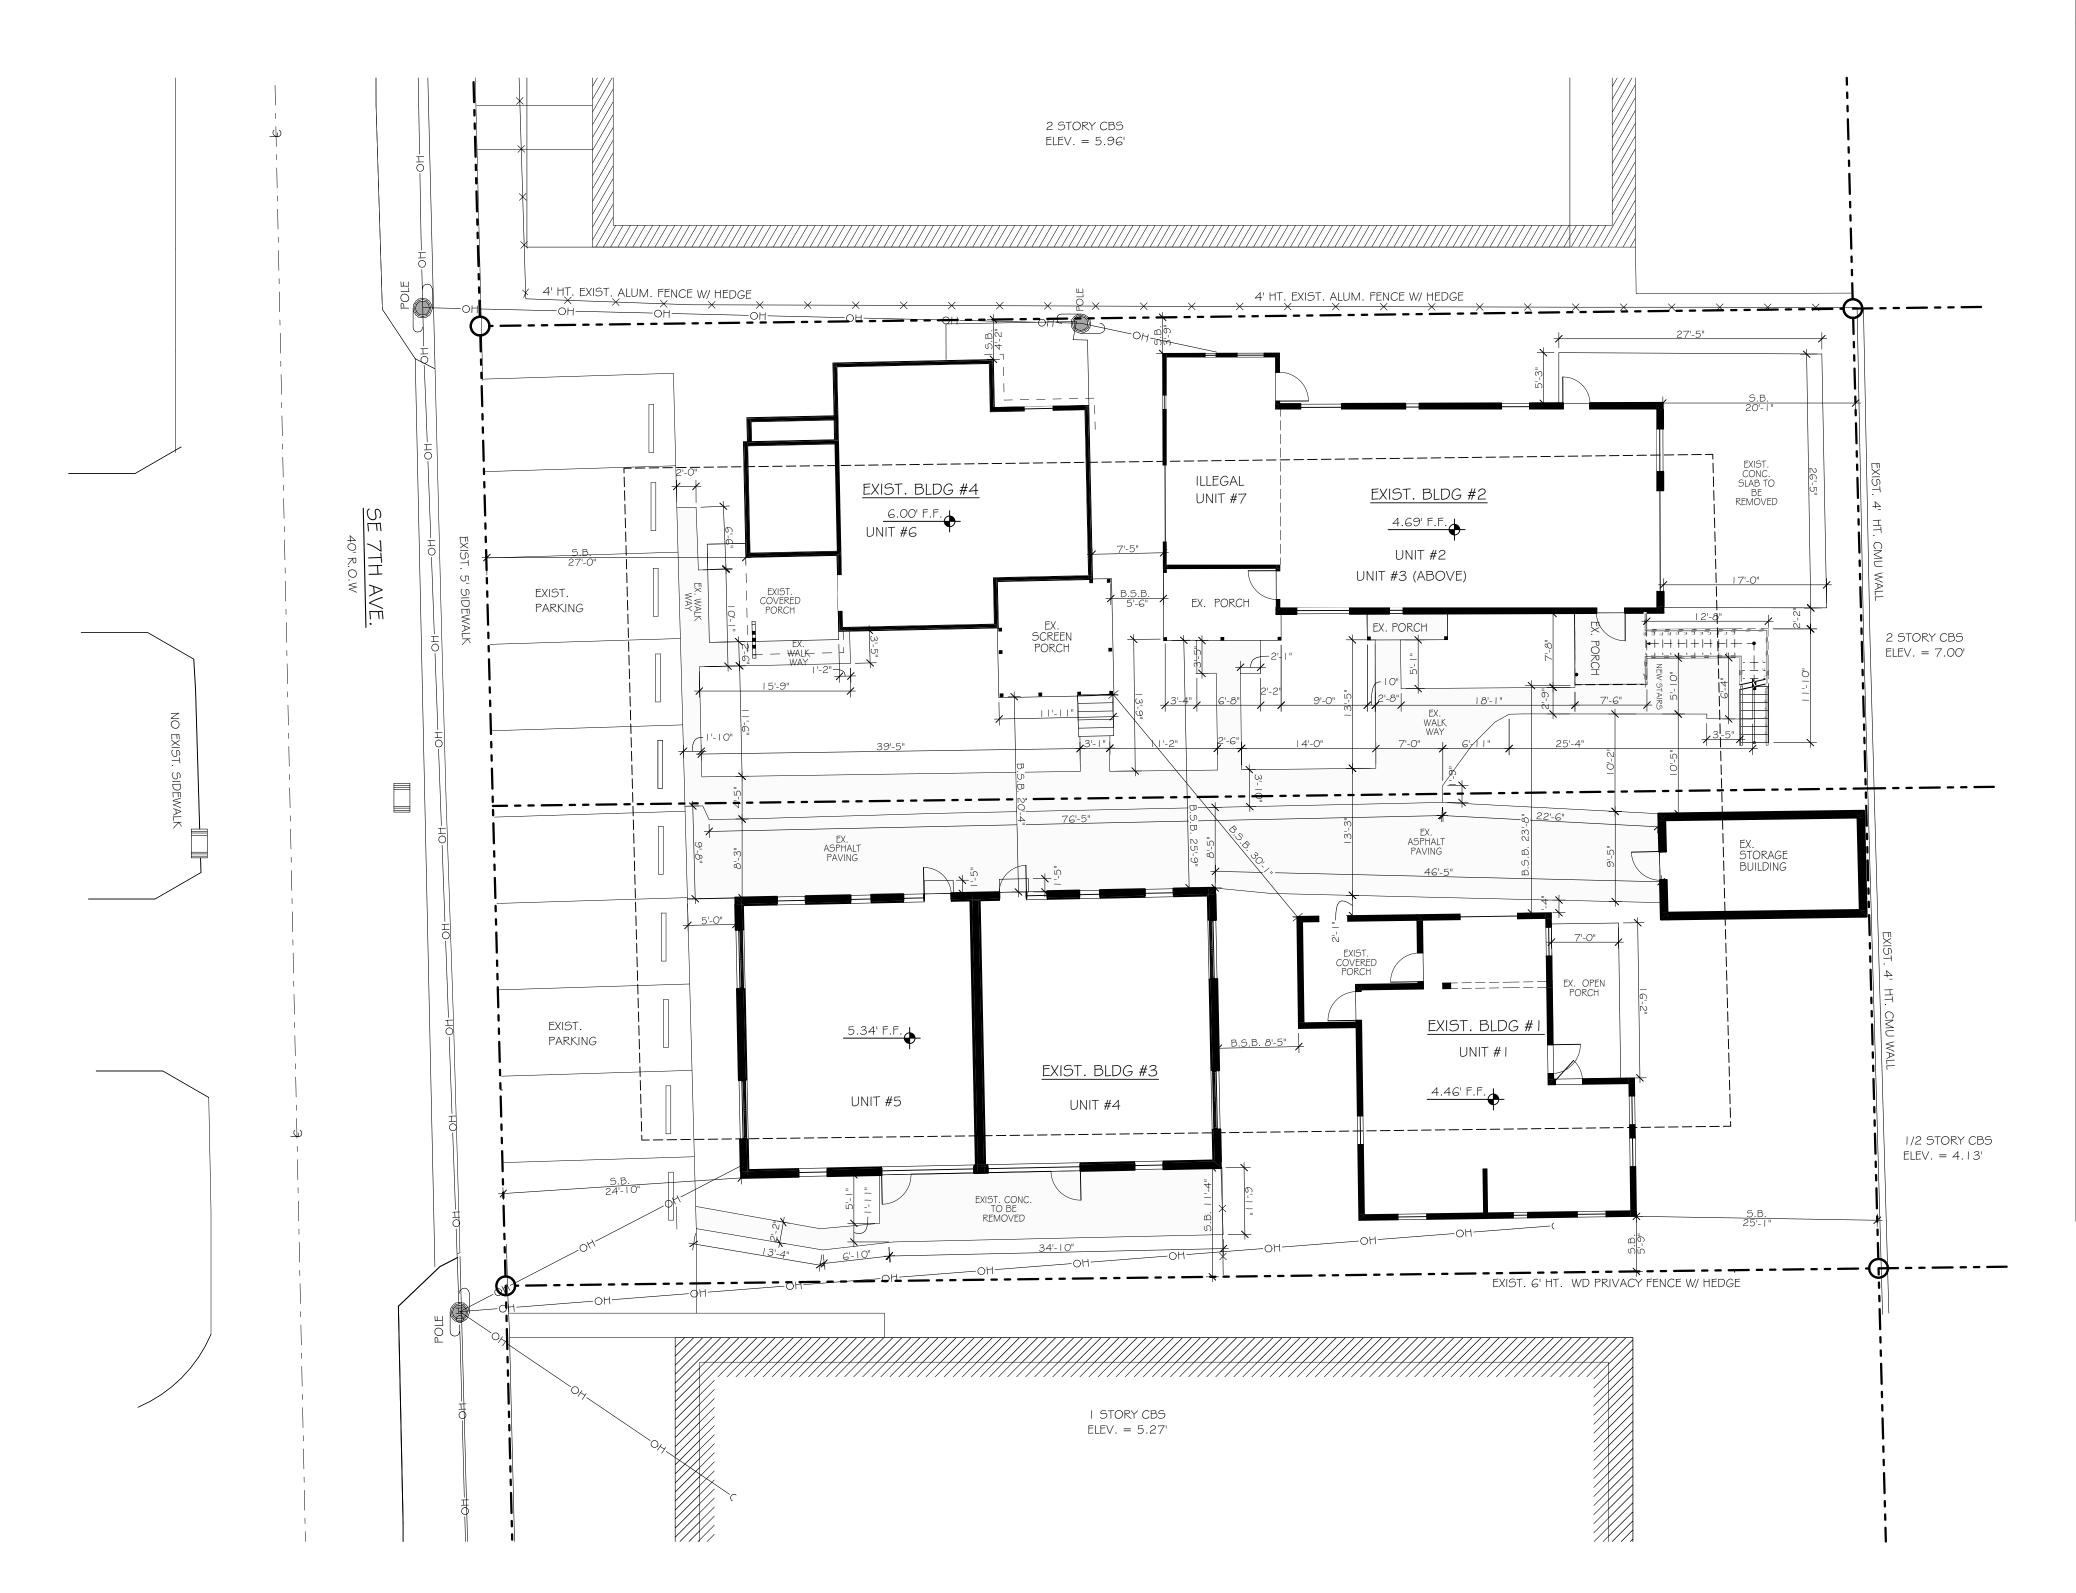

EXISTING ARCHITECTURAL SITE PLAN

SCALE: | " = | 0'

PROJECT DATA:

PROJECT & OWNER INFORMATION:

OWNER: 139 143 SE 7TH AVENUE LLC . 139/143 SE 7TH AVE : DELRAY BEACH, FL 33483 12-43-46-16-01-126-0180 12-43-46-16-01-126-0170 DELRAY BEACH LT 18 BLK 126 DELRAY BEACH LT 17 BLK 126

HISTORIC: MARINA HISTORIC DISTRICT

ZONING AND CODE INFORMATION:

ZONING: RM - RM-MULTIPLE FAMILY CONSTRUCTION TYPE: III-B CURRENT USE: 0800 - MULTIFAMILY PROPOSED USE: 0800 - MULTIFAMILY FLOOD ZONE: AE - ELEV. 8', REFER TO SURVEYORS DWG'S.

FLORIDA BUILDING CODE: FBC-2020 BUILDING CODE & FBC-2020 7TH EDITION RESIDENTIAL FBC EC=FLORIDA BUILDING CODE ENERGY CONSERVATION 2020 FLORIDA FIRE PREVENTION CODE, 5TH EDITION NEC NFPA 70 2017 EDITION, NATIONAL ELECTRICAL CODE FS= FLORIDA STATUES

SITE/LAND DATA: REQUIRED EXISTING

TOTAL SITE AREA:	.328 AC (14,312	SF)
MIN. LOT SIZE:	8,000 SF	14,301
MIN. LOT WIDTH:	60'	100'
MIN. LOT DEPTH:	100'	143'
LOT FRONTAGE:	60'	100'
F.A.R.	-	.36
MIN. FLOOR AREA(SF):	()	4,060
MAX. LOT COVERAGE(BL	DG) 40%	28.4%
MIN. OPEN SPACE:	25%	37.5%
MAX. HEIGHT:	35'	20'-1 1/2" (Bldg. #2)
DENSITY:	6-12 UNITS/ACRE	7 DU EXISTING*
	3 DU PERMITTED	3 MAX. DU ALLOWED

* THE 7 UNITS ARE AN EXISTING NON-CONFORMITY.

SETBACKS:	REQUIRED	EXISTING
FRONT(WEST): REAR (EAST): SIDE INTERIOR (NORTH):	25/30' (6) 5/25' (6) 5/30 (6)	24.85' 20.06' 3.7'
SIDE INTERIOR (SOUTH): POOL REAR: POOL SIDE:	5/30' (6) 0'-0' 0'-0"	5.69' NA NA

PARKING DATA:	REQUIRED	EXISTING
BLDG #1(1 x 2) "EXISTING"	2 SPACES	
BLDG #2(2 x 2) "EXISTING"	4 SPACES	
BLDG #3(2 x 2) "EXISTING"	4 SPACES	
BLDG #4(1 x 2) "EXISTING"	2 SPACES	
GUST PARKING	3 SPACES	
HANDICAP PARKING REQ.	* I SPACES	-
	16 SPACES	10 SPACES
		1

NOTE: THE ARCHITECT OF RECORD IS NOT RESPONSIBLE FOR ANY SURVEY/CIVIL WORK OR ANY DRAWINGS THAT HAVE BEEN INSERTED INTO THIS SET OR ANY LACK OF. THIS INCLUDES, BUT IS NOT LIMITED TO, THE EXISTING CONDITIONS OF GRADING, PARKING, DRIVEWAYS, SEWER LINES, DRAINAGE, FINISH FLOOR ELEVATIONS, PROPERTY LINE LOCATIONS, EXISTING VEGETATION, ETC. ALL FINISH FLOOR ELEVATIONS SHALL BE CONFIRMED BY THE ADJUDICATING CITY OR A LICENSED CIVIL ENGINEER.





STEVE SIEBERT ARCHITECTURE

1010 GATEWAY BLVD. BOYNTON BEACH, FL 33426 PH. 561.880.7894 Steve@stevesiebert.com www.stevesiebert.com

SEAL

STEVEN W. SIEBERT

FLORIDA AR0017834 NEW JERSEY 21AI01517500 TEXAS 26934

C.O.A. DRAWINGS

THE WRITTEN DIMENSIONS ON THESE DRAWINGS SHALL TAKE PRECEDENCE OVER SCALED THE CONTRACTOR SHALL VERIFY AND BE RESPONSIBLE FOR ALL DIMENSIONS AND CONDITIONS ON THE JOB, AND THIS OFFICE MUST BE

NOTIFIED OF ANY VARIATION FROM THE DIMENSIONS. COPYRIGHT STEVE SIEBERT ARCHITECTURE-UNAUTHORIZED REPRODUCTION OR ANY OTHER USE OF THIS DRAWING IS PROHIBITED.

PROJECT NO: 22-429 DRAWN BY:

CHECKED BY: SK REVISIONS: 4 CITY COMMENTS (3.18.25)

5 CITY COMMENTS (5.14.25) 6 CITY COMMENTS (8.8.25)

EXISTING SITE PLAN

DRAWING ABBREVIATIONS

UTILITY EASEMENT DRAINAGE EASEMENT L.M.E. S.B. SETBACK B.S.B BUILDING SETBACK PROP. B.S.B. PROPOSED BUILDING SET BACK E.O.W. EDGE OF WATER L.B.E. R.O.W

CB.

LIMITED ACCESS EASEMENT LAKE MAINTENANCE EASEMENT

LANDSCAPE BUFFER EASEMENT RIGHT OF WAY CATCH BASIN

. VARIANCE - BUILDING #2 NEW ADDITION ON THE SECOND FLOOR THE EXISTING BUILDING AS THE GROUND FLOOR IS INTO THE REQUIRED 15' NORTH PROPERTY LINE REQUIRED SETBACK. CURRENTLY THIS SETBACK FROM THE PROPERTY LINE IS 9'-3". THIS VARIANCE WILL KEEP THE 9'-3" SETBACK FOR THE SECOND FLOOR ADDITION TO ALIGN WITH THE WALL BELOW.

2. VARIANCE - BUILDING #1 NEW GROUND FLOOR ADDITION ONTO THE REQUIRED 15' SETBACK TO MATCH THE EXISTING BUILDING WALL LINE WHICH IS CURRENTLY AT 5'-9" SETBACK FROM THE PROPERTY LINE. THIS VARIANCE WILL KEEP THE 5'-9" SO THE ADDITION ALIGNS WITH THE EXISTING WALL.

3. INTERNAL ADJUSTMENT - BUILDING # I NEW GROUND FLOOR ADDITION THAT WILL BE CLOSER TO BUILDING #3. 16.3' IS REQUIRED, REQUEST WILL BRING IT DOWN TO 7'-10". CURRENTLY. THE EXISTING PORCH IS AT 8'-5" FROM BUILDING #3 AND THIS ADJUSTMENT IS ASKING TO CHANGE TO A 7'-10" DISTANCE.

4. VARIANCE - BUILDING #3 FINISHED FLOOR WILL REMAIN AT THE SAME LEVEL WHICH IS CURRENTLY AT 5.34' NAVD.

5. WAIVER - BUILDING #2, THE SECOND FLOOR ADDITION IS EXPANDING TO THE BUILDINGS FRONT ELEVATION LINE ON TO AN EXISTING FLAT ROOF. SEE ELEVATIONS FOR BLDG. #2 FOR TAG.

6. WAIVER - PARKING LOT LANDSCAPE ISLANDS, THE EXISTING LOT WILL NOT ALLOW FOR US TO MEET SEC. 4.6.16 (H)(3) IN REGARDS TO MULTI-FAMILY DEVELOPMENTS. THE SITE WILL NOT ALLOW FOR INTERMEDIATE ISLANDS AND PROPER SIZED LANDSCAPE AREAS ISLANDS.

DEMOLITION REQUESTS:

DEMOLITION - FULL DEMOLITION OF THE EXISTING SINGLE CAR GARAGE.

DRAWING ABBREVIATIONS

L.A.E. L.M.E. S.B. SETBACK B.S.B PROP. B.S.B.

L.B.E.

R.O.W

CB.

UTILITY EASEMENT DRAINAGE EASEMENT LIMITED ACCESS EASEMENT LAKE MAINTENANCE EASEMENT BUILDING SETBACK

PROPOSED BUILDING SET BACK LANDSCAPE BUFFER EASEMENT RIGHT OF WAY CATCH BASIN

NOTE: THE ARCHITECT OF RECORD IS NOT RESPONSIBLE FOR ANY SURVEY/ CIVIL WORK OR ANY DRAWINGS THAT HAVE BEEN INSERTED INTO THIS SET OR ANY LACK OF. THIS INCLUDES, BUT IS NOT LIMITED TO, THE EXISTING CONDITIONS OF GRADING, PARKING, DRIVEWAYS, SEWER LINES, DRAINAGE, FINISH FLOOR ELEVATIONS, PROPERTY LINE LOCATIONS, EXISTING VEGETATION, ETC. ALL FINISH FLOOR ELEVATIONS SHALL BE

CONFIRMED BY THE ADJUDICATING CITY OR A LICENSED CIVIL ENGINEER.

SITE PLAN IS ILLUSTRATIVE \$ IS SHOWN FOR

BUILDING LOCATION ONLY.

4' HT. EXIST. ALUM. FENCE W/ HED

LANSCAPE



I STORY CBS

ELEV. = 5.27'

EXIST. BLDG #3

2 STORY CBS

ELEV. = 5.96'

EXIST. BLDG #4

UNIT #6

- 6' HT. WOOD FENCE

UNIT #5

15' SIDE SETBACK

EXIST. BLDG #2

UNIT #2

PAVERS

EXIST. 6' HT. WD PRIVACY FENCE W/ HEDGE

EXIST. BLDG #1

UNIT #3 (ABOVE)

A FENCE IS REQUIRED FOR THE POOL PER LDR SECTION 4.6.15

BUILDING STYLE DESCRIPTION: BUILDING I & BUILDING 4 IS A MEDITATION STYLE, BUILDING #3 IS POST MODERN ARCHITECTURE. BUILDING #2 IS FRAME VERNACULAR.

PROJECT DATA:

PROJECT & OWNER INFORMATION:

OWNER: 139 143 SE 7TH AVENUE LLC 139/143 SE 7TH AVE DELRAY BEACH, FL 33483 P.C.N.: 12-43-46-16-01-126-0180

12-43-46-16-01-126-0170 DELRAY BEACH LT 18 BLK 126 DELRAY BEACH LT 17 BLK 126

HISTORIC: MARINA HISTORIC DISTRICT

ZONING AND CODE INFORMATION:

ZONING: RM - RM-MULTIPLE FAMILY CONSTRUCTION TYPE: III-B CURRENT USE: 0800 - MULTIFAMILY PROPOSED USE: 0800 - MULTIFAMILY

FLOOD ZONE: AE - ELEV. 8', REFER TO SURVEYORS DWG'S.

FLORIDA BUILDING CODE:

SITE/I AND DATA. PEOLIPED

FBC-2020 BUILDING CODE \$ FBC-2020 7TH EDITION RESIDENTIAL FBC EC=FLORIDA BUILDING CODE ENERGY CONSERVATION 2020 FLORIDA FIRE PREVENTION CODE, 5TH EDITION

NEC NFPA 70 20 | 8 EDITION, NATIONAL ELECTRICAL CODE

FS= FLORIDA STATUES

2 STORY CBS

ELEV. = 7.00'

4' HT. 8" CMU W/ PAINTED STUCCO TO MATCH MAIN

> 1/2 STORY CBS ELEV. = 4.13'

SITE/LAND DATA:	REQUIRED	EXISTING	PROPOSED
TOTAL SITE AREA:	.328 AC (14,312 S	6F)	
DENSITY:	6-12 UNITS/ACRE	7 DU EXISTING	6 DU PROPOSED*
	1-3 DU ALLOWED	3 MAX. ALLOWED	18 DU/AC EXISTING
MIN. LOT SIZE:	8,000 SF	14,301	14,301
MIN. LOT WIDTH:	60'	100'	100'
MIN. LOT DEPTH:	100'	143'	143'
LOT FRONTAGE:	60'	100'	100'
F.A.R.	-	.36	.47
MIN. FLOOR AREA(SF):	()	4,060 (COMBINED)	4,606 (COMBINED)
MAX. LOT COVERAGE(BLD	G) 40%	28.4%	32.2%
MIN. OPEN SPACE:	25%	37.5%	38.5%
MAX. HEIGHT:	35'	20'-1 1/2"	20'-9" (Bldg. #2)

** THE 6 UNITS ARE AN EXISTING NON-CONFORMITY. AN ILLEGALLY SPLIT UNIT WILL BE JOINED BACK IN TO A SINGLE UNIT. NO NEW UNITS ARE ADDED.

SEE ELEV.

SEE ELEV.

F.A.R.: PROPOSED BUILDING # I 0.10 BUILDING #2 0.19 BUILDING #3 0.10

SETBACKS:	REQUIRED	EXISTING	PROPOSED	
FRONT(WEST): REAR (EAST): SIDE INTERIOR (NORTH): SIDE INTERIOR (SOUTH):	25/30' (6) 5/25' (6) 5/30 (6) 5/30' (6)	24.85' 20.06' 3.7' 5.69'	24.85' 5.1' 3.7' 5.69'	
POOL REAR: POOL SIDE :	O'-O' O'-O"	NA NA	O'-O" O'-O"	

0.07

DISTANCE BETWEEN RESIDENTIAL BUILDINGS

PER SECTION 4.6.2

BUILDING #4

D=(LA+LB+2(HA+HB))/6

BUILDING #3; LA =29.16', HA=11.25' BUILDING #1; LB= 24.58', HB=10.83'

D=(29.16+24.58+2(11.25+10.8)) = 97.8/6 = 16.3

(EXISTING IS 14' PROPOSED IS 7-10")

Required Minimum Horizontal Distance

Effective Length of Building A:

The effective length of Building A is the length of that portion of its wall, or walls, from which perpendicular lines drawn in a horizontal plane will intersect any wall of Building B. Where Building A has a curved or irregular surface, such surface shall be enclosed within an imaginary rectangle having its side nearest to Building B parallel with Building B, and all measurements shall be made from the imaginary rectangle.

Effective Length of Building B:

The effective length of Building B is the length of that portion of its wall, or walls, from which perpendicular lines drawn in a horizontal plane will intersect any wall of Building A. Where Building B has a curved or irregular surface, such surface shall be enclosed within an imaginary rectangle having its side nearest to Building A parallel with Building A, and all measurements shall be made to the imaginary

	PROPOSED:	REQUIRED:	EXIS1.:
BUILDING #3 \$ #4 DISTANCE BETWEEN BUILDINGS	5 20'-4"	22.25'	20'-4"
BUILDING # \$ #4 DISTANCE BETWEEN BUILDINGS	30'-1"	NA	30'-1"
BUILDING # \$ #2 DISTANCE BETWEEN BUILDINGS	5 23'-8"	25.9'	23'-8"
BUILDING #2 \$ #4 DISTANCE BETWEEN BUILDINGS	5'-6"	21'	5'-6"
BUILDING # \$ #3 DISTANCE BETWEEN BUILDINGS	7'-10"	16.3'	8'-5"
BUILDING #2 \$ #3 DISTANCE BETWEEN BUILDINGS	5 25'-9"	NA	25'-9"

PARKING DATA:	REQUIRED	PROVIDED	
BLDG #1(1 x 2) "EXISTING"	2 SPACES	I SPACES	
BLDG #2(2 x 2) "EXISTING"	4 SPACES	2 SPACES	
BLDG #3(2 x 2) "EXISTING"	4 SPACES	2 SPACES	
BLDG #4(1 x 2) "EXISTING"	2 SPACES	I SPACES	
GUST PARKING	3 SPACES	2 SPACES	
HANDICAP PARKING REQ.	* I SPACES	* I SPACES	
	L6 SPACES	09 SPACES	


NO NEW BEDROOMS WERE ADDED TO EXISTING FLOOR PLAN LAYOUT - TYPICAL

* INCLUDED IN OVERALL PARKING SPACE COUNT



STEVE SIEBERT ARCHITECTURE

1010 GATEWAY BLVD. BOYNTON BEACH, FL 33426 PH. 561.880.7894 Steve@stevesiebert.com www.stevesiebert.com

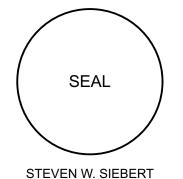

FLORIDA AR0017834

NEW JERSEY 21AI01517500 TEXAS

C.O.A. DRAWINGS

THE WRITTEN DIMENSIONS ON THESE DRAWINGS SHALL TAKE PRECEDENCE OVER SCALED THE CONTRACTOR SHALL VERIFY AND BE RESPONSIBLE FOR ALL DIMENSIONS AND CONDITIONS ON

THE JOB, AND THIS OFFICE MUST BE NOTIFIED OF ANY VARIATION FROM THE DIMENSIONS. COPYRIGHT STEVE SIEBERT ARCHITECTURE-UNAUTHORIZED REPRODUCTION OR ANY OTHER USE OF THIS DRAWING IS PROHIBITED.

PROJECT NO: 22-429 CHECKED BY: SK

4\ CITY COMMENTS (3.18.25)

PROPOSED SITE PLAN

6 CITY COMMENTS (8.8.25)



EXISTING:	EXISTING	l I		
BUILDING 1;				
UNIT #1 (UA)	690 SF			
FRONT PORCH (UC)	119 SF			
REAR PORCH (UC)	136 SF			
TOTAL SF	945 SF			
BUILDING 2;				
UNIT #2A (UA)	704 SF			
UNIT #2A (UC)	64 SF	NOTE LINIT	2B WILL BE	
UNIT 2B (UA)	452 SF	MERGED WIT		
UNIT 2B (UA	96 SF	IVIEROED WIT	11 0111 27 (.	
UNIT #3 (UA)	704 SF			
TOTAL SF	2,020 SF			
BUILDING 3;				
UNIT #4 (UA)	700 SF			
UNIT #5 (UA)	700 SF			
TOTAL SF	1,400 SF			
BUILDING 4;				
UNIT #6 (UA)	814 SF			
FRONT PORCH	120 SF			
REAR PORCH	144 SF			
TOTAL SF	1,078 SF			
BUILDING 5:				
GARAGE	23 I SF			
PROPOSED:	EXISTING	DEMO	ADDITION	PROPOSEI
BUILDING I;				
UNIT #1 (UA)	690 SF		+277 SF	967 3
FRONT PORCH (UC)	119 SF	-42 SF		47 9
REAR PORCH (UC)	136 SF	-136 SF	+550 SF	550 9
TOTAL SF	945 SF			1,564 9
BUILDING 2;				
UNIT #2 (UA - MERGED)	1,156 SF			1,1563
UNIT #2 (UC)	160 SF	-64 SF	+303 SF	399 9
UNIT #3 (UA)	704 SF		+269 SF	973 3
UNIT #3 (UC)	0 SF		+186 SF	1863
TOTAL SF	2,020 SF			2,7143
BUILDING 3;				
UNIT #4 (UA)	700 SF			700 3
UNIT #5 (UA)	700 SF			700 9
TOTAL SF	1,400 SF			1,400 9
BUILDING 4;				
UNIT #6 (UA)	814 SF			8143
FRONT PORCH	120 SF			1203
REAR PORCH TOTAL SF	144 SF 1,078 SF			1,078 5
	,,,,,,,,,,,,,,,,,,,,,,,,,,,,,,,,,,,,,,,			. , . ,
BUILDING 5: GARAGE	231 SF	-231 SF		0.5
		ニントントー		\cup \cup

EXISTING GARAGE TO BE DEMOLISHED = 23 | SF EXISTING BLDG. # | COVERED PORCH DEMO = 178 SF

EXISTING BLDG. #2 PORCH DEMO = 64 SF TOTAL BUILDING AREA = 5,674

(231 + 178 + 64)/5,674=0.083 (8.2%)

SEAL STEVEN W. SIEBERT
FLORIDA AR0017834
SEXTHANE
13 SE 7TH AVE
BEACH, FL 33483

STEVE SIEBERT

ARCHITECTURE

1010 GATEWAY BLVD.

BOYNTON BEACH, FL 33426

PH. 561.880.7894

Steve@stevesiebert.com

www.stevesiebert.com

C.O.A. DRAWINGS

THE WRITTEN DIMENSIONS ON THESE DRAWINGS SHALL TAKE PRECEDENCE OVER SCALED DIMENSIONS.
THE CONTRACTOR SHALL VERIFY AND BE RESPONSIBLE FOR ALL DIMENSIONS AND CONDITIONS ON

THE JOB, AND THIS OFFICE MUST BE NOTIFIED OF ANY VARIATION FROM THE DIMENSIONS.

COPYRIGHT STEVE SIEBERT ARCHITECTURE-UNAUTHORIZED REPRODUCTION OR ANY OTHER USE

OF THIS DRAWING IS PROHIBITED.

PROJECT NO: 22-429

DATE: 4.10.23

DRAWN BY: BT
CHECKED BY: SK


REVISIONS:

A CITY COMMENTS (3.18.25)


S CITY COMMENTS (5.14.25)

COMPOSITE OVERLAY

DEMOLIITON PLAN

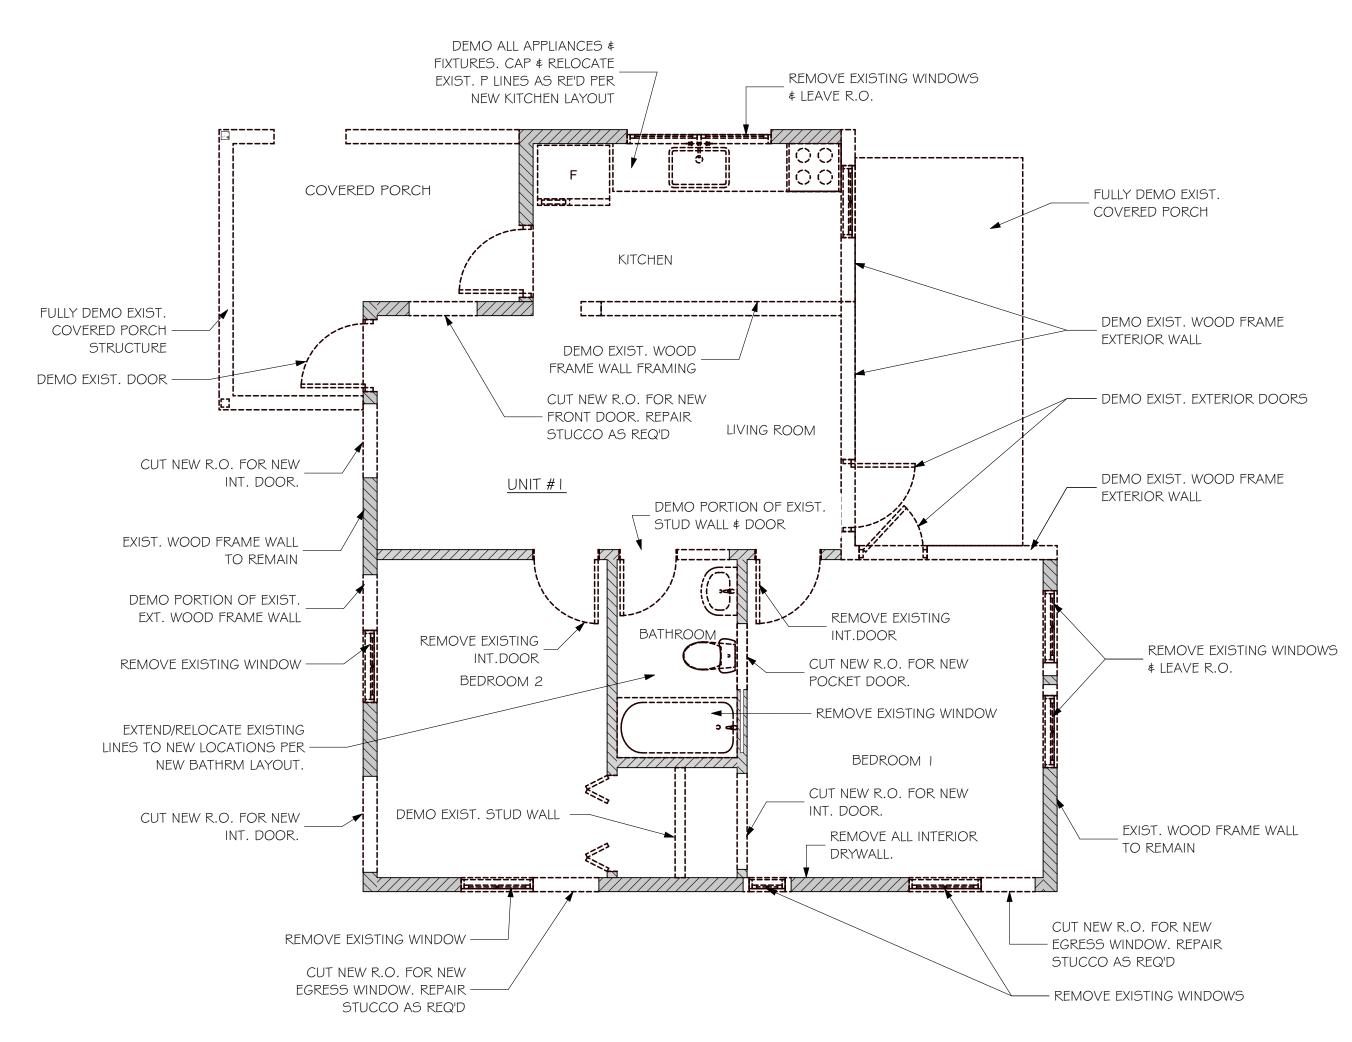



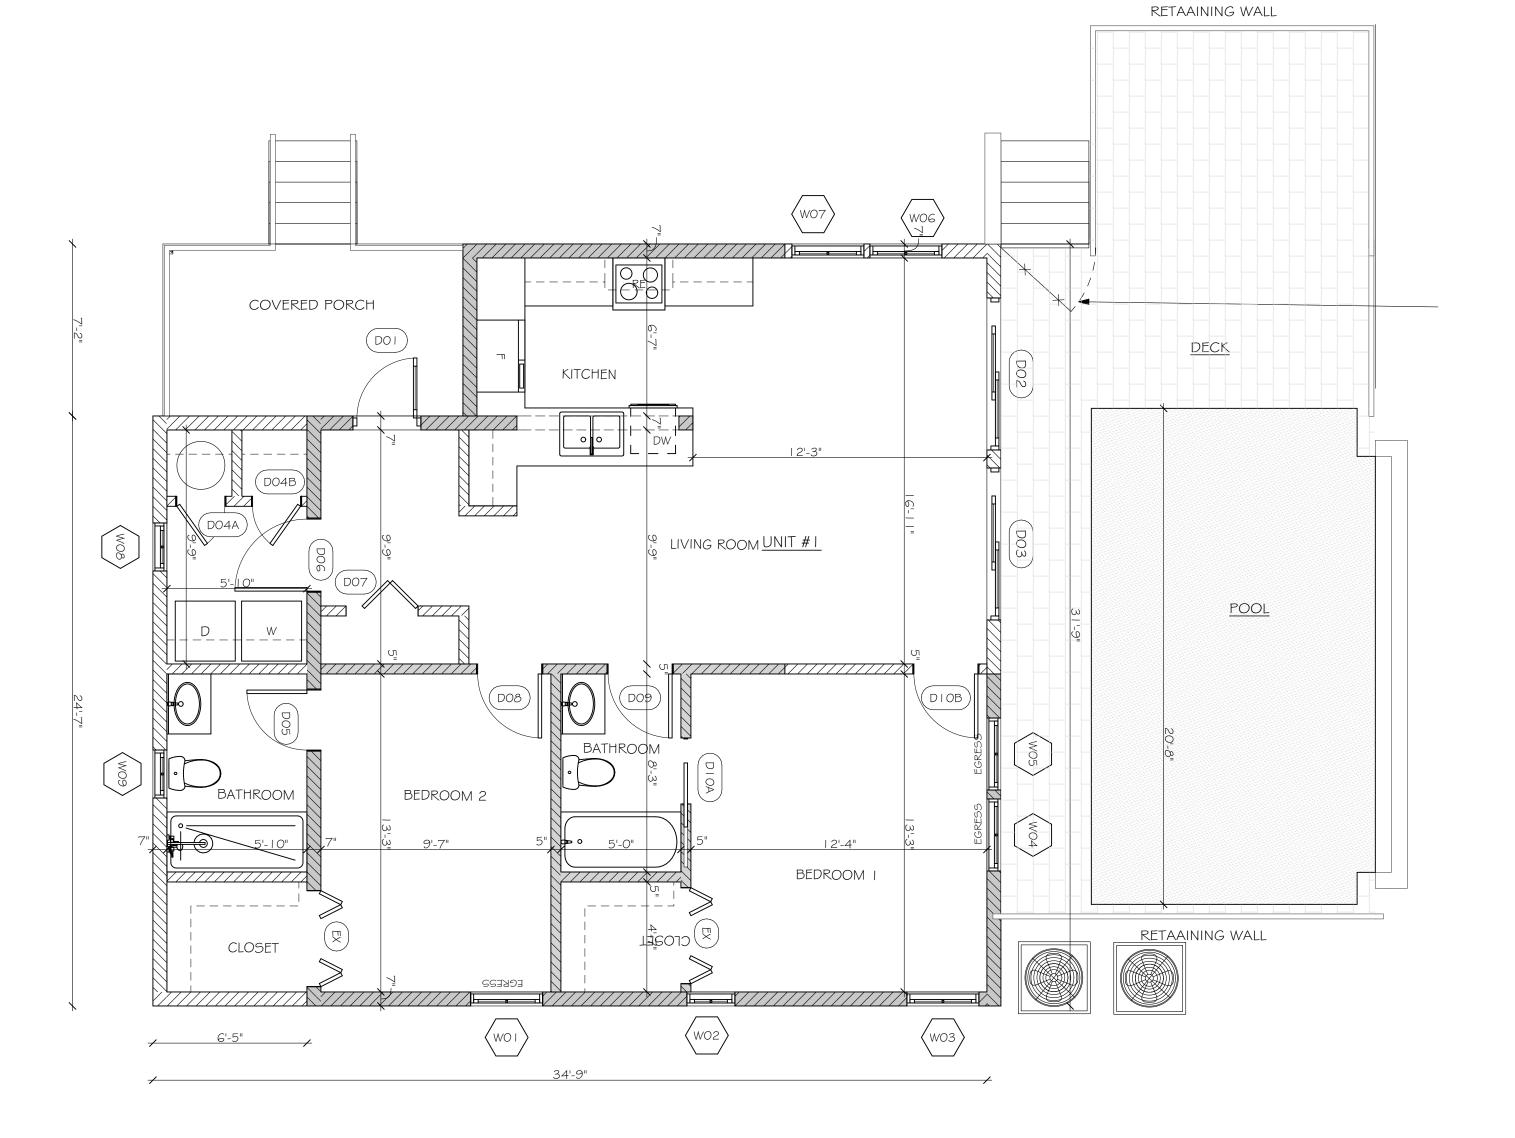




SETBACKS:

WEST):	82'-8"
EAST):	24'-8"
NORTH):	62'-6"
50UTH):	5'-6"



1010 GATEWAY BLVD.
BOYNTON BEACH, FL 33426
PH. 561.880.7894
Steve@stevesiebert.com
www.stevesiebert.com

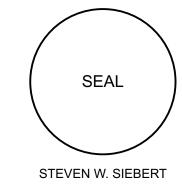

STEVEN W. SIEBERT

FLORIDA AR0017834

NEW JERSEY 21AI01517500

TEXAS 26934

1LAA3 20934

139/143 SE 7TH AVE DELRAY BEACH, FL 33483

C.O.A. DRAWINGS

THE WRITTEN DIMENSIONS ON THESE DRAWINGS SHALL TAKE PRECEDENCE OVER SCALED DIMENSIONS.
THE CONTRACTOR SHALL VERIFY AND BE RESPONSIBLE FOR ALL DIMENSIONS AND CONDITIONS ON THE JOB, AND THIS OFFICE MUST BE NOTIFIED OF ANY VARIATION FROM

THE DIMENSIONS.
COPYRIGHT STEVE SIEBERT ARCHITECTURE-UNAUTHORIZED REPRODUCTION OR ANY OTHER USE OF THIS DRAWING IS PROHIBITED.

PROJECT NO: 22-429

DATE: 4.10.23

DRAWN BY: BT

CHECKED BY: SK

REVISIONS:


4 CITY COMMENTS (3.18.25)

CITY COMMENTS (5.14.25)


CITY COMMENTS (8.8.25)

FLOOR PLANS BLDG 1


A1.1

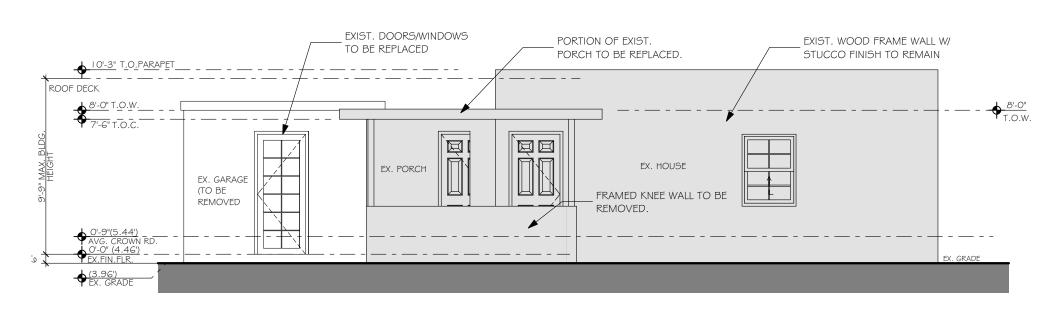


EXISTING WEST ELEVATION BLDG I SCALE: 3/16" = 1'-0"

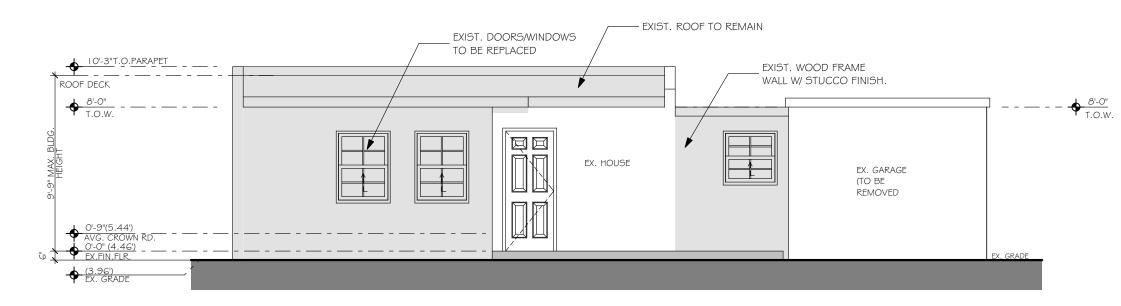


EXISTING EAST ELEVATION BLDG SCALE: 3/16" = 1'-0"

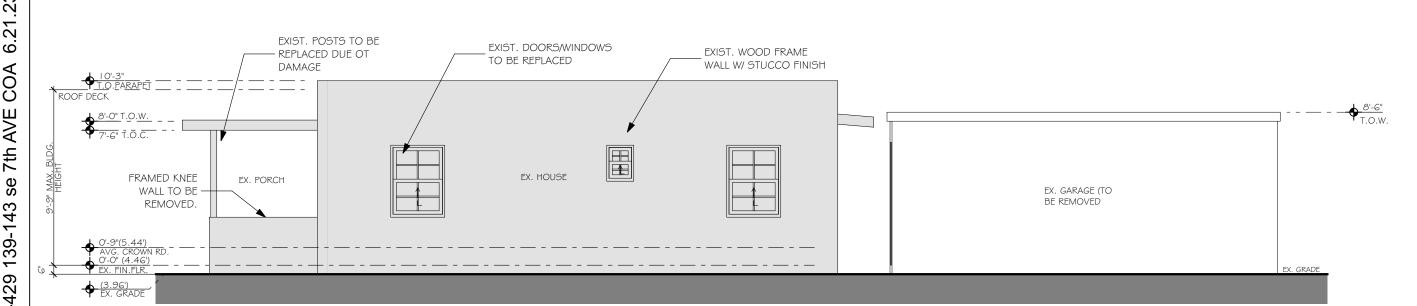



EXISTING SOUTH ELEVATION BLDG I

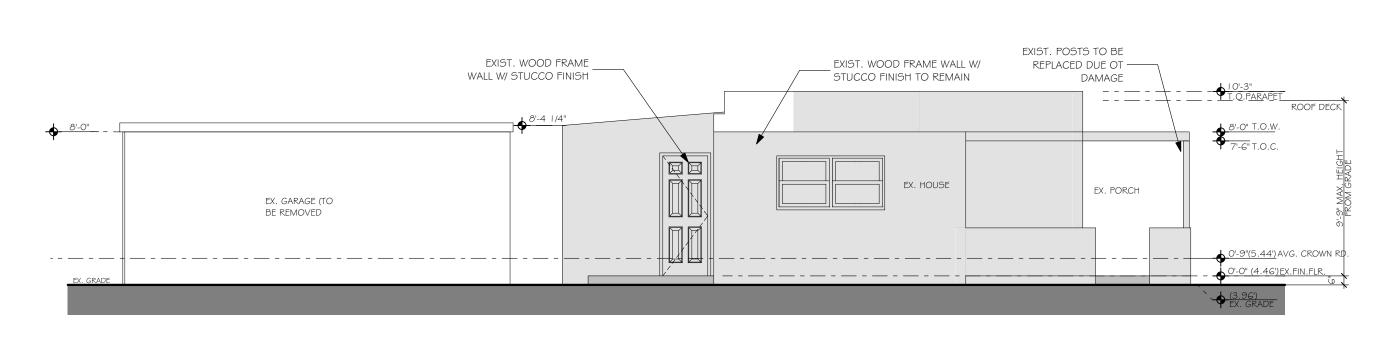


EXISTING NORTH ELEVATION BLDG I

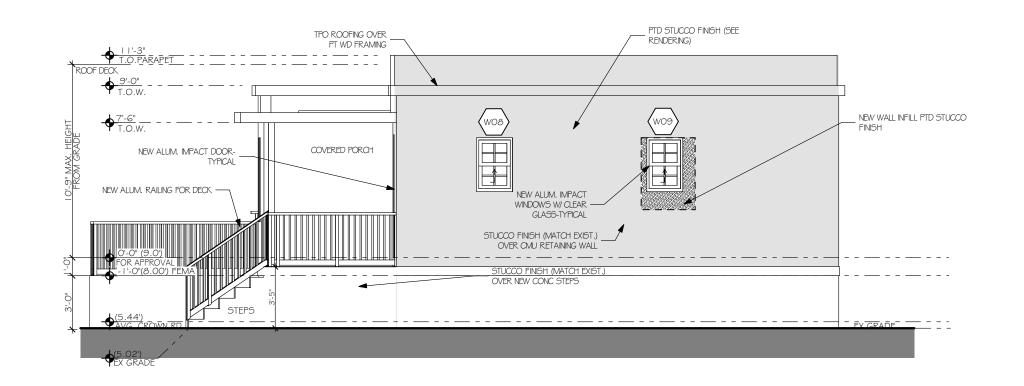

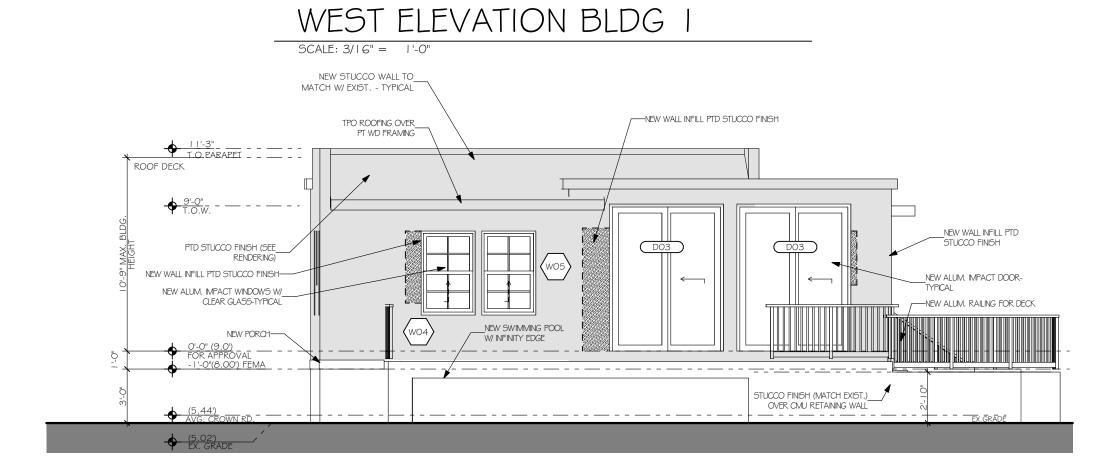

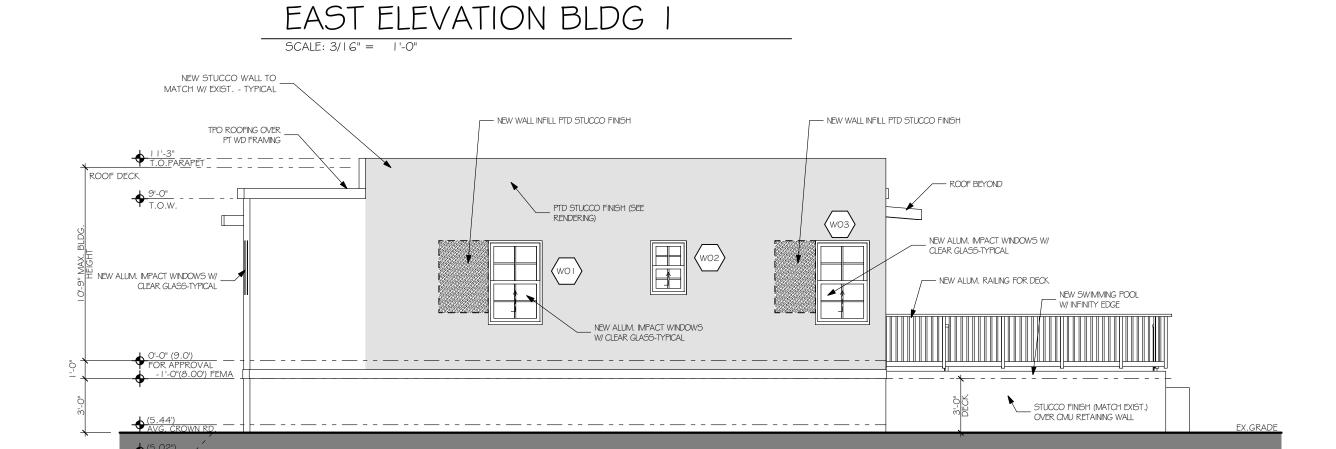



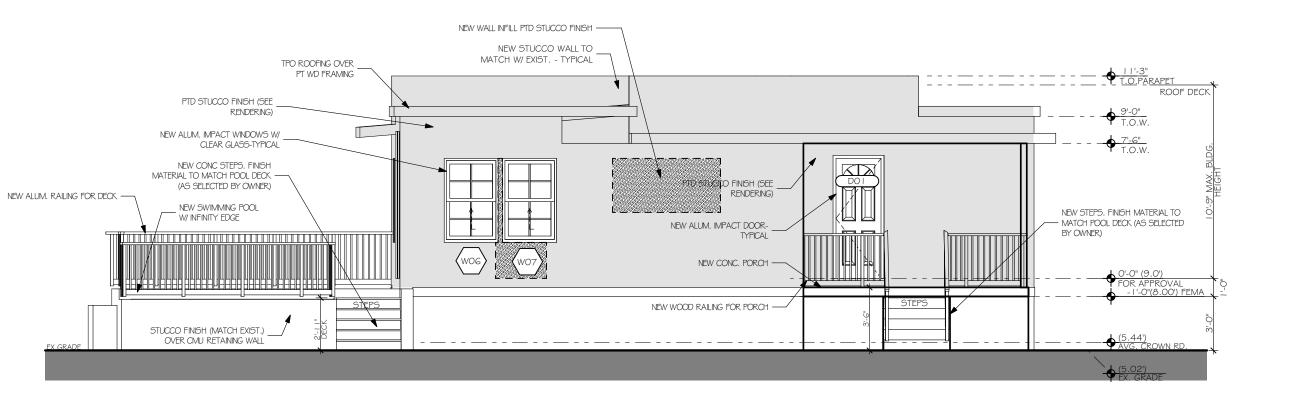


NORTH ELEVATION BLDG I SCALE: 3/16" = 1'-0"



STEVE SIEBERT ARCHITECTURE 1010 GATEWAY BLVD. BOYNTON BEACH, FL 33426

> PH. 561.880.7894 Steve@stevesiebert.com www.stevesiebert.com

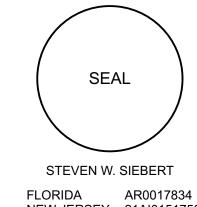

NEW JERSEY 21AI01517500 TEXAS


C.O.A. DRAWINGS

THE WRITTEN DIMENSIONS ON THESE DRAWINGS SHALL TAKE PRECEDENCE OVER SCALED THE CONTRACTOR SHALL VERIFY AND BE RESPONSIBLE FOR ALL DIMENSIONS AND CONDITIONS ON THE JOB, AND THIS OFFICE MUST BE NOTIFIED OF ANY VARIATION FROM THE DIMENSIONS. COPYRIGHT STEVE SIEBERT ARCHITECTURE-UNAUTHORIZED REPRODUCTION OR ANY OTHER USE OF THIS DRAWING IS PROHIBITED.

PROJECT NO: 22-429 4.10.23 DRAWN BY: CHECKED BY: SK

REVISIONS: 4 CITY COMMENTS (3.18.25) 6 CITY COMMENTS (8.8.25)

ELEVATIONS BLDG 1

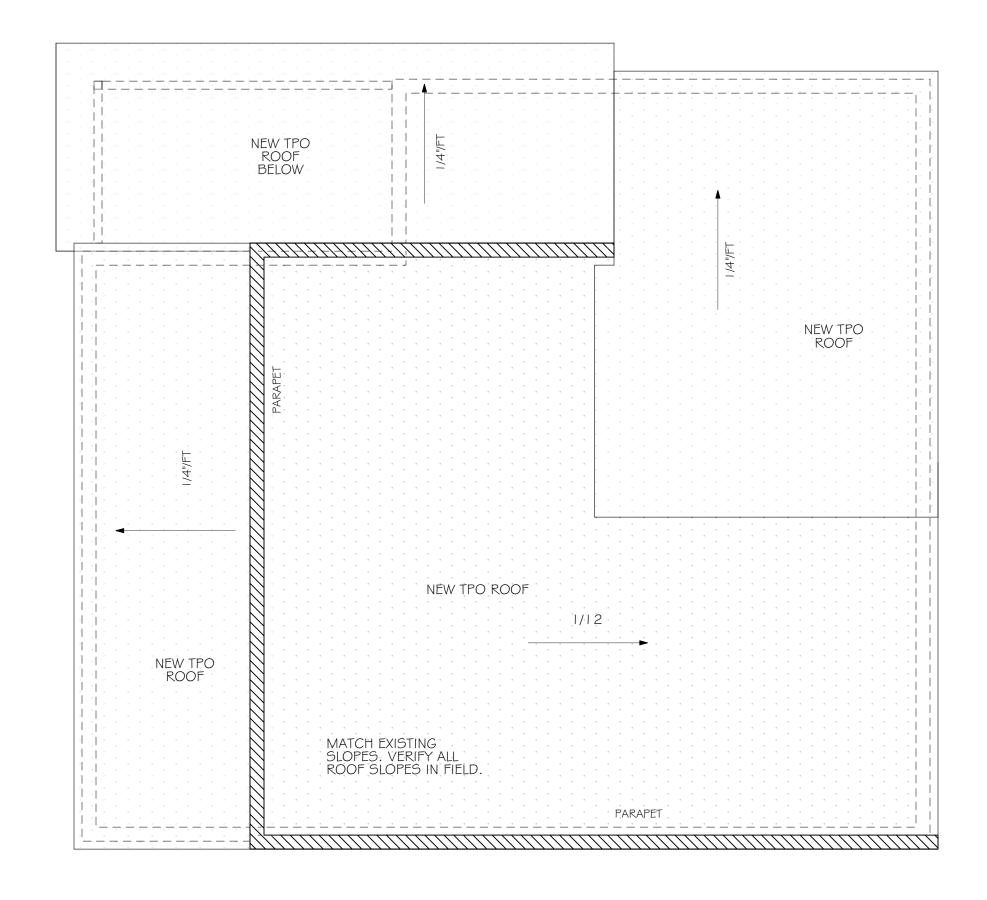






STEVE SIEBERT ARCHITECTURE

1010 GATEWAY BLVD. BOYNTON BEACH, FL 33426 PH. 561.880.7894 Steve@stevesiebert.com www.stevesiebert.com

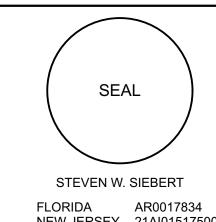

NEW JERSEY 21AI01517500

TEXAS 26934

C.O.A. DRAWINGS

THE WRITTEN DIMENSIONS ON THESE DRAWINGS SHALL TAKE PRECEDENCE OVER SCALED DIMENSIONS.
THE CONTRACTOR SHALL VERIFY AND BE RESPONSIBLE FOR ALL DIMENSIONS AND THE CONDITIONS OF THE LOD AND THE CONDITIONS ON THE LOD AND THE LOD AND

THE JOB, AND THIS OFFICE MUST BE NOTIFIED OF ANY VARIATION FROM THE DIMENSIONS. COPYRIGHT STEVE SIEBERT ARCHITECTURE-UNAUTHORIZED REPRODUCTION OR ANY OTHER USE OF THIS DRAWING IS PROHIBITED.


PROJECT NO: 22-429


DRAWN BY: BT CHECKED BY: SK

REVISIONS: ____ 4 CITY COMMENTS (3.18.25) 5 CITY COMMENTS (5.14.25)


CITY COMMENTS (8.8.25)

ROOF PLAN

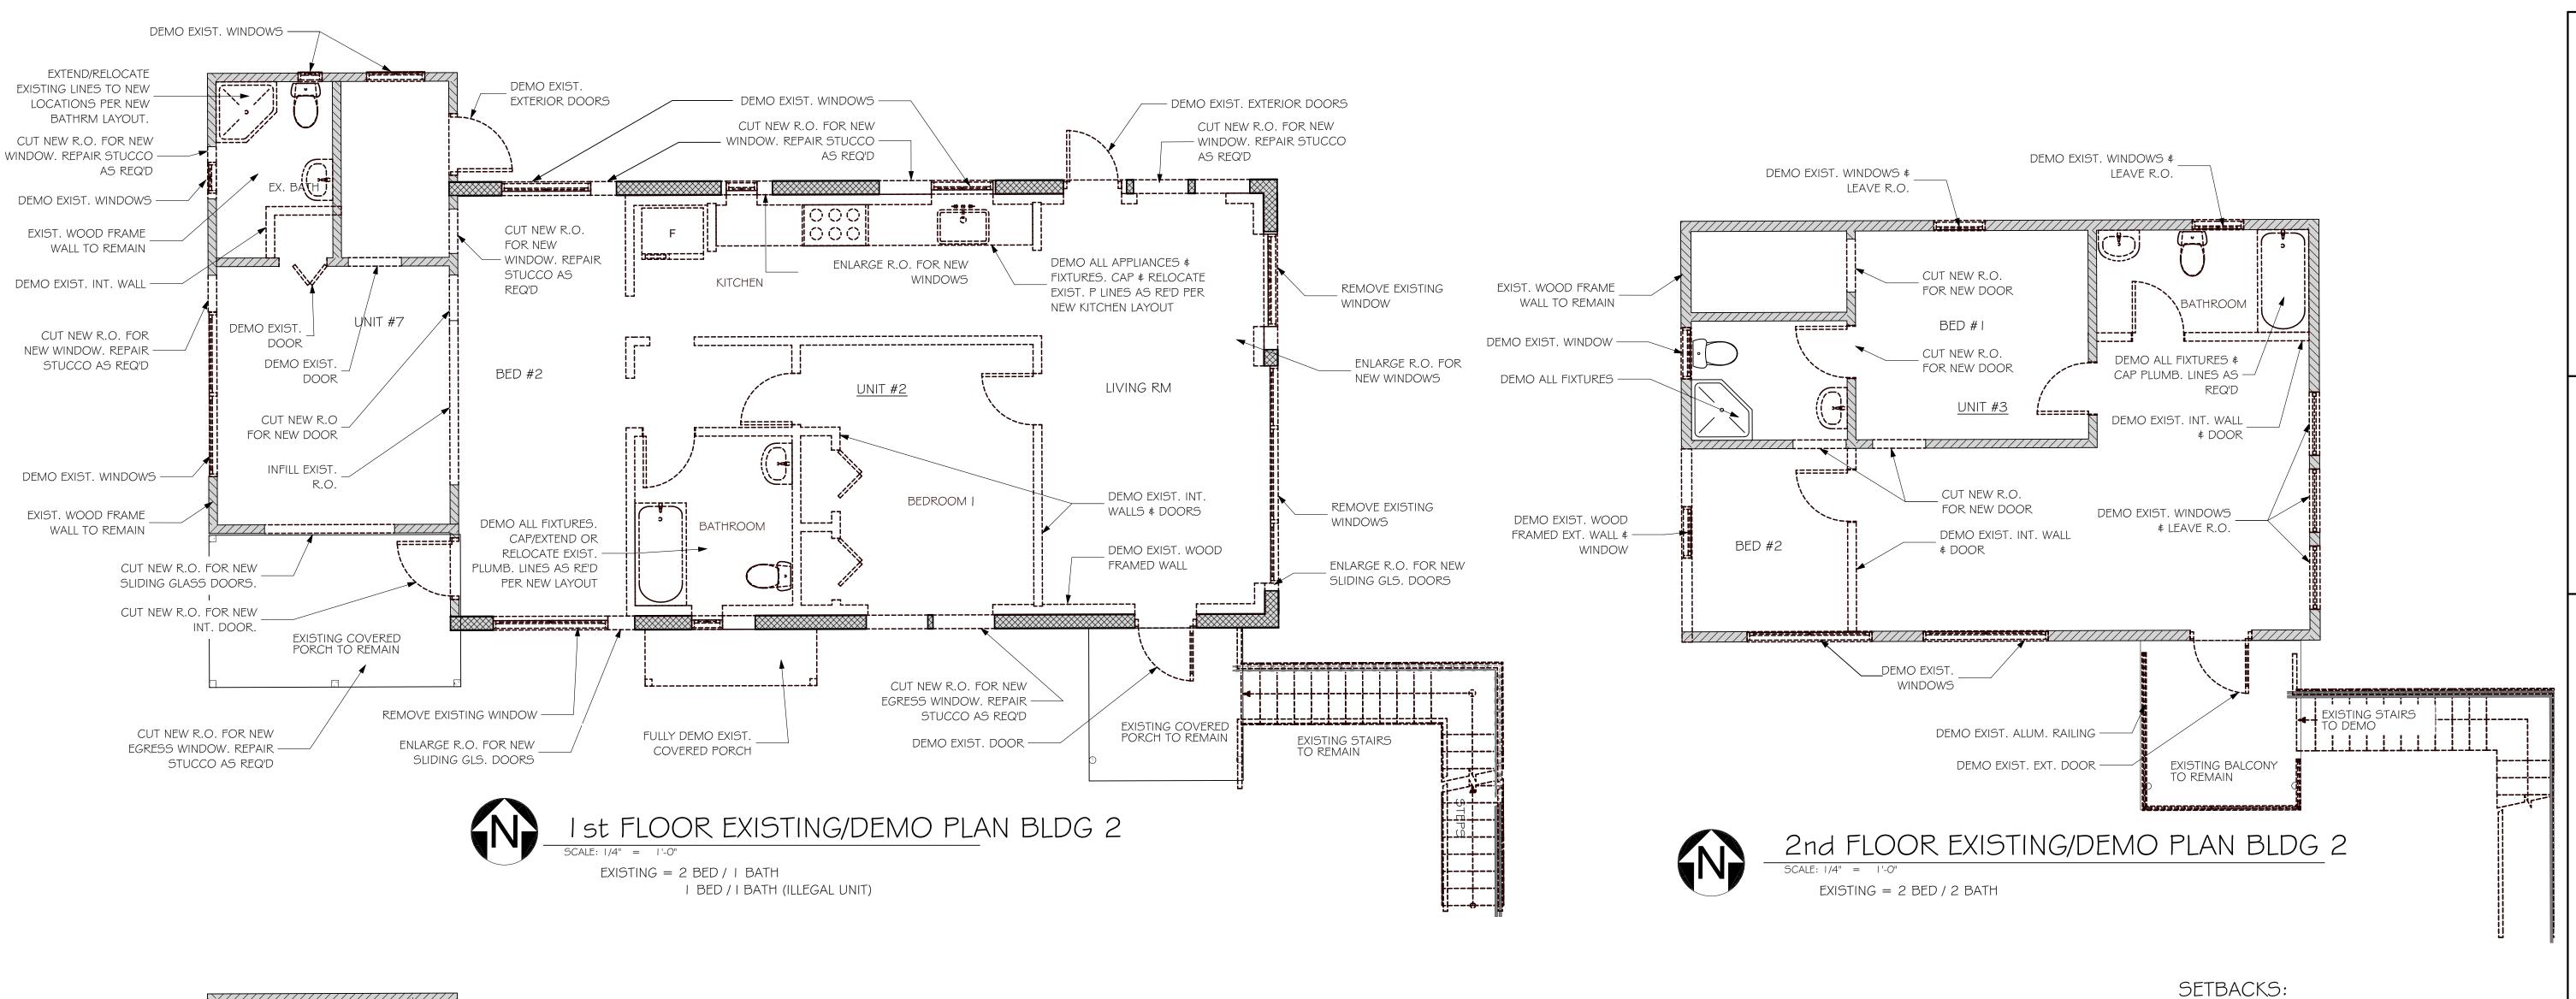

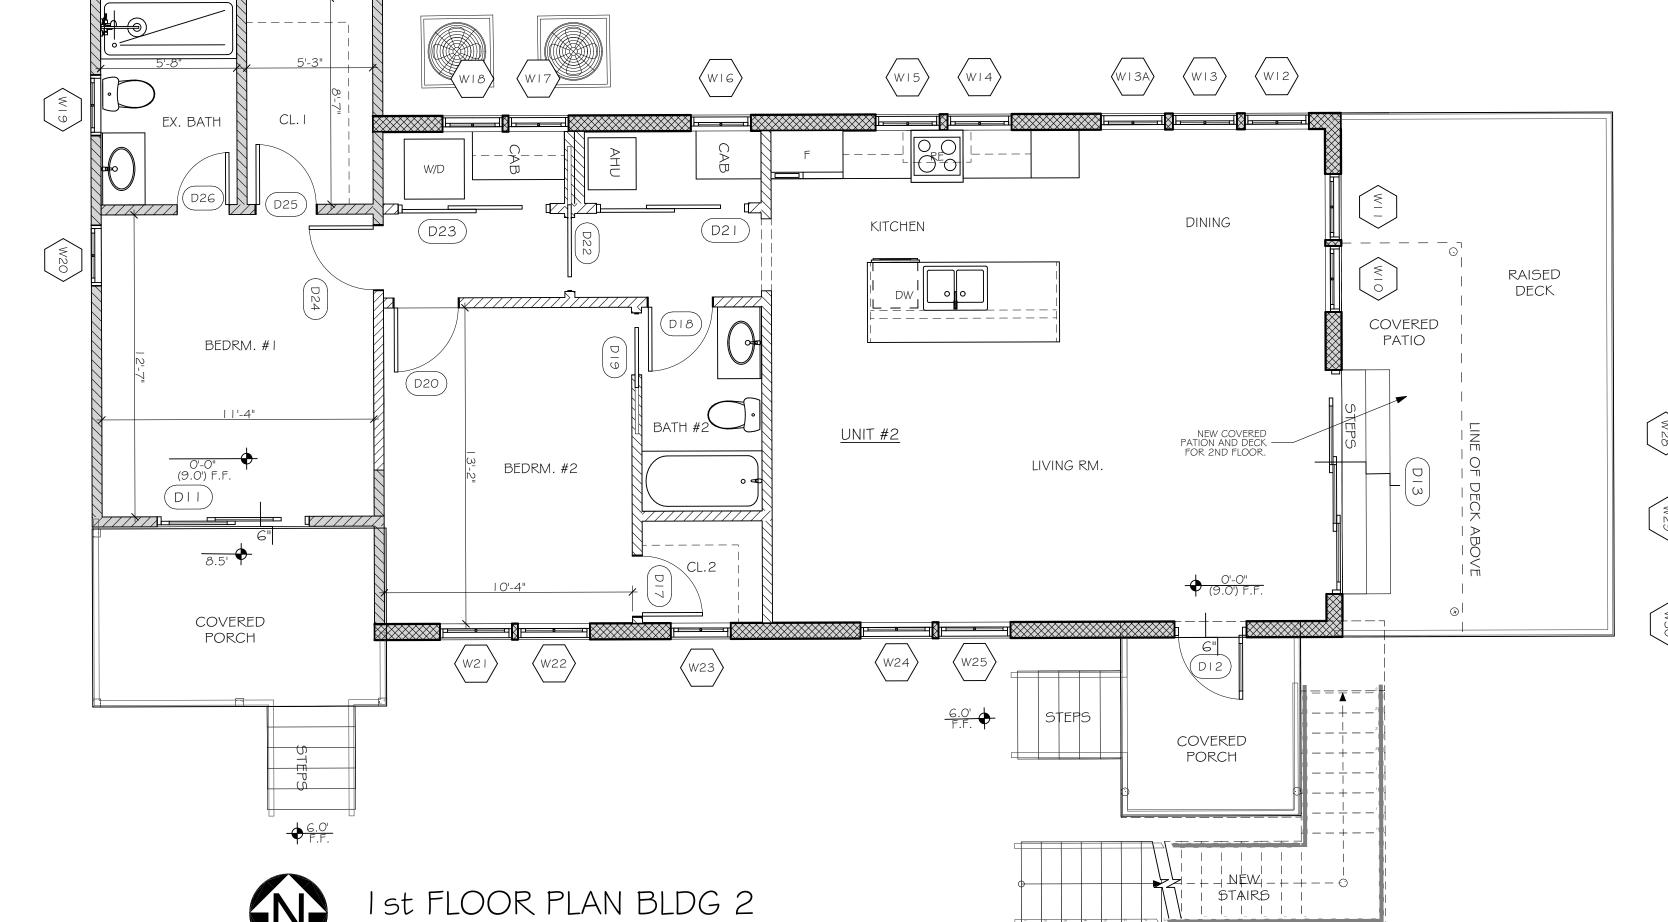

PROPOSED 2 BED / 2 BATH

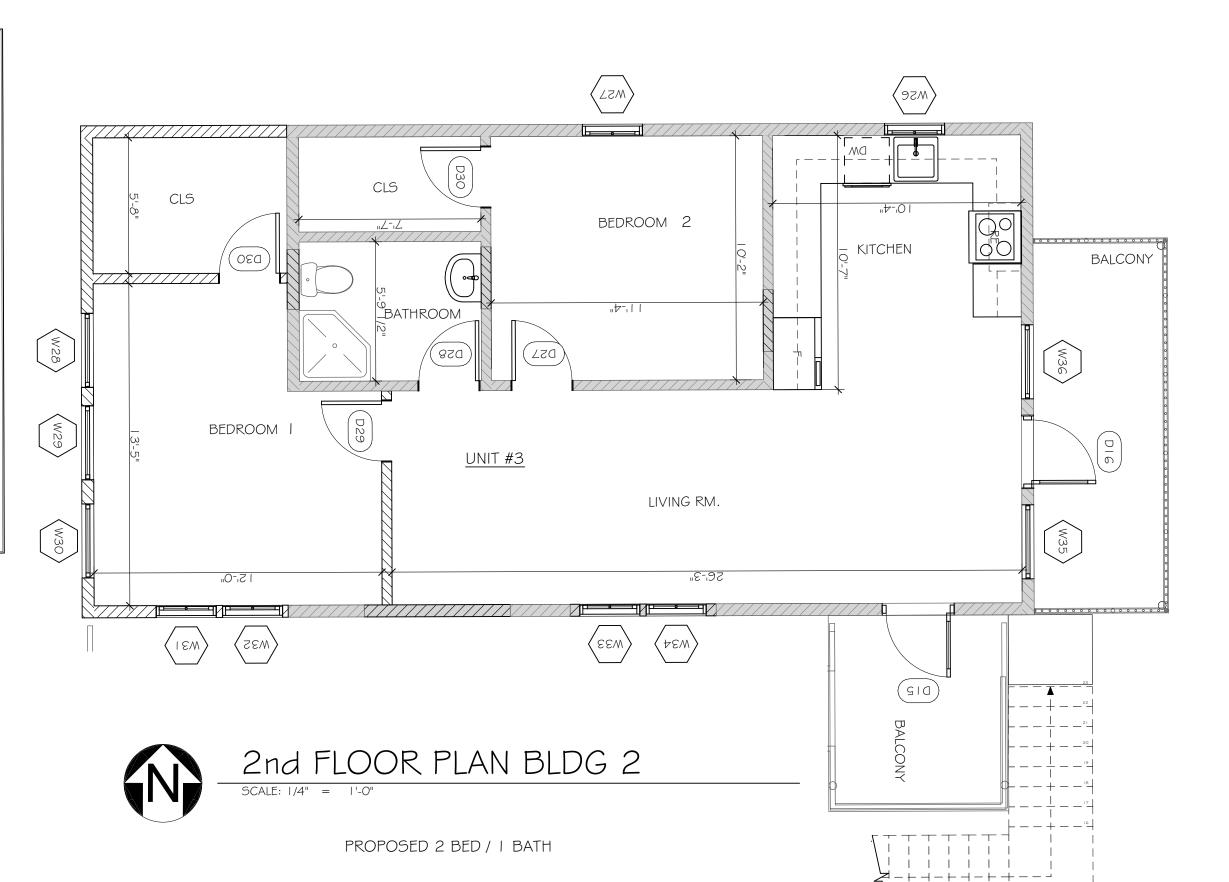



ARCHITECTURE 1010 GATEWAY BLVD. BOYNTON BEACH, FL 33426 PH. 561.880.7894 Steve@stevesiebert.com

www.stevesiebert.com

SEAL STEVEN W. SIEBERT FLORIDA AR0017834

NEW JERSEY 21AI01517500 TEXAS 26934

.70'-2"

.20'-1"

...3'-9" .66'-0"

(EAST):

(NORTH):

(SOUTH):

C.O.A. DRAWINGS

THE WRITTEN DIMENSIONS ON THESE DRAWINGS SHALL TAKE PRECEDENCE OVER SCALED DIMENSIONS. THE CONTRACTOR SHALL VERIFY AND BE RESPONSIBLE FOR ALL DIMENSIONS AND CONDITIONS ON THE JOB, AND THIS OFFICE MUST BE NOTIFIED OF ANY VARIATION FROM THE DIMENSIONS. COPYRIGHT STEVE SIEBERT ARCHITECTURE-UNAUTHORIZED REPRODUCTION OR ANY OTHER USE OF THIS DRAWING IS PROHIBITED.


PROJECT NO: 22-429 4.10.23 DATE: DRAWN BY: BT CHECKED BY: SK

REVISIONS: 4 CITY COMMENTS (3.18.25) 5 CITY COMMENTS (5.14.25) 6 CITY COMMENTS (8.8.25)

FLOOR PLAN(S) BLDG 2

EXISTING WEST ELEVATION BLDG 2

SCALE: 3/16" = 1'-0"

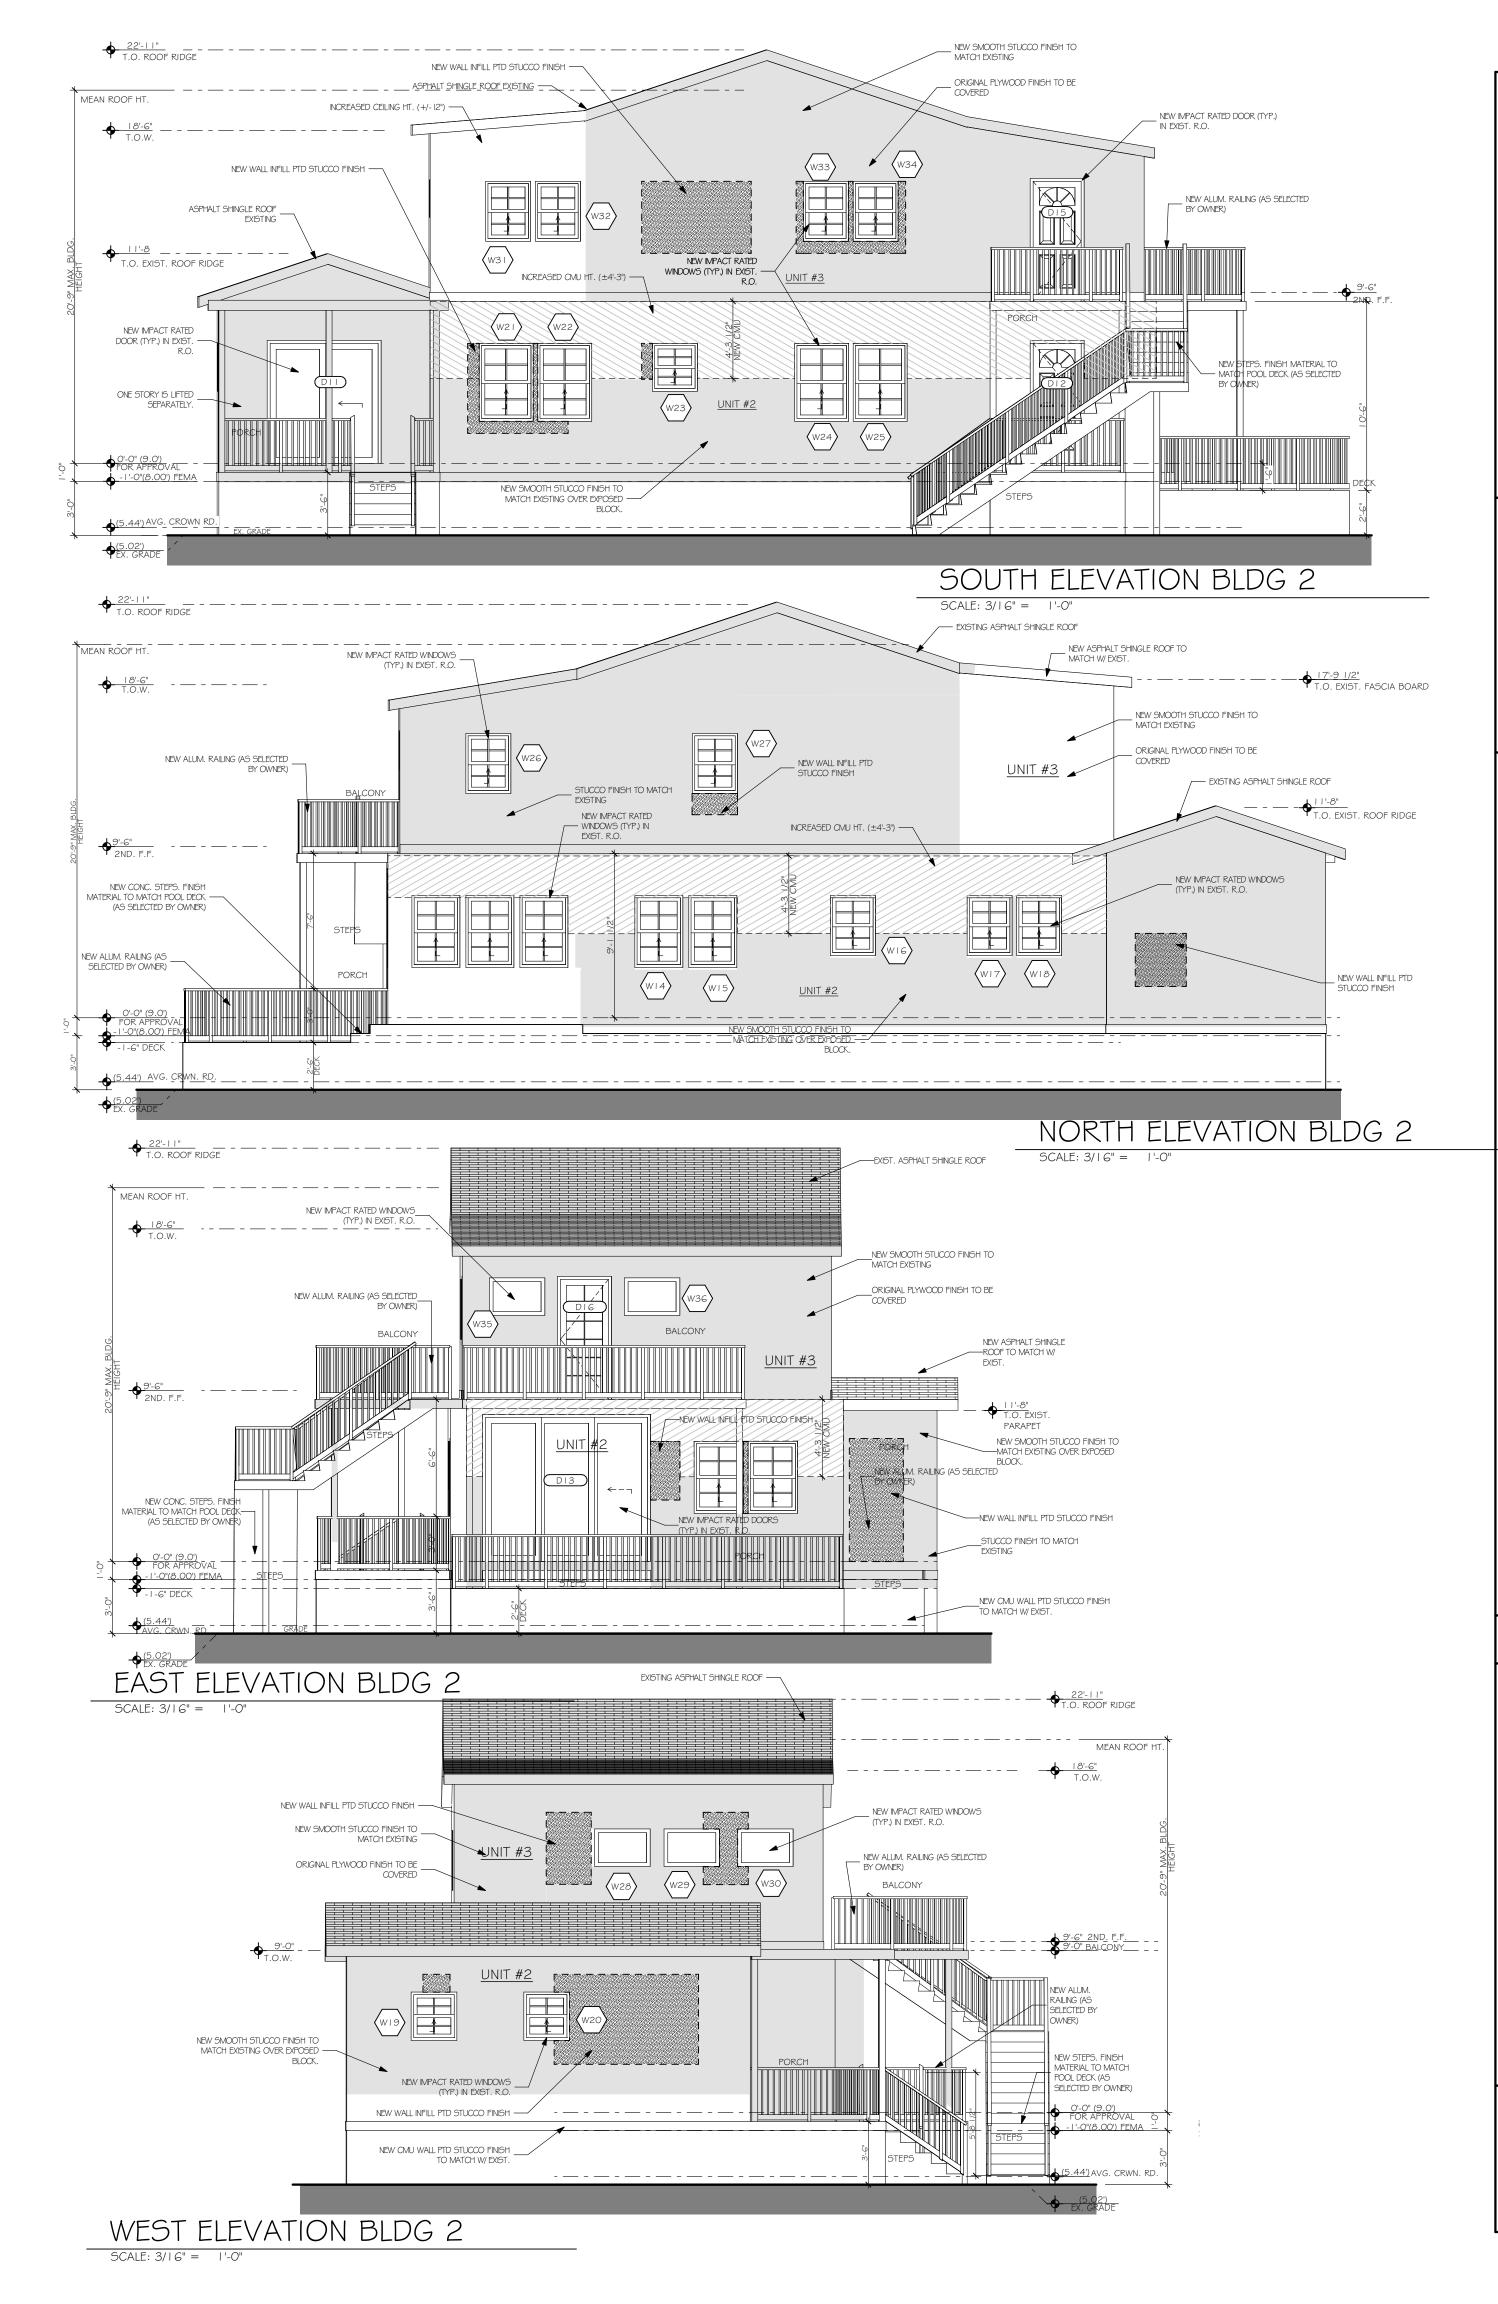

STEVE SIEBERT
ARCHITECTURE

1010 GATEWAY BLVD.
BOYNTON BEACH, FL 33426
PH. 561.880.7894
Steve@stevesiebert.com



www.stevesiebert.com

VAING REVIDENC139/143 SE 7TH AVE DEL RAY REACH EL 33483


C.O.A. DRAWINGS

THE WRITTEN DIMENSIONS ON THESE DRAWINGS SHALL TAKE PRECEDENCE OVER SCALED DIMENSIONS.
THE CONTRACTOR SHALL VERIFY AND BE RESPONSIBLE FOR ALL DIMENSIONS AND CONDITIONS ON THE JOB, AND THIS OFFICE MUST BE NOTIFIED OF ANY VARIATION FROM THE DIMENSIONS.
COPYRIGHT STEVE SIEBERT ARCHITECTURE-UNAUTHORIZED REPRODUCTION OR ANY OTHER USE OF THIS DRAWING IS PROHIBITED.

A CITY COMMENTS (3.18.25)
CITY COMMENTS (5.14.25)
CITY COMMENTS (8.8.25)

ELEVATIONS BLDG 2

12.2

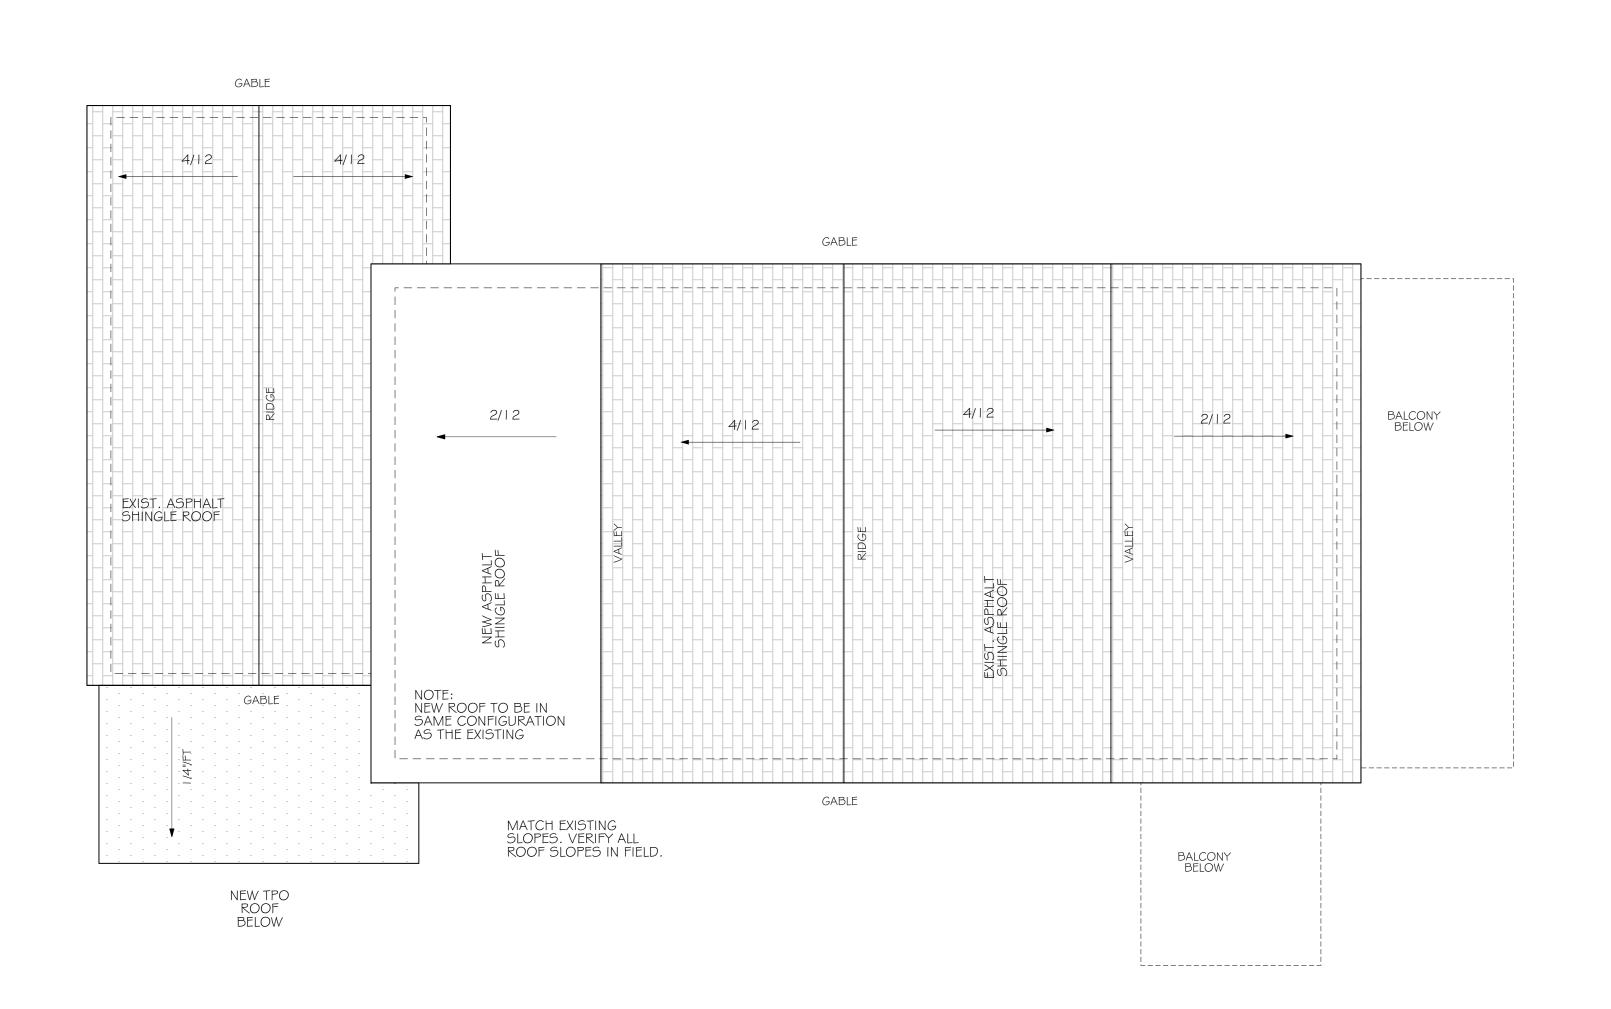





PH. 561.880.7894
Steve@stevesiebert.com
www.stevesiebert.com

BOYNTON BEACH, FL 33426

STEVEN W. SIEBERT
FLORIDA AR0017834

FLORIDA AR0017834 NEW JERSEY 21AI01517500 TEXAS 26934

ENCE

139/143 SE 7TH AVE DELRAY BEACH, FL 33483

C.O.A. DRAWINGS

THE WRITTEN DIMENSIONS ON THESE DRAWINGS SHALL TAKE PRECEDENCE OVER SCALED DIMENSIONS.
THE CONTRACTOR SHALL VERIFY AND BE RESPONSIBLE FOR ALL DIMENSIONS AND CONDITIONS ON THE JOB, AND THIS OFFICE MUST BE NOTIFIED OF ANY VARIATION FROM THE DIMENSIONS.
COPYRIGHT STEVE SIEBERT

THE DIMENSIONS.
COPYRIGHT STEVE SIEBERT
ARCHITECTURE-UNAUTHORIZED
REPRODUCTION OR ANY OTHER USE
OF THIS DRAWING IS PROHIBITED.

PROJECT NO: 22-429

DATE: 4.10.23


DRAWN BY: BT


CHECKED BY: SK

6 CITY COMMENTS (8.8.25)

ROOF PLAN

42.3

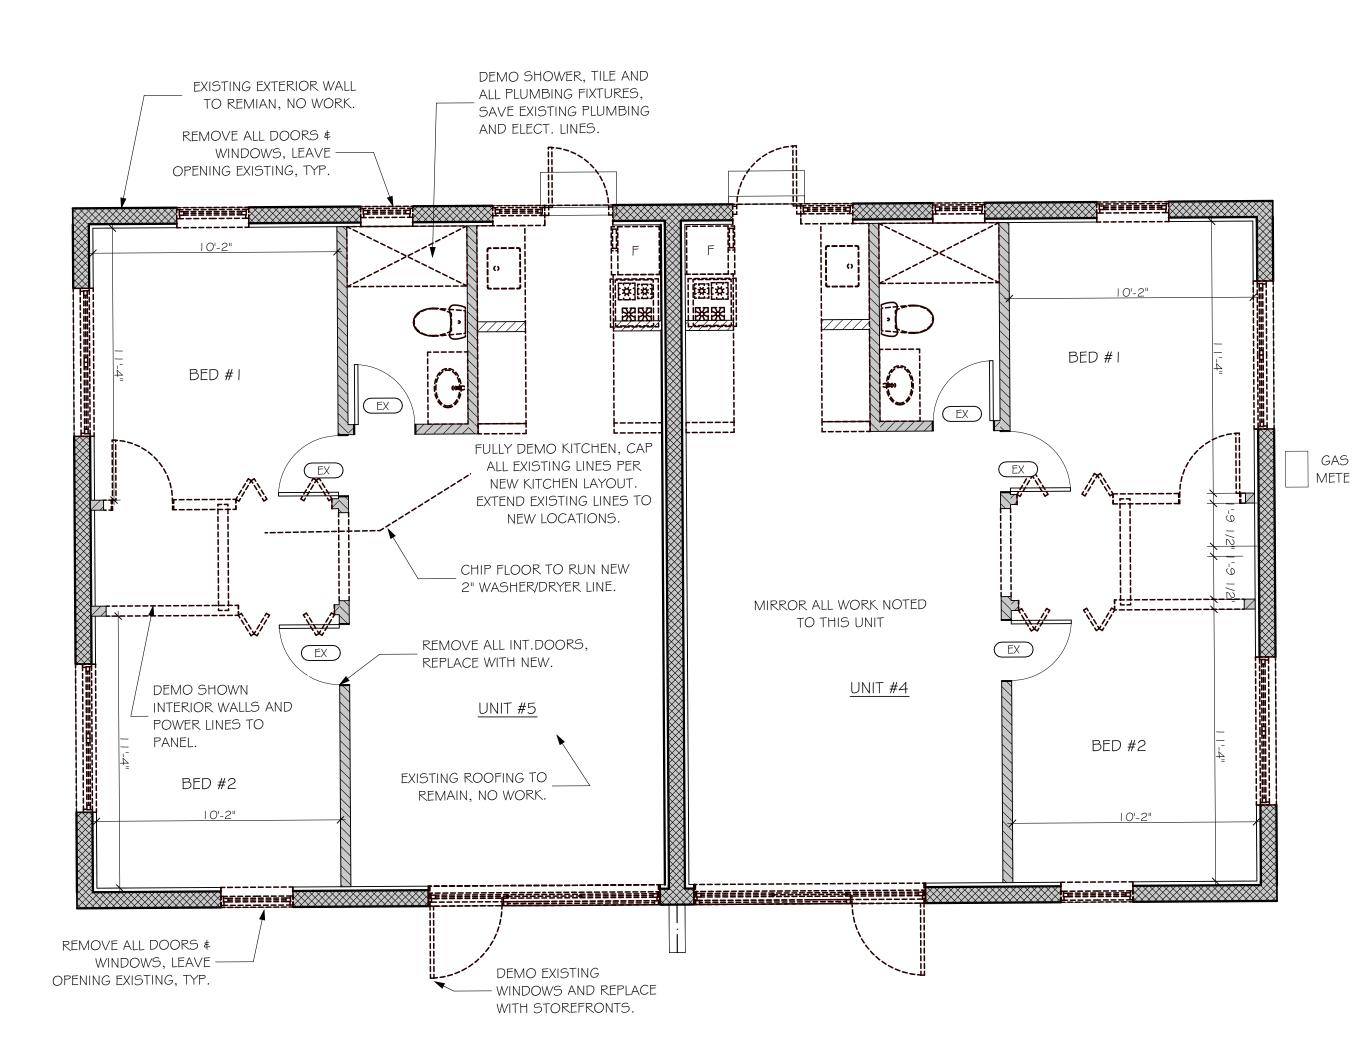

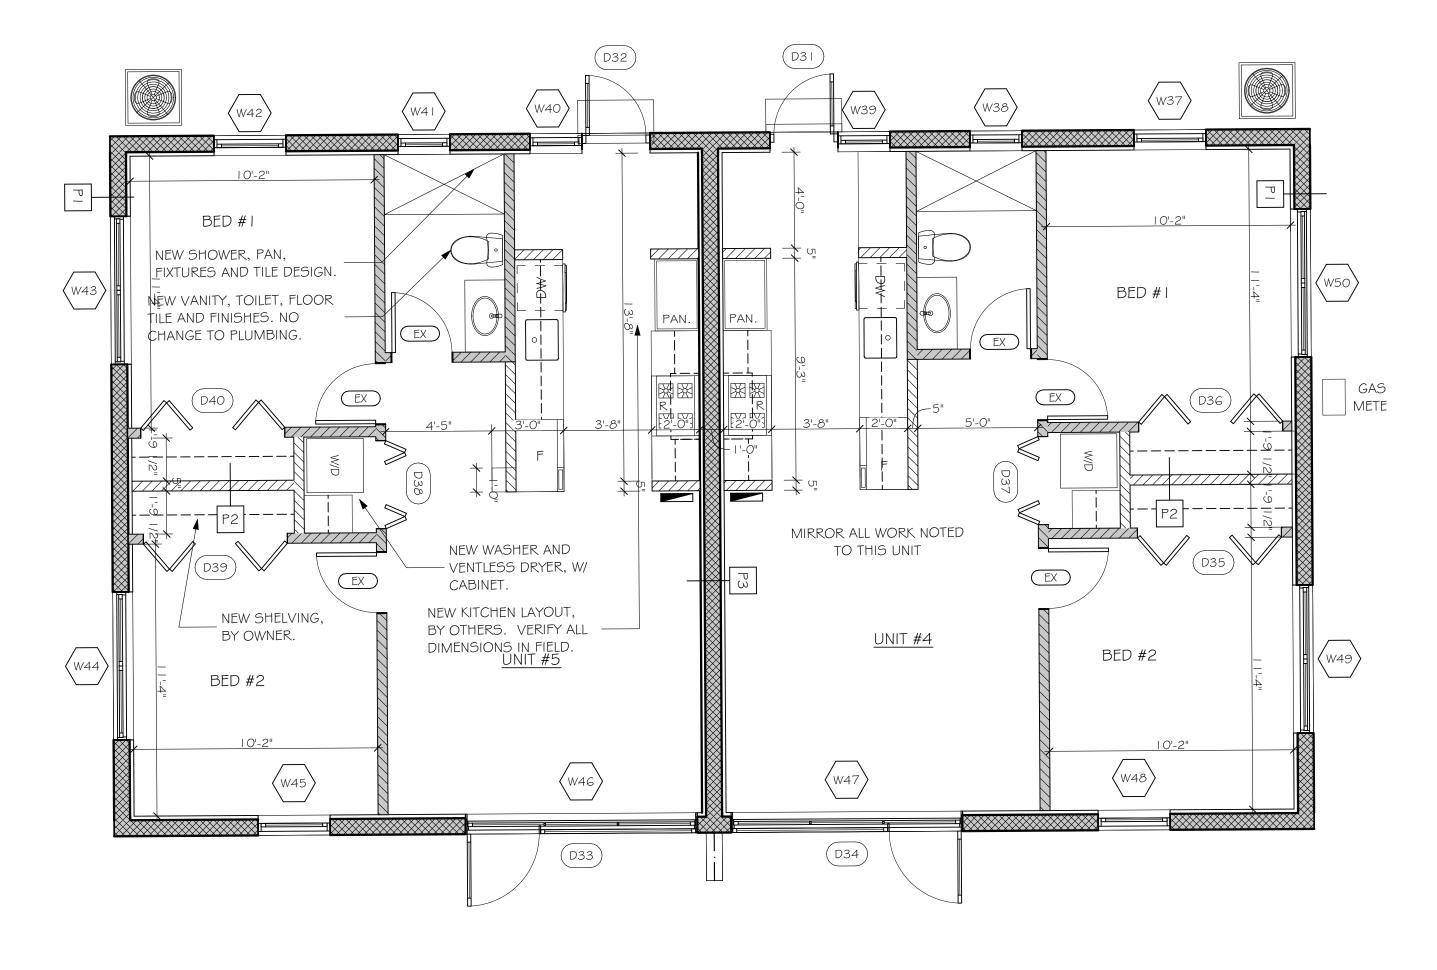





PROPOSED = 2 BED / I BATH

SETBACKS:	
(WEST):	
(EAST):	
(NORTH):	
(SOUTH):	



ARCHITECTURE

1010 GATEWAY BLVD.

BOYNTON BEACH, FL 33426

PH. 561.880.7894

Steve@stevesiebert.com

www.stevesiebert.com



STEVEN W. SIEBERT

FLORIDA AR0017834

NEW JERSEY 21AI01517500

TEXAS 26934

139/143 SE 7TH AVE DELRAY BEACH, FL 33483

C.O.A. DRAWINGS

THE WRITTEN DIMENSIONS ON THESE DRAWINGS SHALL TAKE PRECEDENCE OVER SCALED DIMENSIONS.
THE CONTRACTOR SHALL VERIFY AND BE RESPONSIBLE FOR ALL DIMENSIONS AND CONDITIONS ON THE JOB, AND THIS OFFICE MUST BE NOTIFIED OF ANY VARIATION FROM THE DIMENSIONS.
COPYRIGHT STEVE SIEBERT ARCHITECTURE-UNAUTHORIZED

PROJECT NO: 22-429

DATE: 4.10.23

REPRODUCTION OR ANY OTHER USE OF THIS DRAWING IS PROHIBITED.

DRAWN BY: BT

CHECKED BY: SK

REVISIONS:

A CITY COMMENTS (3.18.25)


S CITY COMMENTS (5.14.25)

CITY COMMENTS (8.8.25)

FLOOR PLAN BLDG 3


A 3.1

BUILDING #3; UNIT 6

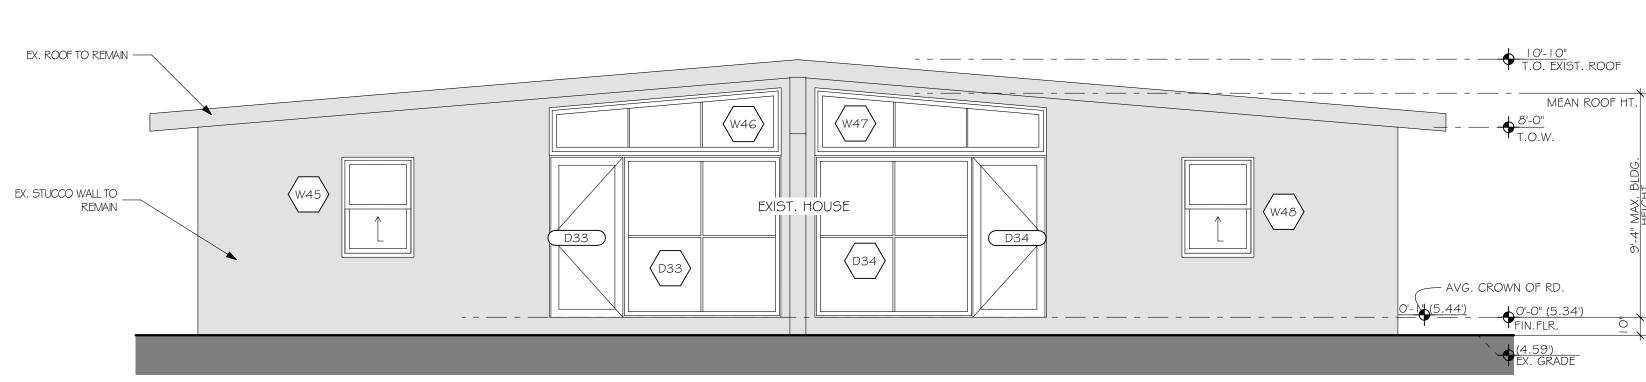



SOUTH ELEVATION BLDG 3

GRAY HATCH INDICATES EXISTING TO REMAIN, NO WORK

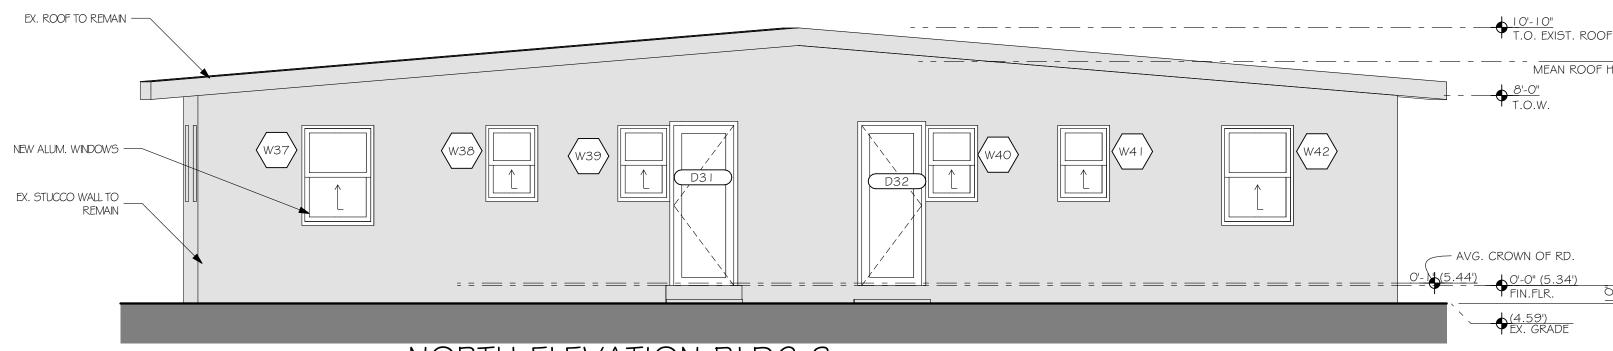

NORTH ELEVATION BLDG 3

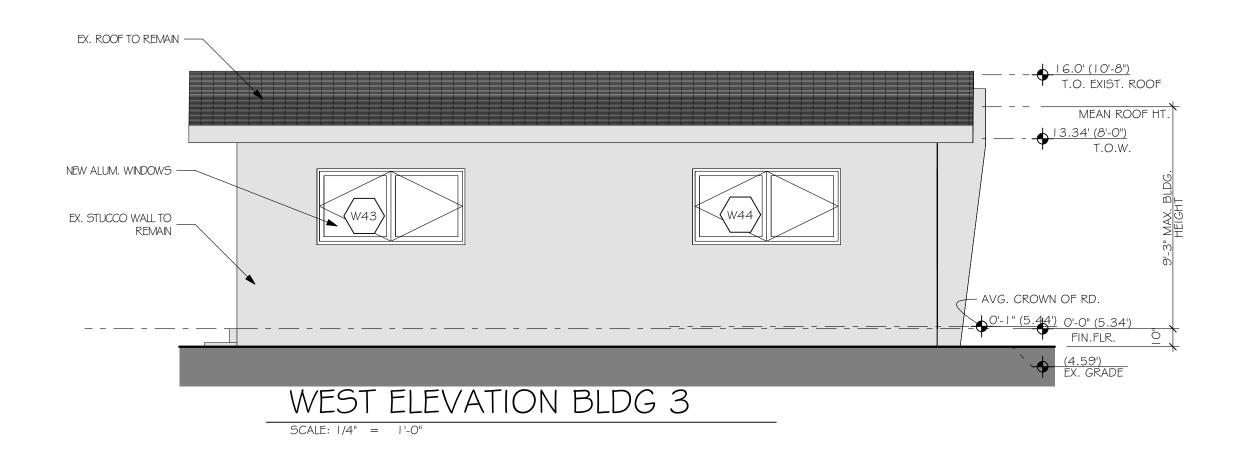

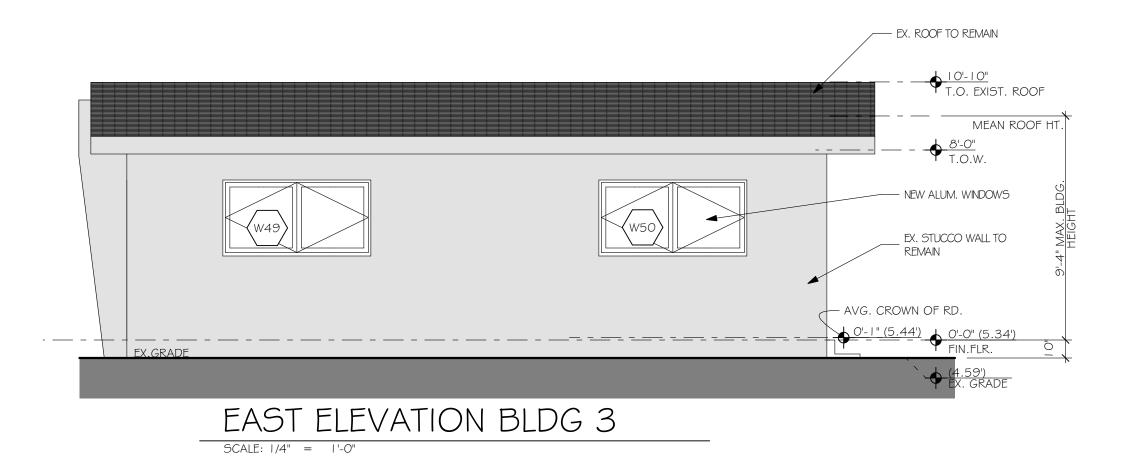


KEY ARCHITECTURAL NOTES:

NO CHANGE TO EXTERIOR OF EXISTING BUILDING
 REPLACE EXISTING DOORS AND WINDOWS WITH NEW IMPACT RATED WINDOWS AND DOORS, OF SAME STYLE AND SIZE, IN EXISTING ROUGH OPENINGS. (VERIFY IN FIELD)



STEVE SIEBERT ARCHITECTURE 1010 GATEWAY BLVD. BOYNTON BEACH, FL 33426 PH. 561.880.7894

Steve@stevesiebert.com www.stevesiebert.com

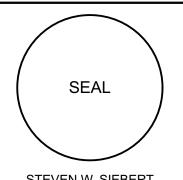

STEVEN W. SIEBERT

FLORIDA AR0017834

NEW JERSEY 21AI01517500

TEXAS 26934

NEW JERSEY 21AI01517500 TEXAS 26934

> 139/143 SE 7TH AVE DELRAY BEACH, FL 33483

C.O.A. DRAWINGS

THE WRITTEN DIMENSIONS ON THESE DRAWINGS SHALL TAKE PRECEDENCE OVER SCALED DIMENSIONS.

THE CONTRACTOR SHALL VERIFY AND BE RESPONSIBLE FOR ALL DIMENSIONS AND CONDITIONS ON THE JOB, AND THIS OFFICE MUST BE NOTIFIED OF ANY VARIATION FROM

NOTIFIED OF ANY VARIATION FROM THE DIMENSIONS.
COPYRIGHT STEVE SIEBERT ARCHITECTURE-UNAUTHORIZED REPRODUCTION OR ANY OTHER USE OF THIS DRAWING IS PROHIBITED.

PROJECT NO: 22-429

DATE: 4.10.23

DRAWN BY: BT

S CITY COMMENTS (5.14.25)
CITY COMMENTS (8.8.25)

ELEVATIONS BLDG 3

43.2

BUILDING #3





ARCHITECTURE

1010 GATEWAY BLVD.

BOYNTON BEACH, FL 33426

PH. 561.880.7894 Steve@stevesiebert.com www.stevesiebert.com

SEAL
STEVEN W. SIEBERT

FLORIDA AR0017834 NEW JERSEY 21AI01517500 TEXAS 26934

TEXAS 26934

139/143 SE 7TH AVE DELRAY BEACH, FL 33483

C.O.A. DRAWINGS

THE WRITTEN DIMENSIONS ON THESE DRAWINGS SHALL TAKE PRECEDENCE OVER SCALED DIMENSIONS.
THE CONTRACTOR SHALL VERIFY AND BE RESPONSIBLE FOR ALL DIMENSIONS AND CONDITIONS ON THE IOD AND THIS OFFICE MUST BE

THE JOB, AND THIS OFFICE MUST BE NOTIFIED OF ANY VARIATION FROM THE DIMENSIONS.

COPYRIGHT STEVE SIEBERT ARCHITECTURE-UNAUTHORIZED REPRODUCTION OR ANY OTHER USE

OF THIS DRAWING IS PROHIBITED.


PROJECT NO: 22-429

DATE: 4.10.23


DRAWN BY: BT
CHECKED BY: SK

ROOF PLAN

43.3

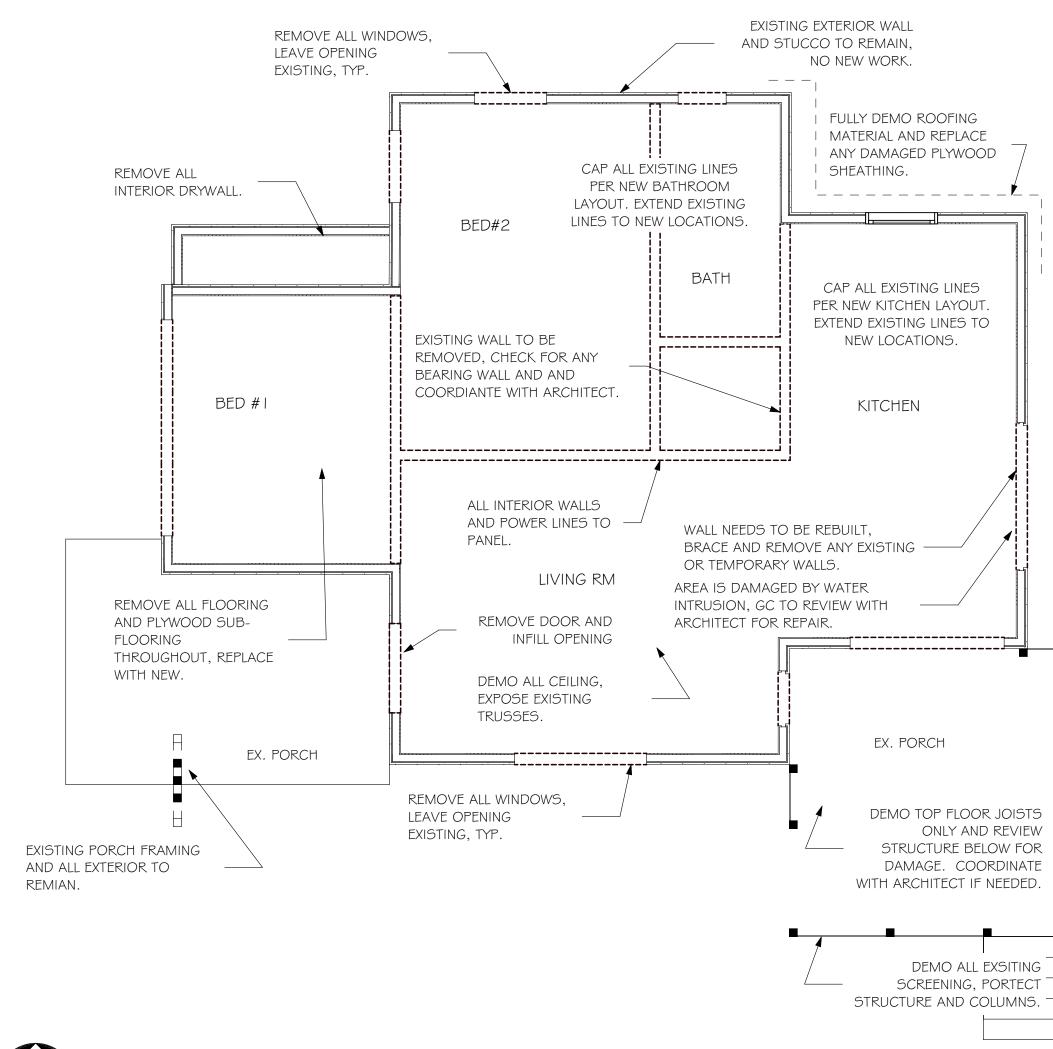



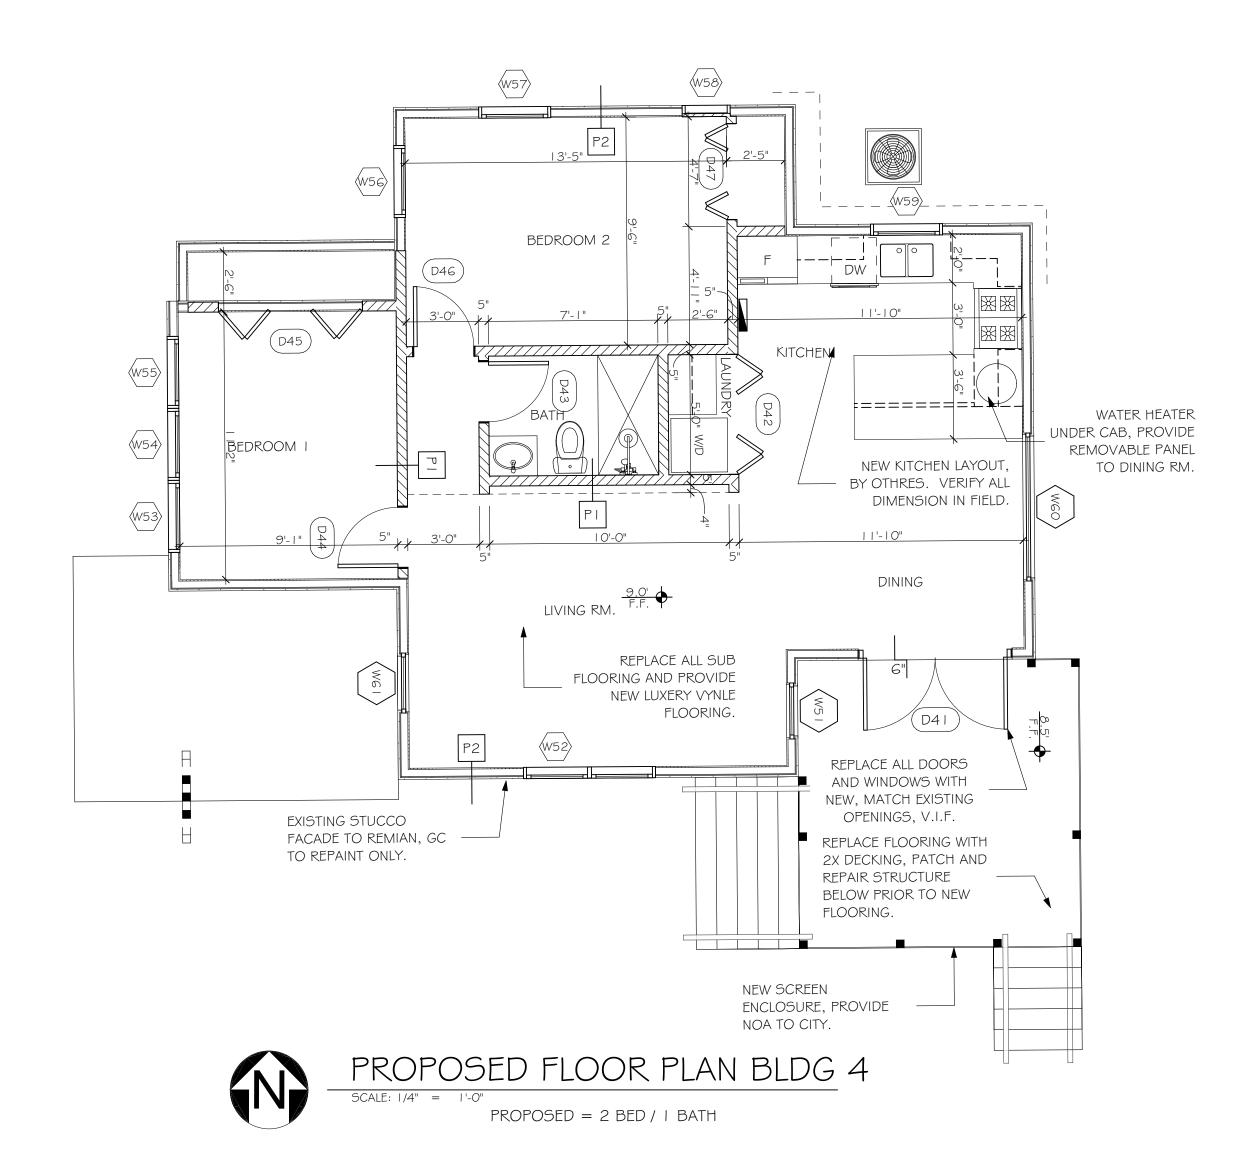


SETBACKS:

WEST):	27'-0"
EAST):	78'-4"
NORTH):	4'- "
SOUTH):	60'-7"



STEVE SIEBERT ARCHITECTURE 1010 GATEWAY BLVD. BOYNTON BEACH, FL 33426

> PH. 561.880.7894 Steve@stevesiebert.com www.stevesiebert.com

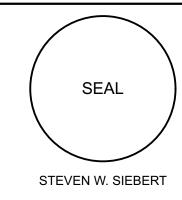

FLORIDA AR0017834
NEW JERSEY 21AI01517500
TEXAS 26934

NEW JERSEY 21AI01517 TEXAS 26934

AING REACH FI 33483139/143 SE 7TH AVE

C.O.A. DRAWINGS

THE WRITTEN DIMENSIONS ON THESE DRAWINGS SHALL TAKE PRECEDENCE OVER SCALED DIMENSIONS.
THE CONTRACTOR SHALL VERIFY AND BE RESPONSIBLE FOR ALL DIMENSIONS AND CONDITIONS ON THE JOB, AND THIS OFFICE MUST BE

NOTIFIED OF ANY VARIATION FROM THE DIMENSIONS.
COPYRIGHT STEVE SIEBERT ARCHITECTURE-UNAUTHORIZED REPRODUCTION OR ANY OTHER USE OF THIS DRAWING IS PROHIBITED.

PROJECT NO: 22-429


DATE: 4.10.23


DRAWN BY: BT


5\ CITY COMMENTS (5.14.25)
CITY COMMENTS (8.8.25)

FLOOR PLAN BUIDLING 4

A4.1

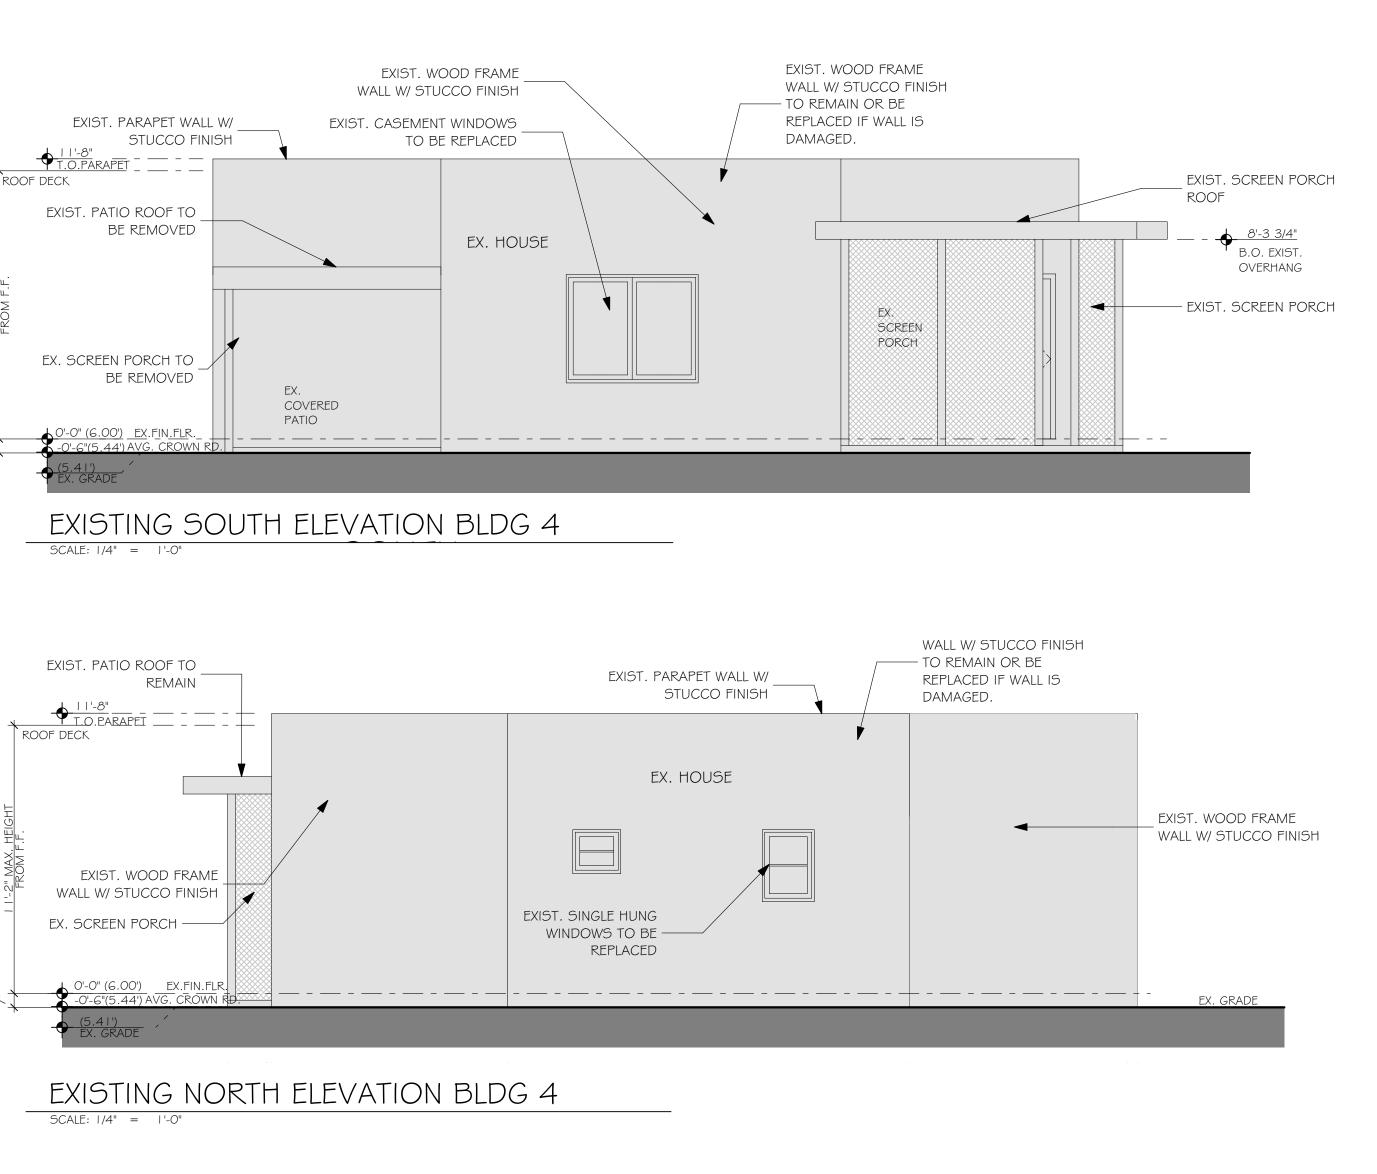

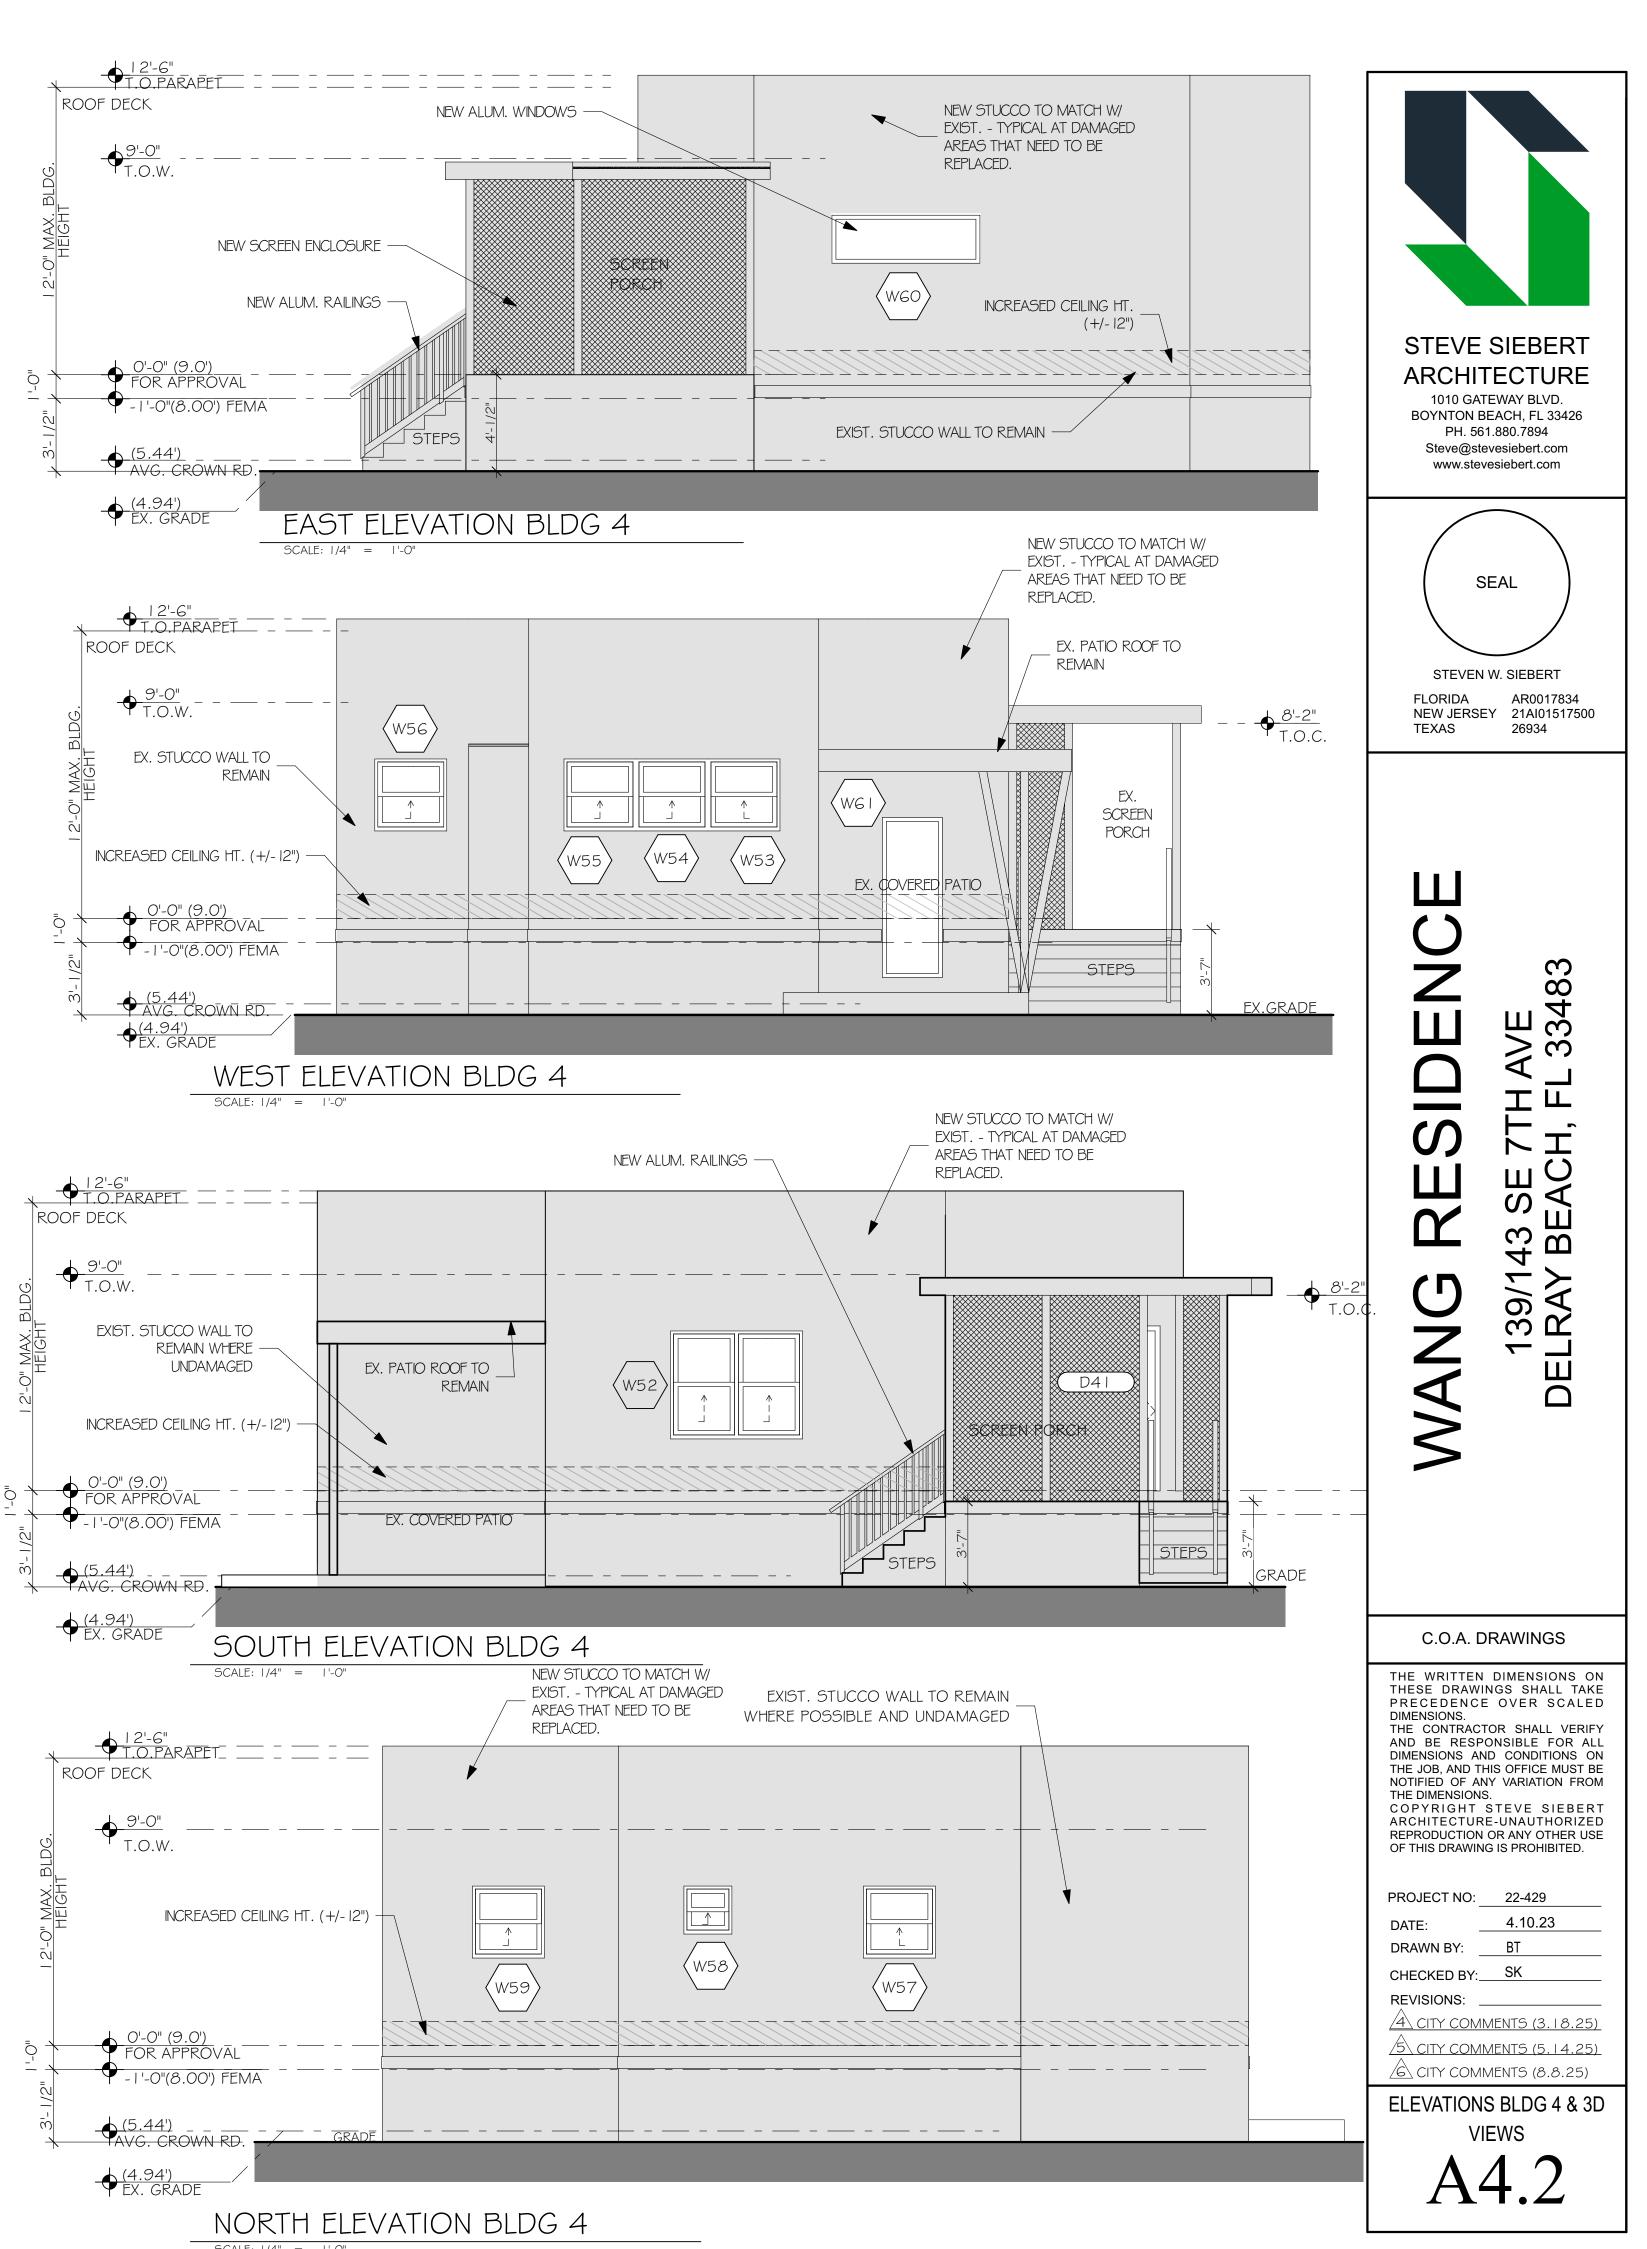

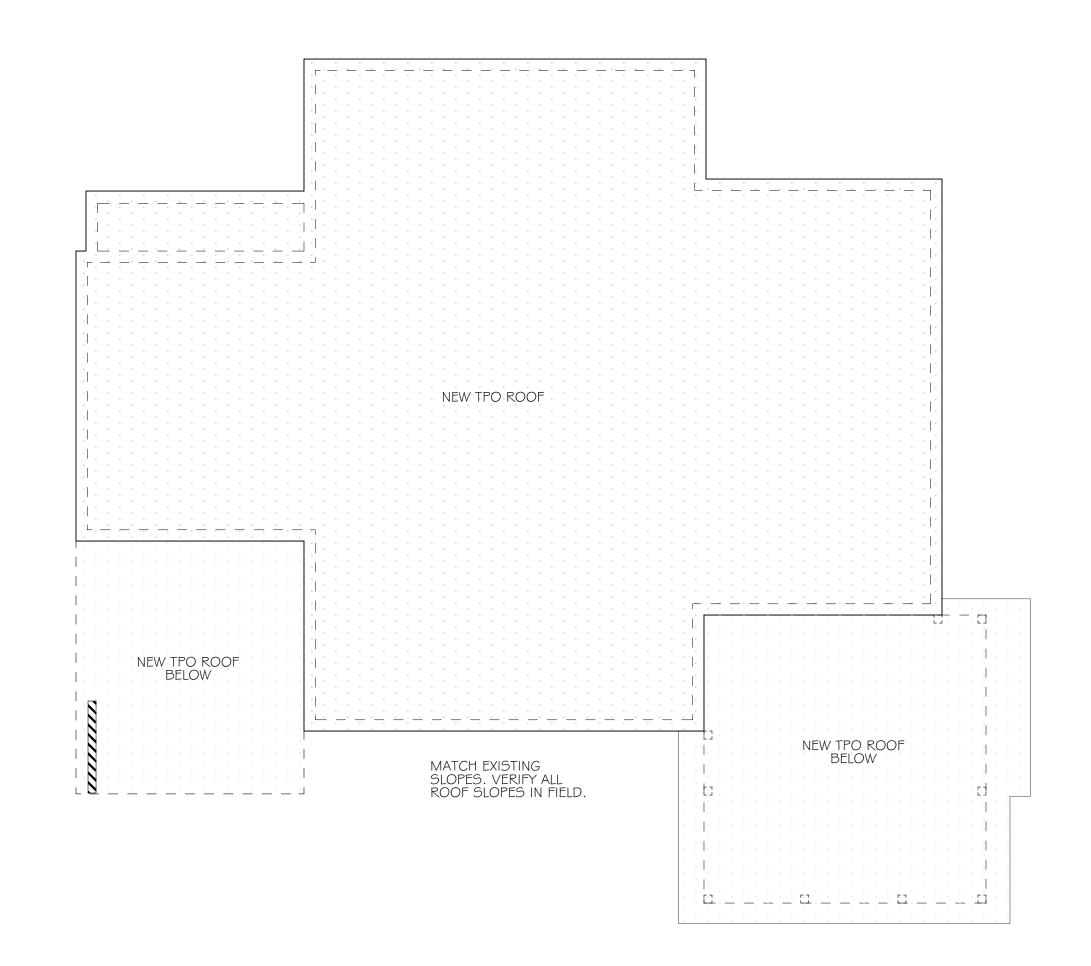





STEVE SIEBERT ARCHITECTURE 1010 GATEWAY BLVD. BOYNTON BEACH, FL 33426

PH. 561.880.7894
Steve@stevesiebert.com
www.stevesiebert.com

SEAL

STEVEN W. SIEBERT
FLORIDA AR0017834

FLORIDA AR0017834 NEW JERSEY 21AI01517500 TEXAS 26934

139/143 SE 7TH AVE DELRAY BEACH, FL 33483

C.O.A. DRAWINGS

THE WRITTEN DIMENSIONS ON THESE DRAWINGS SHALL TAKE PRECEDENCE OVER SCALED DIMENSIONS.
THE CONTRACTOR SHALL VERIFY AND BE RESPONSIBLE FOR ALL DIMENSIONS AND CONDITIONS ON THE JOB, AND THIS OFFICE MUST BE

THE JOB, AND THIS OFFICE MUST BE NOTIFIED OF ANY VARIATION FROM THE DIMENSIONS.

COPYRIGHT STEVE SIEBERT ARCHITECTURE-UNAUTHORIZED REPRODUCTION OR ANY OTHER USE OF THIS DRAWING IS PROHIBITED.

PROJECT NO: 22-429

DATE: 4.10.23

DRAWN BY: BT

CHECKED BY: SK


REVISIONS:


A CITY COMMENTS (3.18.25)

S CITY COMMENTS (5.14.25)

ROOF PLAN

Δ43

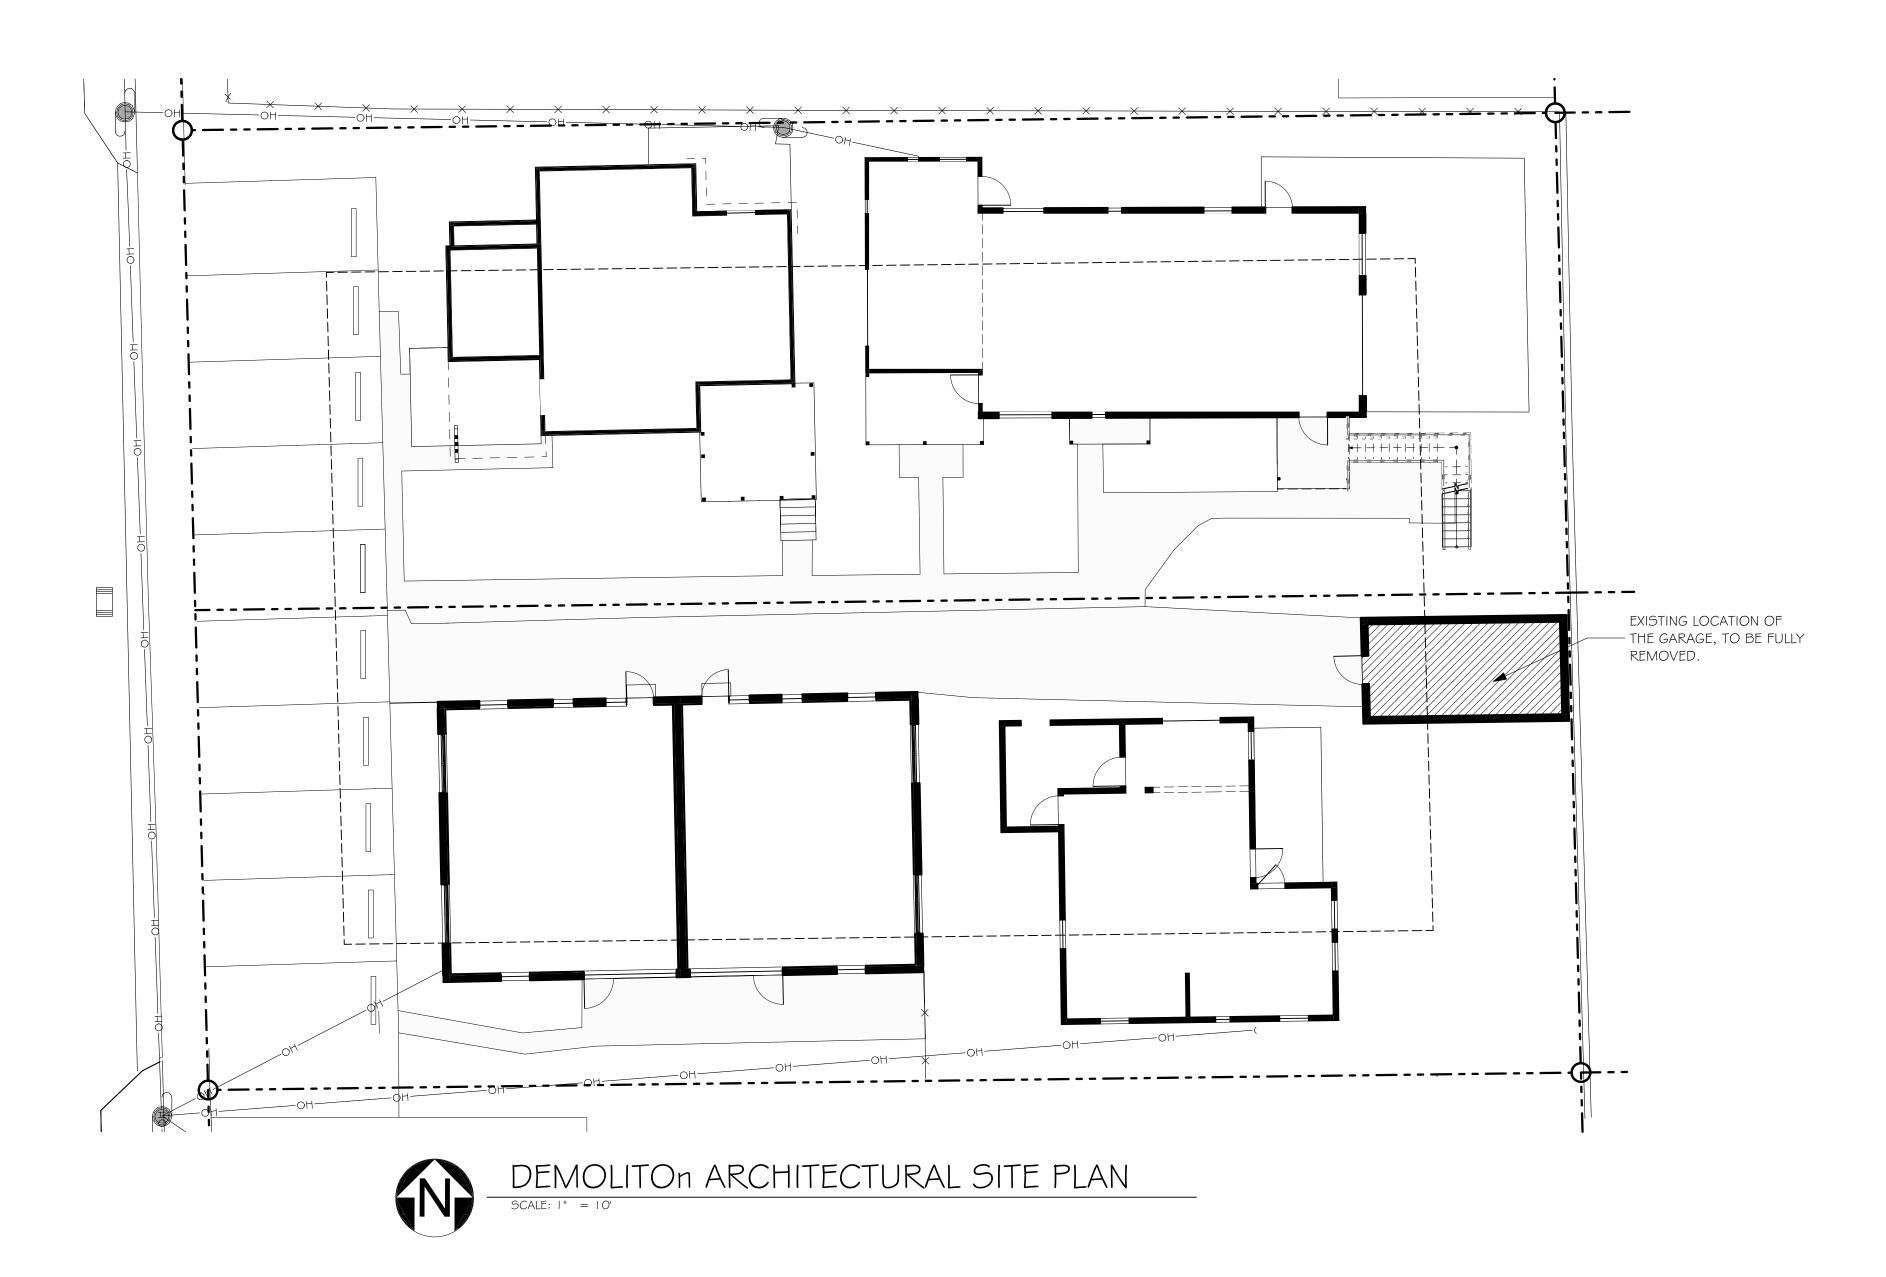

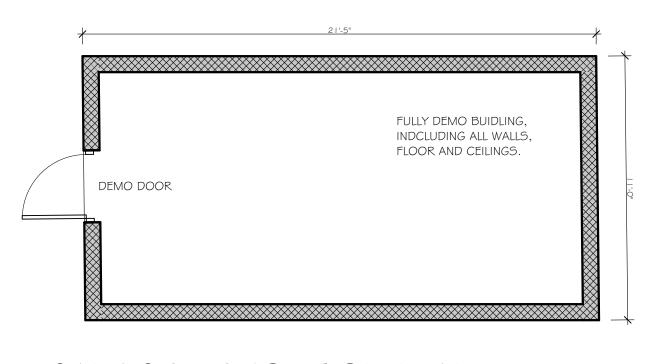

GARAGE DEMOLITION PLAN





EXISTING ELEVATIONS

SCALE: 1/4" = 1'-0"



STEVE SIEBERT

ARCHITECTURE

1010 GATEWAY BLVD.

BOYNTON BEACH, FL 33426

PH. 561.880.7894 Steve@stevesiebert.com www.stevesiebert.com

STEVEN W. SIEBERT

FLORIDA AR0017834

NEW JERSEY 21AI01517500

139/143 SE 7TH AVE

C.O.A. DRAWINGS

THE WRITTEN DIMENSIONS ON THESE DRAWINGS SHALL TAKE PRECEDENCE OVER SCALED DIMENSIONS.
THE CONTRACTOR SHALL VERIFY AND BE RESPONSIBLE FOR ALL DIMENSIONS AND CONDITIONS ON

NOTIFIED OF ANY VARIATION FROM THE DIMENSIONS.
COPYRIGHT STEVE SIEBERT ARCHITECTURE-UNAUTHORIZED REPRODUCTION OR ANY OTHER USE OF THIS DRAWING IS PROHIBITED.

THE JOB, AND THIS OFFICE MUST BE

PROJECT NO: 22-429

DATE: 4.10.23

DRAWN BY: BT

CHECKED BY: SK

REVISIONS:

A CITY COMMENTS (3.18.25)

S CITY COMMENTS (5.14.25)


CITY COMMENTS (8.8.25)

GARAGE DEMOLITION


A44


						DOOR SCHEDULE					
ID	W	HT	THK	MATERIAL	REQUIRED PRESSURES (PSF)	APPROVED PRESSURES (PSF)	PRODUCT APPROVAL	TYPE	HRDWR GROUP	COLOR	COMMENTS
DOI	2'-6"	6'-8"	13/4"	SC WD	PER PLAN	PER NOA	17-1226.05	А	LOCK	WHT	HALF LITE
D02	6'-0"	8'-0"	13/4"	SC WD	PER PLAN	PER NOA	20-0429.10	С	MANU	WHT	SLIDING GLS. DOORS
D03	6'-0"	8'-0"	13/4"	SC WD	PER PLAN	PER NOA	20-0429.10	С	MANU	WHT	SLIDING GLS. DOORS
DO4A	2'-0"	6'-8"	13/4"	SC WD	-	-	=	В	PASS	-	
DO4B	2'-0"	6'-8"	13/4"	SC WD	-	-	=	В	PASS	-	
D05	2'-6"	6'-8"	13/4"	SC WD	-	-	-	D	PRIV	-	
D06	3'-0"	6'-8"	13/4"	SC WD	-	-	-	В	PASS	-	
D07	3'-0"	6'-8"	13/4"	SC WD	-	-	-	E	MANU	-	BIFOLD
D08	2'-8"	6'-8"	13/4"	SC WD	-	-	-	В	PRIV	-	
D09	2'-8"	6'-8"	13/4"	SC WD	-	-	-	В	PRIV	-	
DIOA	2'-8"	6'-8"	13/4"	SC WD	-	-	-	F	MANU	-	POCKET
DIOB	2'-8"	6'-8"	13/4"	SC WD	-	-	-	В	PRIV	-	
DII	6'-0"	6'-8"	MANU	SC WD/GLS	PER PLAN	PER NOA	20-0429.10	С	MANU	WHT	SLIDING GLS DOOR
DI2	2'-8"	6'-8"	1 3/4"	ALUM/GLS	PER PLAN	PER NOA	17-1226.05	А	LOCK	WHT	SNGL LITE
DI3	9'-0"	8'-0"	MANU	ALUM/GLS	PER PLAN	PER NOA	20-0429.10	С	MANU	WHT	SLIDING GLS DOOR
DI5	2'-8"	6'-8"	1 3/4"	SC WD	PER PLAN	PER NOA	17-1226.05	А	LOCK	WHT	SNGL LITE
DI6	2'-8"	6'-8"	1 3/4"	SC WD	PER PLAN	PER NOA	17-1226.05	А	LOCK	WHT	SNGL LITE
DI7	2'-6"	6'-8"	1 3/4"	SC WD	-	-	-	В	PRIV	WHT	
DI8	2'-8"	6'-8"	1 3/4"	SC WD	-	-	-	В	PASS	WHT	
D19	2'-6"	6'-8"	1 3/4"	SC WD	-	-	-	F	PRIV	PRIV	POCKET
D20	2'-8"	6'-8"	1 3/4"	SC WD	-	-	-	В	PRIV	WHT	
D21	6'-0"	8'-0"	1 3/4"	SC WD	-	-	-	E	PASS	WHT	DBL BYPASS
D22	3'-0"	6'-8"	1 3/4"	SC WD	-	-	-	F	MANU	WHT	POCKET
D23	6'-0"	8'-0"	1 3/4"	SC WD	-	-	-	E	PASS	WHT	DBL BYPASS
D24	2'-8"	6'-8"	1 3/4"	SC WD	-	-	-	В	PRIV	WHT	
D25	2'-6"	6'-8"	1 3/4"	SC WD	-	-	-	В	PASS	WHT	
D26	2'-2"	6'-8"	1 3/4"	SC WD	-	-	-	В	PRIV	WHT	
D27	2'-6"	8'-0"	1 3/4"	SC WD	-	-	-	В	PRIV	WHT	
D28	2'-6"	8'-0"	1 3/4"	SC WD	-	-	-	В	PRIV	WHT	
D29	2'-6"	8'-0"	1 3/4"	SC WD	-	-	-	В	PRIV	WHT	
D30	2'-6"	8'-0"	1 3/4"	SC WD	-	-	-	В	PASS	WHT	
D3 I	2'-6"	6'-8"	1 3/4"	SC WD	PER PLAN	+/-80	17-1226.05	А	LOCK	WHT	SNGL LITE
D32	2'-6"	6'-8"	1 3/4"	SC WD	PER PLAN	+/-80	17-1226.05	Α	LOCK	WHT	SNGL LITE
D33	3'-0"	6'-8"		SC WD	PER PLAN	+/-80	17-1226.05	А	LOCK	WHT	SNGL LITE
D34	3'-0"	6'-8"		SC WD	PER PLAN	+/-80	17-1226.05	Α	LOCK	WHT	SNGL LITE
D35	6'-0"	8'-0"	1 3/4"	SC WD	-	-	-	В	PASS	WHT	DBL BIFOLD
D36	6'-0"	8'-0"	1 3/4"	SC WD	-	-	-	В	PASS	WHT	DBL BIFOLD
D37	3'-8"	8'-0"	1 3/4"	SC WD	-	-	-	В	PASS	WHT	DBL BIFOLD
D38	3'-8"	8'-0"		SC WD	-	-	-	В	PASS	WHT	DBL BIFOLD
D39	6'-0"	8'-0"	1 3/4"	SC WD	-	-	-	В	PASS	WHT	DBL BIFOLD
D40	6'-0"	8'-0"		SC WD	-	-	-	В	PASS	WHT	DBL BIFOLD
D41	6'-0"	6'-8"		SC WD	PER PLAN	PER NOA	17-1226.05	I	LOCK	DRK BRZ	
D42	5'-0"	6'-8"		SC WD	-	-	-	G	MANU	WHT	DBL BIFOLD
D43	2'-6"	6'-8"		SC WD	-	-	-	D	PRIV	WHT	- · ·
D44	2'-6"	6'-8"		SC WD	-	-	-	D	PRIV	WHT	
D45	6'-0"	6'-8"		SC WD	-	-	-	G	MANU	WHT	DBL BIFOLD
D45	2'-6"	8'-0"		SC WD	_	-	-	D	PRIV	WHT	
	1 20	1 0 20	I' 5/4	100 110	_		-	U	1 1 1 1 1	V V I I I	

						WINDO	W SCHED	ULE:				
ID	W	HT	REQUIRED PRESSURES	APPROVED PRESSURES	PRODUCT APPROVAL	MULLION BARS	TYPE	EGRESS	MATERIAL	GLAZE	COLOR	COMMENTS
WO I	3'-0"	4'-8"	PER PLAN	PER NOA	20-0401.11	Υ	SH3	Υ	ALUM.	CLEAR GLASS	WHT	
WO2	2'-0"	3'-0"	PER PLAN	PER NOA	20-0401.11	N	SH3	N	ALUM.	CLEAR GLASS	WHT	
WO3	3'-0"	4'-8"	PER PLAN	PER NOA	20-0401.11	N	SH3	Υ	ALUM.	CLEAR GLASS	WHT	
W04	3'-0"	4'-8"	PER PLAN	PER NOA	20-0401.11	N	SH3	Υ	ALUM.	CLEAR GLASS	WHT	
W05	3'-0"	4'-8"	PER PLAN	PER NOA	20-0401.11	N	SH3	Υ	ALUM.	CLEAR GLASS	WHT	
W06	3'-0"	4'-8"	PER PLAN	PER NOA	20-0401.11	Y	SH3	N	ALUM.	CLEAR GLASS	WHT	
W07	3'-0"	4'-8"	PER PLAN	PER NOA	20-0401.11	Y	SH3	N	ALUM.	CLEAR GLASS	WHT	
W08	2'-0"	3'-0"	PER PLAN	PER NOA	20-0401.11	N	SH3	N	ALUM.	CLEAR GLASS	WHT	
W09	2'-0"	3'-0"	PER PLAN	PER NOA	20-0401.11	N	SH3	N	ALUM.	CLEAR GLASS	WHT	
WIO	2'-9"	4'-0"	PER PLAN	PER NOA	20-0401.11	N	SH	N	ALUM.	CLEAR GLASS	WHT	
WII	2'-9"	4'-0"	PER PLAN	PER NOA	20-0401.11	N	SH	N	ALUM.	CLEAR GLASS	WHT	
WI2	2'-8"	4'-0"	PER PLAN	PER NOA	20-0401.11	N	SH	N	ALUM.	CLEAR GLASS	WHT	
WI3	2'-8"	4'-0"	PER PLAN	PER NOA	20-0401.11	N	SH	N	ALUM.	CLEAR GLASS	WHT	
WI3A	2'-8"	4'-0"	PER PLAN	PER NOA	20-0401.11	N	SH	N	ALUM.	CLEAR GLASS	WHT	
W14	2'-8"	4'-0"	PER PLAN	PER NOA	20-0401.11	N	SH	N	ALUM.	CLEAR GLASS	WHT	
W15	2'-8"	4'-0"	PER PLAN	PER NOA	20-0401.11	N	SH	N	ALUM.	CLEAR GLASS	WHT	
W16	2'-6"	3'-4"	PER PLAN	PER NOA	20-0401.11	N	SH	N	ALUM.	CLEAR GLASS	WHT	
W17 W18	2'-6"	3'-4" 3'-4"	PER PLAN PER PLAN	PER NOA PER NOA	20-0401.11	N	SH SH	N N	ALUM.	CLEAR GLASS	WHT	
W18 W19	2'-6"	2'-8"	PER PLAN PER PLAN	PER NOA PER NOA	20-0401.11	N N	SH	N	ALUM.	CLEAR GLASS CLEAR GLASS	WHT	
W19 W20	2'-6"	2'-8"	PER PLAN PER PLAN	PER NOA	20-0401.11	N	SH	N	ALUM.	CLEAR GLASS CLEAR GLASS	WHT	
W20 W21	3'-0"	4'-4"	PER PLAN	PER NOA	20-0401.11	N	SH	Y	ALUM.		WHT	
W21 W22	3'-0"	4'-4"	PER PLAN	PER NOA	20-0401.11	N	SH	N	ALUM.	CLEAR GLASS CLEAR GLASS	WHT	
W23	2'-6"	2'-8"	PER PLAN	PER NOA	20-0401.11	N	SH	N	ALUM.	CLEAR GLASS	WHT	
W24	3'-0"	4'-4"	PER PLAN	PER NOA	20-0401.11	N	SH	N	ALUM.	CLEAR GLASS	WHT	
W25	3'-0"	4'-4"	PER PLAN	PER NOA	20-0401.11	N		N	ALUM.	CLEAR GLASS	WHT	
N26	2'-6"	3'-4"	PER PLAN	PER NOA	20-0401.11	N	SH	N	ALUM.	CLEAR GLASS	WHT	
W27	2'-6"	3'-4"	PER PLAN	PER NOA	20-0401.11	N	SH	N	ALUM.	CLEAR GLASS	WHT	
N28	3'-0"	2'-0"	PER PLAN	PER NOA	20-0401.11	N	SH	N	ALUM.	CLEAR GLASS	WHT	
W29	3'-0"	2'-0"	PER PLAN	PER NOA	20-0401.11	N	SH	N	ALUM.	CLEAR GLASS	WHT	
W30	3'-0"	2'-0"	PER PLAN	PER NOA	20-0401.11	N	SH	N	ALUM.	CLEAR GLASS	WHT	
W3 I	2'-6"	3'-4"	PER PLAN	PER NOA	20-0401.11	N	SH	N	ALUM.	CLEAR GLASS	WHT	
W32	2'-6"	3'-4"	PER PLAN	PER NOA	20-0401.11	N	SH	N	ALUM.	CLEAR GLASS	WHT	
W33	2'-6"	3'-4"	PER PLAN	PER NOA	20-0401.11	N	SH	N	ALUM.	CLEAR GLASS	WHT	
W34	2'-6"	3'-4"	PER PLAN	PER NOA	20-0401.11	N	SH	N	ALUM.	CLEAR GLASS	WHT	
W35	3'-0"	2'-0"	PER PLAN	PER NOA	20-0401.11	N	SH	N	ALUM.	CLEAR GLASS	WHT	
W36	3'-0"	2'-0"	PER PLAN	PER NOA	20-0401.11	N	SH	N	ALUM.	CLEAR GLASS	WHT	
W37	3'-0"	4'-2"	PER PLAN	PER NOA	20-0401.11	N	SHI	N	ALUM.	CLEAR GLASS	WHT	
W38	2'-2"	3'-2"	PER PLAN	PER NOA	20-0401.11	N	SH2	N	ALUM.	CLEAR GLASS	WHT	
W39	2'-2"	3'-2"	PER PLAN	PER NOA	20-0401.11	N	SH2	Ν	ALUM.	CLEAR GLASS	WHT	
W40	2'-2"	3'-2"	PER PLAN	PER NOA	20-0401.11	N	SH2	N	ALUM.	CLEAR GLASS	WHT	
W4 I	2'-2"	3'-2"	PER PLAN	PER NOA	20-0401.11	N		N	ALUM.	CLEAR GLASS	WHT	
W42	3'-0"	4'-2"	PER PLAN	PER NOA	20-0401.11	N		N	ALUM.	CLEAR GLASS	WHT	
W43	6'-2"	3'-2"	PER PLAN	PER NOA	20-0402.02	Y		Υ	ALUM.	CLEAR GLASS	WHT	
W44	6'-2"	3'-2"	PER PLAN	PER NOA	20-0402.02	Y		Υ	ALUM.	CLEAR GLASS	WHT	
W45	3'-0"	4'-2"	PER PLAN	PER NOA	20-0401.11	N		N	ALUM.	CLEAR GLASS	WHT	
W46	9'-8"	2'-10"	PER PLAN	PER NOA	20-0401.10	Y		N	ALUM.	CLEAR GLASS	WHT	TRAPEZOID TRANSOM ABV
N47	9'-8"	2'-10"	PER PLAN	PER NOA	20-0401.10	Y		N	ALUM.	CLEAR GLASS	WHT	TRAPEZOID TRANSOM ABV
W48	3'-0"	4'-2"	PER PLAN	PER NOA	20-0401.11	N		N	ALUM.	CLEAR GLASS	WHT	
N49	6'-2"	3'-2"	PER PLAN	PER NOA	20-0402.02	Y		Y	ALUM.	CLEAR GLASS	WHT	
N50	6'-2"	3'-2"	PER PLAN	PER NOA	20-0402.02	Y		Y	ALUM.	CLEAR GLASS	WHT	
N5 I	2'-4"	4'-2"	PER PLAN	PER NOA	20-0401.10	N	CSM2		ALUM.	CLEAR GLASS	WHT	
N52	5'-6"	4'-6"	PER PLAN	PER NOA	20-0402.02	N		Y	ALUM.	CLEAR GLASS	WHT	
N53	3'-0"	3'-0"	PER PLAN	PER NOA	20-0402.02	N	CSM3		ALUM.	CLEAR GLASS	WHT	
N54	3'-0"	3'-0"	PER PLAN	PER NOA	20-0402.02	N	CSM3		ALUM.	CLEAR GLASS	WHT	
N55	3'-0"	3'-0"	PER PLAN	PER NOA	20-0402.02	N	CSM3		ALUM.	CLEAR GLASS	WHT	
N56	3'-0"	3'-0"	PER PLAN	PER NOA	20-0402.02	N	CSM4		ALUM.	CLEAR GLASS	WHT	
N57	3'-0"	3'-0"	PER PLAN	PER NOA	20-0402.02	N	CSM4		ALUM.	CLEAR GLASS	WHT	
W58	2'-0"	2'-0"	PER PLAN	PER NOA	20-0401.10	N	CSM5		ALUM.	CLEAR GLASS	WHT	
W59	3'-0"	3'-0"	PER PLAN	PER NOA	20-0402.02	N	CSM3		ALUM.	CLEAR GLASS	WHT	
W60	6'-2"	2'-0"	PER PLAN	PER NOA	20-0401.10	N	FXD2		ALUM.	CLEAR GLASS	WHT	

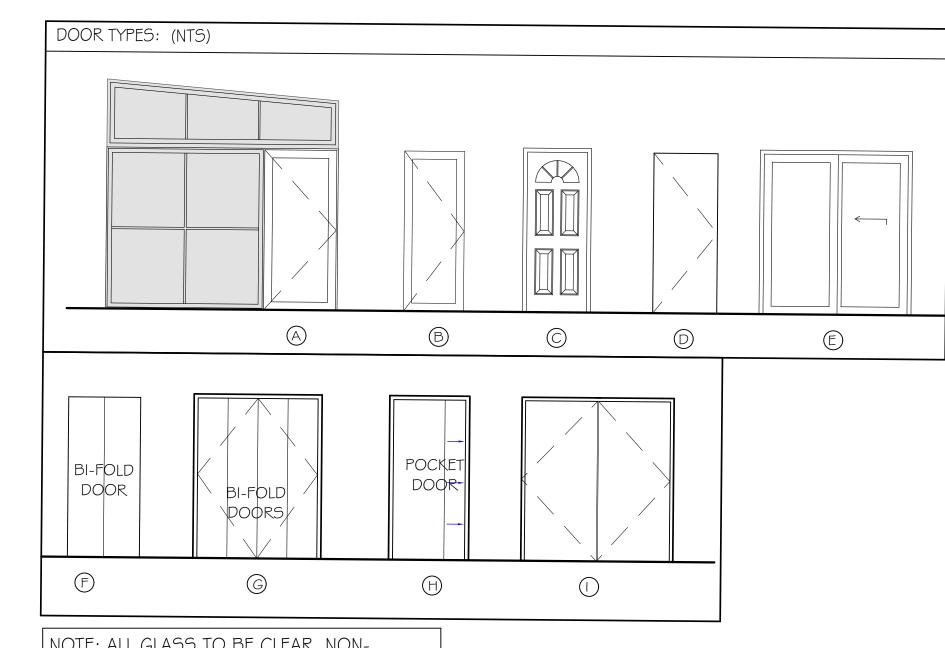

NOTE: ALL GLASS TO BE CLEAR, NON-REFLECTIVE GLASS W/ 33% MAX. GRAY TINT (NO GREEN TINT PERMITTED)

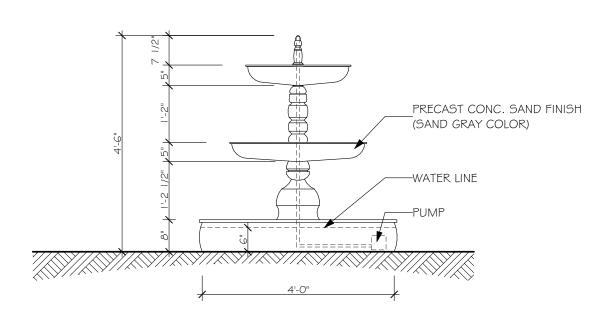

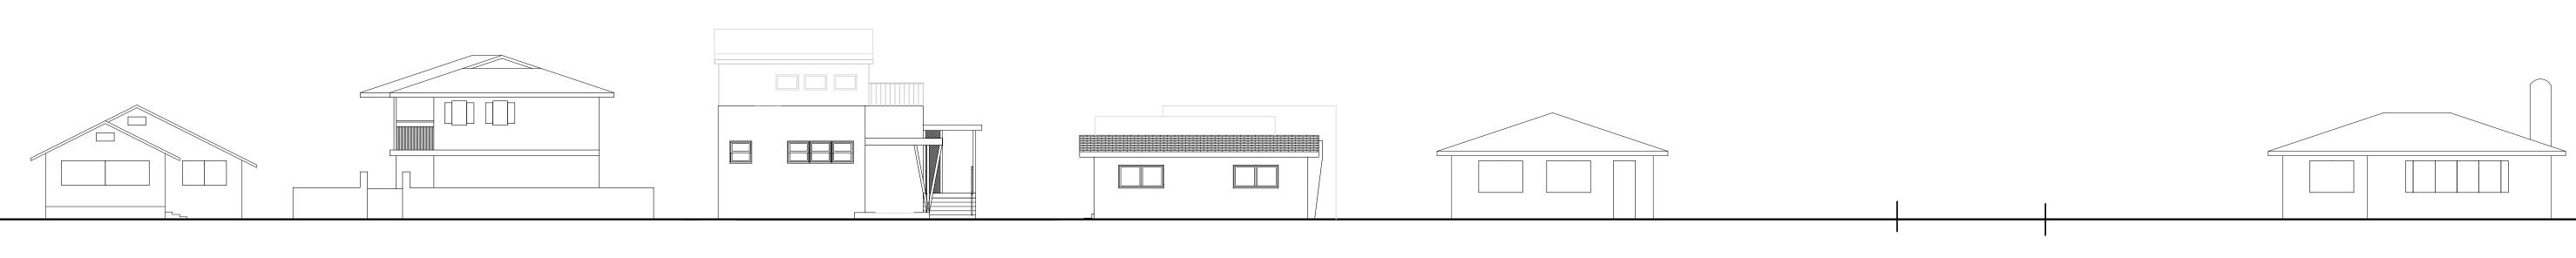

131 SE 7TH AVE.

142 MARINE WAY.

139 SE 7TH AVE.

143 SE 7TH AVE.

WG | 2'-6" | 6'-8" | PER PLAN | PER NOA | 20-040 | 1.10 | N | FXD | N

711 SE 2ND ST.

ALUM. CLEAR GLASS WHT

203 SE 7TH AVE.

HISTORIC STREETSCAPE

REVISIONS:

D/W SCHEDULE & HISTORIC STREETSCAPE

STEVE SIEBERT

ARCHITECTURE 1010 GATEWAY BLVD. BOYNTON BEACH, FL 33426 PH. 561.880.7894 Steve@stevesiebert.com www.stevesiebert.com

SEAL

STEVEN W. SIEBERT FLORIDA AR0017834

NEW JERSEY 21AI01517500 TEXAS 26934

C.O.A. DRAWINGS THE WRITTEN DIMENSIONS ON THESE DRAWINGS SHALL TAKE PRECEDENCE OVER SCALED DIMENSIONS.
THE CONTRACTOR SHALL VERIFY AND BE RESPONSIBLE FOR ALL DIMENSIONS AND CONDITIONS ON THE JOB, AND THIS OFFICE MUST BE NOTIFIED OF ANY VARIATION FROM THE DIMENSIONS.
COPYRIGHT STEVE SIEBERT ARCHITECTURE-UNAUTHORIZED REPRODUCTION OR ANY OTHER USE OF THIS DRAWING IS PROHIBITED.

PROJECT NO: 22-429

4.10.23 DRAWN BY: BT CHECKED BY: SK

4 CITY COMMENTS (3.18.25) 5 CITY COMMENTS (5.14.25) CITY COMMENTS (8.8.25)






COLOR PERSPECTIVE A

NOT TO SCALE

COLOR PERSPECTIVE B NOT TO SCALE

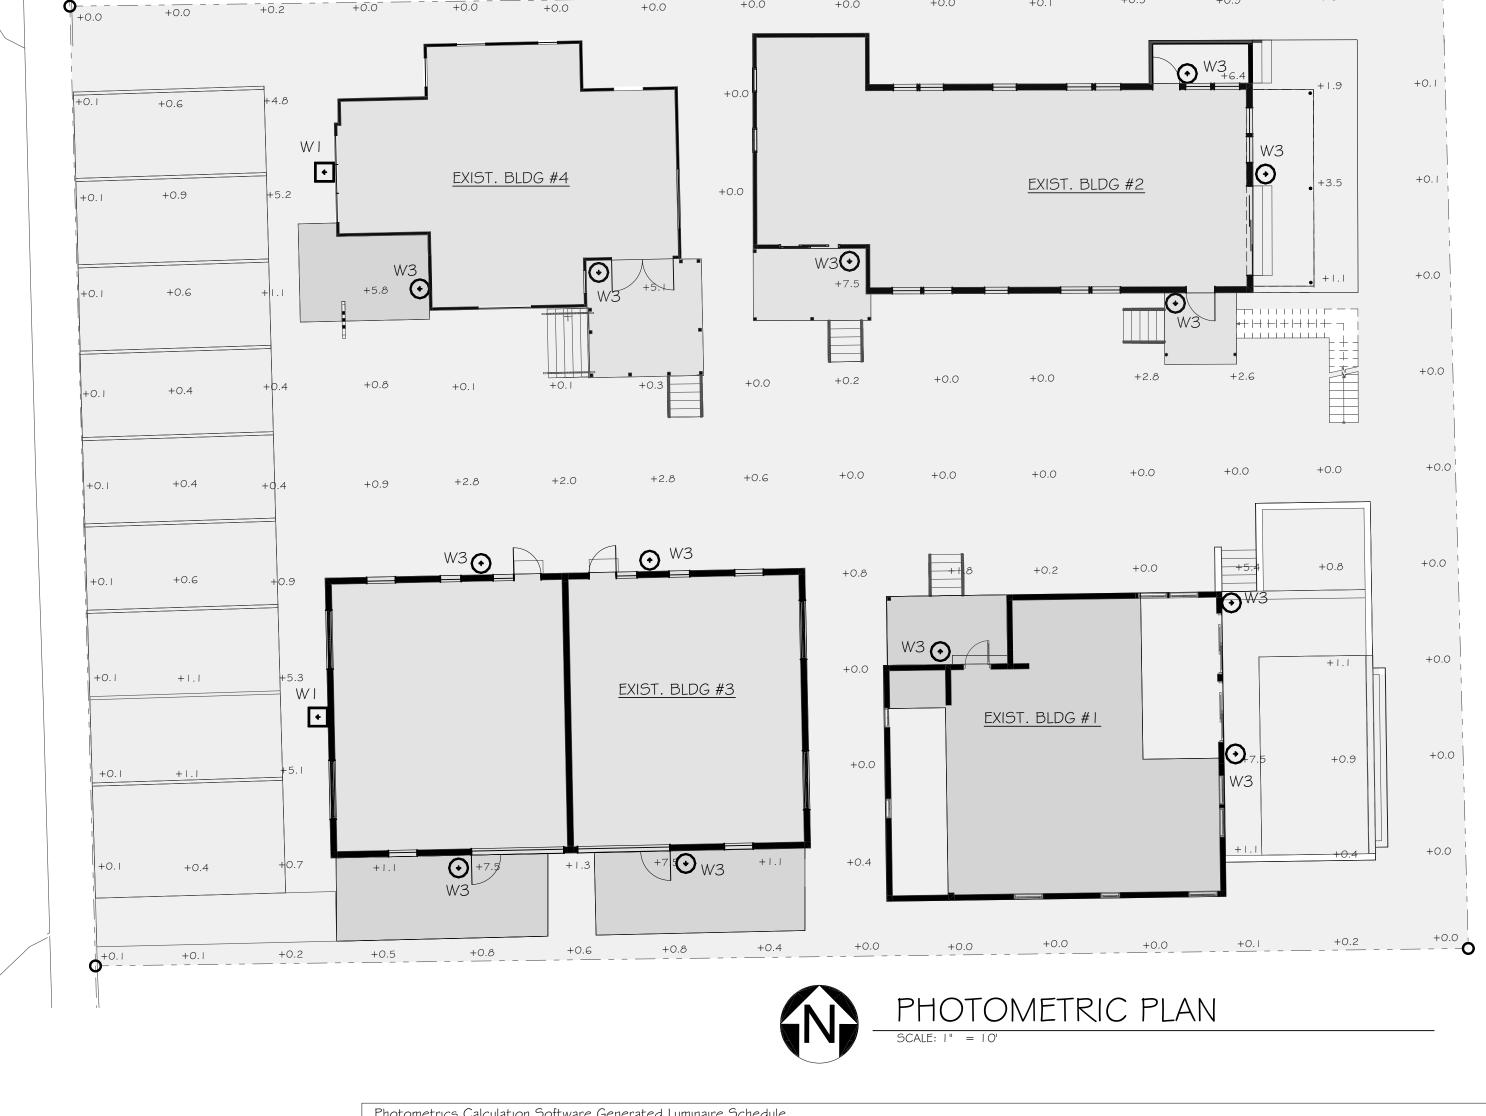

Photometrics Ca	Iculation Softwa	re Generated	Luminaire Schedule					
Symbol	Qty	Label	Arrangement	Lum. Lumens	Arr. Lum. Lumens	LLF	Lum. Watts	Arr. Watts
•	2	WI	Single	2069	2069	0.900	20.1	20.1
$\overline{\odot}$	0	W2	Single	2931	2931	0.900	40	40
Ō	13	W3	Single	976	976	0.900	1.1	11

	LIGHTING FIXTURE SCHEDULE										
TYPE	DESCRIPTION	MANF	CATALOG NUMBER	VOLT	LAMP COLOR	LUMENS	LAMP TYPE	DIM TYPE	WATTS	MOUNTING	NOTES
W1	WALL MOUNTED LUMINAIRE	IVUE	ENC-SA1A-740-U-T2-FINISH-HSS	UNV	4000K	2069	LED	0-10V	20W	WALL	1
W2	CYLINDRICAL DOWN LIGHT	LIGMAN	UMV-30052-2x20w-EW-T4-W40-FINSH-120/277V	UNV	4000K	2931	LED	0-10V	40W	WALL	1
W3	CYLINDRICAL DOWN LIGHT	LIGMAN	UMV-30001-11W-M-W40-FINSH-120/277V	UNV	4000K	976	LED	0-10V	11W	WALL	1
	FIXTURE SCHEDULE NOTES										



COLOR PERSPECTIVE C NOT TO SCALE



COLOR PERSPECTIVE D NOT TO SCALE



STEVE SIEBERT ARCHITECTURE

1010 GATEWAY BLVD. BOYNTON BEACH, FL 33426 PH. 561.880.7894 Steve@stevesiebert.com www.stevesiebert.com



NEW JERSEY 21AI01517500

TEXAS 26934

C.O.A. DRAWINGS

THE WRITTEN DIMENSIONS ON THESE DRAWINGS SHALL TAKE PRECEDENCE OVER SCALED DIMENSIONS.
THE CONTRACTOR SHALL VERIFY AND BE RESPONSIBLE FOR ALL DIMENSIONS AND CONDITIONS ON THE IOD AND THE OFFICE MISSIONS AND CONDITIONS OF

THE JOB, AND THIS OFFICE MUST BE NOTIFIED OF ANY VARIATION FROM THE DIMENSIONS. COPYRIGHT STEVE SIEBERT ARCHITECTURE-UNAUTHORIZED REPRODUCTION OR ANY OTHER USE OF THIS DRAWING IS PROHIBITED.

PROJECT NO: 22-429 4.10.23 DRAWN BY: BT


CHECKED BY: SK **REVISIONS:**

4 CITY COMMENTS (3.18.25) 5 CITY COMMENTS (5.14.25) 6 CITY COMMENTS (8.8.25)

COLOR PERSPECTIVES / PHOTOMETRIC


Existing	Tree List													
Guide for Plar	nt Appraisal, 9th Edition													
ase/Location:	139-143 SE 7th Avenue, Delray Beach, FL	33483												
Date:	7/27/2023													
Appraiser:	Thomas White, ASLA-ISA.													
	ISA Arborist FL-5248A													
Tree	Species	Height	Spread	Class	Rating %	=	X	DBH	X	Condition	Condition %	=	Caliper	Disposition
#	(Botanical Name / Common Name)	(Feet)	(Feet)					(Inches)					Removed	
6	Plumeria spp. / Frangipani	10	8	В	80	0.80		4		Fair	0.44		1.41	Owner Removed
Condition:														
	Specimen	100-80	%											
	Good-Healthy	79-60	%		Caliper Re	move	d F	ormula :	= F	Rating % x D	BH Caliper x	Cor	ndition %.	
	Fair	59-40	%		Replacem	ent Va	alue	Formul	a =	DBH Calip	er Inches x \$6	5.		
	Poor	39-20	%											
Category	A	100%												
	В	80%												


Existing Pal	m List					
Guide for Plant App	oraisal, 9th Edition					
Case/Location:	139-143 SE 7th Avenue, Delray Beach, FL 3348	3				
Date:	7/27/2023					
Appraiser:	Thomas White, ASLA-ISA.					
	ISA Arborist FL-5248A					
Palm	(Botanical Name / Common Name)	Ht.	C.T.	Condition	Replacement	Disposition
#		(Feet)	(Feet)		Palms	
1	Sabal palmetto / Cabbage Palm	16	10	Good	1	Owner Removed
2	Dypsis lutescens / Areca Palm	15	0	Fair	1	Owner Removed
3	Dypsis lutescens / Areca Palm	15	0	Fair	1	Owner Removed
4	Sabal palmetto / Cabbage Palm	16	10	Good	1	Owner Removed
5	Sabal palmetto / Cabbage Palm	16	16	Good	1	Owner Removed
7	Sabal palmetto / Cabbage Palm	20	15	Good	1	Owner Removed
8	Sabal palmetto / Cabbage Palm	26	20	Good	1	Owner Removed
9	Dypsis lutescens / Areca Palm	8	0	Fair	0	Owner Removed
10	Dypsis lutescens / Areca Palm	8	0	Fair	0	Owner Removed
11	Dypsis lutescens / Areca Palm	8	0	Fair	0	Owner Removed
12	Dypsis lutescens / Areca Palm	8	0	Fair	0	Owner Removed
13	Dypsis lutescens / Areca Palm	8	0	Fair	0	Owner Removed
14	Dypsis lutescens / Areca Palm	20	0	Fair	1	Owner Removed
15	Adonidia merrillii / Christmas Palm	25	20	Fair	1	Owner Removed
16	Dypsis lutescens / Areca Palm	25	0	Good	1	Owner Removed
17	Ptychosperma elegans / Solitaire Palm	24	20	Fair	1	Owner Removed
	-	Replace	ement Pa	lms Required	Per City	
		ORF	Payment I	nto Tree Fund	-	

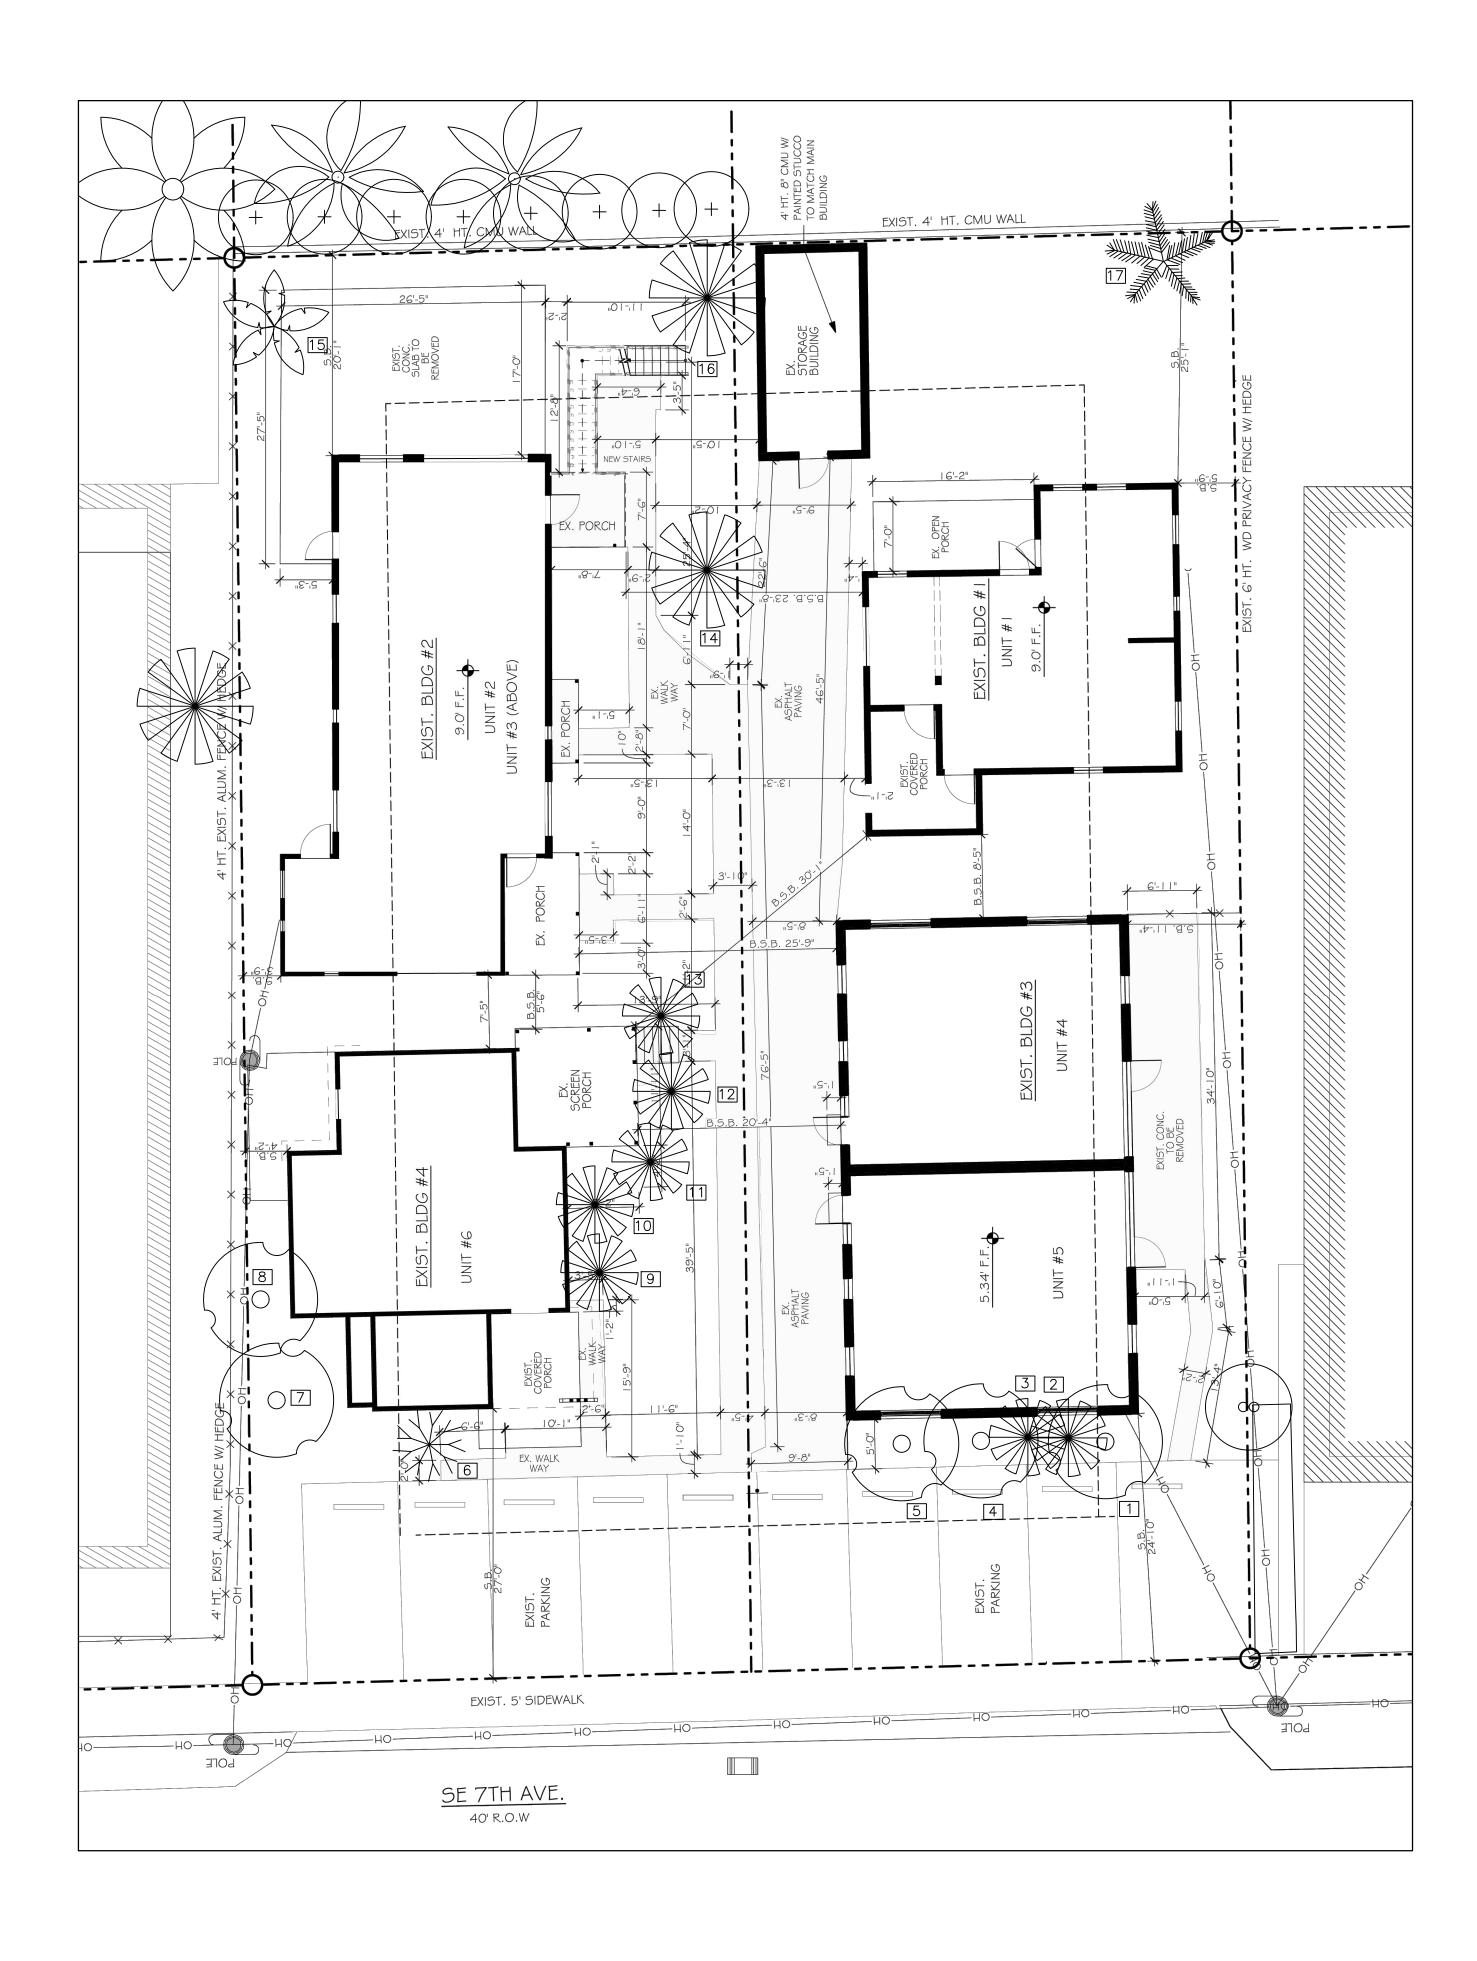

Thomas White

Digitally signed by Thomas White Date: 2025.05.21 15:59:59 -04'00'

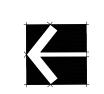

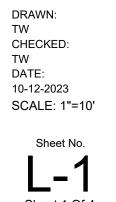

Sunshine Call 811 or www.sunshine811.com two full business days before digging to have utilities located and marked.

Check positive response codes before you dig!


REVISIONS

GENERAL LANDSCAPE NOTES


- The plan takes precedence over the plant list.
 2 Full business days before digging, call toll free 1-800-432-4770 Sunshine State One Call of Florida, Inc. Notification Center. Contractors are responsible for coordinating with the owners and appropriate public agencies to assist in locating and verifying all underground utilities prior to excavation. All existing utilities shown on the plans are to be considered
- utilities prior to excavation. All existing utilities shown on the plans are to be considered approximate and should be verified by the contractor prior to the start of work operations.

 General site and berm grading to +/- 1 inch (1") shall be provided by the general contractor. All finished site grading and final decorative berm shaping shall be provided by
- the landscape contractor.
 All sizes shown for plant material on the plans are to be considered Minimum. All plant material must meet or exceed these minimum requirements for both height and spread. Any other requirements for specific shape or effect as noted on the plan(s) will also be required for final acceptance.
- All plant material furnished by the landscape contractor shall be Florida #1 or better as established by Grades and Standards for Florida Nursery Trees and Plants.
- All trees designated as single trunk shall have a single, relatively straight, dominant leader, proper structural branching and even branch distribution. Trees with bark inclusion, tipped branches, and co-dominant trunks will not be accepted. Trees with girdling, circling and/or plunging roots will be rejected.
- All planting beds shall be free of all rocks ½" or larger, sticks, and all objectionable non-native material including weeds, weed seeds. All limerock, road rock, asphalt shall be removed/cleaned down to the native soils. Planting soil 50/50 sand/topsoil mix shall be delivered to the site in a clean loose and friable condition and is required around the root ball of all trees and palms, the top 6" of all shrubs and ground cover beds and top 2" of all sodded areas. This soil shall be tilled into the existing soil after the existing soil has been cleaned of all rocks, concrete, asphalt, limestone and sticks. Recycled compost is encouraged as a soil amendment alternative.
- All burlap, string, cords, wire baskets, plastic or metal containers shall be removed from the rootballs before planting. Remove all bamboo and metal nursery stakes. Remove all tagging tape.
- All trees/palms shall be planted so the top of the root ball, root flair are slightly above final grade. Shrub material shall be planted such that the top of the plant ball is flush with the surrounding grade. It is the sole responsibility of the landscape contractor to insure that all new plantings receive adequate water during the installation and during all plant warranty periods. Deep watering of all new trees and palms and any supplemental watering that may be required to augment natural rainfall and site irrigation is mandatory
- to insure proper plant development and shall be provided as a part of this contract.

 All trees/palms shall be staked using biodegradable material. No wire, black strapping, or other synthetic material shall be used. Nailing into trees and palms for any reason is prohibited and the material will be rejected. Please refer to the planting details
- All landscape and lawn areas are irrigated by an existing fully automatic sprinkler system with a minimum 100% coverage with all heads adjusted to 50% overlap. One bubbler shall be provided for each tree. The system is operational with a rain sensor and rust inhibitor.
 No fertilizers are required.
- All landscape areas shall be covered with a 3" layer of Melaleuca mulch or Florimulch when settled. Spread mulch to 1" thickness 3" away from the trunks/stems of all plant material. All trees in sodded areas shall have a clean cut 4' diameter mulch ring. The 5-6" height water ring shall be made from mulch, not soil. Certain areas may receive a thicker mulch cover where noted on plans. Cypress, red, gold and green mulch is prohibited.
- All open areas not covered by trees, palms, shrubs, vines or ground covers shall receive Stenotaphrum secundatum, St. Augustine 'Palmetto' sod, whether labeled on the plans or not, unless a different species is indicated on the planting plan. All noted s.f. shall be approximate; it is the contractor's responsibility to do his or her take off and sod all open areas. It shall be the responsibility of the contractor to include in the bid, the repair of any existing sod which may be damaged during construction.
- Please refer to the planting details for a graphic representation of the above notes.
 All ideas, designs and plans indicated or represented by this drawing are owned by and are the exclusive property of Thomas L White, ASLA—ISA.
- All plant material as included herein shall be warranted by the landscape contractor for a minimum period as follows: All trees and palms for 12 months, all shrubs, vines, groundcovers and miscellaneous planting materials for 90 days, and all lawn areas for 60 days after final acceptance by the owner or owner's representative.
- A min. 5 feet horizontal clearance / horizontal separation is required between city utilities infrastructure and proposed small trees and 10 foot separation from large trees.

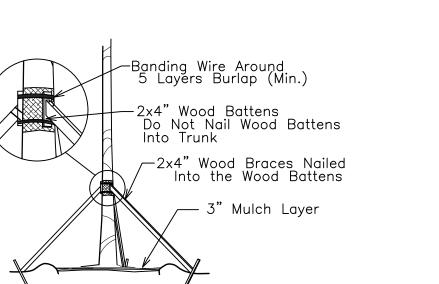

TREE/PALM BRACING DETAIL

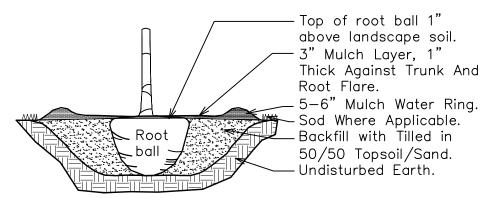


TREE/PALM PLANTING DETAIL

C: 18" for all 1 gal., 30" for all 3 gal. or greater, vines not included	Fence, wall or structure B: 18" between all 1 gal. m and 1 gal., 24" between
A: 14" for all 1 gal., 24" for all 3 gal. or greater.	all 1 gal. and 3 gal., 36 between all 3 gal. and 3 gal. and 3 gal. or greater. Curb or edge of pavement


TYPICAL SHRUB SPACING DETAIL

NTS


PLAN	N 1 L	_101				
Code		Drought	QTY.		Botanical Name / Common Name	Specifications
						Min. per Delray Code
Propos	ed T	rees / Palı	me			Wiiii. per Bellay Coa
AM	Jeu II	V	2		Adonidia merrillii / Christmas Palm	16' OA Ht., 8' CT
CE	(N)		2		Conocarpus erectus sericeus / Silver Buttonwood	16' Ht X 7' Spr., 8' CT
FD	(14)	V	1		Filicium decipiens / Japanese Fern Tree	16' Ht X 7' Spr., 8' CT
IC	(N)	•	1		llex cassine / Dahoon Holly	16' Ht X 7' Spr., 8' CT
CO	(N)		2		Chrysophyllum oliviforme / Satin Leaf	16' Ht X 7' Spr., 8' CT
VM	(14)	V	3		Veitchia montgomeryana / Montgomery Palm	16' OA Ht., 8' CT
VIVI			8		Total Proposed Trees / Palms (AM and VM Counted	
			5		Native Trees	0.1)
			65%		Native Trees	
			00 /0		Nutive frees	
Accent	c / QI	hrube				
ACCENT	S / SI	V	1		Agave desmettiana / Variegated Agave	30"X30"
CFR		V	9		Cordyline fruticosa 'Red Sister' / Red Sister Ti Plant	3 Gal., 30"X12"
CHE		V	1		Chamaerops humilis / European fan palm	42-48" OA Ht.
CMF		V	2		Caryota mitis / Fishtail Palm	6' OA Ht.
CRI	(N)	V	7		Crinum asiaticum / Tree Crinum	30"X30"
CRO	(14)	V	28		Codiaeum variegatum 'Mammey' / Croton	3 Gal., 18"X18"
CRS	(N)	V	44		Clusia rosea / Small Leaf Clusia	36"X24", 24-30" OC
DAH	(14)	V	1		Dictyosperma album / Hurricane Palm	8' OA Ht.
DLA		V	21		Dypsis lutescens / Areca Palm	8' OA Ht.
ING		V	15		Ixora 'Nora Grant' / Pink Nora Grant Ixora	3 Gal., 18"X18"
JNS		V	13		Jasminum nitidum / Shining Jasmine	3 Gal., 18"X18"
MDS		V	17		Monstera deliciosa / Swiss Cheese Plant	3 Gal., 18"X18"
MFS		V	5		Myrcianthes fragrans / Simpson Stopper	8' OA Ht.
PMP		V	107		Podocarpus maki / Podocarpus	3 Gal., 24"X18", 2' OC
SAG		V	80		Schefflera arboricola / Green Dwarf Schefflera	3 Gal., 24 X 18 , 2 OC
SAT		V				3 Gal., 24 X24 , 2 OC
TDF	/N I)		9		Schefflera arboricola 'Trinette' / Variegated Arboricola	
TRF	(N)	V	6		Tripsacum dactyloides / Fakahatchee Grass Thrinax radiata / Florida Thatch Palm	24-30"x 24-30", 42-48" OC 8' OA Ht.
VOS		V	5			3 Gal., 24"X24", 2' OC
		V			Viburnum odoratissimum / Sweet Viburnum	
VSS		V	13		Viburnum suspensum / Sandankwa Viburnum	3 Gal., 24"X24", 2' OC
			388		Total Shrubs	
Cround	d Cov	ers / Sod				
ADM		V V	18		Asparagus densiflorus 'Myers' / Foxtail Fern	1 Gal., 12" OA
BRO		V	5		Bromeliad spp. / Bromeliads	1 Gal., 8"OA
CFH		V	33		Cyrtomium falcatum / Holly Fern	1 Gal., 8 OA
DIA		V	13		Dietes iridioides / African Iris	1 Gal., 12 OA
FMG		V	28		Ficus microcarpa / Green Island Ficus	3 Gal., 16" Spr.
JCS		V	14		Juniperus conferta / Shore Juniper	1 Gal., 12" Spr.
JHB		V	37		Juniperus horizontalis / Blue Rug Juniper	1 Gal., 12" Spr.
LME		V	140		Liriope muscari 'eg' / Liriope Evergreen Giant	1 Gal., 12 Spr.
NEB		V	8		Nephrolepis exaltata / Boston Fern	1 Gal., 12 OA
INLD		V	0		riepinolepis exaltata / Dostori i em	1 dai., 12 OA
A-Sod		N.A	D., C.C.	C [Ctonotanbrum equindatum / Ct. Augustina (Dalmatta)	Colid application in gene
		M	-		Stenotaphrum secundatum / St. Augustine 'Palmetto'	Solid application - no gaps
B-Sod		M	By GC	3.F.	Paspalum notatum / Argentine Bahia - Sand Grown	Solid application - no gaps

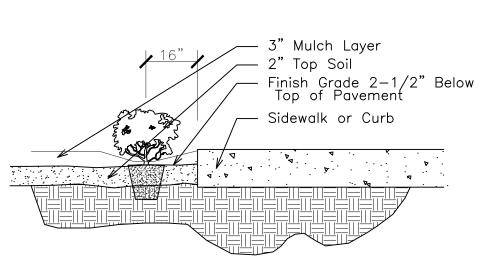


SHRUB INSTALLATION DETAIL

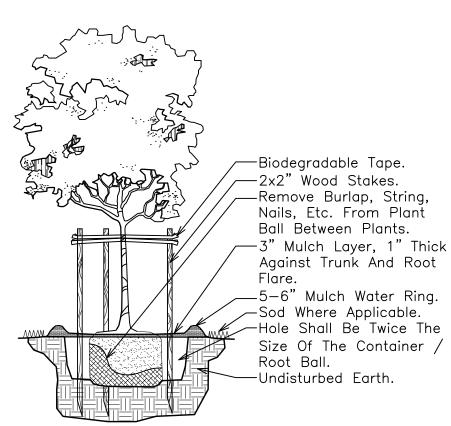

SMALL TREE PLANTING DETAIL

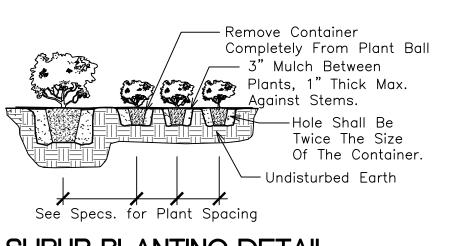

SHRUB PLANTING DETAIL

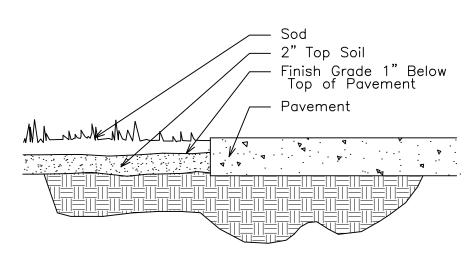

SOD INSTALLATION DETAIL

Multi Fam	пуг	Minimum Landscape Requirements				
Sec 4.6.16	5. (H	1) (3)				
	Ť		Required	Provided		
	S	treet Facing Foundation Shrubs	Contd. Shrubs	Contd. Shrubs		
	A	/C Units Screen w/ Shrubs or Wood Fence	Hedge or Wood Fence	Both		
	S	od	Sod	Sod		
	R	OW Sod	Sod	NA		
	R	efuse Containers Screened	NA	Rear		
	Irı	igation System	Irrigation System	Irrigation System		
		Parking	Area:	1785	SF	
		Parking Imterior Landscape	Area:	420	SF	24%
		Landscape Barrier / 5' Perimeter where applic	cable:	1475	SF	
		Interior Lands	cape:	1820	SF	
		Foundation Lands	cape:	1275	SF	
				4990	SF	

ANY TREES OR SHRUBS PLACED
WITHIN WATER, SEWER OR DRAINAGE
EASEMENTS SHALL CONFORM TO THE
CITY OF DLERAY BEACH STANDARD
DETAILS; LD 1.0 & LD 2.0

2 LME

30

EXIST. 5' SIDEWALK

5' DEDICATION

4' WOOD FENCE

33 DAH

JHB

37 /

ING 15

BLDG #2

Vegetable Garden

NEB\

/ DIA

BLDG #4

10'X10' Sight Triangles (Typ.) NEW SCREEN PORCH

Community:

Herb Garden -

Adjacent

OA Ht.

2 SAG

\ 4 /

14 CRS

CE

Adjacent

OA Ht.

Property 8'

Ficus Hedge

Property 8'

Ficus Hedge



NEW POOL

VM\

9 ADM

LME

100,00°

S.E. 7th Ave.

40′ R.□.W

Two Existing

City Water


Meters

UNIT #5

EXIST. BLDG #1

Thomas White

Digitally signed by Thomas White Date: 2025.05.21 16:01:03 -04'00'

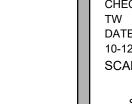



REVISIONS

3/6/2025: Updated Existing Plant Material, Site Plan, and Parking Layout.

5/21/2025: Parking walk added.

CRO 22 LME

20 VSS


34 CRS

Property 8' OA Ht

POLE

Clusia Hedge

Wang Residence

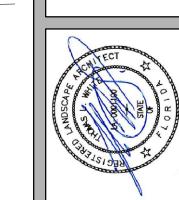

TW
CHECKED:
TW
DATE:
10-12-2023
SCALE: 1"+10'



ZONE VALVES - Hunter PGV Series with SCV-100-VALVE-B Smart Valve Battery Controller.

WEXISTING CITY WATER METER.

outside on eave of structure.

SLEEVES — Sch. 40, 2 Sizes Larger. NOTE — Pipe Size Shown is the Lateral Size, NOT the Sleeve Size

> 6" POP-UP SPRAY -Hunter MP Rotator Series: Nozzles as Required. NOTE — All of the below may not be used MP1000 MP800 120 T 180 H 240 TT

○ 6" POP-UP STREAM BUBBLER - Hunter 5-CST-B 5'R.

SS-530 5 x 30' **■** ES-515 5 x 15'

270 TQ

360 F

ZONE # VALVE SIZE

IRRIGATION NOTES:

Main Lines: PVC SCH 40 Solvent Weld. Zone Lines: PVC SCH 40 Solvent Weld. 1/2 in. is not used. All pipe is 1 inch. Sleeves and suction Line: PVC SCH 40.

Fittings: SCH 40 PVC

Fabrication: To manufacturers specifications. Use blue or grey PVC cement, square cut, clean and prime all joints.

Allow all main lines to cure for 24 hours before pressuring.

All pipe, fittings, and solvents to conform to latest ASTM specs.

Depth of Lines: Main Line and wiring = 18 in. depth, min. Sleeving under pavement = 24 in. depth, min. Suction Line = 24 in. depth, nominal. Zone Lines 1-1/2 in. and smaller = 15 in. depth, min.

Control Wires: AWG 14 for all hot wires and AWG 12 for common. Solid copper type UF UL listed for direct burial. Run wires under main.

Run spares, two min. Splice wires only in a valve box. All splices shall be moisture proof using Snap tite or DBY UL connectors.

Backfill all trenches free of debris, compact to original density, flush all lines, use screens in all heads, adjust heads


Common shall be white, hot shall be red or color coded Spare shall be black. Run all wires in Grey Electrical SCH 40 conduit..

for proper coverage avoiding excess water on walls, walks, etc. All details are graphically shown only. All quantities shall be verified by the contractor prior to installation. It shall be the

contractors responsibility to assure complete overlapping coverage. Any discrepancies shall be reported to the owner and landscape architect before proceeding. Codes and local regulations shall take precedence over these plans, it is the contractors responsibility to comply. The landscape architect reserves the right to make minor field changes, the contractor may field adjust spray nozzle selection to provide for proper 100% min. coverage.

Provide owner with an accurate as installed plan(s) at completion showing main lines, wiring, valves, crossings, etc. using dimensions from fixed datums.


Contractor shall verify all underground utilities prior to commencement of work.

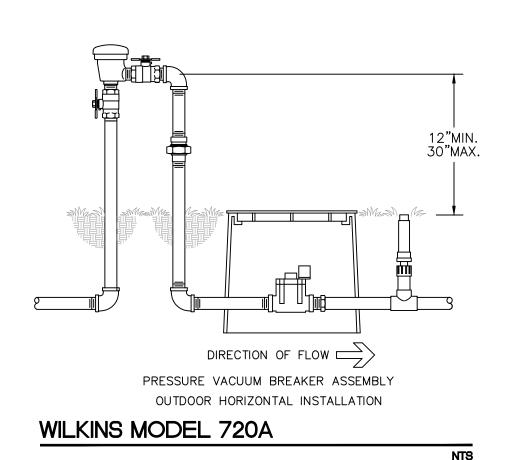


1)IRRIGATION CONTROLLER

2)IRRIGATION CONTROL WIRE IN CONDUIT

SIZE AND TYPE PER LOCAL CODES

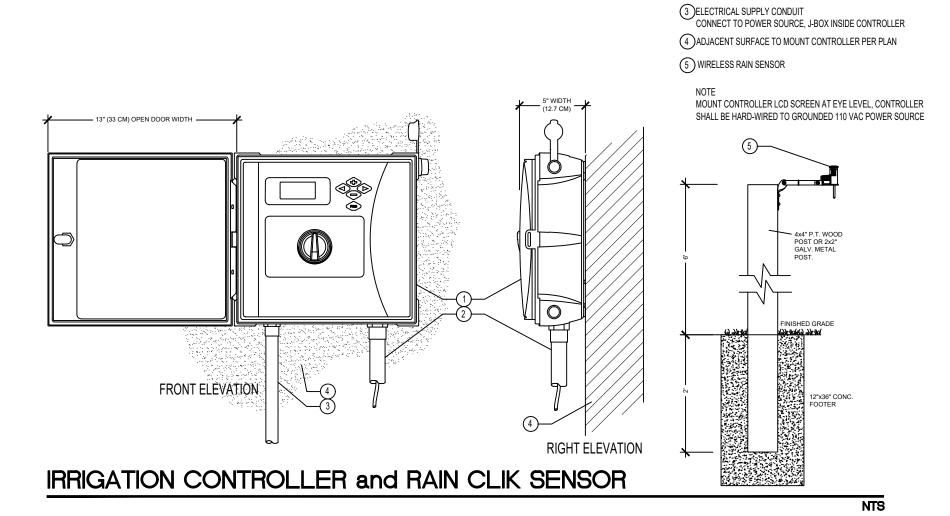

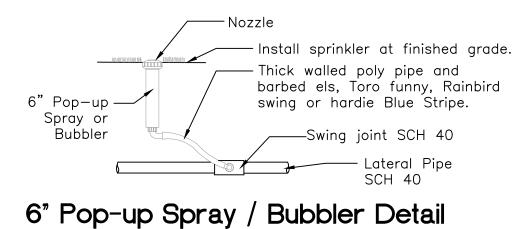

NOTE: Each Building has it's own time clock, controller, and one irrigation zone.



POLE

Date: 2025.05.21 16:01:49 -04'00'



EXIST. 4' HT. CMU WALL

NEW POOL

UNIT #4

UNIT #5

100.00

Two Existing

City Water

Meters

EXIST. 5' SIDEWALK

EXIST. 4' HT. CMU WALL

BLDG #2






POLE



REVISIONS

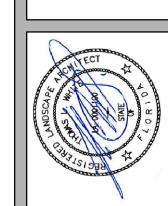

CHECKED: TW DATE: 10-12-2023 SCALE: 1"+10'






PATH LIGHT



LIGHTING FIXTURE SCHEDULE

SYMBOL	TYPE. FINISH	MANUFACTURER	ITEM NUMBER	LAMPS		VOLTS	REMARKS
				QTY	TYPE		
abla	UP LIGHT. BLACK	Kichler	16020BKT30	1	12 Watt LED	12-LED	Available Locally at Light Bulbs
							Unlimited, Factory
۵	PATH LIGHT BLACK	Kichler	15845BKT	1	11.6 Watts		Direct or online at Wayfair or Amazon.
	TRANSFORMER. BLACK	Kichler	TBD		65 Watts	120	


NOTE:
THIS LOW VOLTAGE SYSTEM HAS BEEN DESIGNED FOR MAXIMUM SAVINGS
THE LAYOUT HAS MINIMIZED THE RUNNING LENGTH OF THE WIRING

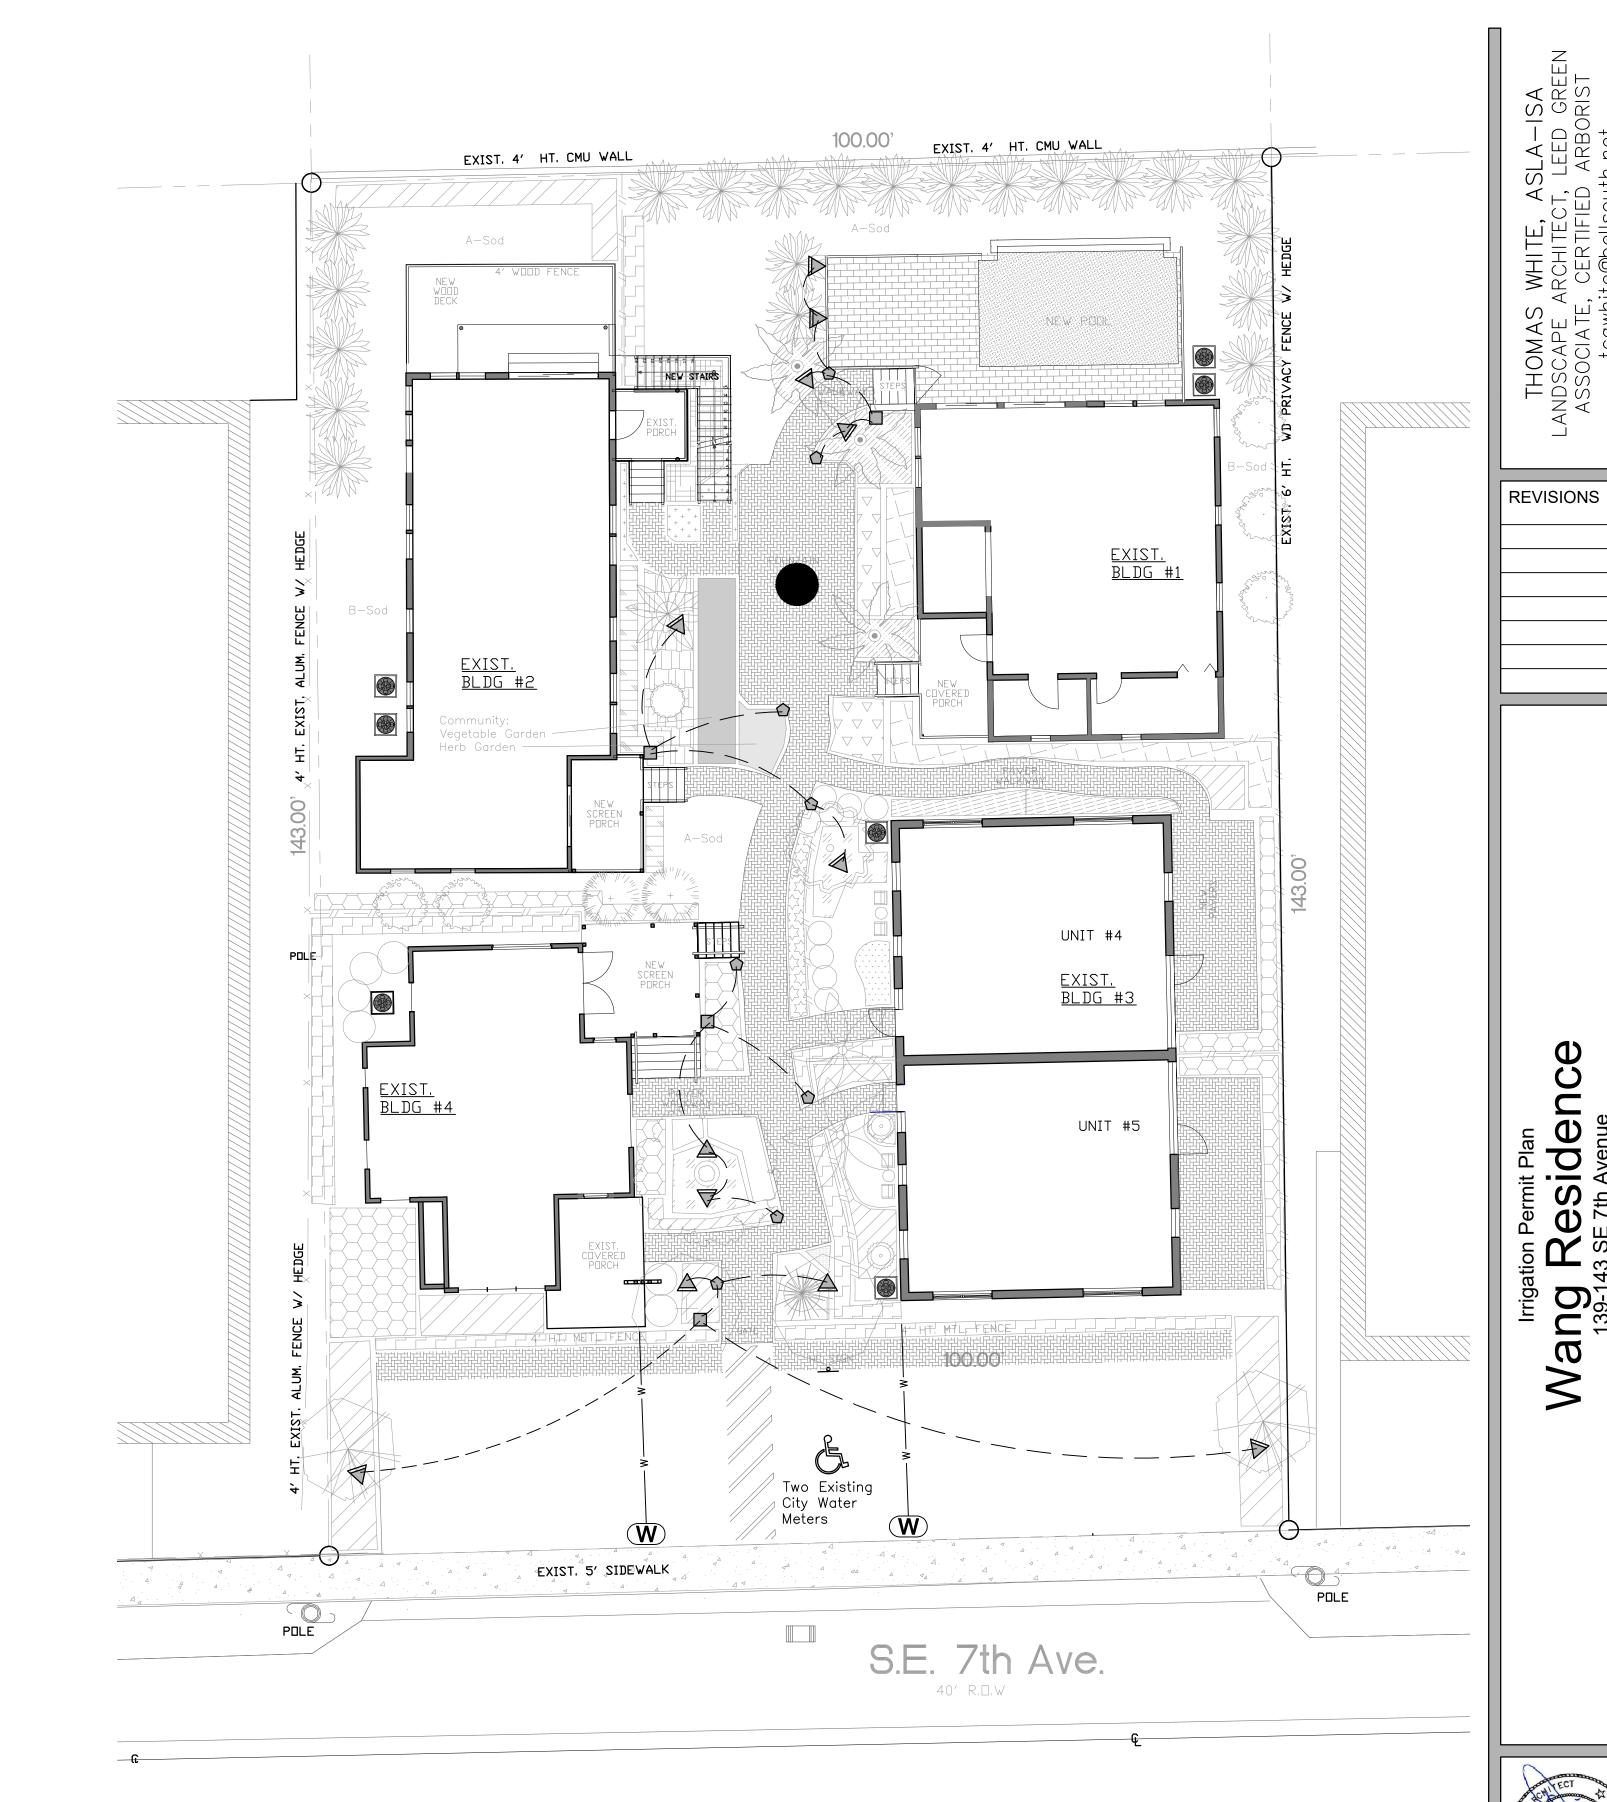


Thomas White

Digitally signed by Thomas White Date: 2025.05.21 16:02:27 -04'00'

Sunshine [1] Call 811 or www.sunshine811.com two full business days before digging to have utilities located and marked. Check positive response codes before you dig!

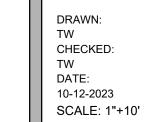



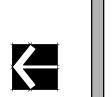


PAVING, GRADING, & DRAINAGE PLAN

FOR

139/143 SE 7TH AVENUE

DELRAY BEACH, FL

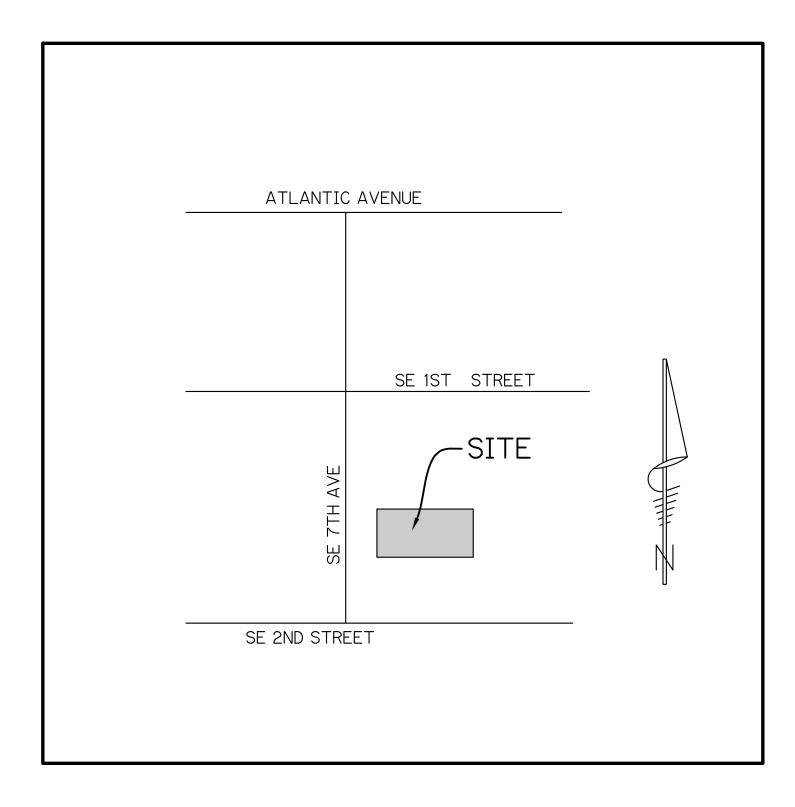

INDEX OF SHEETS


SHEET No.	DESCRIPTION
1	COVER
2	DEMOLITION PLAN
3	PAVING, GRADING, & DRAINAGE PLAN
4-5	PAVING, GRADING, & DRAINAGE DETAILS


LOCATION MAP


N. 1.5. SEC. 16 TWP. 46 S RGE. 43 E



1860 Old Okeechobee Road, Suite 504 West Palm Beach, FL 33409 phone (561)615-6567 fax (561)683-0872 EB 9889

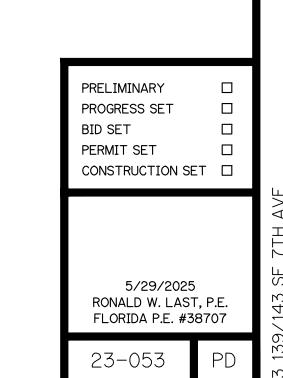

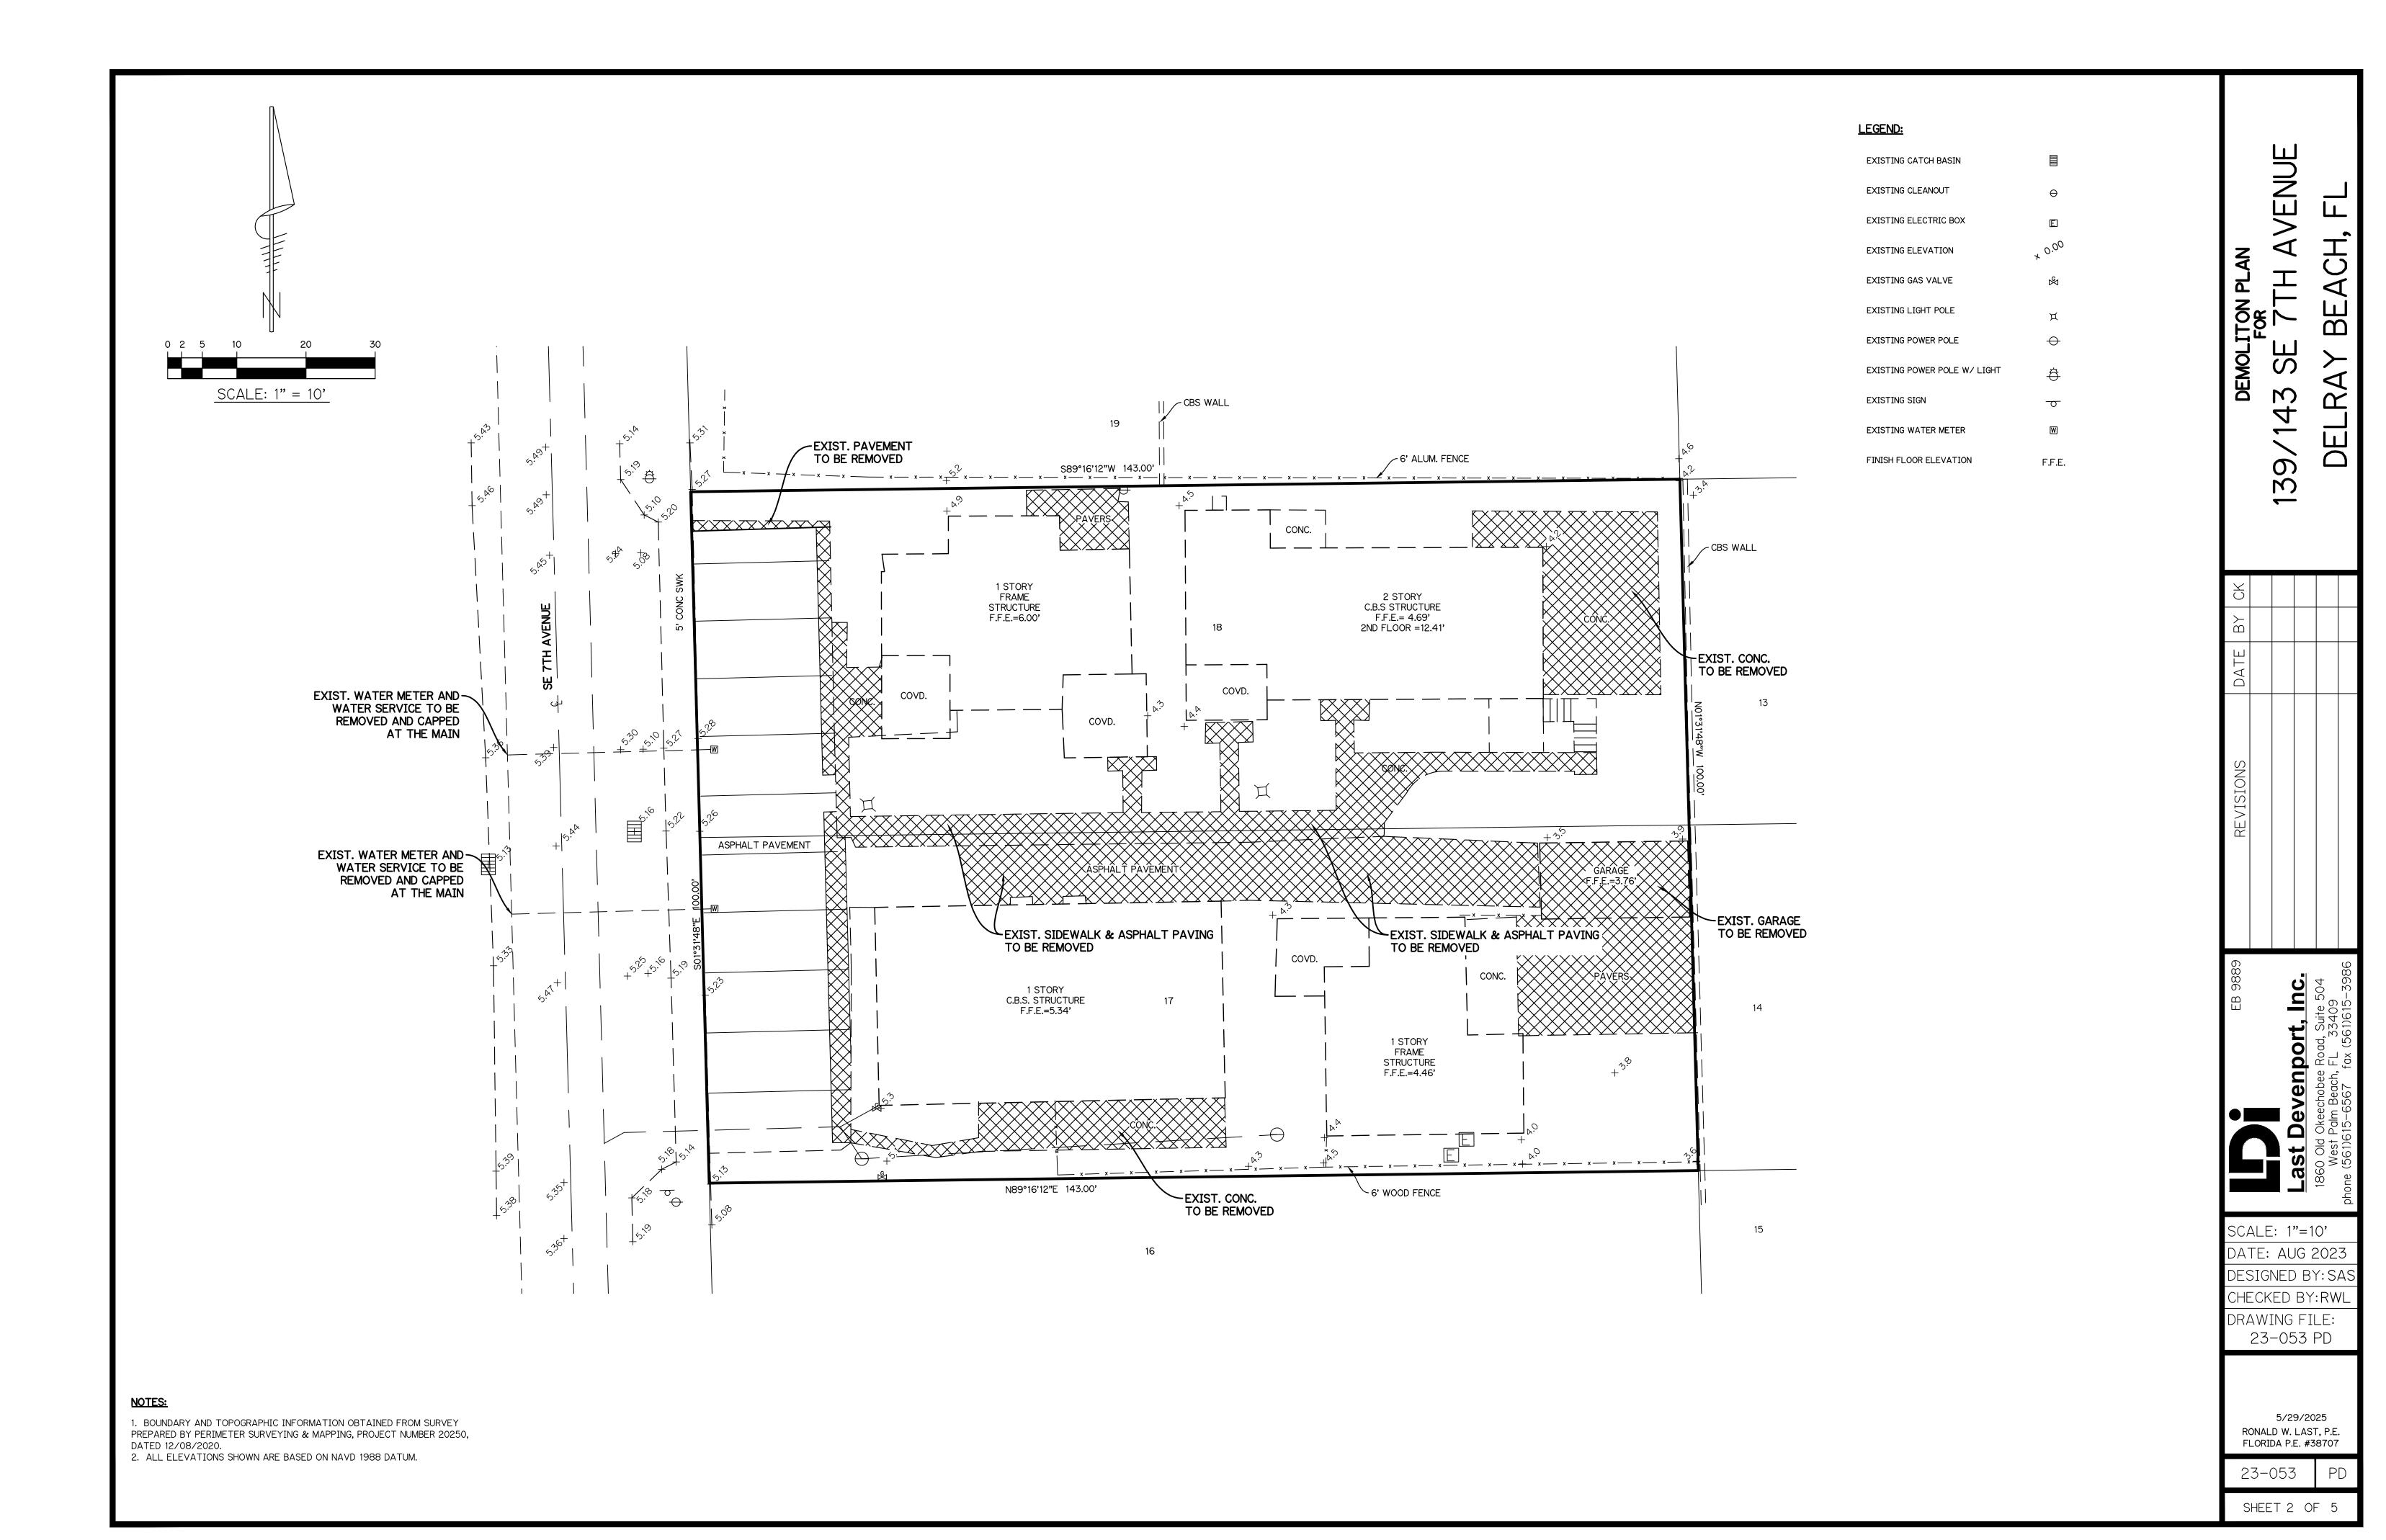

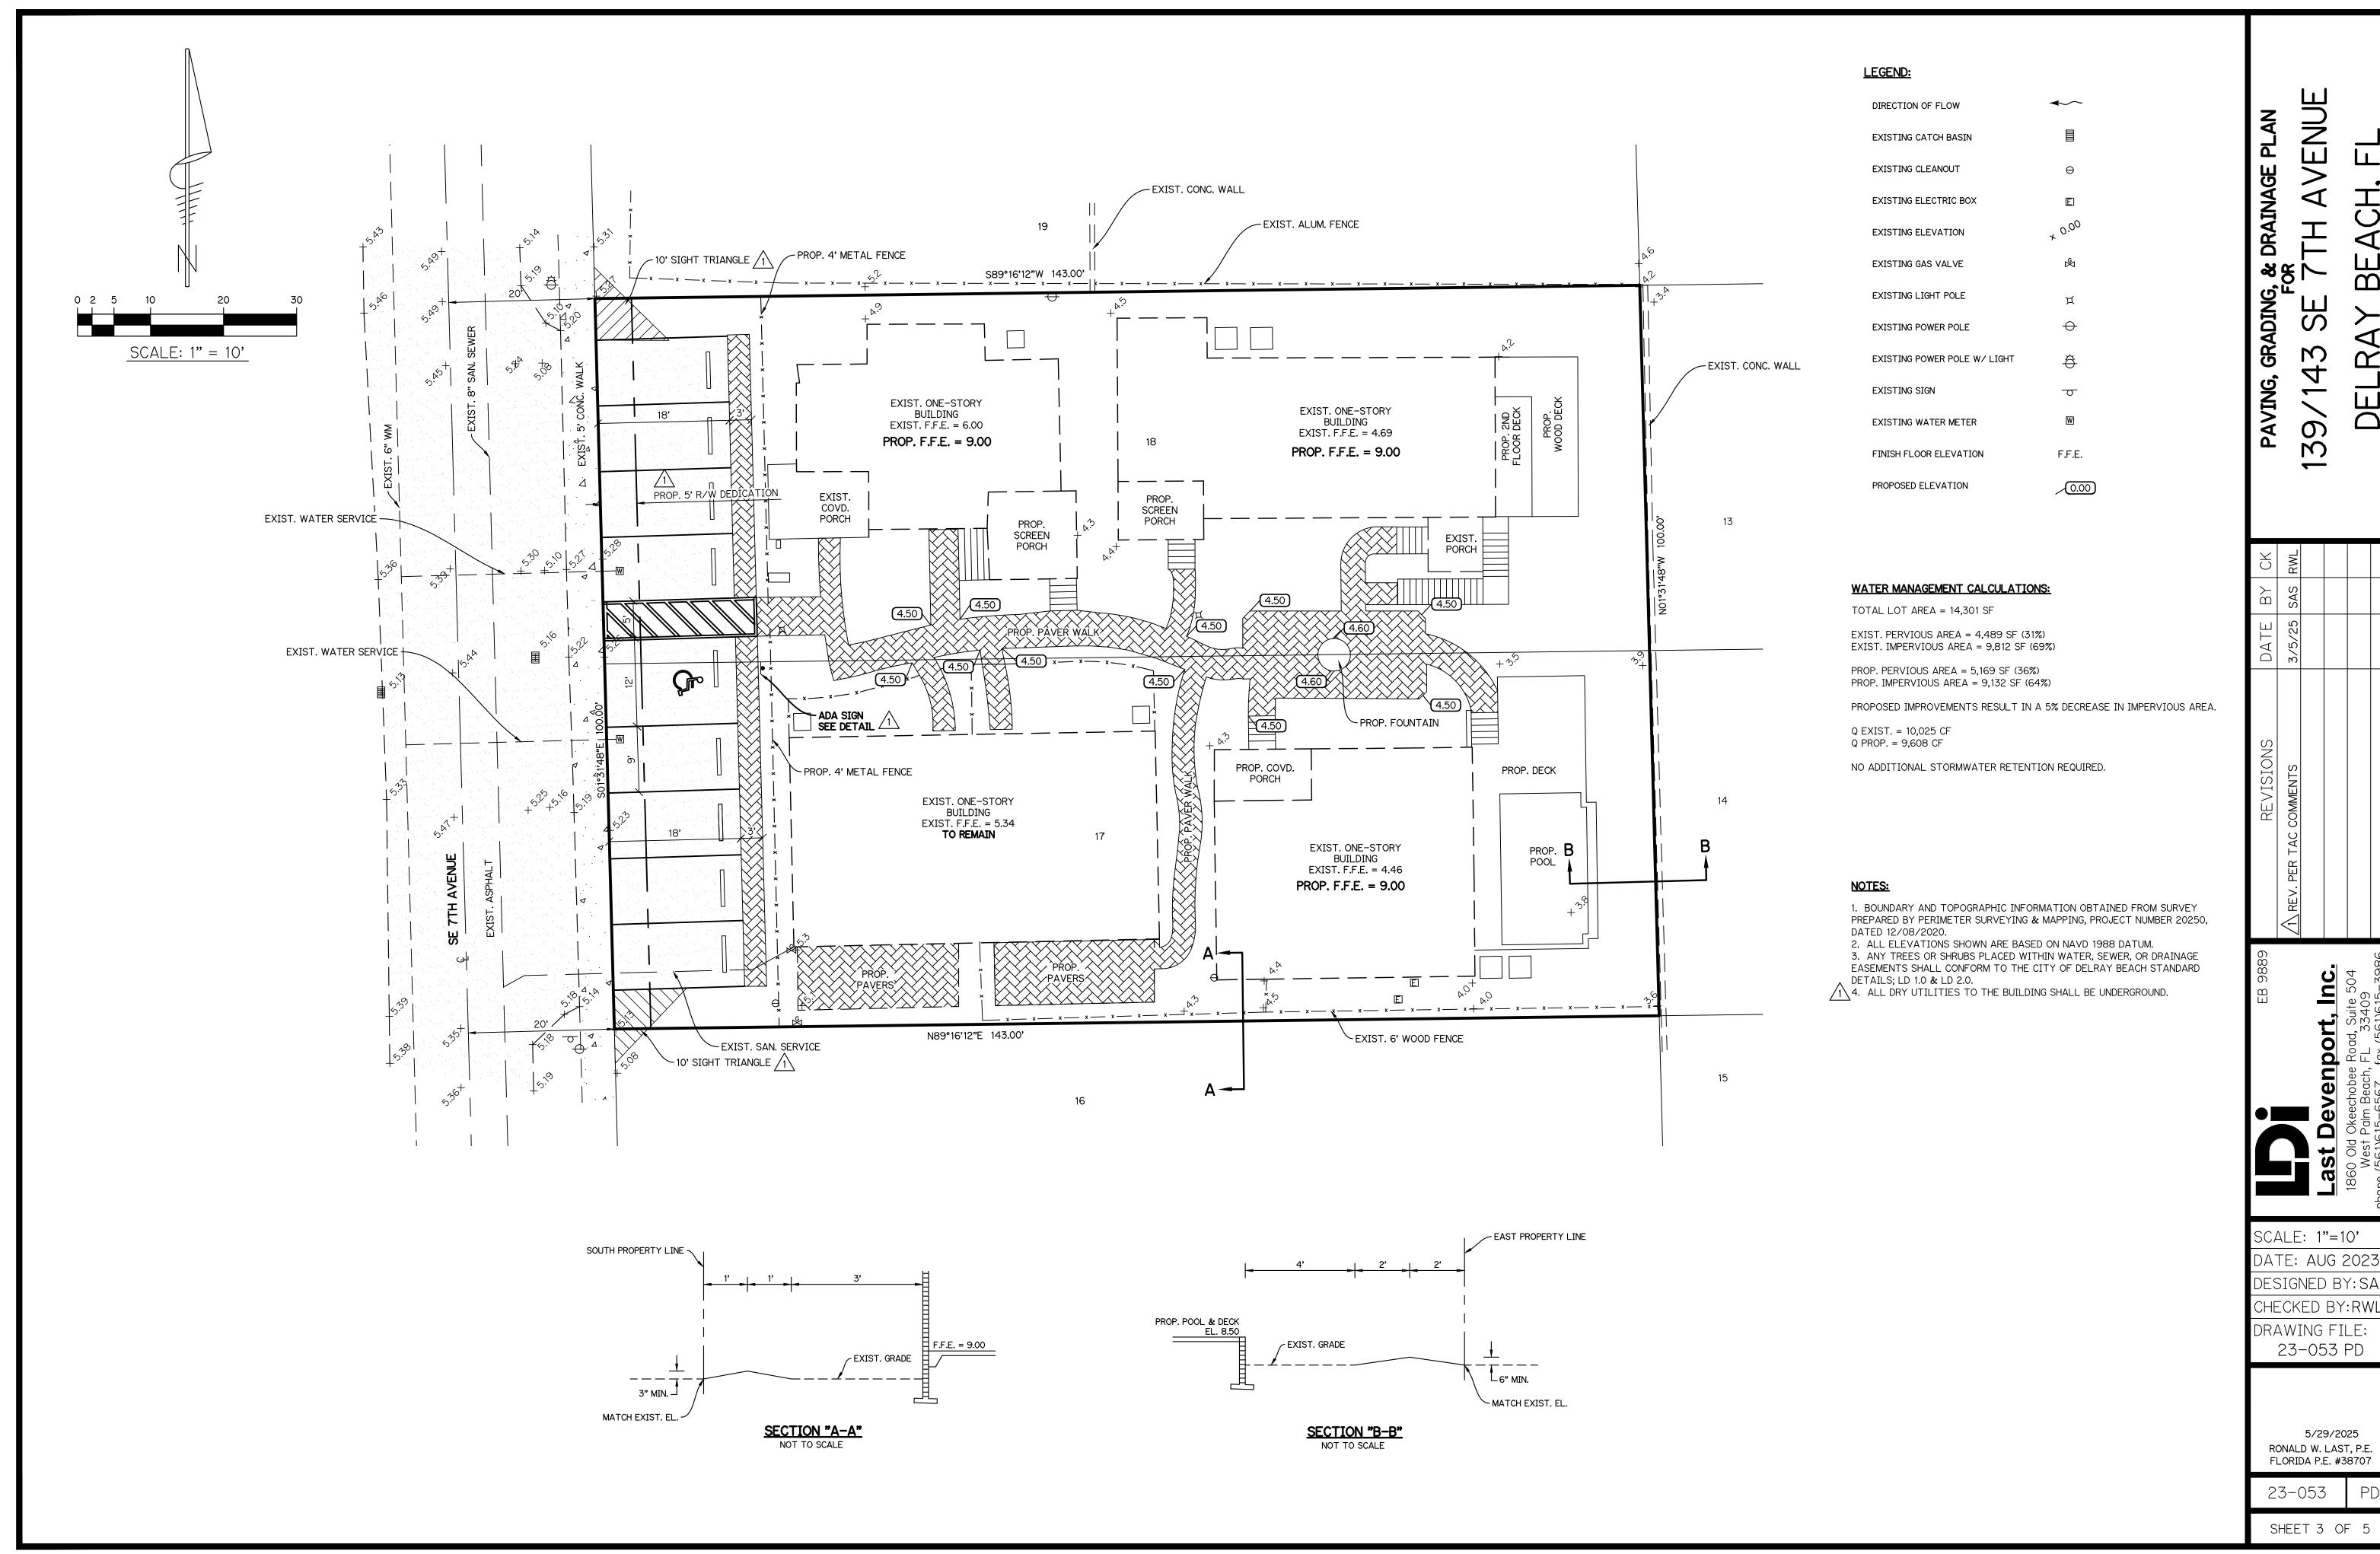



SCALE: 1"=10' DATE: AUG 2023 DESIGNED BY: SA CHECKED BY: RWL

DRAWING FILE: 23-053 PD

5/29/2025 RONALD W. LAST, P.E. FLORIDA P.E. #38707

SHEET 3 OF 5

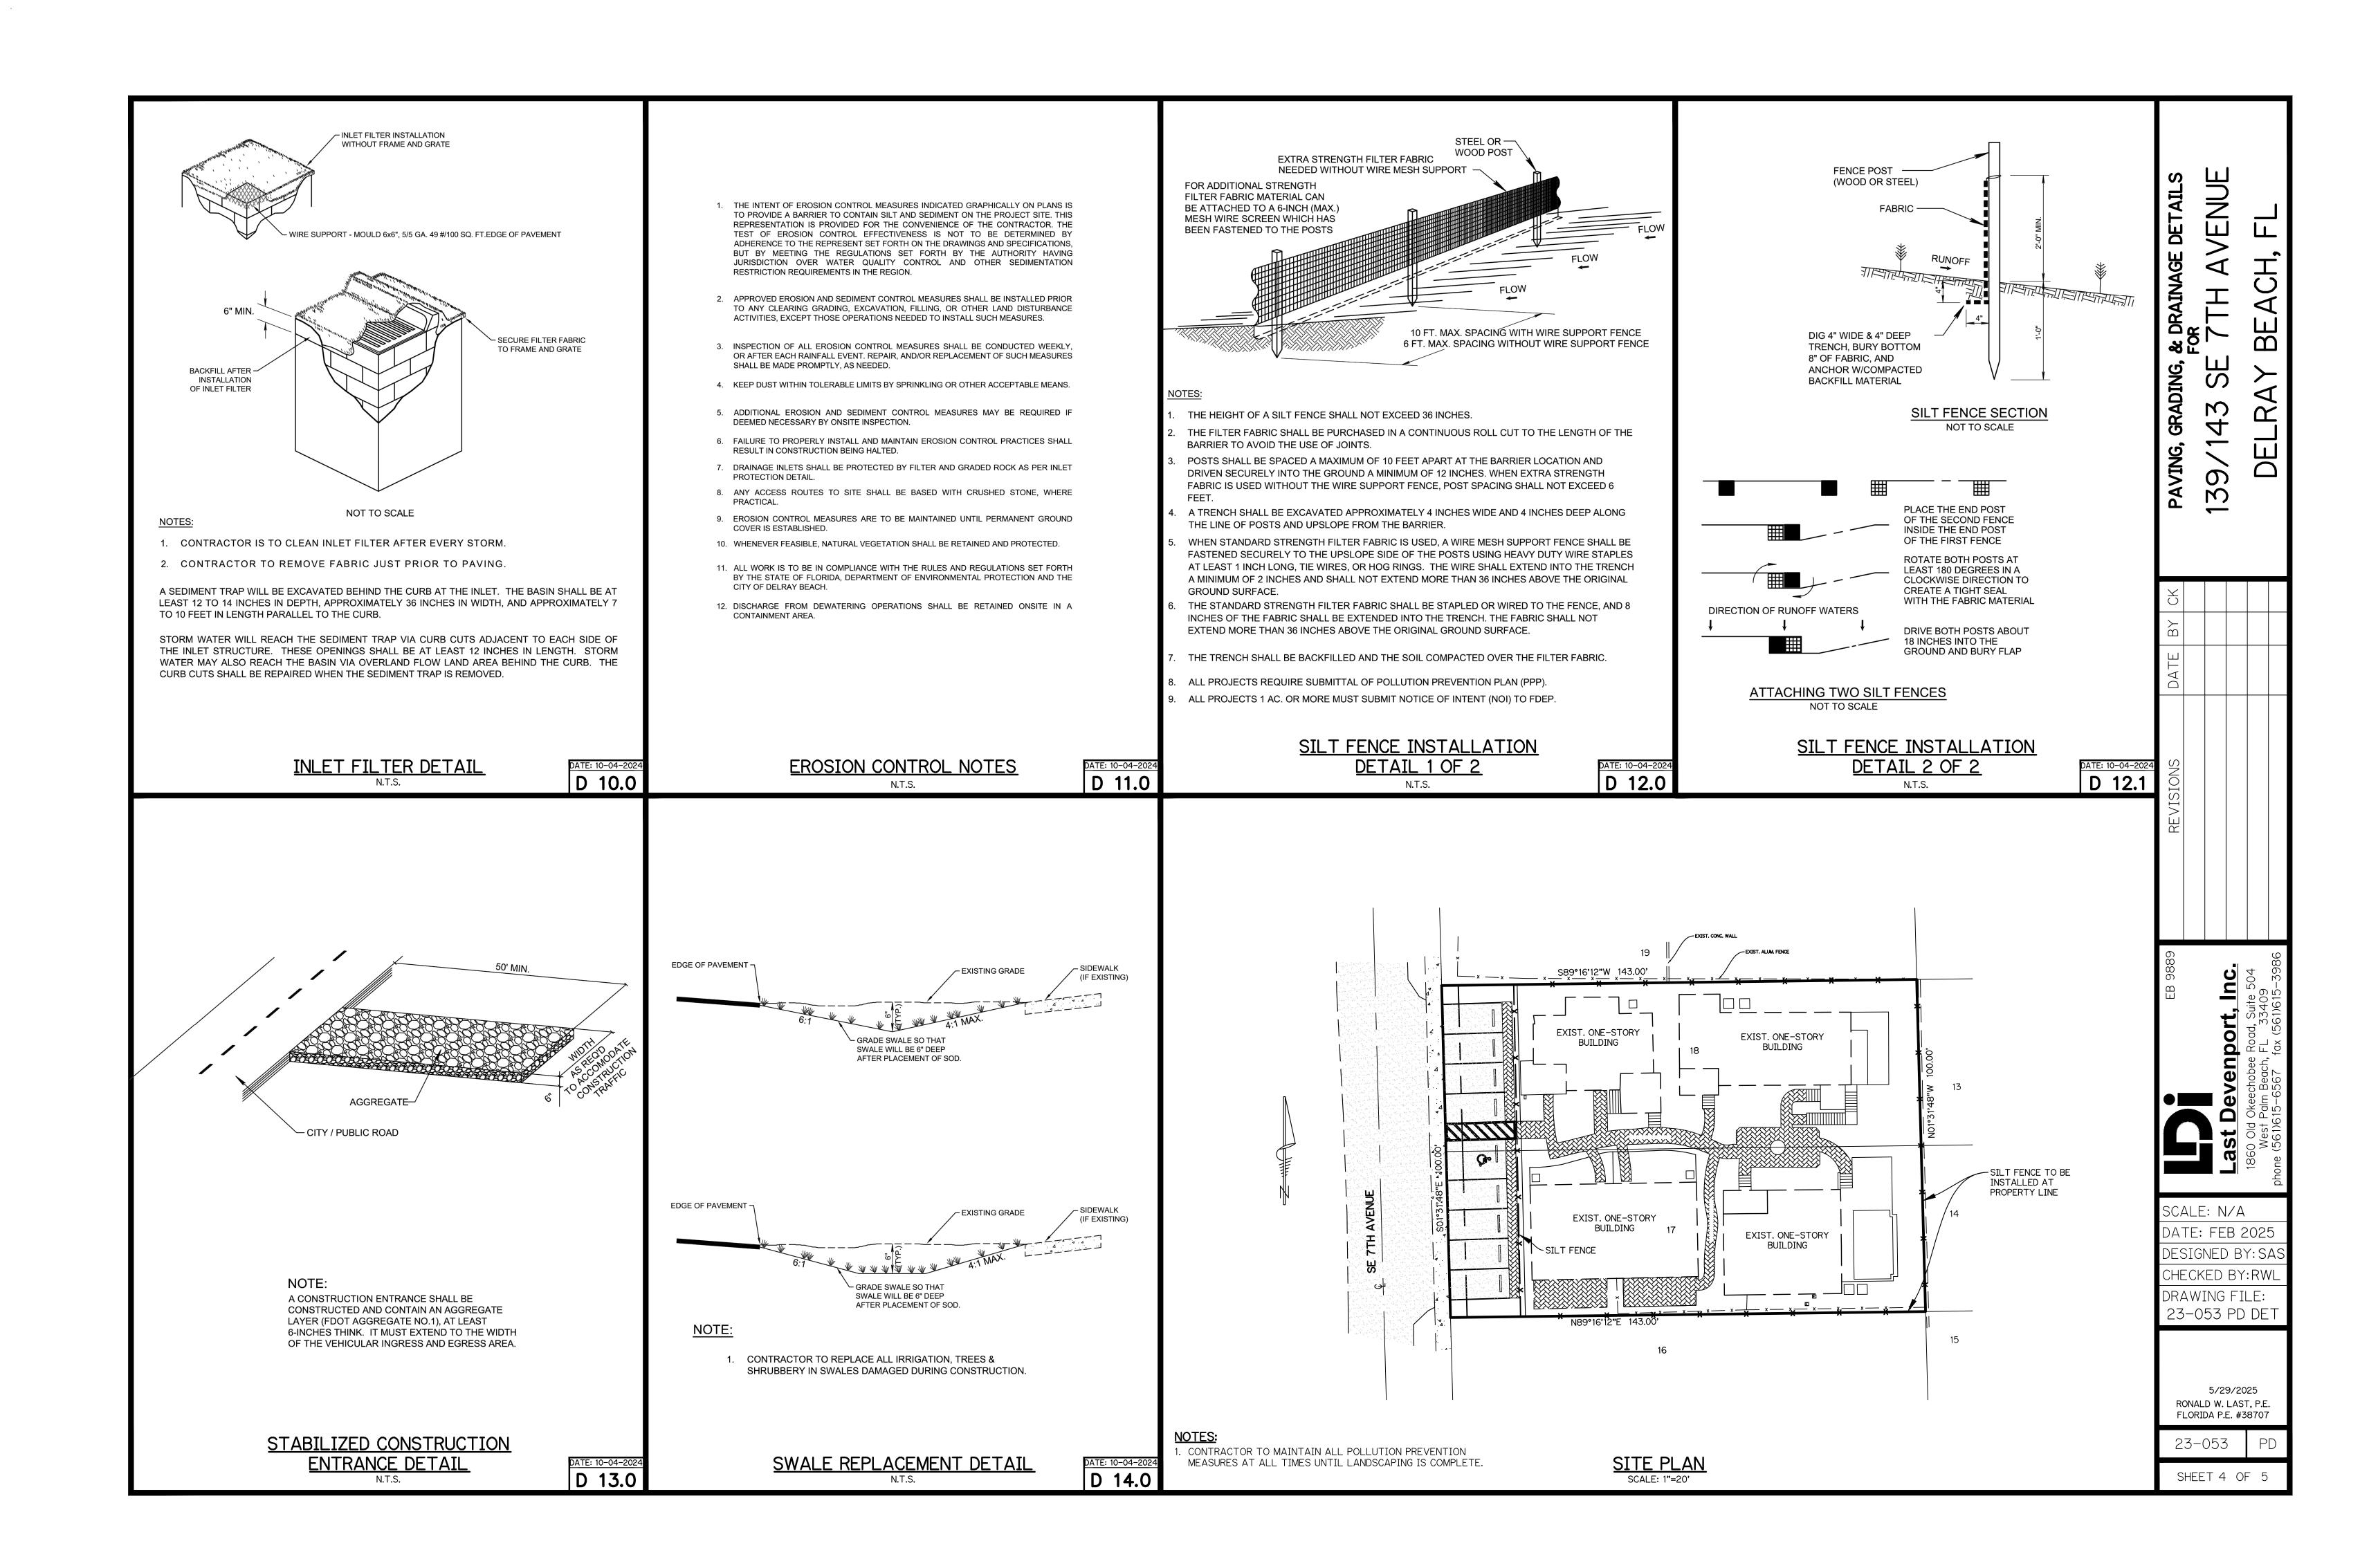

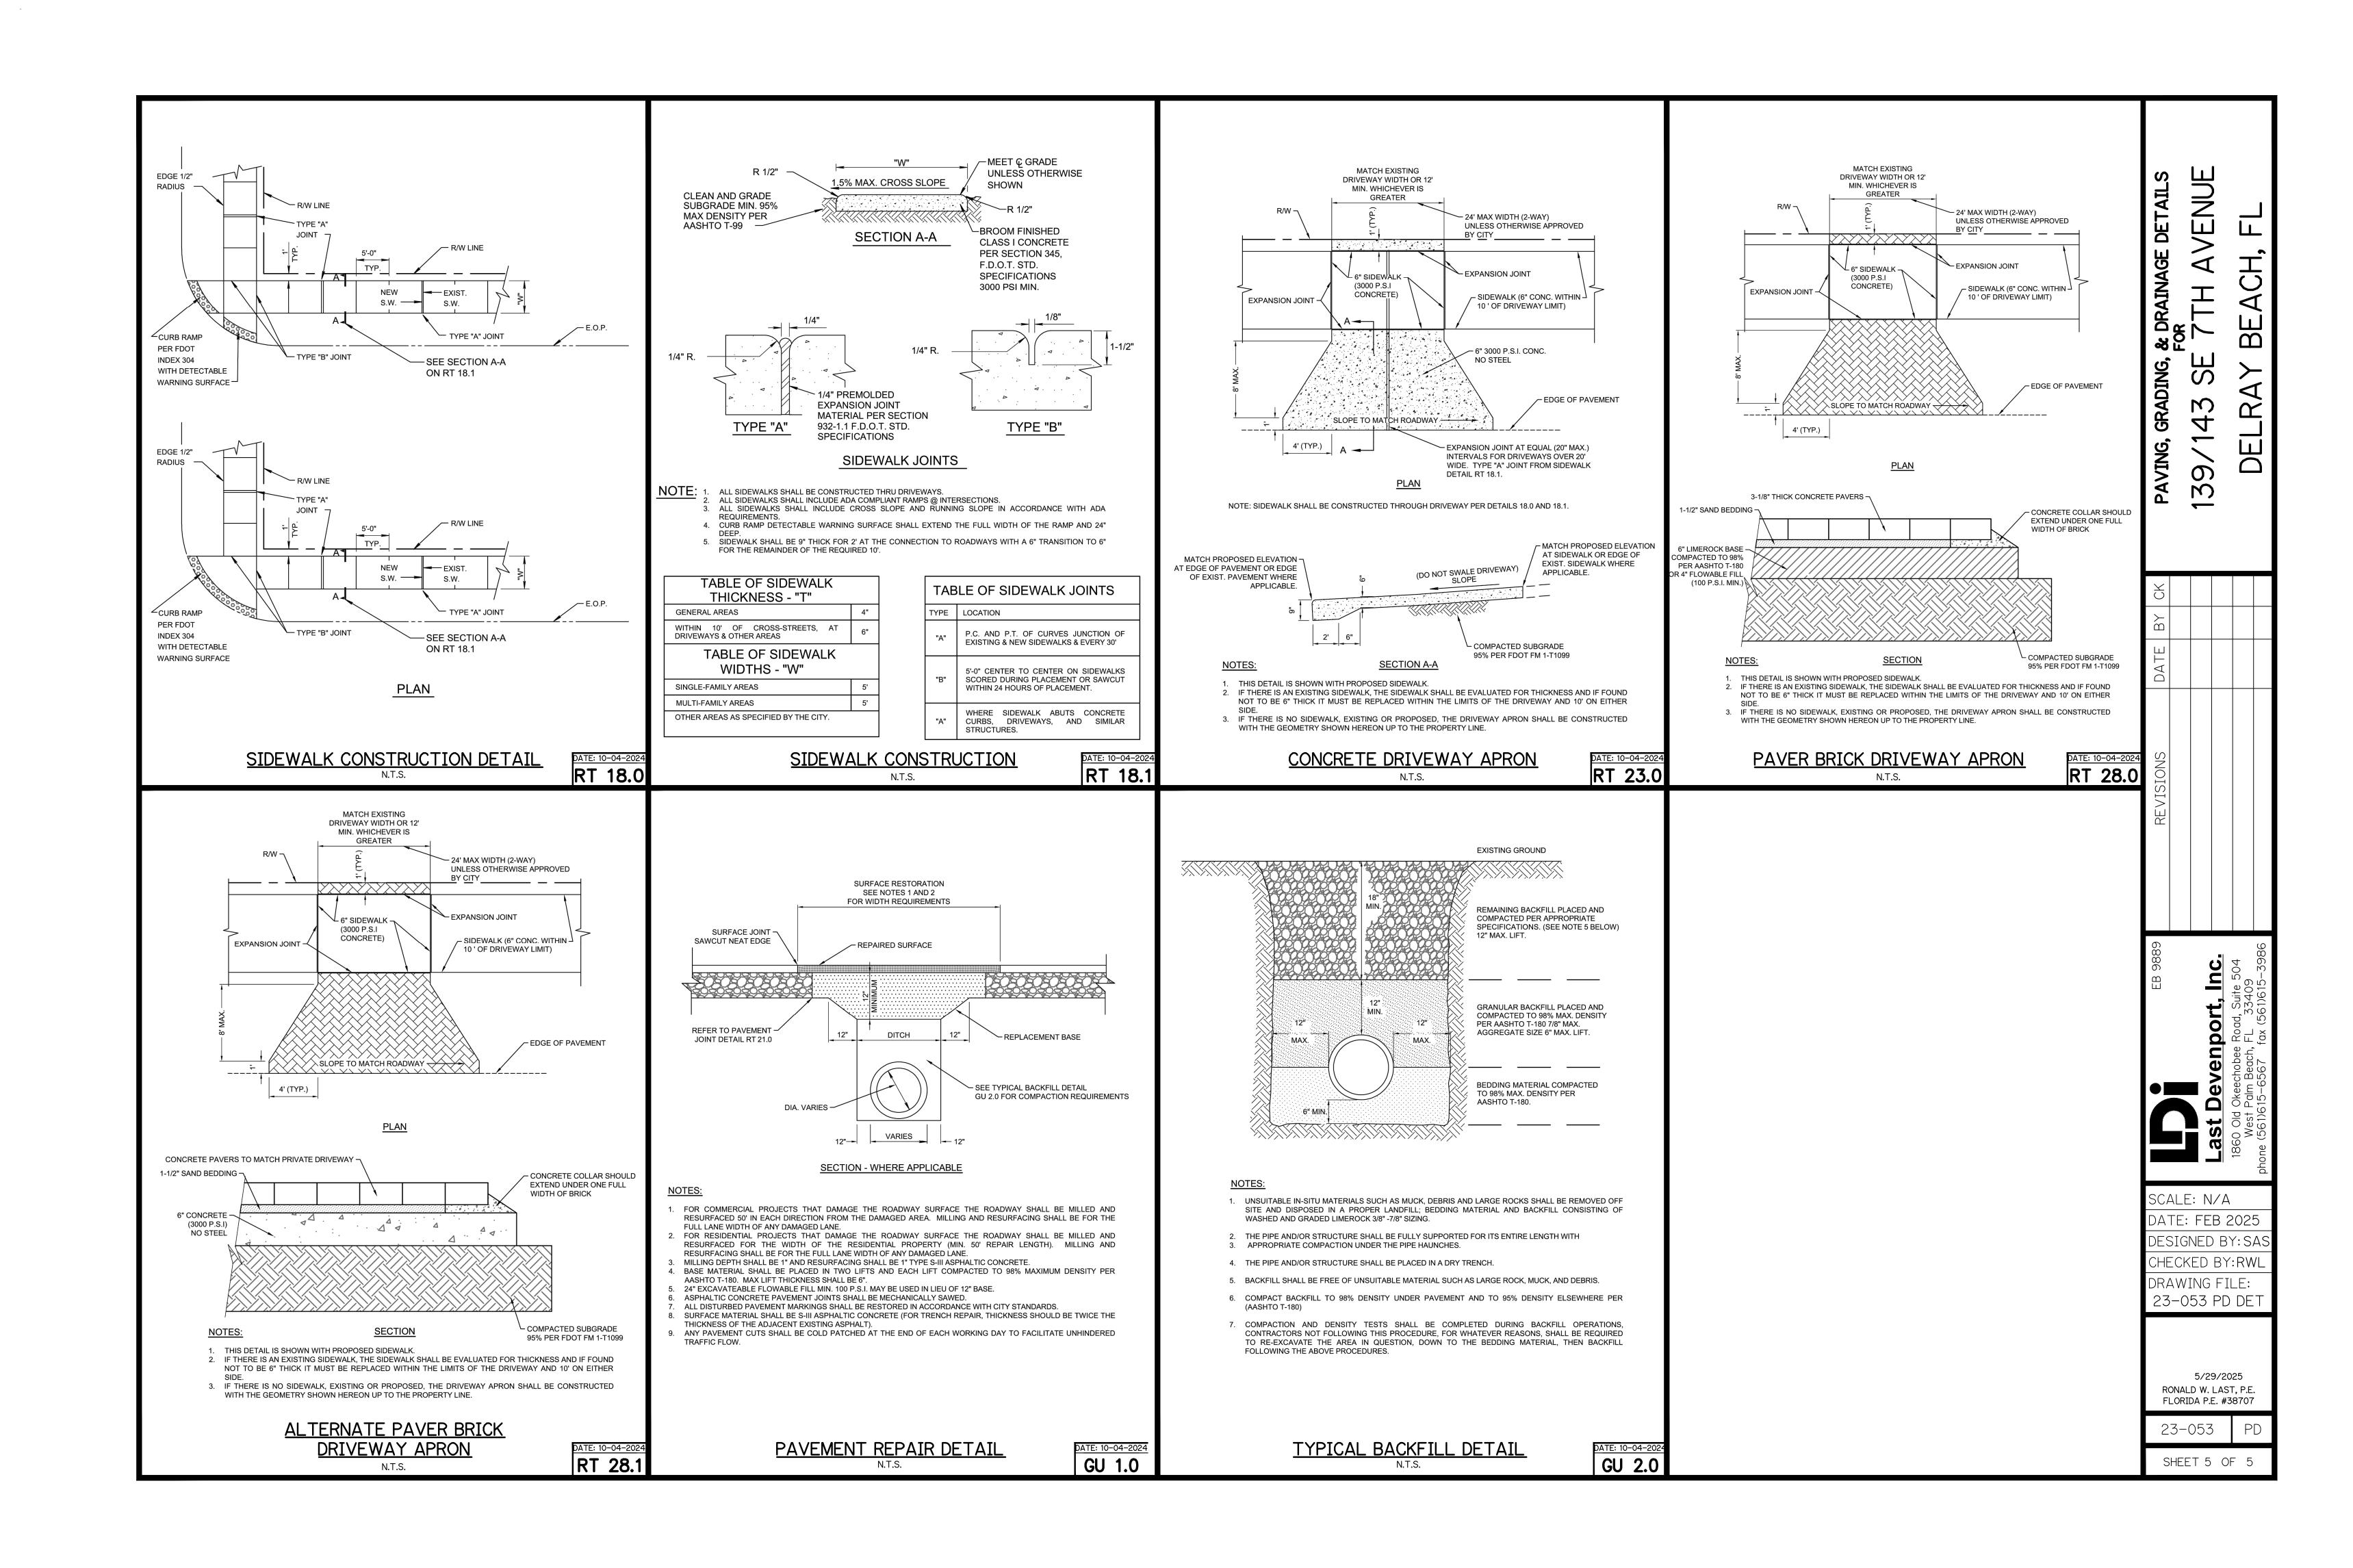


WATER & SEWER PLAN

FOR

139/143 SE 7TH AVENUE

DELRAY BEACH, FL

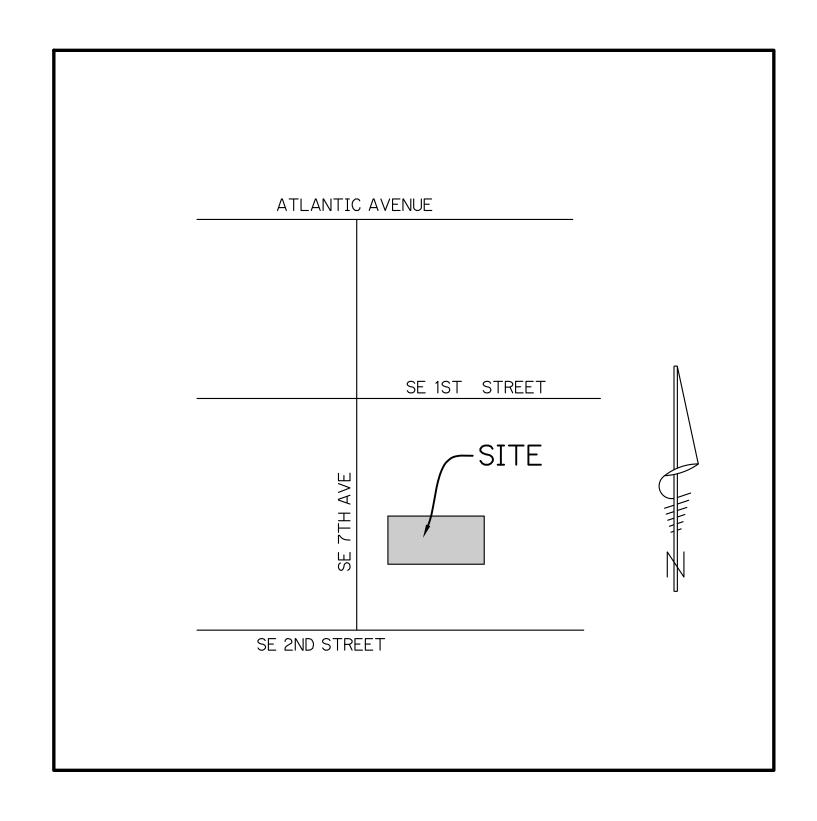

INDEX OF SHEETS


SHEET No.	DESCRIPTION
1	COVER
2	DEMOLITION PLAN
3	WATER & SEWER PLAN
4	WATER & SEWER DETAILS


LOCATION MAP


N. 1.5. SEC. 16 TWP. 46 S RGE. 43 E




1860 Old Okeechobee Road, Suite 504 West Palm Beach, FL 33409 phone (561)615-6567 fax (561)683-0872 EB 9889

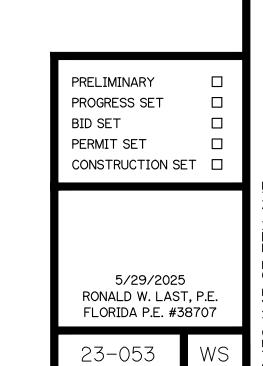

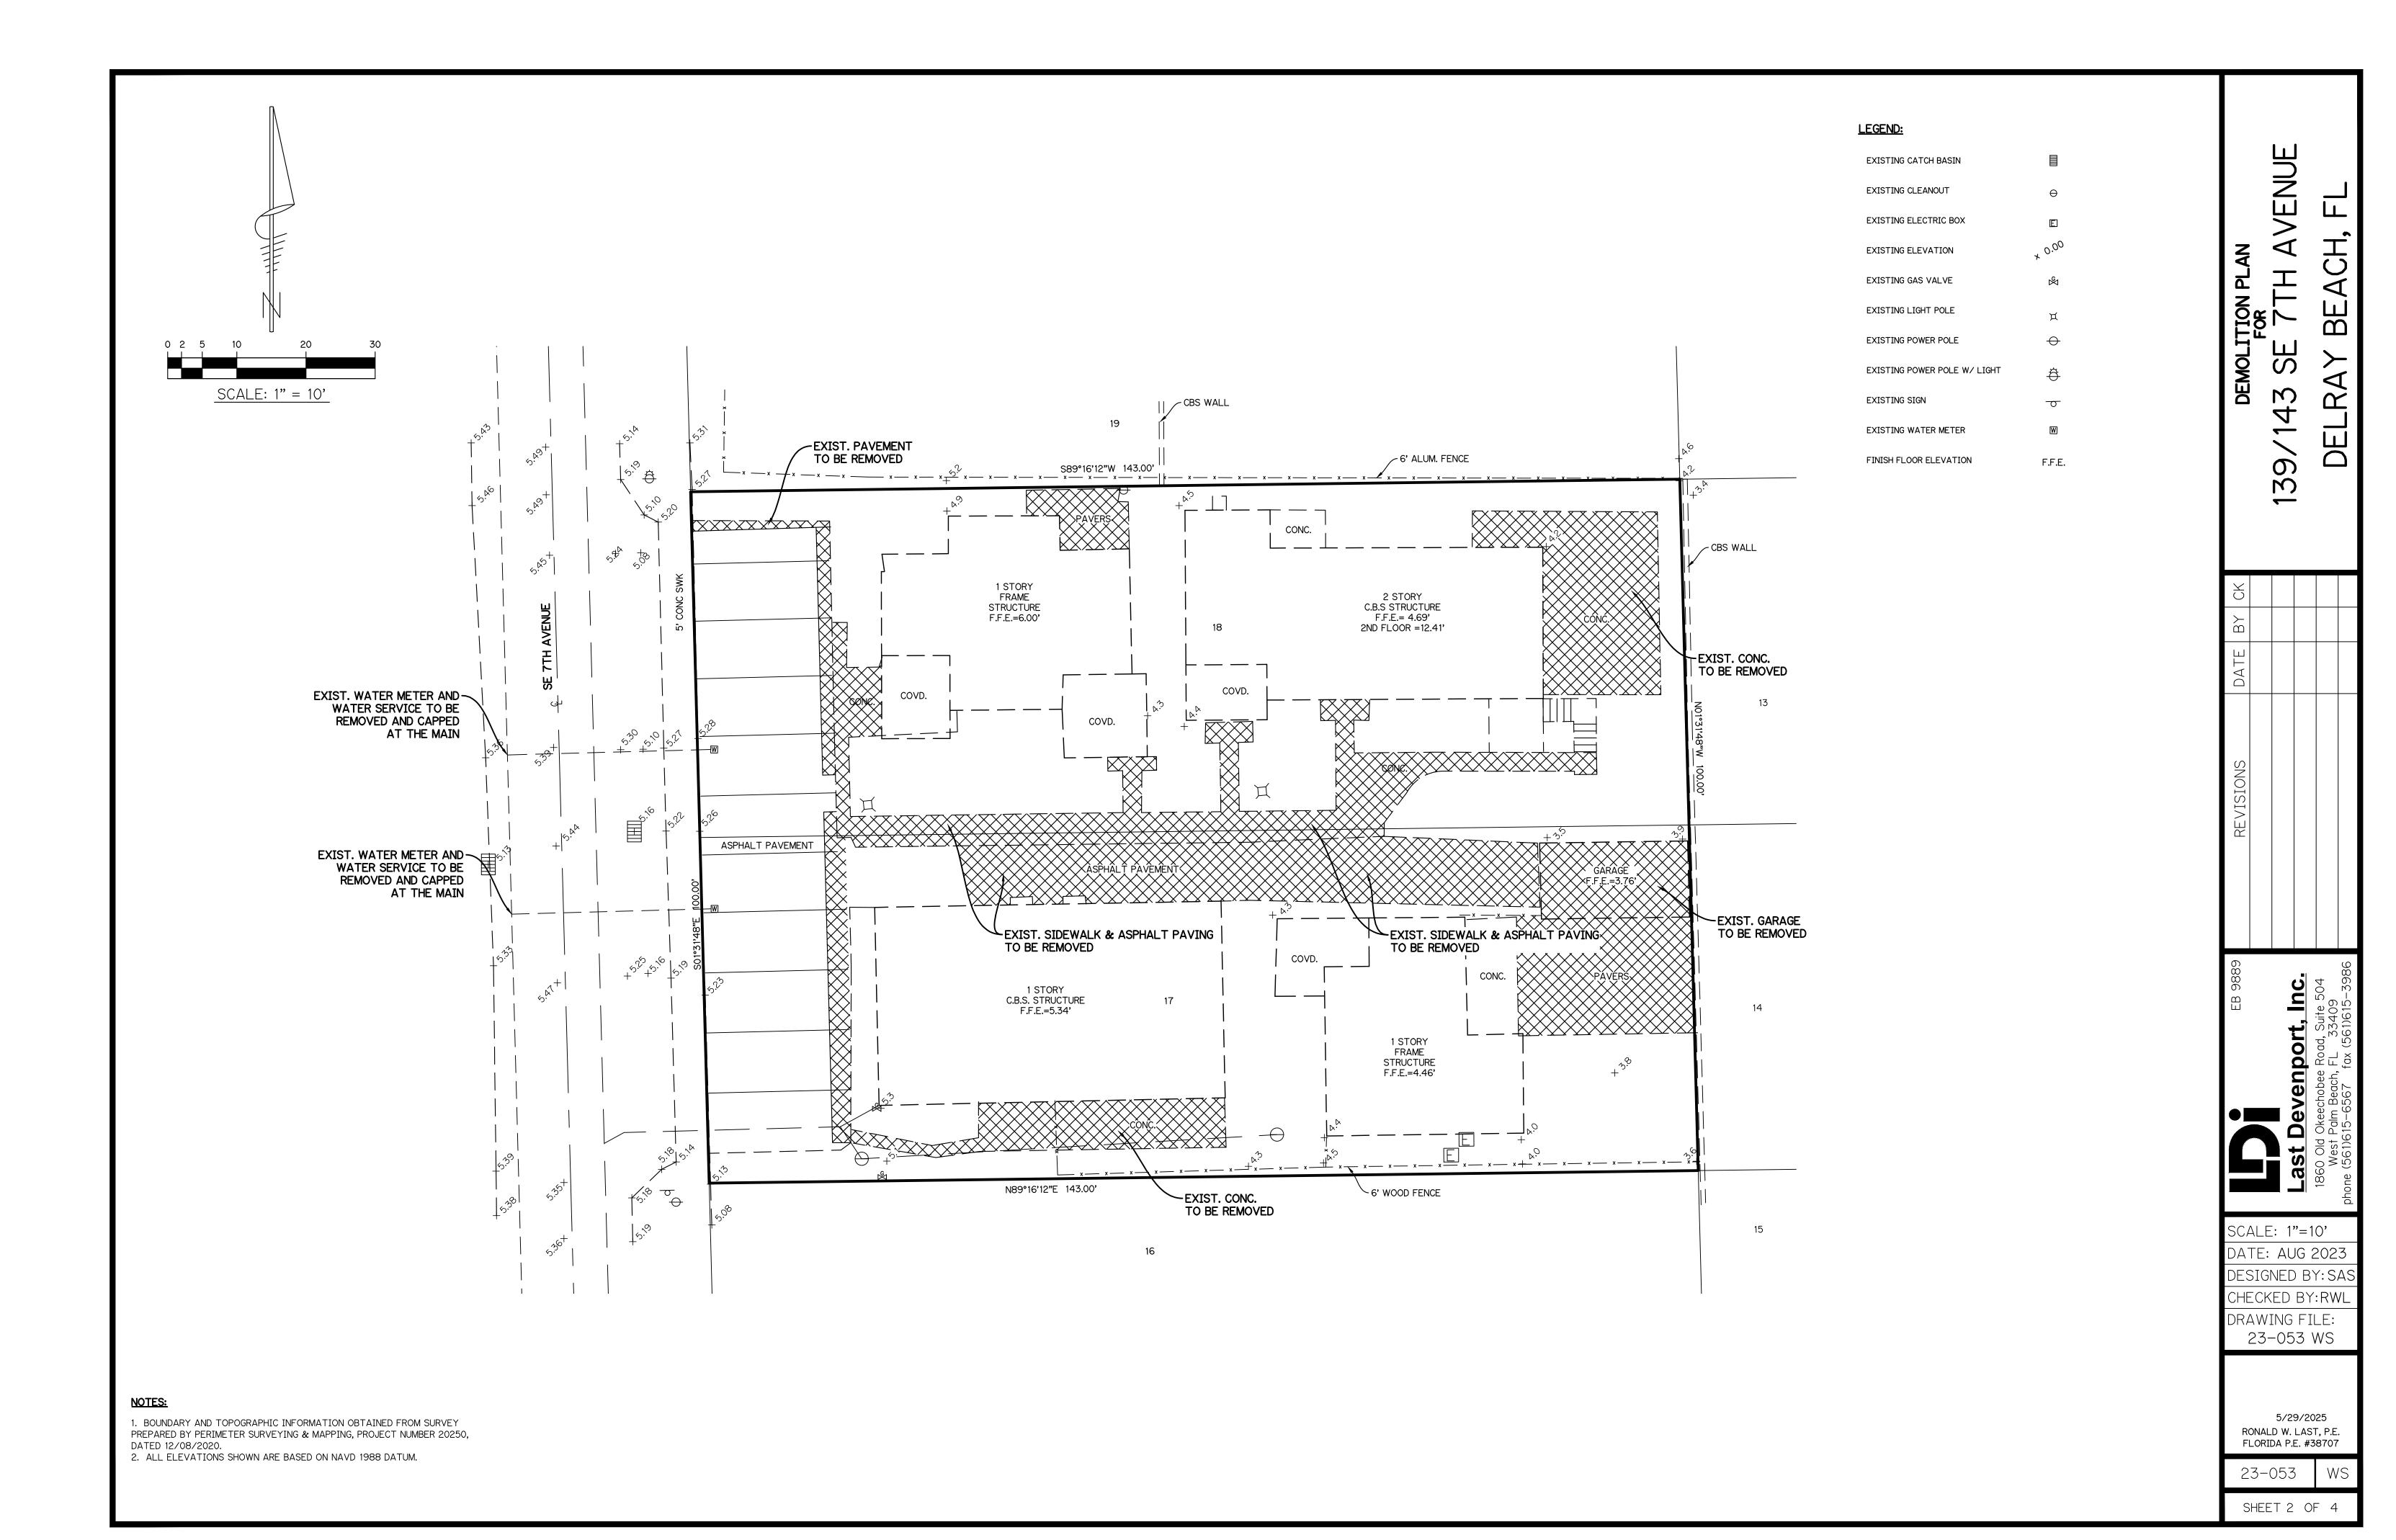

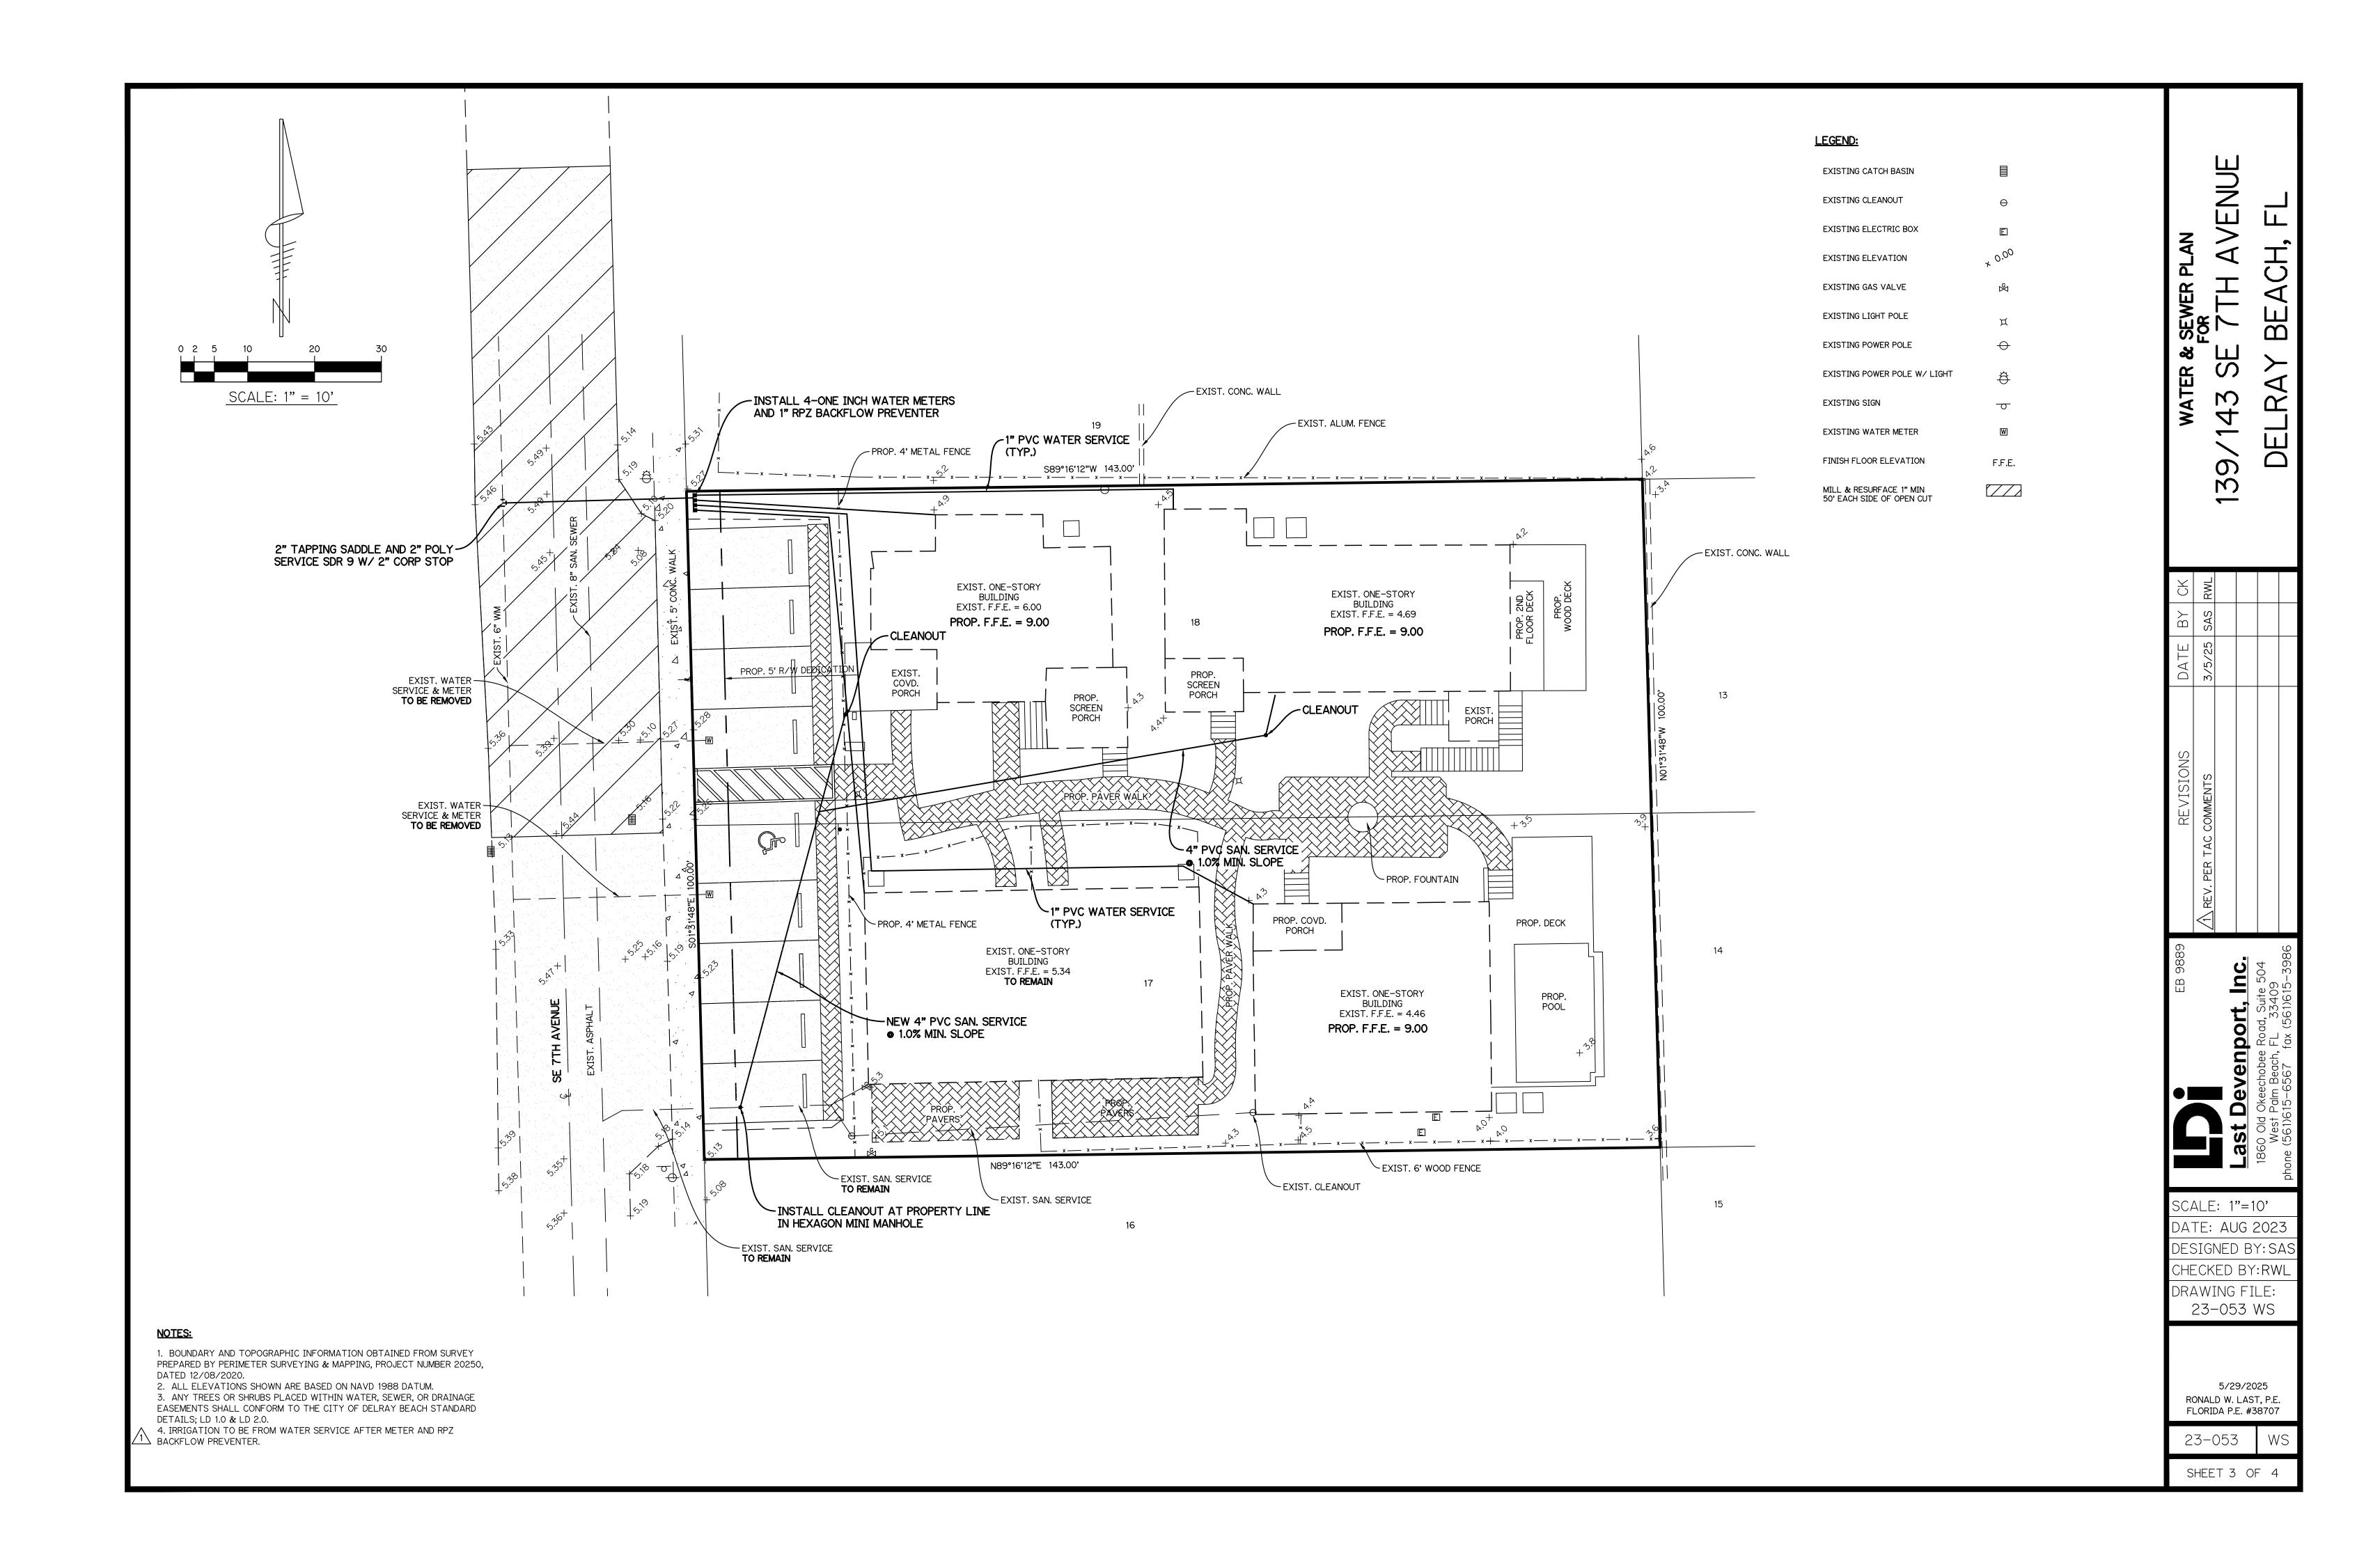

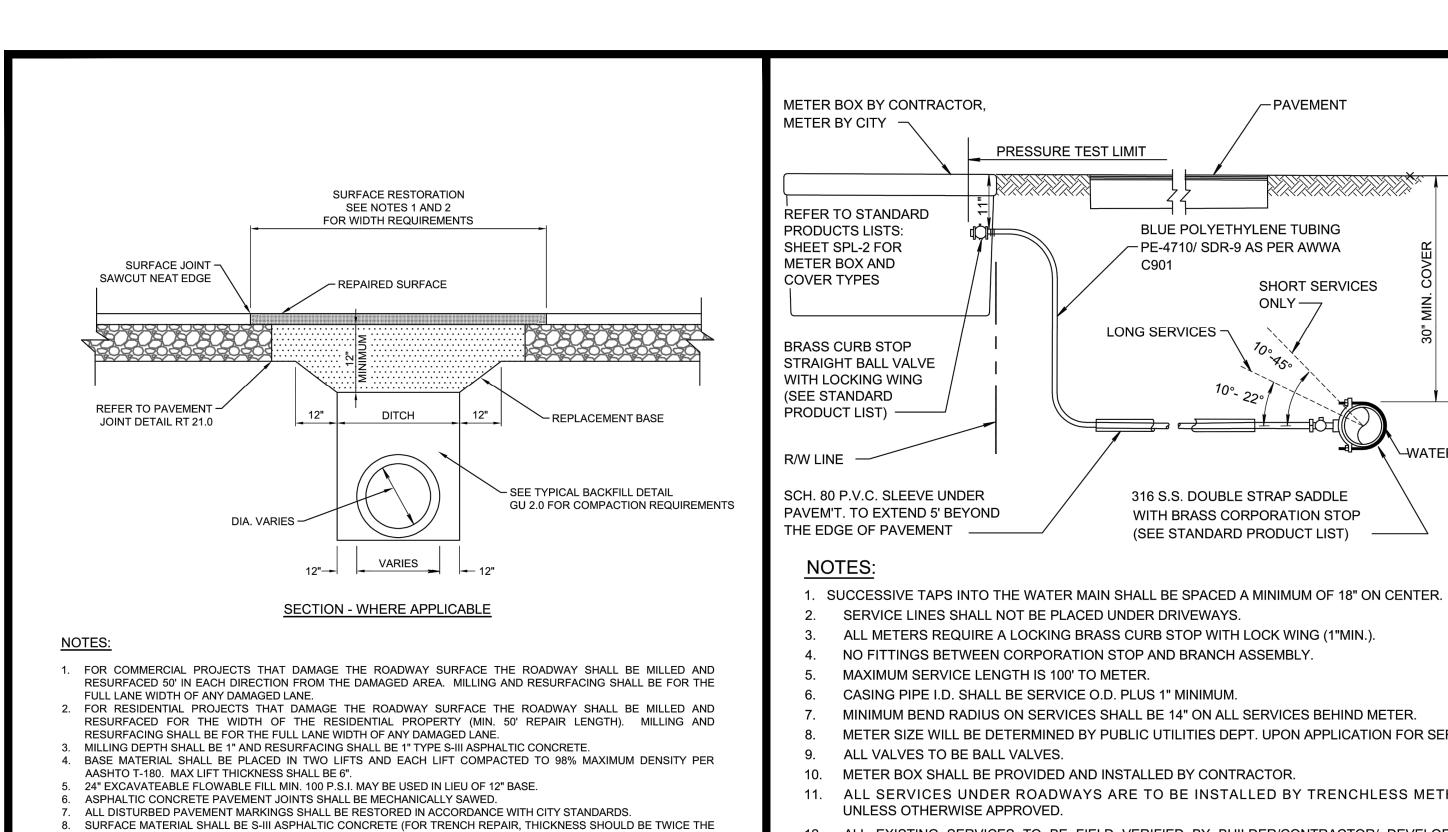

9. ANY PAVEMENT CUTS SHALL BE COLD PATCHED AT THE END OF EACH WORKING DAY TO FACILITATE UNHINDERED

PAVEMENT REPAIR DETAIL

-ROTATE BENDS AS REQUIRED

- WYE BRANCH (NO TEE

- ALTERNATE:

CONFIGURED FITTINGS)

ADDITIONAL RISER AND BEND

MIN. 6" PVC SDR 26

SLOPE UP TO P

1/8" PER FOOT MIN.

-PRIVATE SERVICE BY OTHERS

6" CLEANOUT W/6" X 6" DOUBLE WYE

MAKE CONNECTION AT

R/W LINE (TYP.)

PROPERTY LINE

6" CLEANOUT (BY OTHERS)

- R/W OR EASEMENT LINE

PROPERTY LINE

B' MAXIMUM

(BY OTHERS)

WHERE GREATER SEWER DEPTH

THICKNESS OF THE ADJACENT EXISTING ASPHALT).

TRAFFIC FLOW.

SLOPE UP TO P L

ROTATE BEND

AS REQUIRED -

UNDISTURBED SOIL

SANITARY

SANITARY

NOTE:

SEWER MAIN -

SEWER MAIN -

LAY ON

1/8" PER FOOT MIN.

EXISTING SERVICE IS GALVANIZED, BUILDER/CONTRACTOR/ DEVELOPER SHALL REPLACE WITH POLYETHYLENE PIPING FROM MAIN TO THE METER. 13. ALL WATER SERVICE SHALL BE A MINIMUM OF 2". 14. WATER METERS SHALL BE LOCATED OUTSIDE ANY DRIVEWAYS BY 2'

MINIMUM BEND RADIUS ON SERVICES SHALL BE 14" ON ALL SERVICES BEHIND METER.

METER SIZE WILL BE DETERMINED BY PUBLIC UTILITIES DEPT. UPON APPLICATION FOR SERVICE.

ALL SERVICES UNDER ROADWAYS ARE TO BE INSTALLED BY TRENCHLESS METHOD,

12. ALL EXISTING SERVICES TO BE FIELD VERIFIED BY BUILDER/CONTRACTOR/ DEVELOPER; IF

ALL METERS REQUIRE A LOCKING BRASS CURB STOP WITH LOCK WING (1"MIN.).

NO FITTINGS BETWEEN CORPORATION STOP AND BRANCH ASSEMBLY.

CASING PIPE I.D. SHALL BE SERVICE O.D. PLUS 1" MINIMUM.

MAXIMUM SERVICE LENGTH IS 100' TO METER.

UNLESS OTHERWISE APPROVED.

PRESSURE TEST LIMIT

BLUE POLYETHYLENE TUBING

SHORT SERVICES

316 S.S. DOUBLE STRAP SADDLE

WITH BRASS CORPORATION STOP


(SEE STANDARD PRODUCT LIST)

LONG SERVICES

TYPICAL URBAN/REDEVELOPMENT AREA SERVICE CONNECTION

PW 12.0

`_WATERMAIN

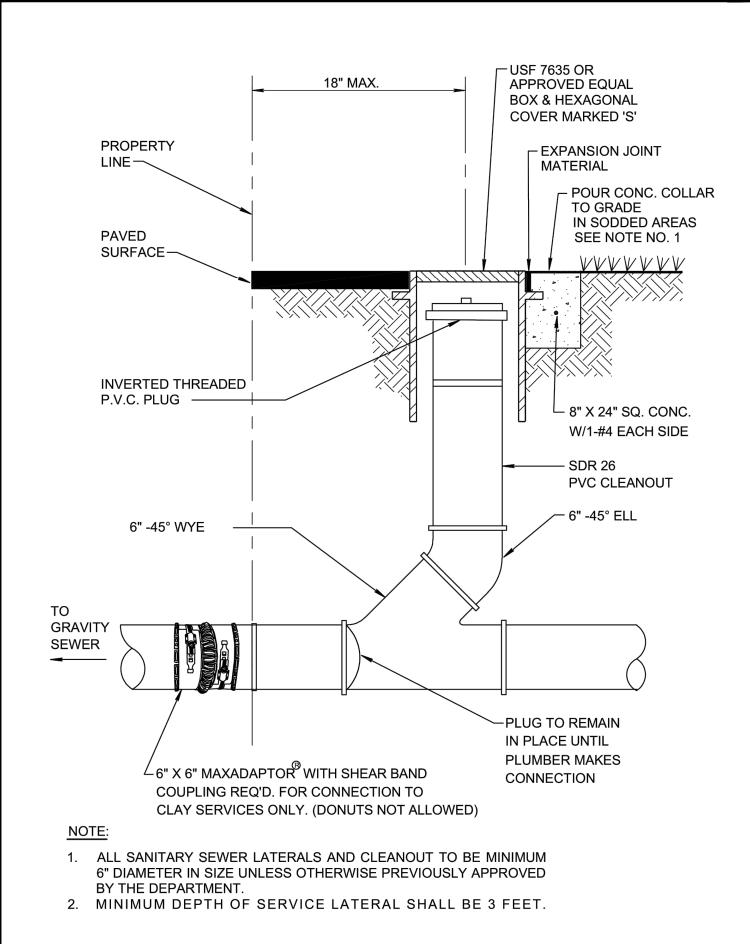

CONSTRUCTION NOTES

- 1. ALL UNSUITABLE MATERIALS, SUCH AS MUCK, HARDPAN, ORGANIC MATERIAL AND OTHER DELETERIOUS MATERIAL AS CLASSIFIED BY AASHTO M-145, FOUND WITHIN THE BUILDING PAD, ROAD AND PARKING LOT AREAS SHALL BE REMOVED DOWN TO ROCK OR SUITABLE MATERIAL, AND REPLACED WITH THE SPECIFIED FILL MATERIAL IN MAXIMUM 18" LIFTS THOROUGHLY AND UNIFORMLY COMPACTED TO ACHIEVE 95 PERCENT OF THE ASTM D1557 MAXIMUM DRY DENSITY.
- 2. ALL AREAS SHALL BE CLEARED AND GRUBBED PRIOR TO CONSTRUCTION. THIS SHALL CONSIST OF THE COMPLETE REMOVAL AND DISPOSAL OF ALL TREES, BRUSH, STUMPS, ROOTS, GRASS, WEEDS, RUBBISH AND ALL OTHER OBSTRUCTION RESTING ON OR PROTRUDING THROUGH THE SURFACE OF THE EXISTING GROUND TO A DEPTH OF 1 FOOT. ITEMS DESIGNATED TO REMAIN OR TO BE RELOCATED OR TO BE ADJUSTED SHALL BE SO DESIGNATED ON THE DRAWINGS.
- 3. FILL MATERIAL SHALL BE CLASSIFIED AS A-1, A-3, or A-2-4 IN ACCORDANCE WITH AASHTO M-145 AND SHALL BE FREE FROM VEGETATION AND ORGANIC MATERIAL. FILL MATERIAL SHOULD HAVE NOT MORE THAN 10i. BY WEIGHT PASSING THE NO. 200 SIEVE AND SHALL HAVE NO PARTICLE SIZE LARGER THAN 12". CARE SHOULD BE EXERCISED WHEN PLACING MATERIALS WHICH EXCEED 3" TO ASSURE THAT NESTING DOES NOT OCCUR AND TO FURTHER ASSURE THAT THE +3" PARTICLES ARE FULLY SURROUNDED BY FINER GRAINED MATERIAL.
- 4. THE CONTRACTOR SHALL BE RESPONSIBLE FOR PROVIDING CERTIFIED MATERIAL TEST RESULTS TO THE ENGINEER OF RECORD PRIOR TO THE RELEASE OF FINAL CERTIFICATION BY THE ENGINEER. TEST RESULTS MUST INCLUDE, BUT MAY NOT BE LIMITED TO, DENSITIES FOR SUBGRADE AND LIMEROCK, UTILITIES, EXCAVATION, ASPHALT GRADATION REPORTS, CONCRETE CYLINDERS, ETC.
- 5. ALL PROPOSED ELEVATIONS REFER TO FINISHED GRADES.
- 6. ALL CONSTRUCTION SHALL BE IN ACCORDANCE WITH THE MINIMUM STANDARDS OF THE CITY OF DELRAY BEACH ENGINEERING DIVISION.
- 7. ALL HANDICAP SPACES, RAMPS, AND ACCESS AREAS SHALL COMPLY IN STRICT ACCORDANCE WITH THE "AMERICAN DISABILITY ACT" (ADA) (28 CFR PART 36), AND "ACCESSIBILITY BY HANDICAPPED PERSONS", CHAPTER 553, PART V, FLORIDA STATUTES. ANY DISCREPANCY SHALL BE CALLED TO THE ENGINEER'S ATTENTION PRIOR TO CONSTRUCTION.
- 8. UNDER FLORIDA STATUTES, THE CONTRACTOR MUST PROVIDE A 48 HOUR NOTIFICATION PRIOR TO ANY OPERATION WHICH WOULD "PIERCE THE EARTH'S SURFACE" WITH THE WORK STARTED WITHIN FIVE WORKING DAYS AFTER ALL UNDERGROUND UTILITIES HAVE BEEN IDENTIFIED. THE NOTIFICATION NUMBER IS A ONE CALL SYSTEM STATEWIDE AT (800) 432-4770. FAILURE TO COMPLY COULD RESULT IN FINES AND DAMAGES.

UNIVERSAL COLOR CODE FOR MARKING UNDERGROUND UTILITY LINES

RED ELECTRIC GAS-OIL YELLOW COMMUNICATION, CATV ORANGE WATER BLUE GREEN SEWER SURVEY MARKINGS PINK PROPOSED EXCAVATION

- 9. THE LOCATION AND SIZE OF ALL EXISTING UTILITIES AND TOPOGRAPHY HAS BEEN PREPARED FROM THE MOST RELIABLE INFORMATION AVAILABLE TO THE ENGINEER. THIS INFORMATION IS NOT GUARANTEED AND IT IS THE CONTRACTOR'S RESPONSIBILITY TO DETERMINE THE EXACT LOCATION OF ANY EXISTING UTILITIES AND TOPOGRAPHY PRIOR TO CONSTRUCTION. THE CONTRACTOR SHALL VERIFY ALL UTILITIES, BY ELECTRONIC METHODS AND BY HAND EXCAVATION IN COORDINATION WITH ALL UTILITY COMPANIES. PRIOR TO BEGINNING ANY CONSTRUCTION OPERATIONS. ANY AND ALL CONFLICTS OF EXISTING UTILITIES WITH PROPOSED IMPROVEMENTS SHALI BE RESOLVED BY THE ENGINEER PRIOR TO BEGINNING ANY CONSTRUCTION OPERATIONS. THIS WORK BY THE CONTRACTOR SHALL BE CONSIDERED INCIDENTAL TO THE CONTRACT AND NO ADDITIONAL COMPENSATION SHALL BE ALLOWED.
- 10. PRIOR TO CONSTRUCTION, THE CONTRACTOR SHALL NOTIFY THE FOLLOWING UTILITY COMPANIES IF APPLICABLE.

FLORIDA POWER AND LIGHT COMPANY

A T & T DELRAY BEACH WATER UTILITIES DEPARTMENT LOCAL CABLE TELEVISION COMPANY(S) FLORIDA DEPARTMENT OF TRANSPORTATION LOCAL GAS COMPANY

- 11. ALL ELEVATIONS ARE BASED UPON THE NORTH AMERICAN VERTICAL DATUM (NAVD) OF 1988.
- 12. THE CONTRACTOR SHALL BE RESPONSIBLE FOR THE REPAIR AND RESTORATION OF EXISTING PAVEMENT, PIPES, CONDUITS, CABLES, ETC., AND LANDSCAPED AREAS DAMAGED AS A RESULT OF THE CONTRACTOR'S OPERATIONS AND/OR THOSE OF HIS SUBCONTRACTORS AND SHALL RESTORE THEM PROMPTLY.
- 13. FLOOD INFORMATION IS AS FOLLOWS:

COMMUNITY NUMBER: 125102 PANEL NUMBER: 0979 DATE OF FIRM INDEX: OCTOBER 5, 2017

ZONE: BASE FLOOD ELEV: N/A

14. CONTRACTOR SHALL VERIFY EXISTING WATER SERVICE MATERIAL. IF THE WATER SERVICE IS GALVANIZED THEN IT SHALL BE REPLACED TO THE WATER MAIN PER PW 9.1a AT THE OWNERS EXPENSE.

 \triangleleft \mathbf{m} S

enport **6**

C

CALE: N/A ATE: FEB 2025) DESIGNED BY: SA CHECKED BY:RWI DRAWING FILE: 23-053 WS DE

> 5/29/2025 RONALD W. LAST, P.E. FLORIDA P.E. #38707

SHEET 4 OF 4

23-053

SEWER SERVICE CONNECTION

1. SERVICE LATERALS SHALL TERMINATE INSIDE PROPERTY LINE A DEPTH OF 3

CLEANOUT INSTALLATION SHALL BE PROPERTY OWNERS RESPONSIBILITY AND

DOUBLE SERVICE

6" MIN. SERVICE LINE

SINGLE SERVICE

6" MIN. SERVICE LINE

MAX.

MAX.

PVC SDR 26

PVC SDR 26

FEET AND MARKED WITH A 2"X 4" TREATED STAKE.

3. SEE DETAIL PW 2.0 FOR SEPARATION REQUIREMENTS.

SHALL BE INSTALLED BY LICENSED PLUMBER.

WW 8.0

GU 1.0

TYPICAL CLEANOUT

947 Clint Moore Road Boca Raton, Florida 33487



Tel: (561) 241-9988 Fax: (561) 241-5182

BOUNDARY AND TOPOGRAPHIC SURVEY 139-143 SE 7TH AVENUE, DELRAY BEACH, FL

LEGAL DESCRIPTION

LOTS 17 AND 18 IN BLOCK 126 OF DELRAY BEACH, ACCORDING TO THE PLAT THEREOF, AS RECORDED IN PLAT BOOK 11, AT PAGE 4, OF THE PUBLIC RECORDS OF PALM BEACH COUNTY, FLORIDA.

SAID LANDS SITUATE IN THE CITY OF DELRAY BEACH, FLORIDA, AND CONTAIN 14,300 SQUARE FEET, MORE OR LESS.

NOTES

1. REPRODUCTIONS OF THIS SKETCH ARE NOT VALID WITHOUT THE SIGNATURE AND THE ORIGINAL RAISED SEAL OF A FLORIDA LICENSED SURVEYOR AND MAPPER. 2. NO SEARCH OF THE PUBLIC RECORDS WAS MADE IN THE PREPARATION OF THIS SKETCH AND DESCRIPTION. 3. BEARINGS SHOWN HEREON ARE BASED ON THE CENTER LINE OF SE 7TH AVENUE HAVING AN ASSUMED BEARING OF SOUTH 01° 31'48" EAST.


ELEVATIONS SHOWN HEREON ARE BASED ON NAVD 1988 DATUM RELATIVE TO PALM BEACH COUNTY BENCHMARK 14.33SRD HAVING AN ELEVATION OF 12.782'.

FLOOD INFORMATION

COMMUNITY NUMBER : 125102

PANEL NUMBER : 12099C0979F DATE OF FIRM : OCTOBER 5, 2017

ZONE : AE BASE FLOOD ELEV : 6.0'

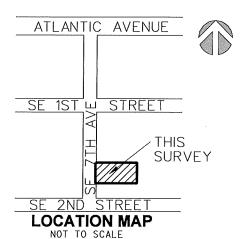

LEGEND

 \leftarrow — ANCHOR CATCH BASIN CLEAN OUT E ELECTRIC SERVICE GAS VALVE LIGHT POLE M MAIL BOX WOOD POWER POLE W WATER VALVE -X-- FENCE ---- OVERHEAD LINE + ELEVATION

ABBREVIATIONS

ALUM CONC. ALUMINUM CONCRETE
CONCRETE BLOCK & STUCCO
DELTA (CENTRAL ANGLE) CBS Ď.E. DRAINAGE EASEMENT IRON ROD IRON ROD AND CAP I.R. I.R.C. L.B. L.S. LICENSED BUSINESS LICENSED SURVEYOR SURVEYOR MON. MONUMENT POINT OF BEGINNING
POINT OF COMMENCEMENT
PLAT BOOK
PALM BEACH COUNTY RECORDS O.R.B. P.O.B. P.O.C. P.B.C.R. PAGE PROFESSIONAL SURVEYOR & MAPPER RIGHT-OF-WAY UTILITY EASEMENT R/W U.E. COVERED COV SIDEWALK SWK.

WOOD FENCE

FINISHED FLOOR ELEVATION

CERTIFICATION

FF ELEV I HEREBY CERTIFY THAT THE SURVEY SHOWN HEREON COMPLIES WITH STANDARDS OF PRACTICE AS CONTAINED IN CHAPTER 5J-17.051, FLORIDA ADMINISTRATIVE CODE, PURSUANT TO SECTION 472.027, FLORIDA STATUTES, AND THAT SAID SURVEY IS TRUE AND CORRECT TO THE BEST OF MY KNOWLEDGE AND BELIEF AS PREPARED UNDER MY DIRECTION.

JEFF S. HODAPP SURVEYOR AND MAPPER FLORIDA LICENSE NO. LS5111

LAST DATE OF FIELD WORK: DEC. 8, 2020

W.F.

		020. G, 2020
Project Name: 139-143 SE 7TH AVE		DATE: 12/8/2020
JOB NO. 20250	DWG BY: JSH	
	СК'D By: AJR	SHEET 1 OF 2

