## LOCATION MAP:



### LIST OF DRAWINGS:

С 5. І	COVER SHEET
С 5.2	SCREEN AND RAILING DETAILS
A I . I I	SITE PLAN
A   .	SITE PLAN
	BUILDING A FLOOR PLAN
A - I . I	BUILDING ROOF PLAN
A - I.2	BUILDING A ELEVATIONS
A - I.3	BUILDING A ELEVATIONS
BF2.0	BUILIDNG B¢F FLOOR PLAN
BF-2.1	BUILIDNG B¢F ROOF PLAN
	BUILDING B&F ELEVATIONS
BF-2.3	BUILDING B&F ELEVATIONS
	BUILDING B&F ELEVATIONS
С-З.О	BUILDING C FLOOR PLAN
C-3.1	BUILDING C ELEVATIONS
С-З.2	BUILDING C ELEVATIONS
E-4.0	BUILIDNG E FLOOR PLAN
E-4.1	PROPOSED ROOF PLAN
	BUILDING E ELEVATIONS
E-4.3	BUILDING E ELEVATIONS
E-4.4	BUILDING E ELEVATIONS
G-5.0	BUILDING G FLOOR PLAN
G-5.I	BUILDING G ROOF PLAN
G-5.2	BUILDING G ELEVATIONS
G-5.3	BUILDING G ELEVATIONS

# GENERAL NOTES:

I. ALL IDEAS, DRAWINGS, PLANS AND ARRANGEMENTS INDICATED OR REPRESENTED BY THESE DRAWINGS ARE OWNED BY AND THE PROPERTY OF THE ARCHITECT AND/OR ENGINEER OF RECORD. THEY WERE CREATED FOR AND DEVELOPED FOR USE ON AND IN CONNECTION WITH THE SPECIFIED PROJECT. THE IDEAS, DESIGNS, DRAWINGS, PLANS AND ARRANGEMENTS OF THE SPECIFIED PROJECT SHALL NOT BE USED BY OR DISCLOSED TO ANY PERSONS, FIRM, OR CORPORATION FOR ANY PURPOSE WHATSOEVER WITHOUT THE WRITTEN PERMISSION OF THE ARCHITECT AND ENGINEER(S) OF RECORD. 2. ALL SHOP DRAWINGS SHALL BE SUBMITTED TO THE ARCHITECT/ENGINEER OF RECORD REVIEW ONLY AFTER THEY HAVE BEEN THOROUGHLY REVIEWED BY THE GENERAL CONTRACTOR FOR CONSTRUCTION METHODS, DIMENSIONS, FIELD CONDITIONS, "AS-CONSTRUCTED" DIMENSIONS AND OTHER TRADE REQUIREMENTS, AND STAMPED WITH THE CONTRACTOR'S APPROVAL STAMP. ONLY REQUESTED SHOP DRAWINGS AND SUBMITTALS TO BE PROVIDED TO ARCHITECT FOR REVIEW, ALL OTHERS TO BE APPROVED

AND REVIEWED BY G.C. 3. ARCHITECT OF RECORD IS NOT RESPONSIBLE FOR ANY SURVEY OR CIVIL DWGS. THAT ARE INSERTED INTO THIS SET AND/OR LACK OF. THIS INCLUDES BUT IS NOT LIMITED TO PROPOSED AND/OR EXISTING CONDITIONS OF GRADING, PARKING, DRIVEWAYS, SEWER LINES, DRAINAGE, FINISH FLOOR ELEVATIONS, PROPERTY LINE LOCATIONS, EXISTING VEGETATION LOCATIONS, AND ETC.

4. ALL FINISH FLOOR ELEVATIONS SHALL BE CONFIRMED BY LOCAL MUNICIPALITY OR A LICENSED CIVIL ENGINEER OR LICENSED SURVEYOR. 5. PRIOR TO START OF CONSTRUCTION, THE GENERAL CONTRACTOR AND ALL SUB-CONTRACTORS SHALL

VERIFY ALL GRADES, LINES, LEVELS, DIMENSIONS AND COORDINATE EXISTING CONDITIONS AT THE JOB SITE WITH THE PLANS AND SPECIFICATIONS. THEY SHALL REPORT ANY INCONSISTENCIES OR ERRORS IN THE CONSTRUCTION DOCUMENTS TO THE ARCHITECT AND ENGINEER OF RECORD BEFORE COMMENCING WORK. THE CONTRACTOR AND HIS SUB-CONTRACTORS SHALL LAY OUT THEIR WORK FROM ESTABLISHED REFERENCE POINTS AND BE RESPONSIBLE FOR ALL LINES, ELEVATIONS AND MEASUREMENTS IN CONNECTION WITH THEIR WORK. THE CIVIL ENGINEER OF RECORD SHALL ESTABLISH THE +0'-0" FINISHED FLOOR BASE ELEVATION - REFERENCE CIVIL ENGINEERING PLANS FOR THE HEIGHT.

# SUNDY VILLAGE BLOCK 61

# SITE PLAN RENDERING:



### ABBREVIATIONS:

@	AT
ACT	ACOUSTICAL TILE
ADJ.	ADJUSTABLE
A.B.	ANCHOR BOLT
A.C.	AIR CONDITIONIN
AFF	ABOVE FINISH FLO
ALUM.	ALUMINUM
ALT.	ALTERNATE
BD.	BOARD
BLDG.	BUILDING
B.M.	BENCH MARK
B.O.	BOTTOM OF
BRG.	BRIDGING OR BEA
C/C	CENTER TO CENTE
CL	CENTER LINE
CAB.	CABINET
C.B.	CATCH BASIN
C.I.	CAST IRON
CER.	CERAMIC
CLG.	CEILING
C.O.	CLEAN OUT
CONC.	CONCRETE
COORD.	COORDINATE
COL.	COLUMN
CONT.	CONTINUOUS
DET.	DETAIL
DN.	DOWN
DK.	DECK
D.S.	DOWN SPOUT
D.W.	DRY WALL
DWG.	DRAWING
E.C.	ELECTRICAL CONT
EL. ELEV.	ELEVATION
ELEC.	ELECTRICAL
EX./EXIST	EXISTING
EXP.	EXPOSED OR EXP.
F.E.	FIRE EXTINGUISHE
F.F.	FINISHED FLOOR
FIN.	FINISH
FLR.	FLOOR
F.S.	FULL SIZE
F.T	FOOT OR FEET
FTG.	FOOTING
G.C.	GENERAL CONTRA
GL.	GLASS OR GLAZIN
G.PT.	GLAZED PAINT
GYP.	GYPSUM
GWB	GYPSUM WALL BO
H.B.	HOSE BIB
HGT.	HEIGHT
HRD'R	HARDENER

	Н.С. Н.М.	HOLLOE CORE HOLLOW METAL
	H.V.A.C.	HEATING, VENTILATION. ∉ AIR CONDITIONING
	INSUL.	INSULATION
OR	INV.	
	LAM. MAT.	LAMINATED MATERIAL
	M.C.	MECHANICAL CONTRACTOR
	M.H.	MAN HOLE
	MLDG.	MOLDING
	MTL. MET.	METAL
र।NG र	MIN. M.T.	MINIMUM METAL THRESHOLD
	N.I.C.	NOT IN CONTRACT
	NO.	NUMBER
	NOM.	NOMINAL
	O.C.	ON CENTER
	OPG.	OPENING
	0.W. P.C.	OPEN WEB PLUMBING CONTRACTOR
	PL	PLATE
	PT.	PRESSURE TREADED
	P.S.I.	POUNDS PER SQARE INCH
	R.A.	RETURN AIR
	RM.	ROOM
	REQ'D REIN.	REQUIRED REINFORCING
	S.B.	SPALSH BLOCK
	SCH.	SCHEDULE
	SEC.	SECTION
RACTOR	S.C.	SOLID CORE
	SIM.	SIMILAR
	S.S. S.V.B.	STAINLESS STEEL STRAIGHT VINYL BASE
NSION	SPEC.	SPECIFICATION
2	Т.О.	TOP OF
	T.O.F.	TOP OF FOOTING
	Т.О.Р.	TOP OF PLATE
	T.O.S. TYP.	TOP OF STEEL TYPICAL
	тнг. тнк.	THICK OR THICKNESS
	T¢G	TOUNGUE AND GROOVE
CTOR	UNO	UNLESS NOTED OTHERWISE
<u> </u>	V.C.T.	VINYL COMPOSITION TILE
	V.C.B.	VINYL COVE BASE
ARD	VIF W/	VERIFY IN FIELD WITH
	W.I.	WROUGHT IRON
	WD.	WOOD
	W.W.F.	WELDED WIRE FABRIC

### WALL LEGEND:

	EXISTING CMU WALL
	EXISTING INTERIOR WALL
/ <b>*</b> / / )	EXISTING FIRE RATED PARTITION WALL
	CMU WALL
	CMU WALL, W/ ONE SIDE I x PT FURRING & GYPSUM BOARD
	CMU WALL, W/ ONE SIDE 2x PT FURRING & GYPSUM BOARD
	CMU WALL, W/ ONE SIDE I-5/8" MTL. STUD & GYPSUM BOARD
	PARTITION WALL (PARTTY WALL)- CMU WALL, W/ I-5/8" MTL. STUD, (SFAB) \$ 5/8" GYPSUM BOARD ON EACH SIDE. NOTE: FIRE RATED PARTITION WALL
	PARTITION WALL (PARTTY WALL)- CMU WALL, W/ 2x PT FURRING, (SFAB) \$ 5/8" GYPSUM BOARD ON EACH SIDE. NOTE: FIRE RATED PARTITION WALL
/////	INTERIOR WALL
	INTERIOR FIRE RATED PARTITION WALL

# ARCHITECTURAL SYMBOLS:

$\triangle$	REVISION MARKER	
- <b>\$</b> -	ELEVATION MARK	
101	ROOM NUMBER	
	DOOR TAG- REFER TC	DOOR SCHEDULE
WI01	WINDOW TAG- REFER	TO WINDOW SCHEDULE
PI	WALL DETAIL, REFER T	O PARTITION DETAILS
	FIXTURE TAG	
SECT	ION LETTER	SECTION LETTER
	WALL SECTION	BUILDING SECTION
SHEE	T NUMBER	SHEET NUMBER
DETA	IL NUMBER	
	DETAIL	
SHEE	T NUMBER	

# PROJECT DATA:

### PROJECT DESCRIPTION:

THE PROPOSED PROJECT IS A COA APPLICATION FOR VARIOUS ITEMS THAT WERE NOT PART OF THE ORIGINAL COA APPROVAL, INCLUDING HOOD VENTING, REPLACEMENT OF DAMAGED SIDING AND HAND/GUARD RAILS DUE TO HEIGHT DIFFERENCES.

### PROJECT INFORMATION:

OWNER:	SUNDY VILLAGE WEST
ADDRESS:	7900 GLADES RD. STE 540 BOCA RATON, FL 33434
FOLIO:	2-43-46- 6-Q6-00 -00 0
LEGAL:	SUNDY VILLAGE NLY 208.70 FT OF PAR 1

### ZONING AND CODE INFORMATION:

ZONING: OSHADD OCCUPANCY: ASSEMBLY CONSTRUCTION TYPE: 5B ALTERATION LEVEL: COA ONLY CURRENT USE: VACANT PROPOSED USE: ASSEMBLY

### FLORIDA BUILDING CODE:


FBC-2023 8th EDITION BUILDING CODE & FBC-2023, 8TH EDITION BUILDING CODE EXISTING FBC EC= FLORIDA BUILDING CODE ENERGY CONSERVATION 2023 NEC= NFPA 70 2020 EDITION, NATIONAL ELECTRICAL CODE FS= FLORIDA STATUTES FFPC=FLORIDA FIRE PREVENTION CODE, 7TH EDITION NFPA 101: LIFE SAFETY CODE 2018 EDITION ACCESSIBILITY CODE: 2023 FLORIDA ACCESSIBILITY CODE


### DESIGN TEAM:

### ARCHITECT:

STEVE SIEBERT ARCHITECTURE IO IO GATEWAY BLVD, SUIT 103 BOYNTON BEACH, FL 33426 (56 I) 880-7894 STEVE@STEVESIEBERT.COM


STEVE SIEBERT         ACCHARCE SUBJERT         SUBJERT    <
SEAL STEVEN W. SIEBERT FLORIDA AR0017834 NEW JERSEY 21AI01517500 TEXAS 26934
COA APPLICATION SUNDY VILLAGE BLOCK 61 22-44 W. ATLANTIC AVE. DELRAY BEACH, FLORIDA 334444
COA APPLICATION
THE WRITTEN DIMENSIONS ON THESE DRAWINGS SHALL TAKE PRECEDENCE OVER SCALED DIMENSIONS. THE CONTRACTOR SHALL VERIFY AND BE RESPONSIBLE FOR ALL DIMENSIONS AND CONDITIONS ON THE JOB, AND THIS OFFICE MUST BE NOTIFIED OF ANY VARIATION FROM THE DIMENSIONS. COPYRIGHT STEVE SIEBERT ARCHITECTURE-UNAUTHORIZED REPRODUCTION OR ANY OTHER USE OF THIS DRAWING IS PROHIBITED. PROJECT NO: 23-534 DATE: 7.1.2024 DRAWN BY: SK/BT CHECKED BY: S.S. REVISIONS:
COVER SHEET

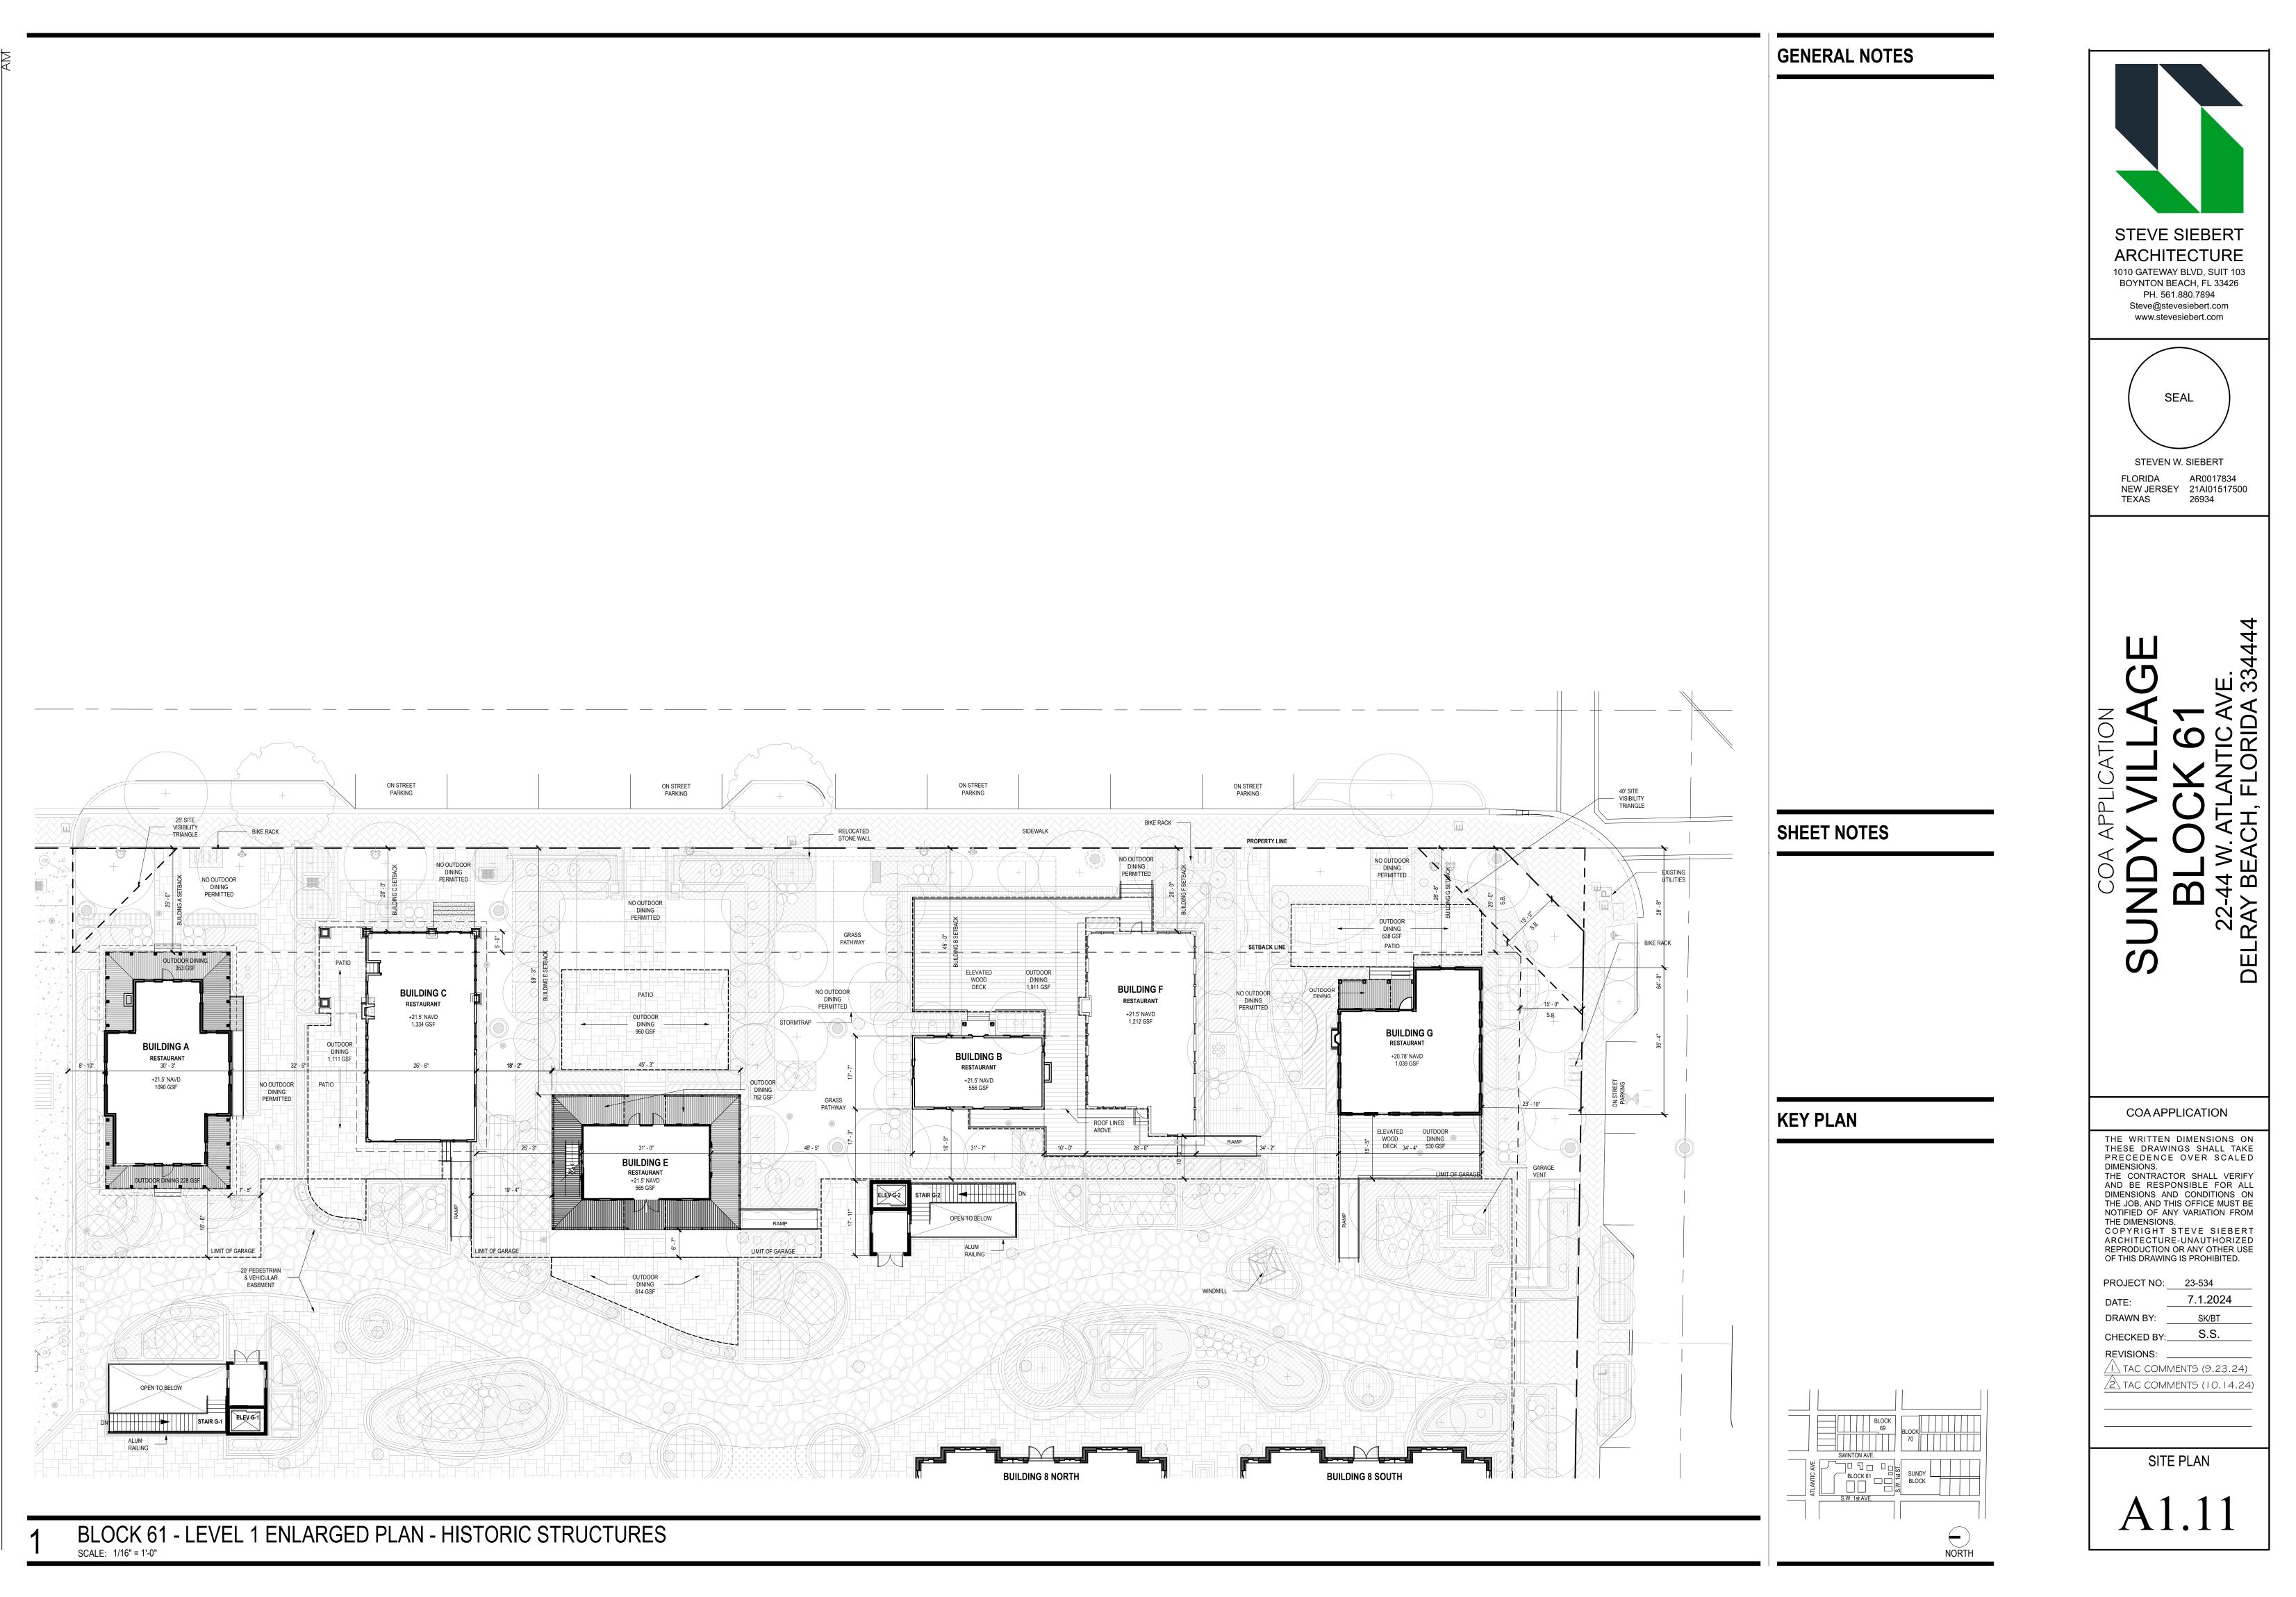


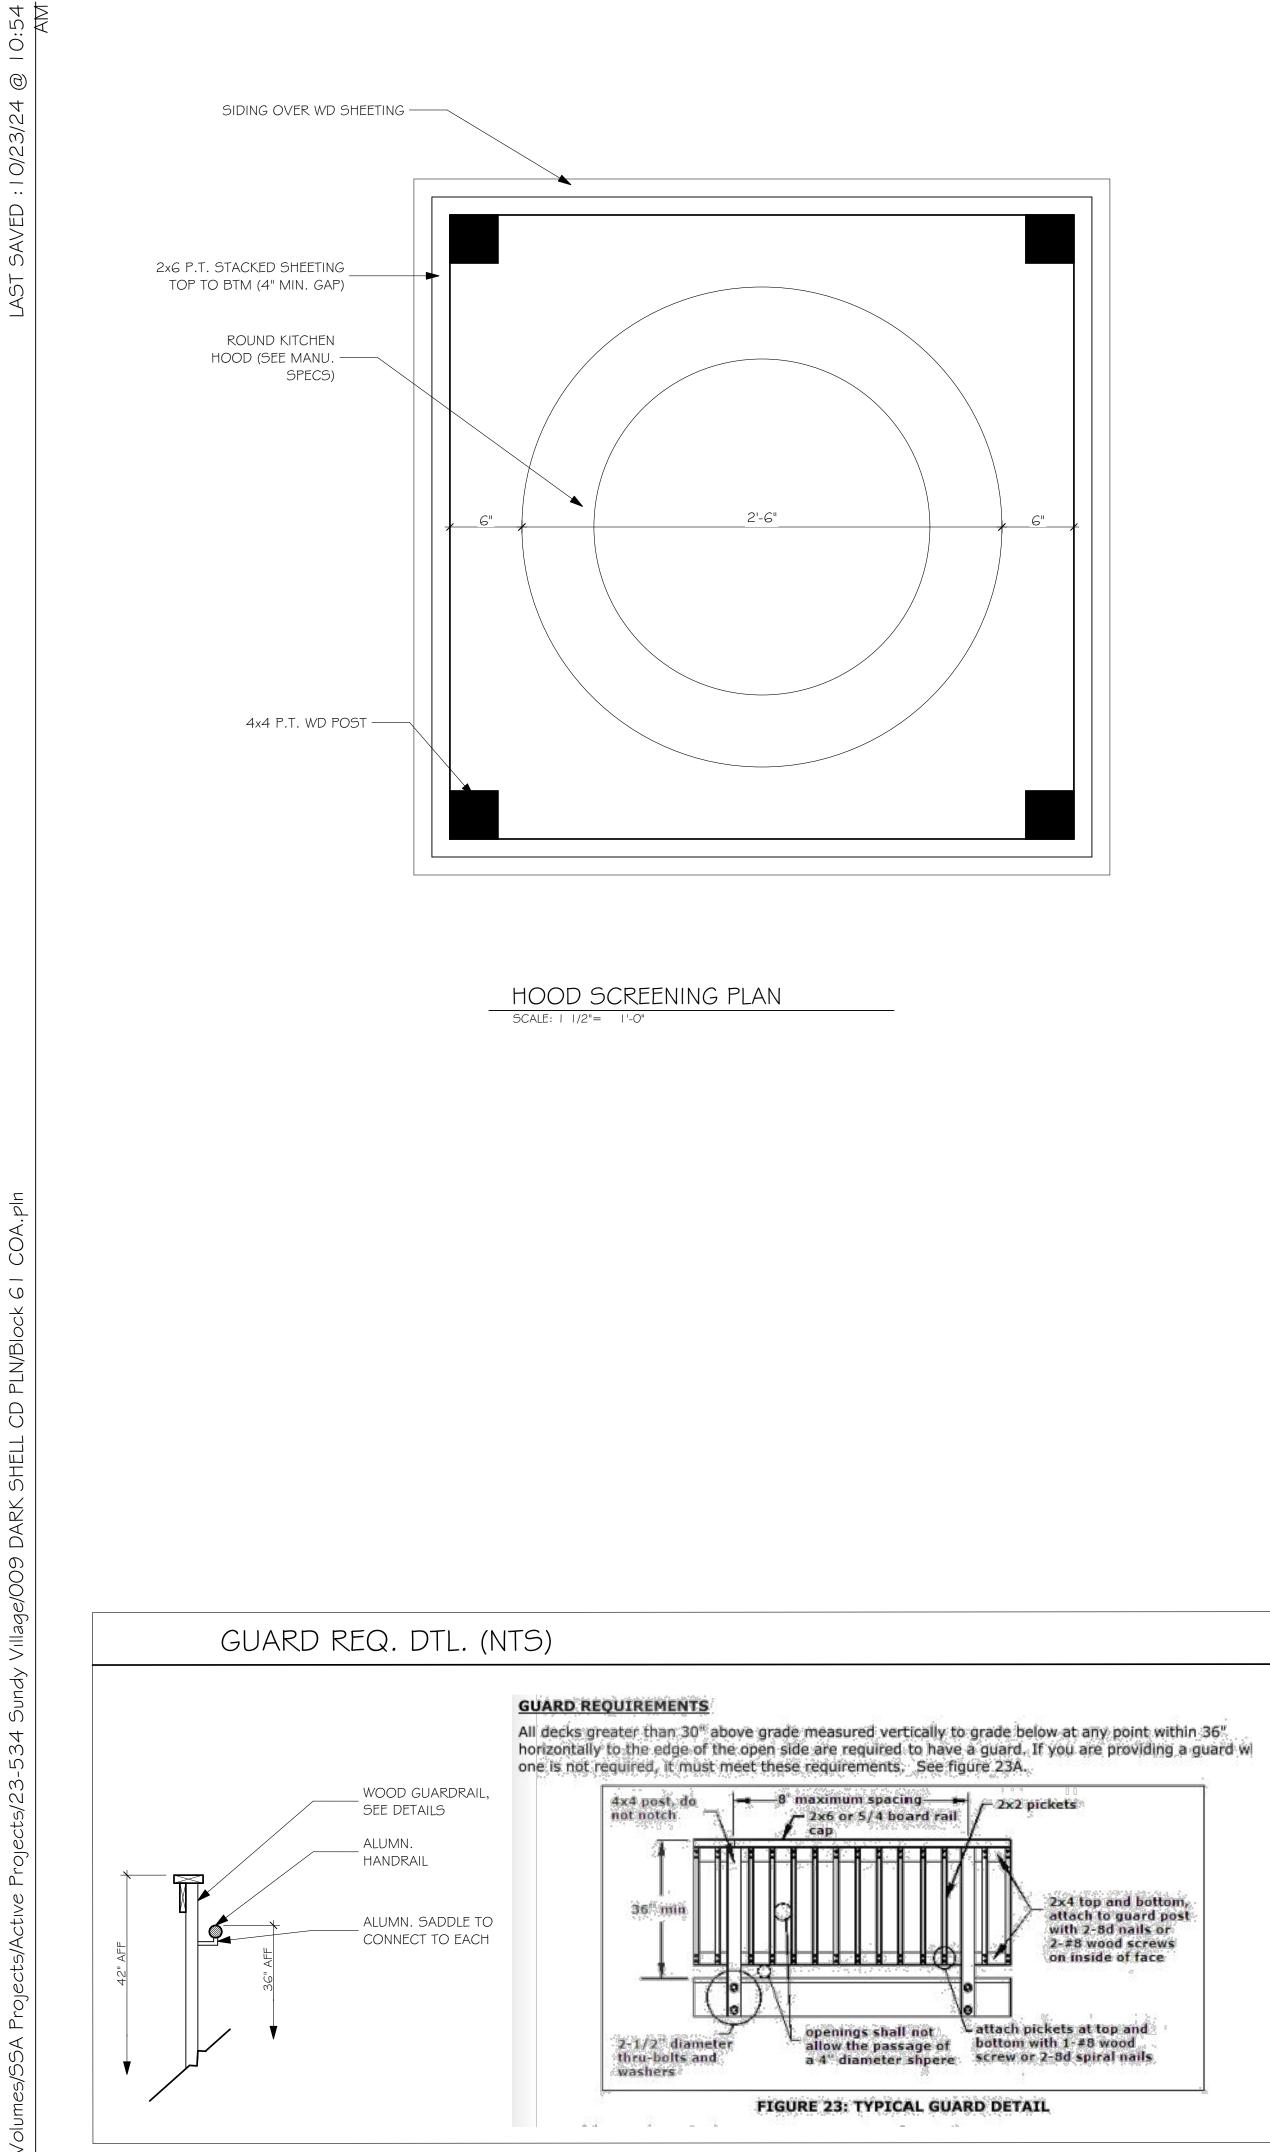


 $\bigcirc$ 


()

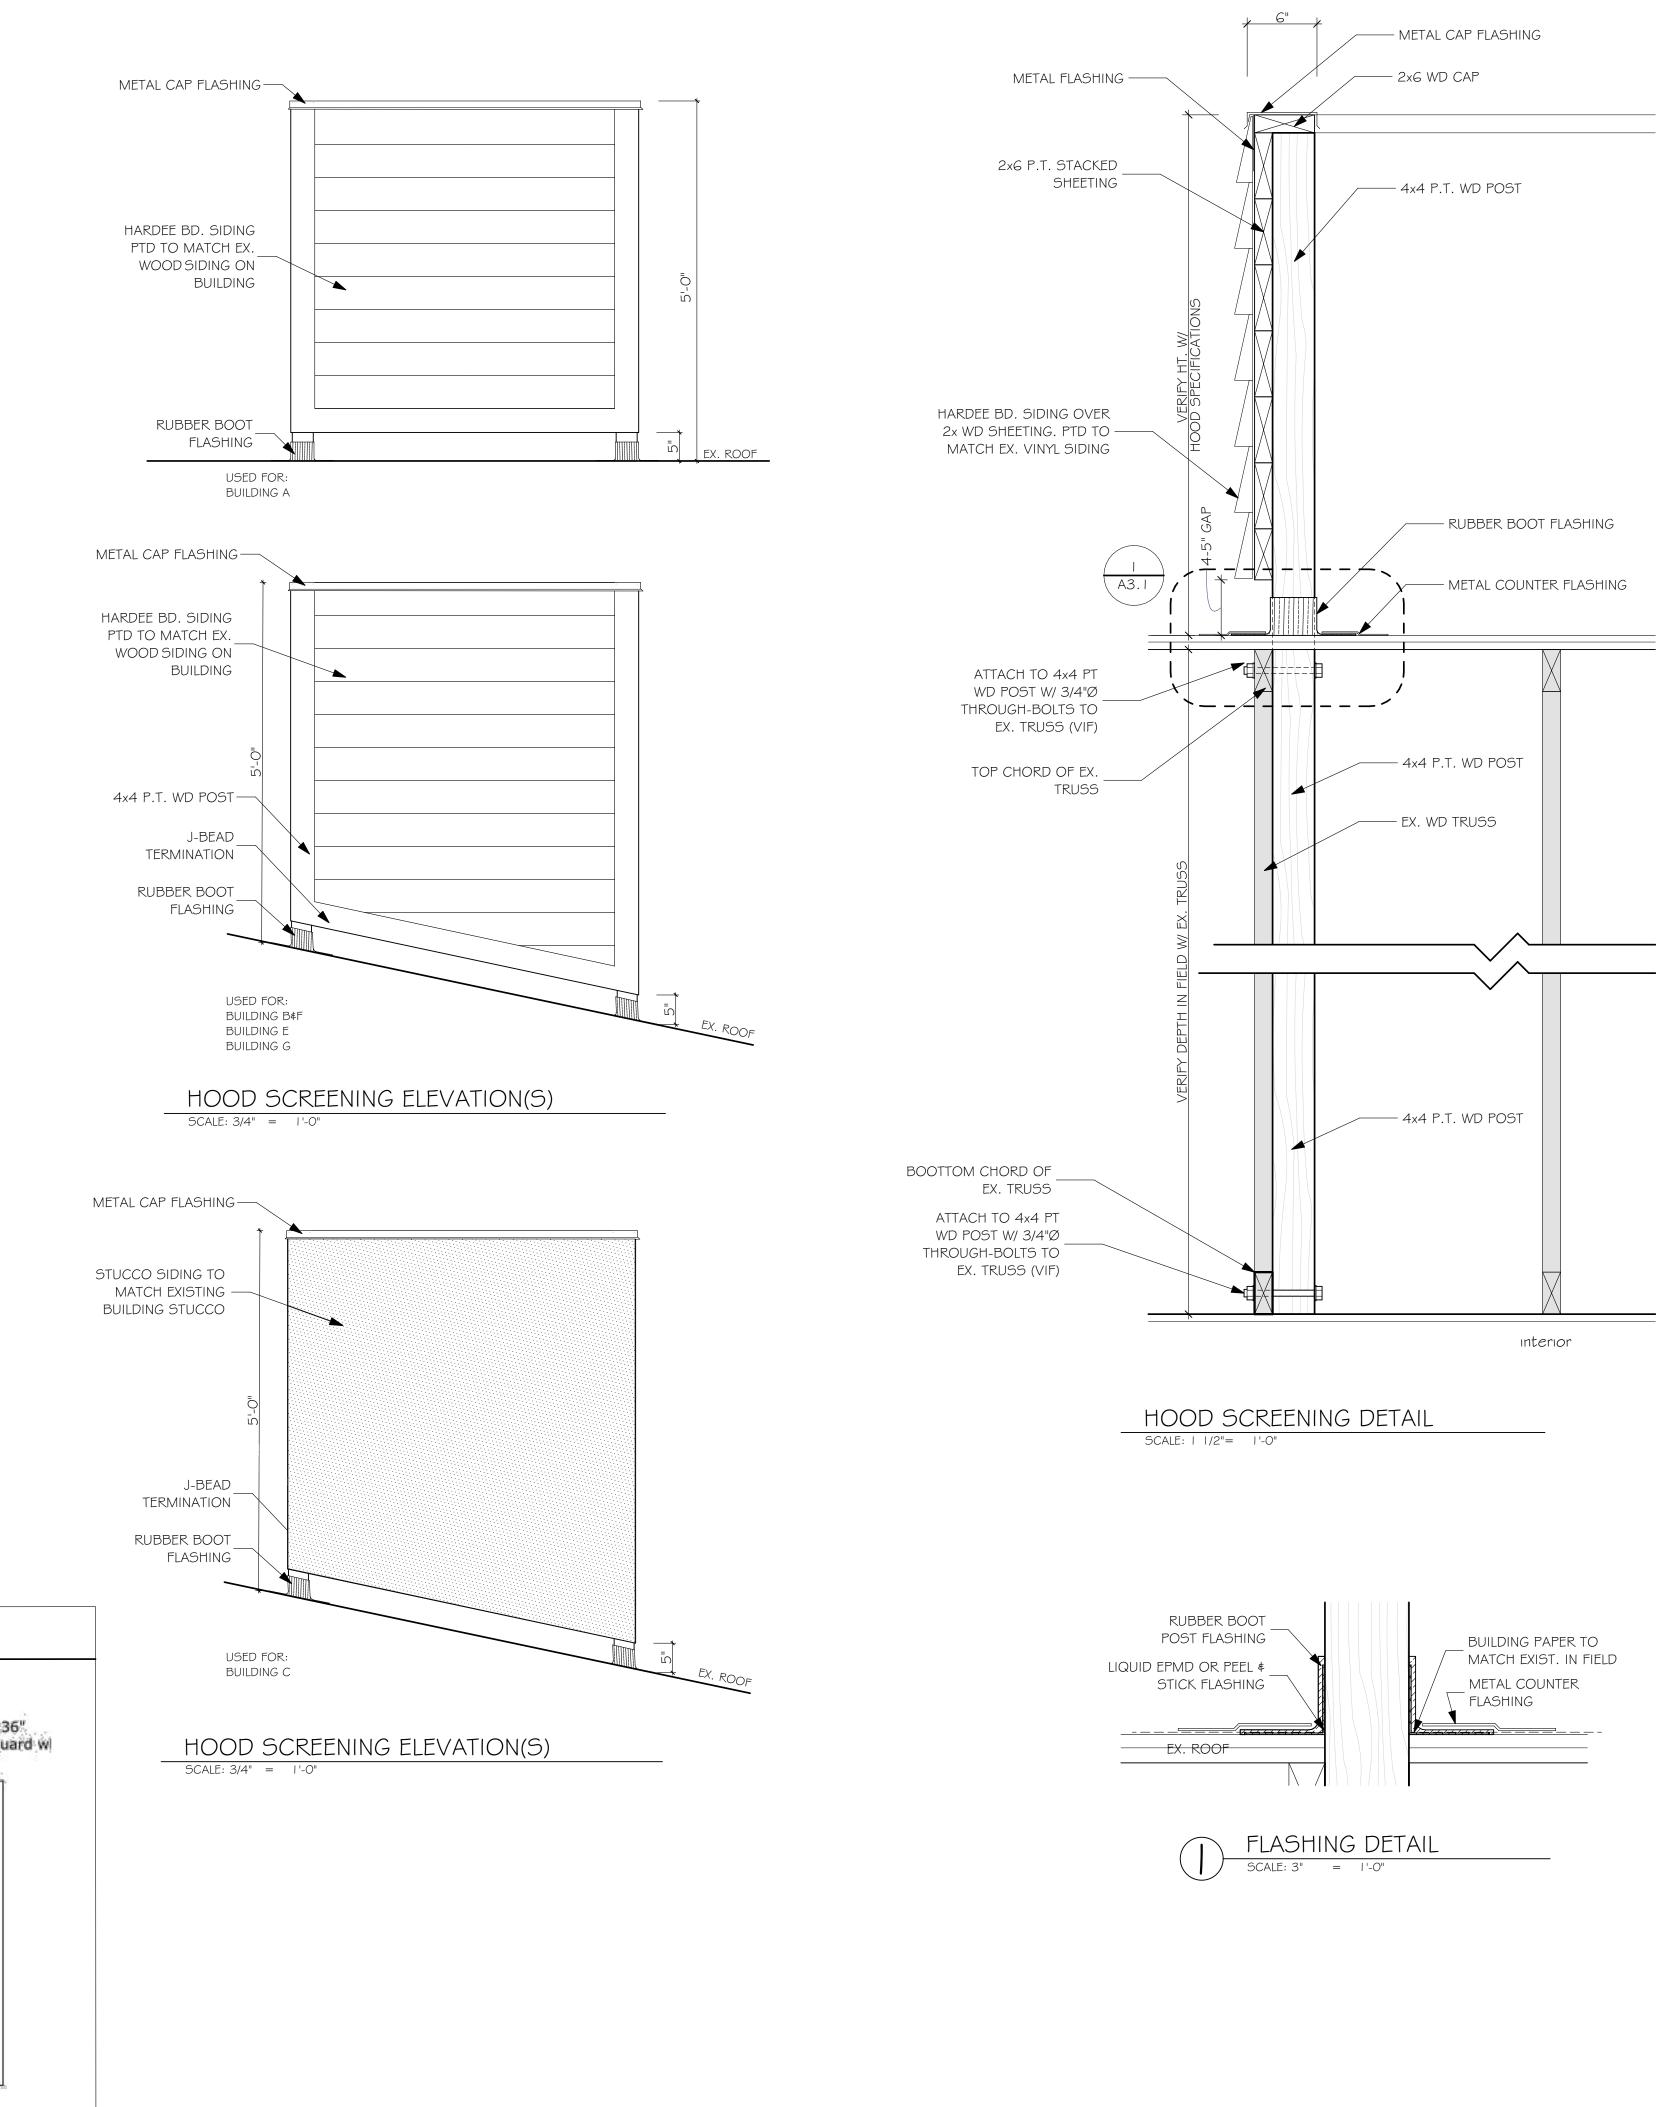

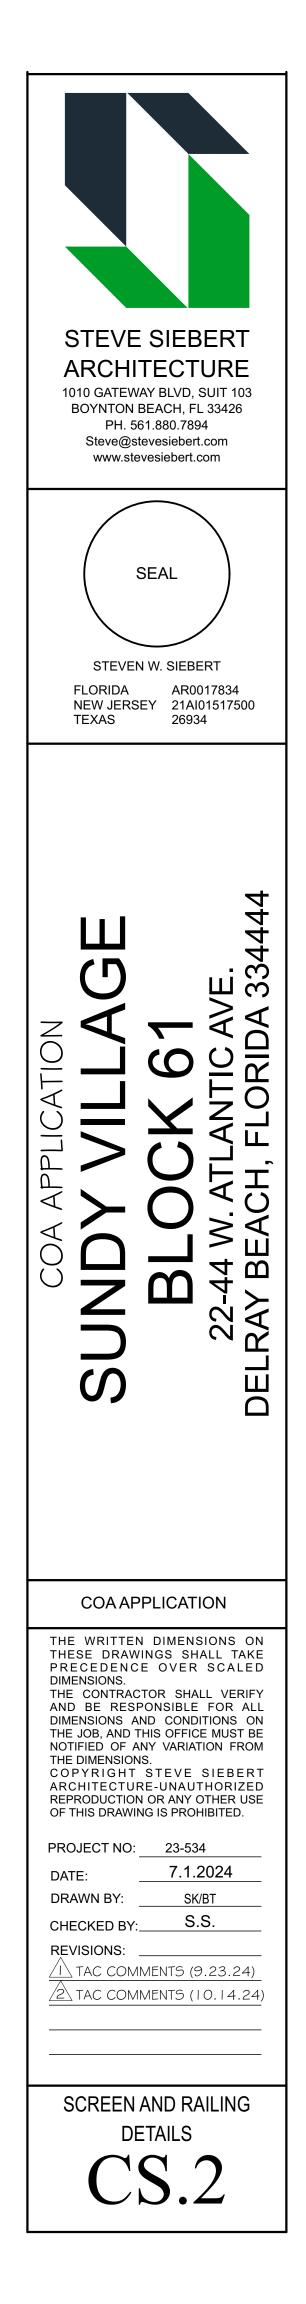



()

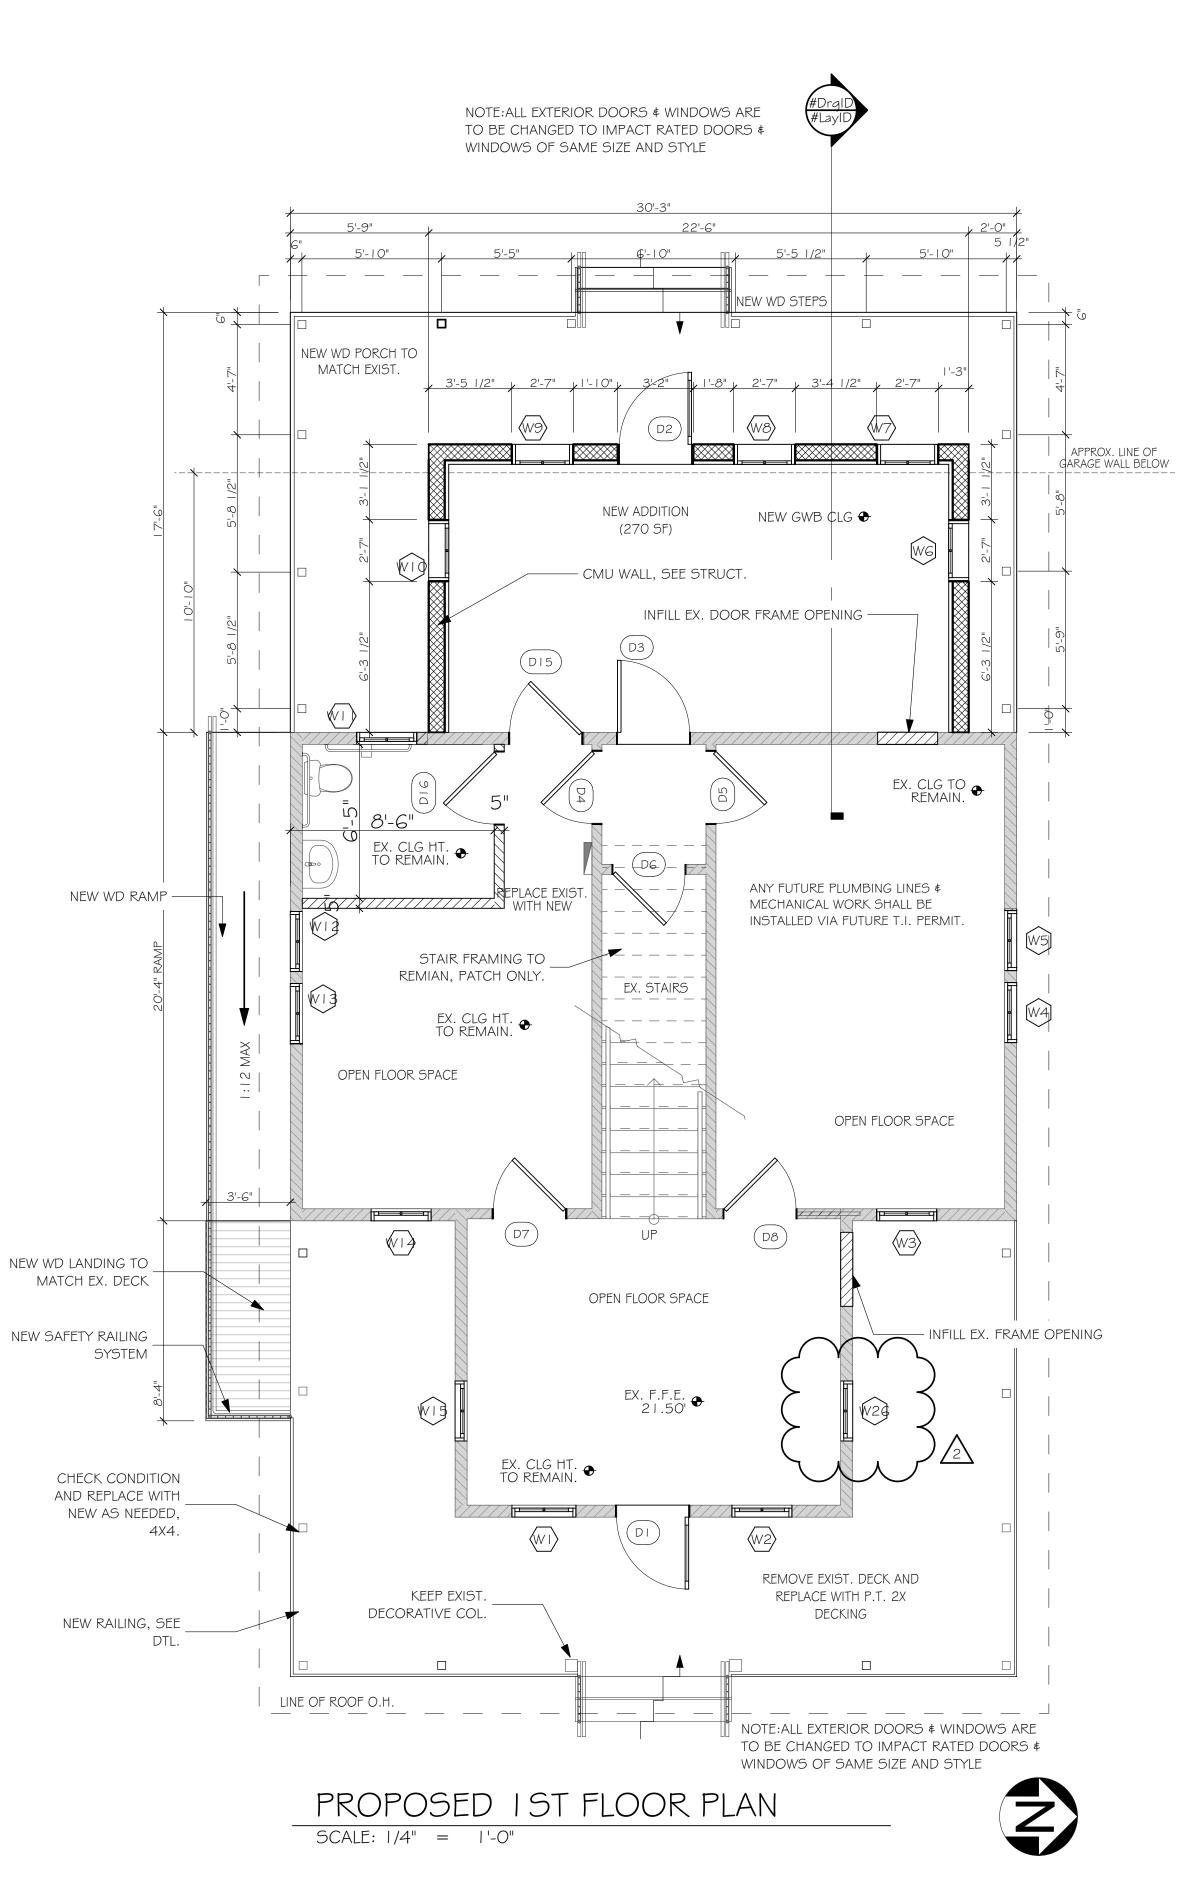


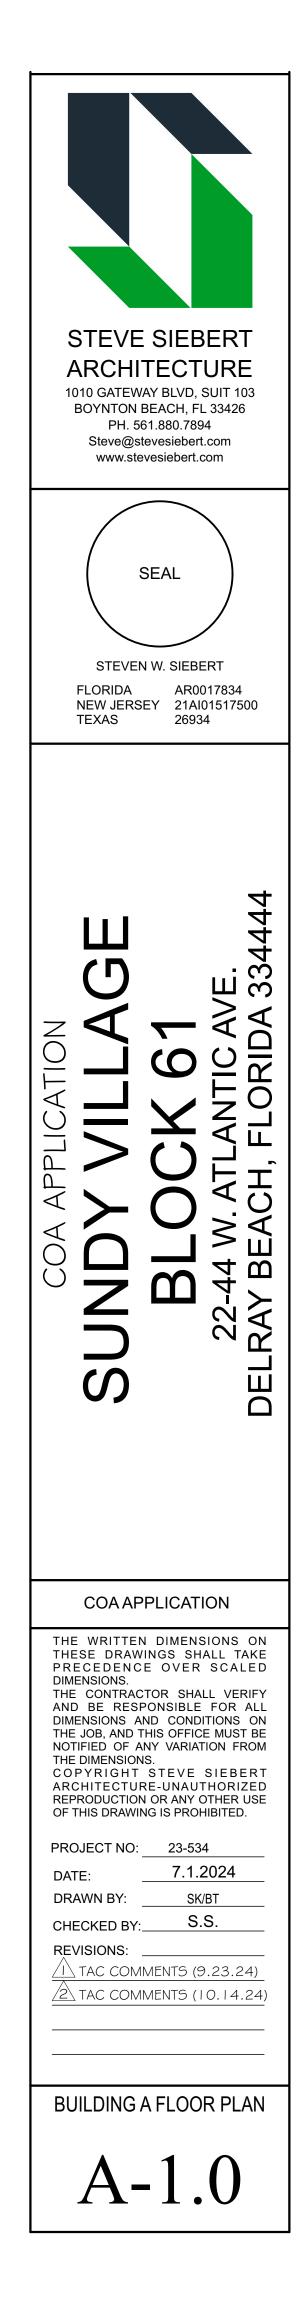


COA. 0 PLN/ СD IELL μ DARK 00 D

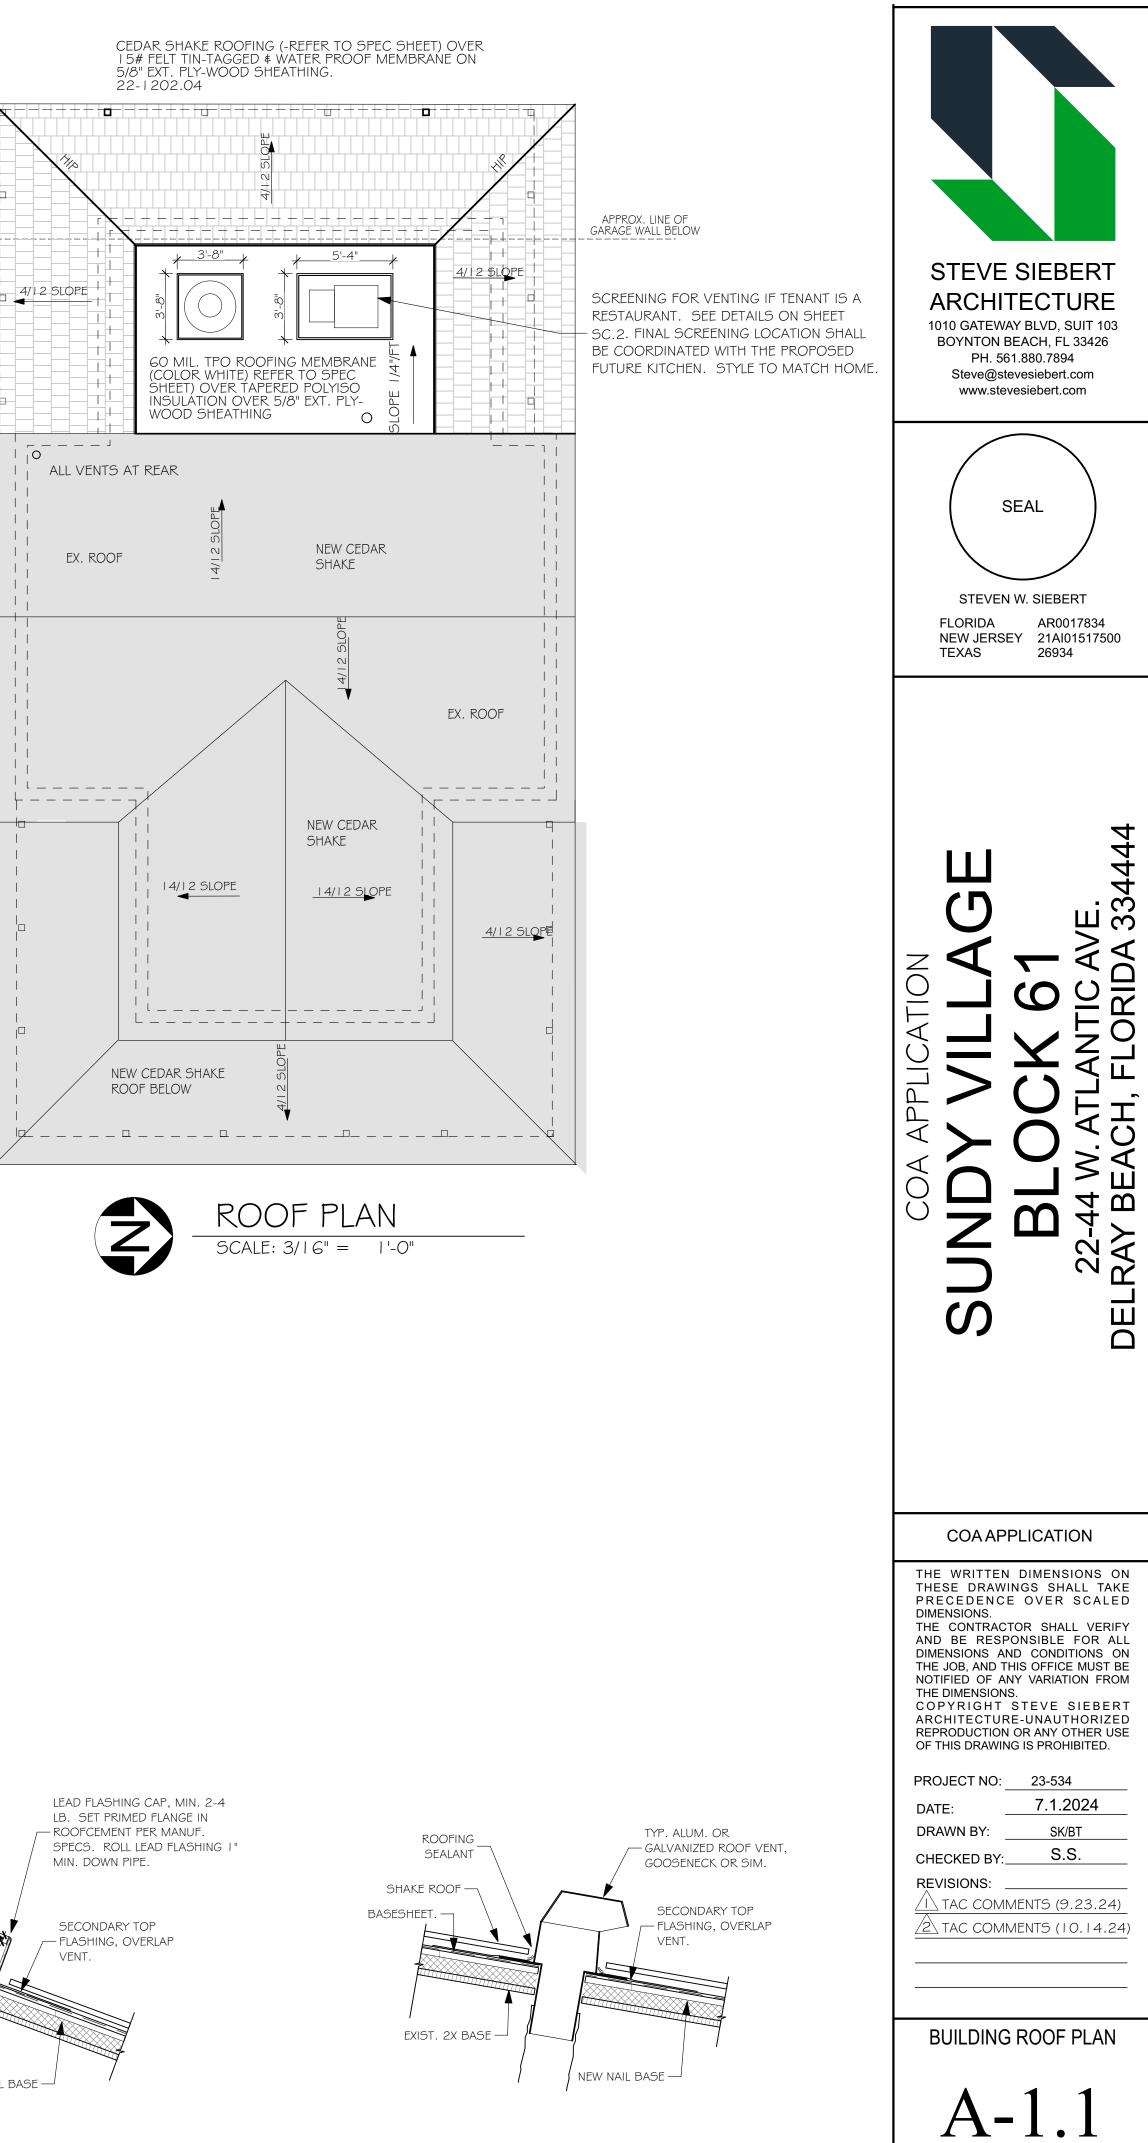

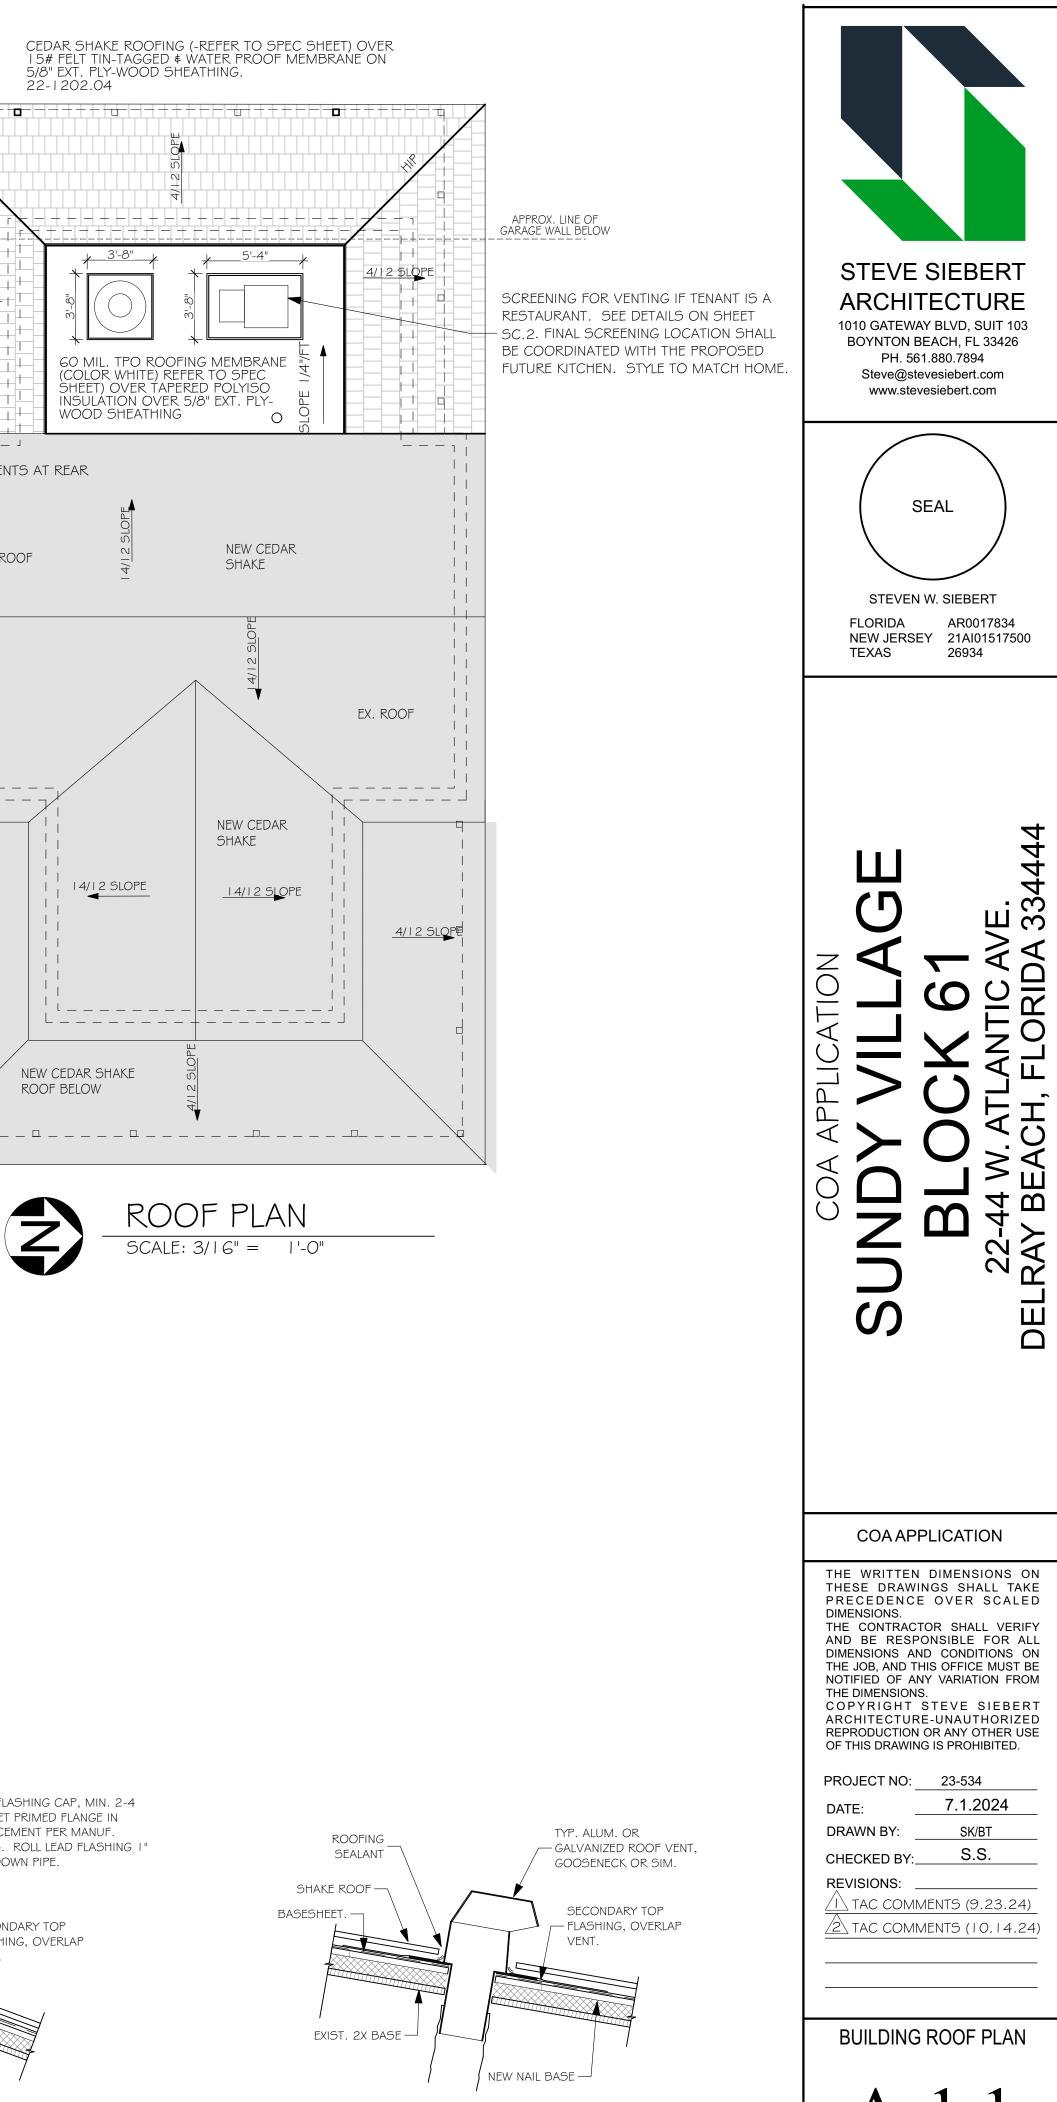

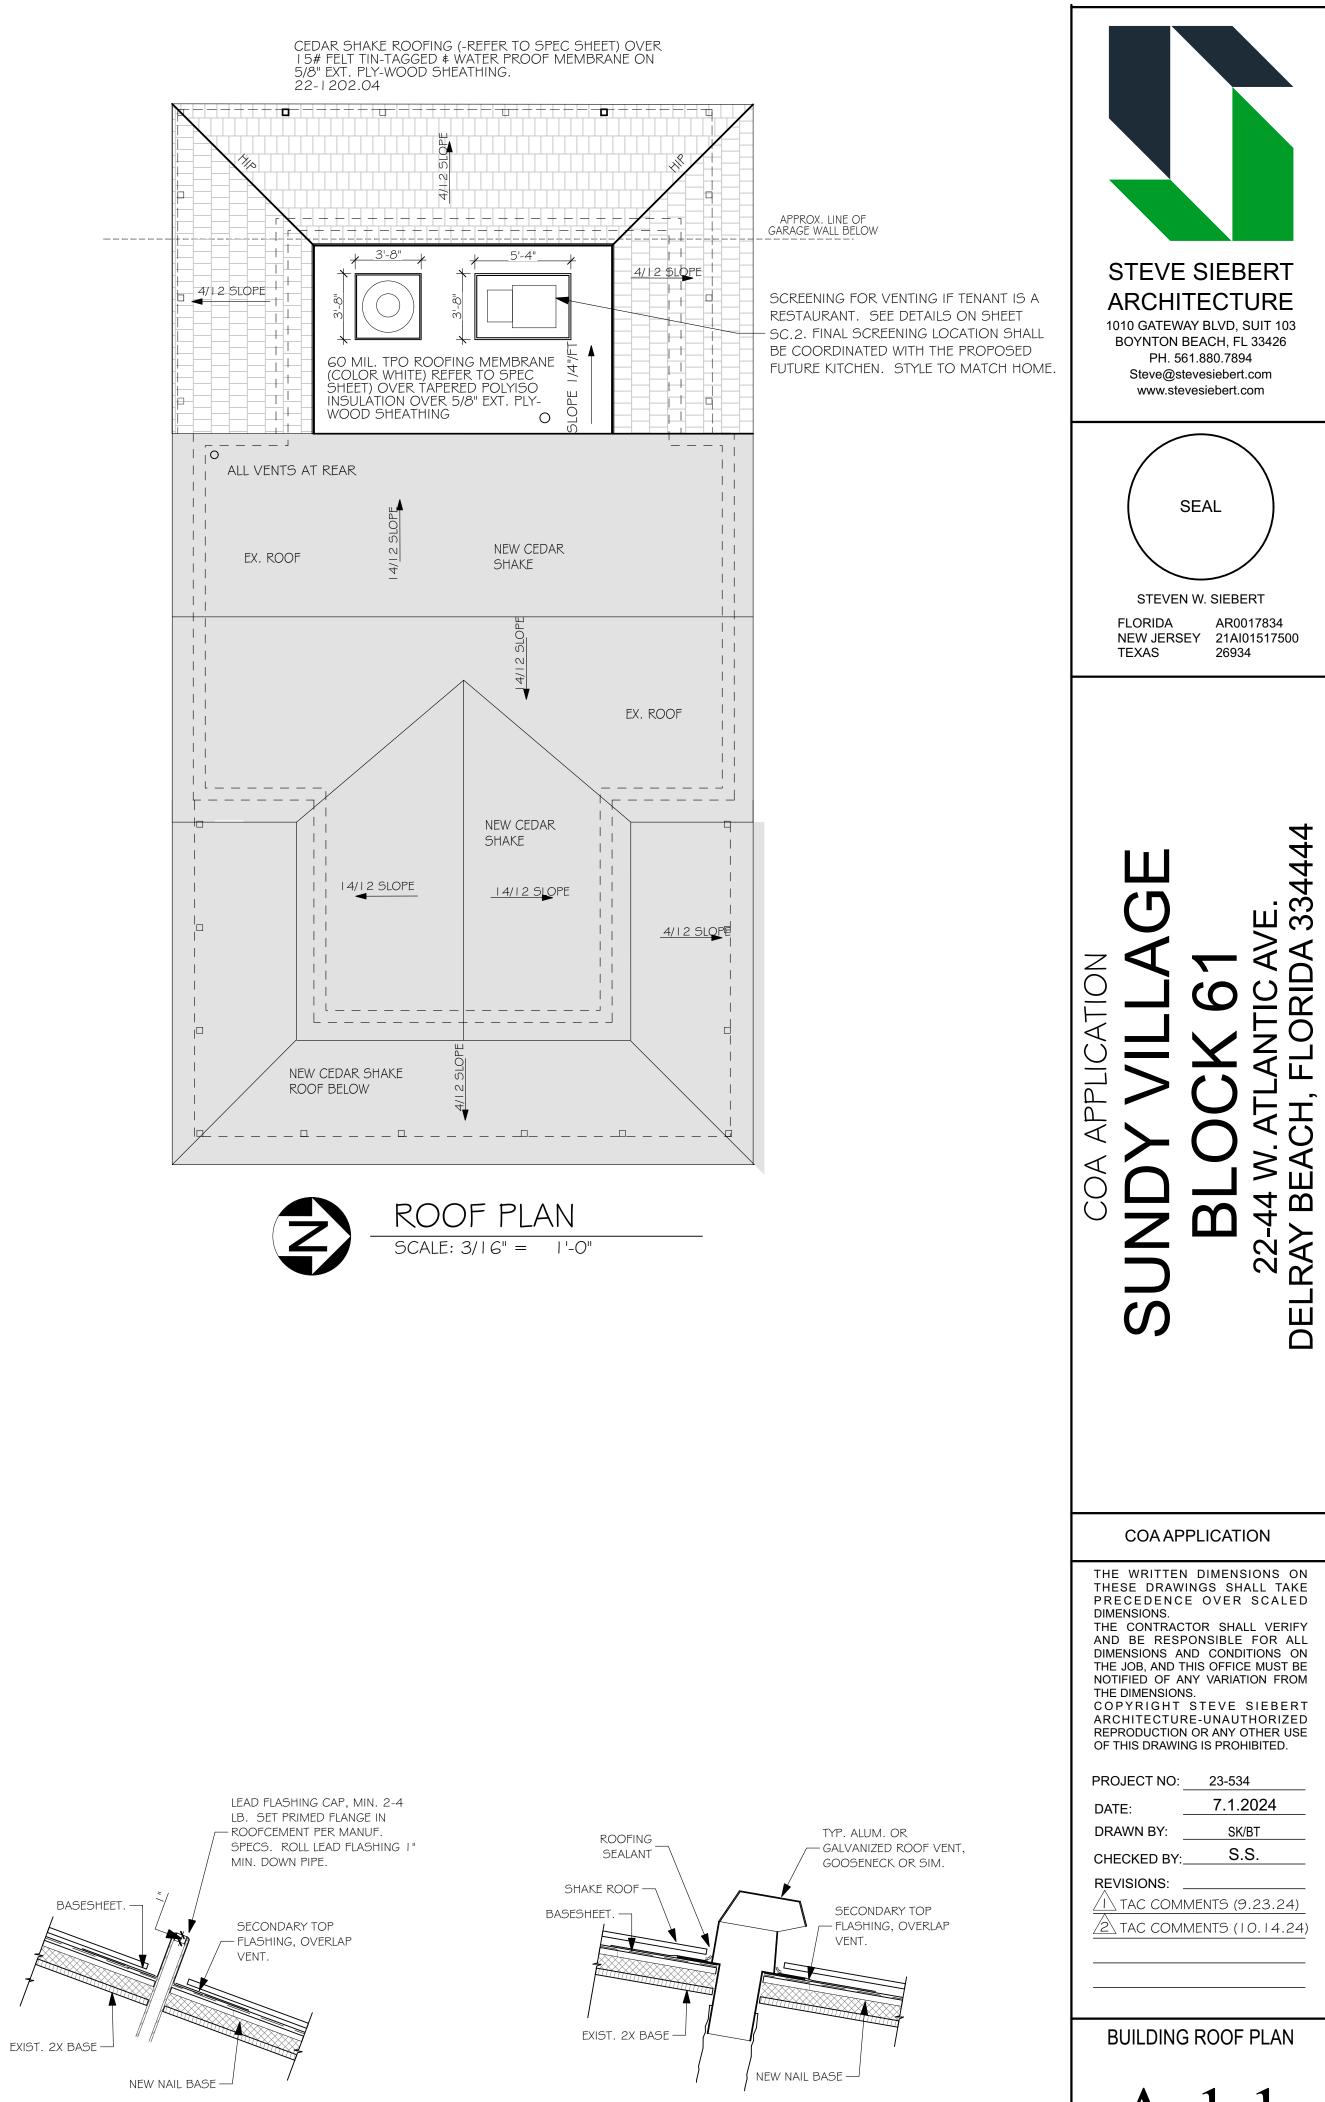

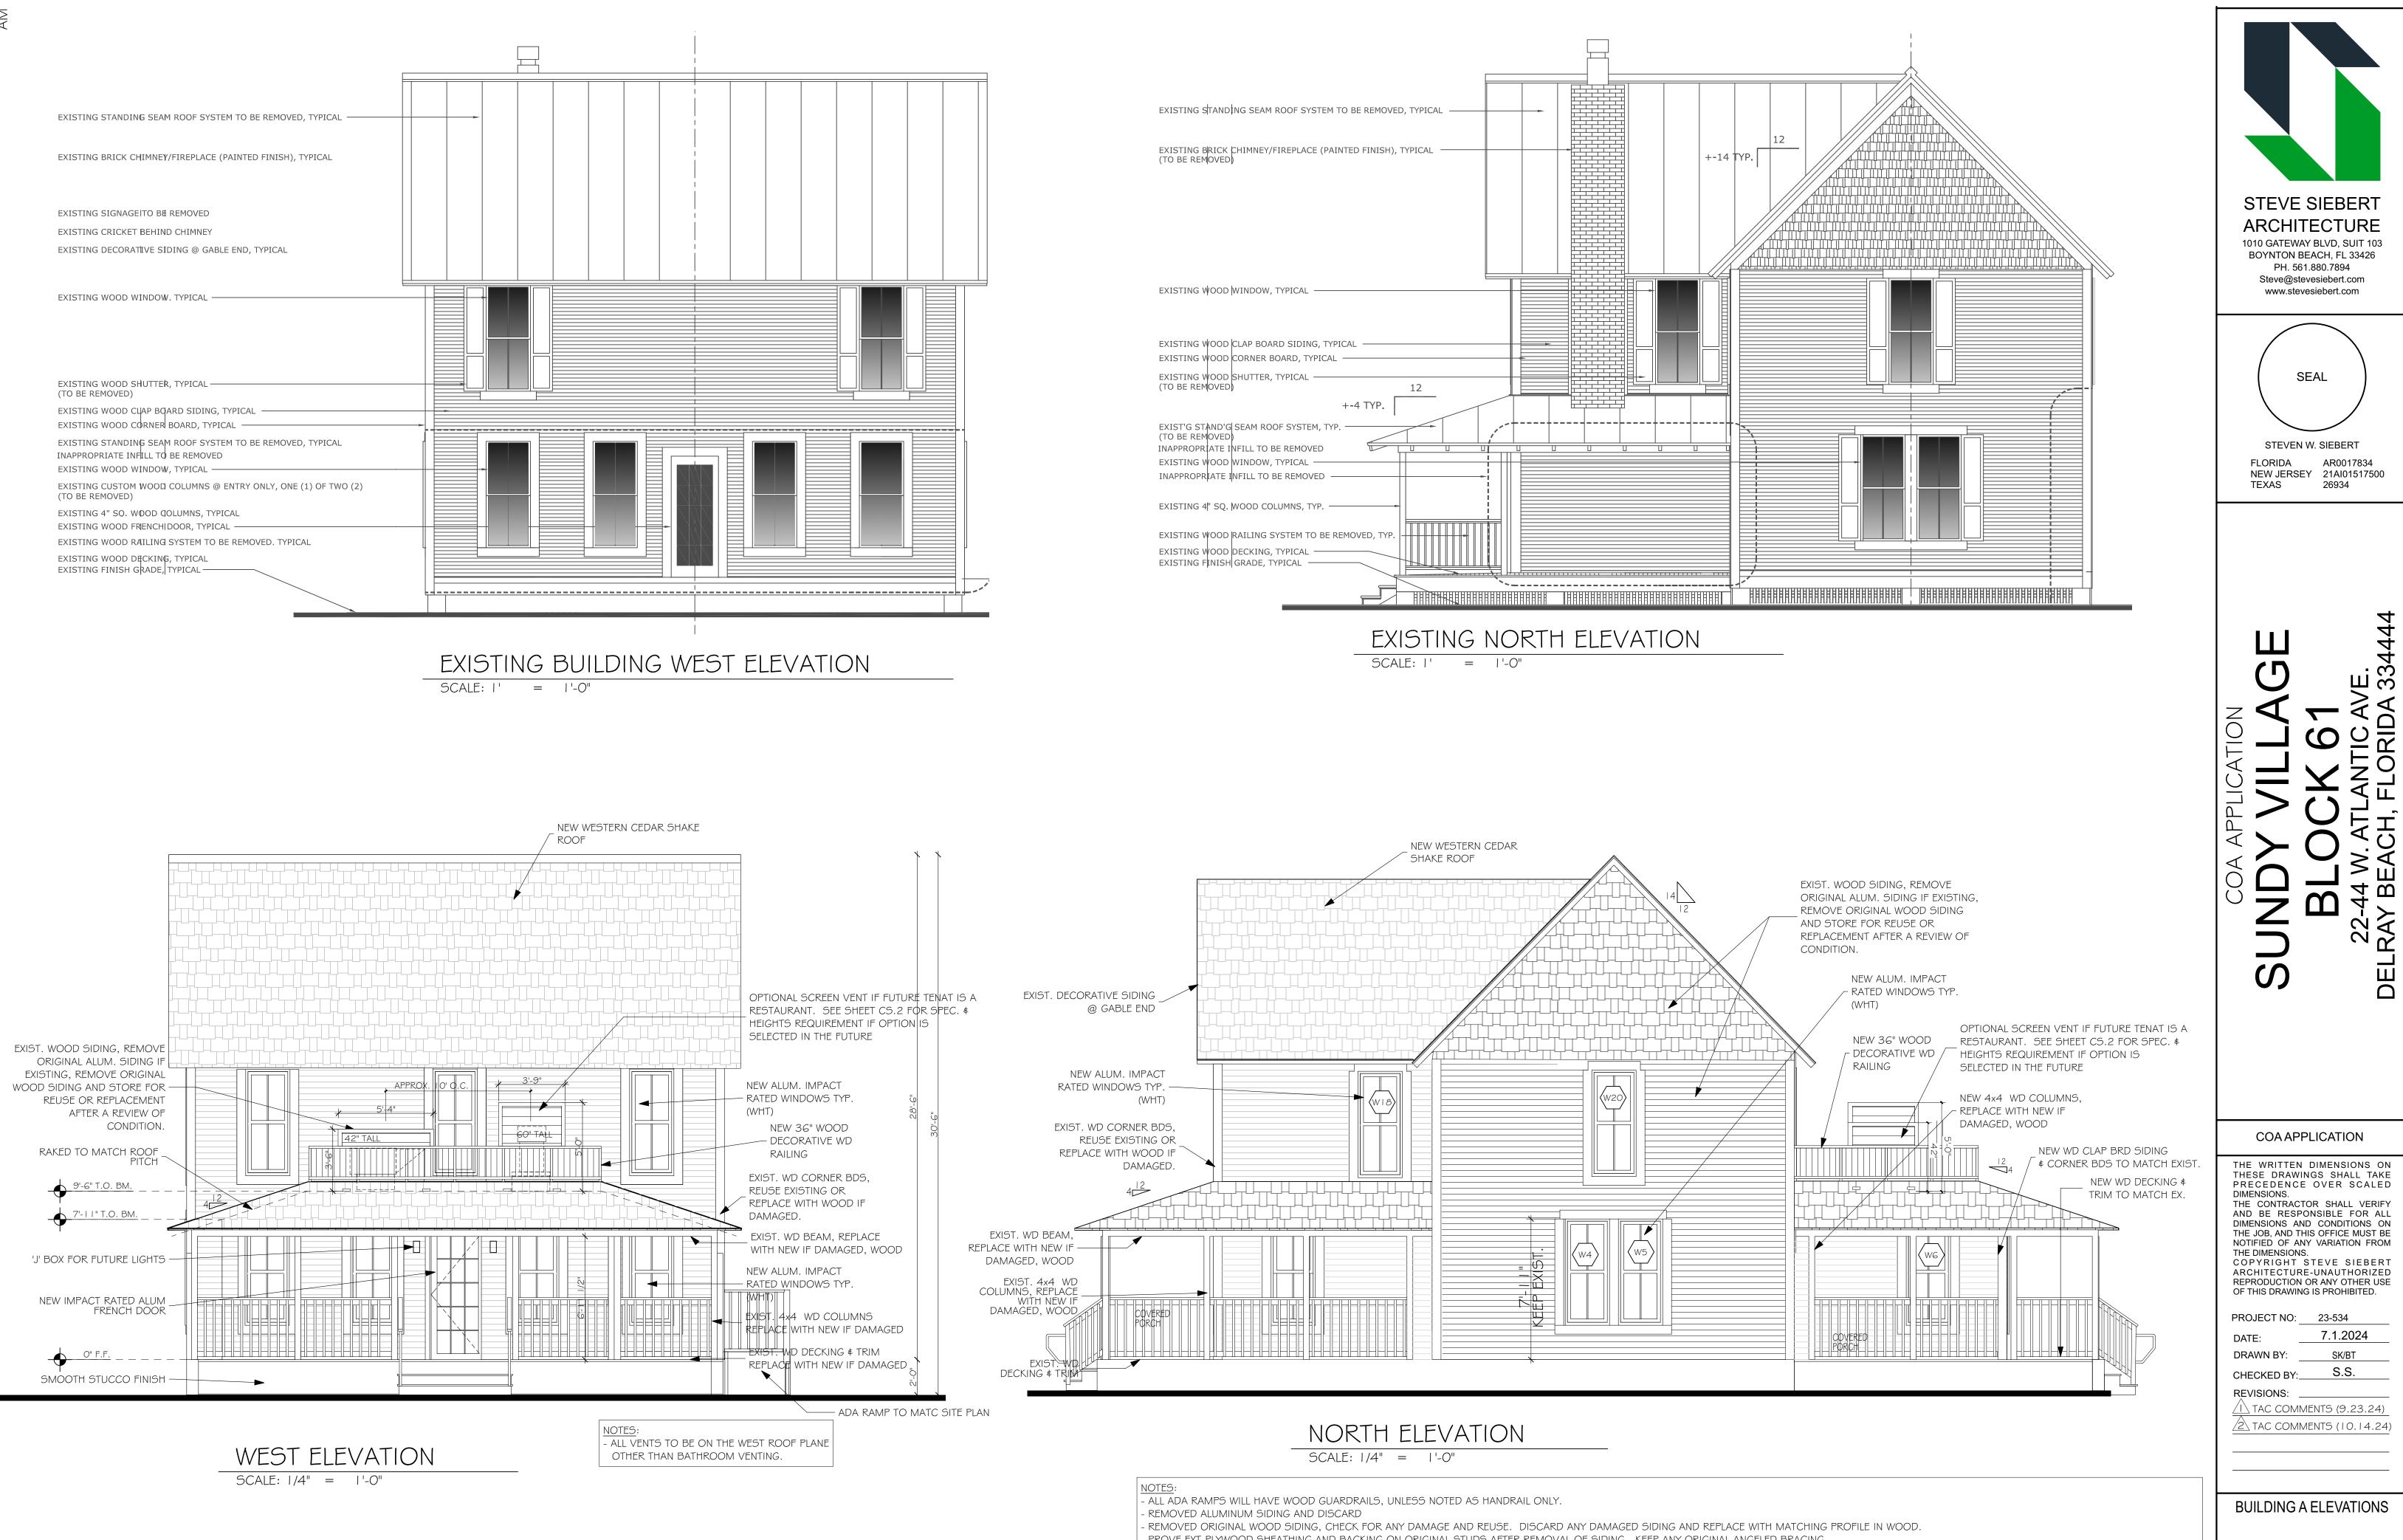



PROVE EXT-PLYWOOD SHEATHING AND BACKING ON ORIGINAL STUDS AFTER REMOVAL OF SIDING. KEEP ANY ORIGINAL ANGELED BRACING. - KEEP AND REPLACE ANY ORIGINAL TRIM WOOD AS MUCH AS POSSIBLE, ANY DAMAGED TO BE NEW AND MATCH EXISTING IN WOOD.

- ANY SCREENING TO MATCH STYLE, COLOR AND SIDING OF THE EXISTING HOME. - FOR ANY WOOD MEMBERS: REUSE EXISTING OR REPLACE WITH WOOD IF DAMAGED.

- WOOD SIDING TO BE REPLACED" INSTEAD OF "NEW SIDING". IF THERE ARE ANY OTHER ELEMENTS THAT CURRENTLY EXIST. ON THE STRUCTURE THAT IS BEING REPLACED WITH THE SAME MATERIAL.

**A-**

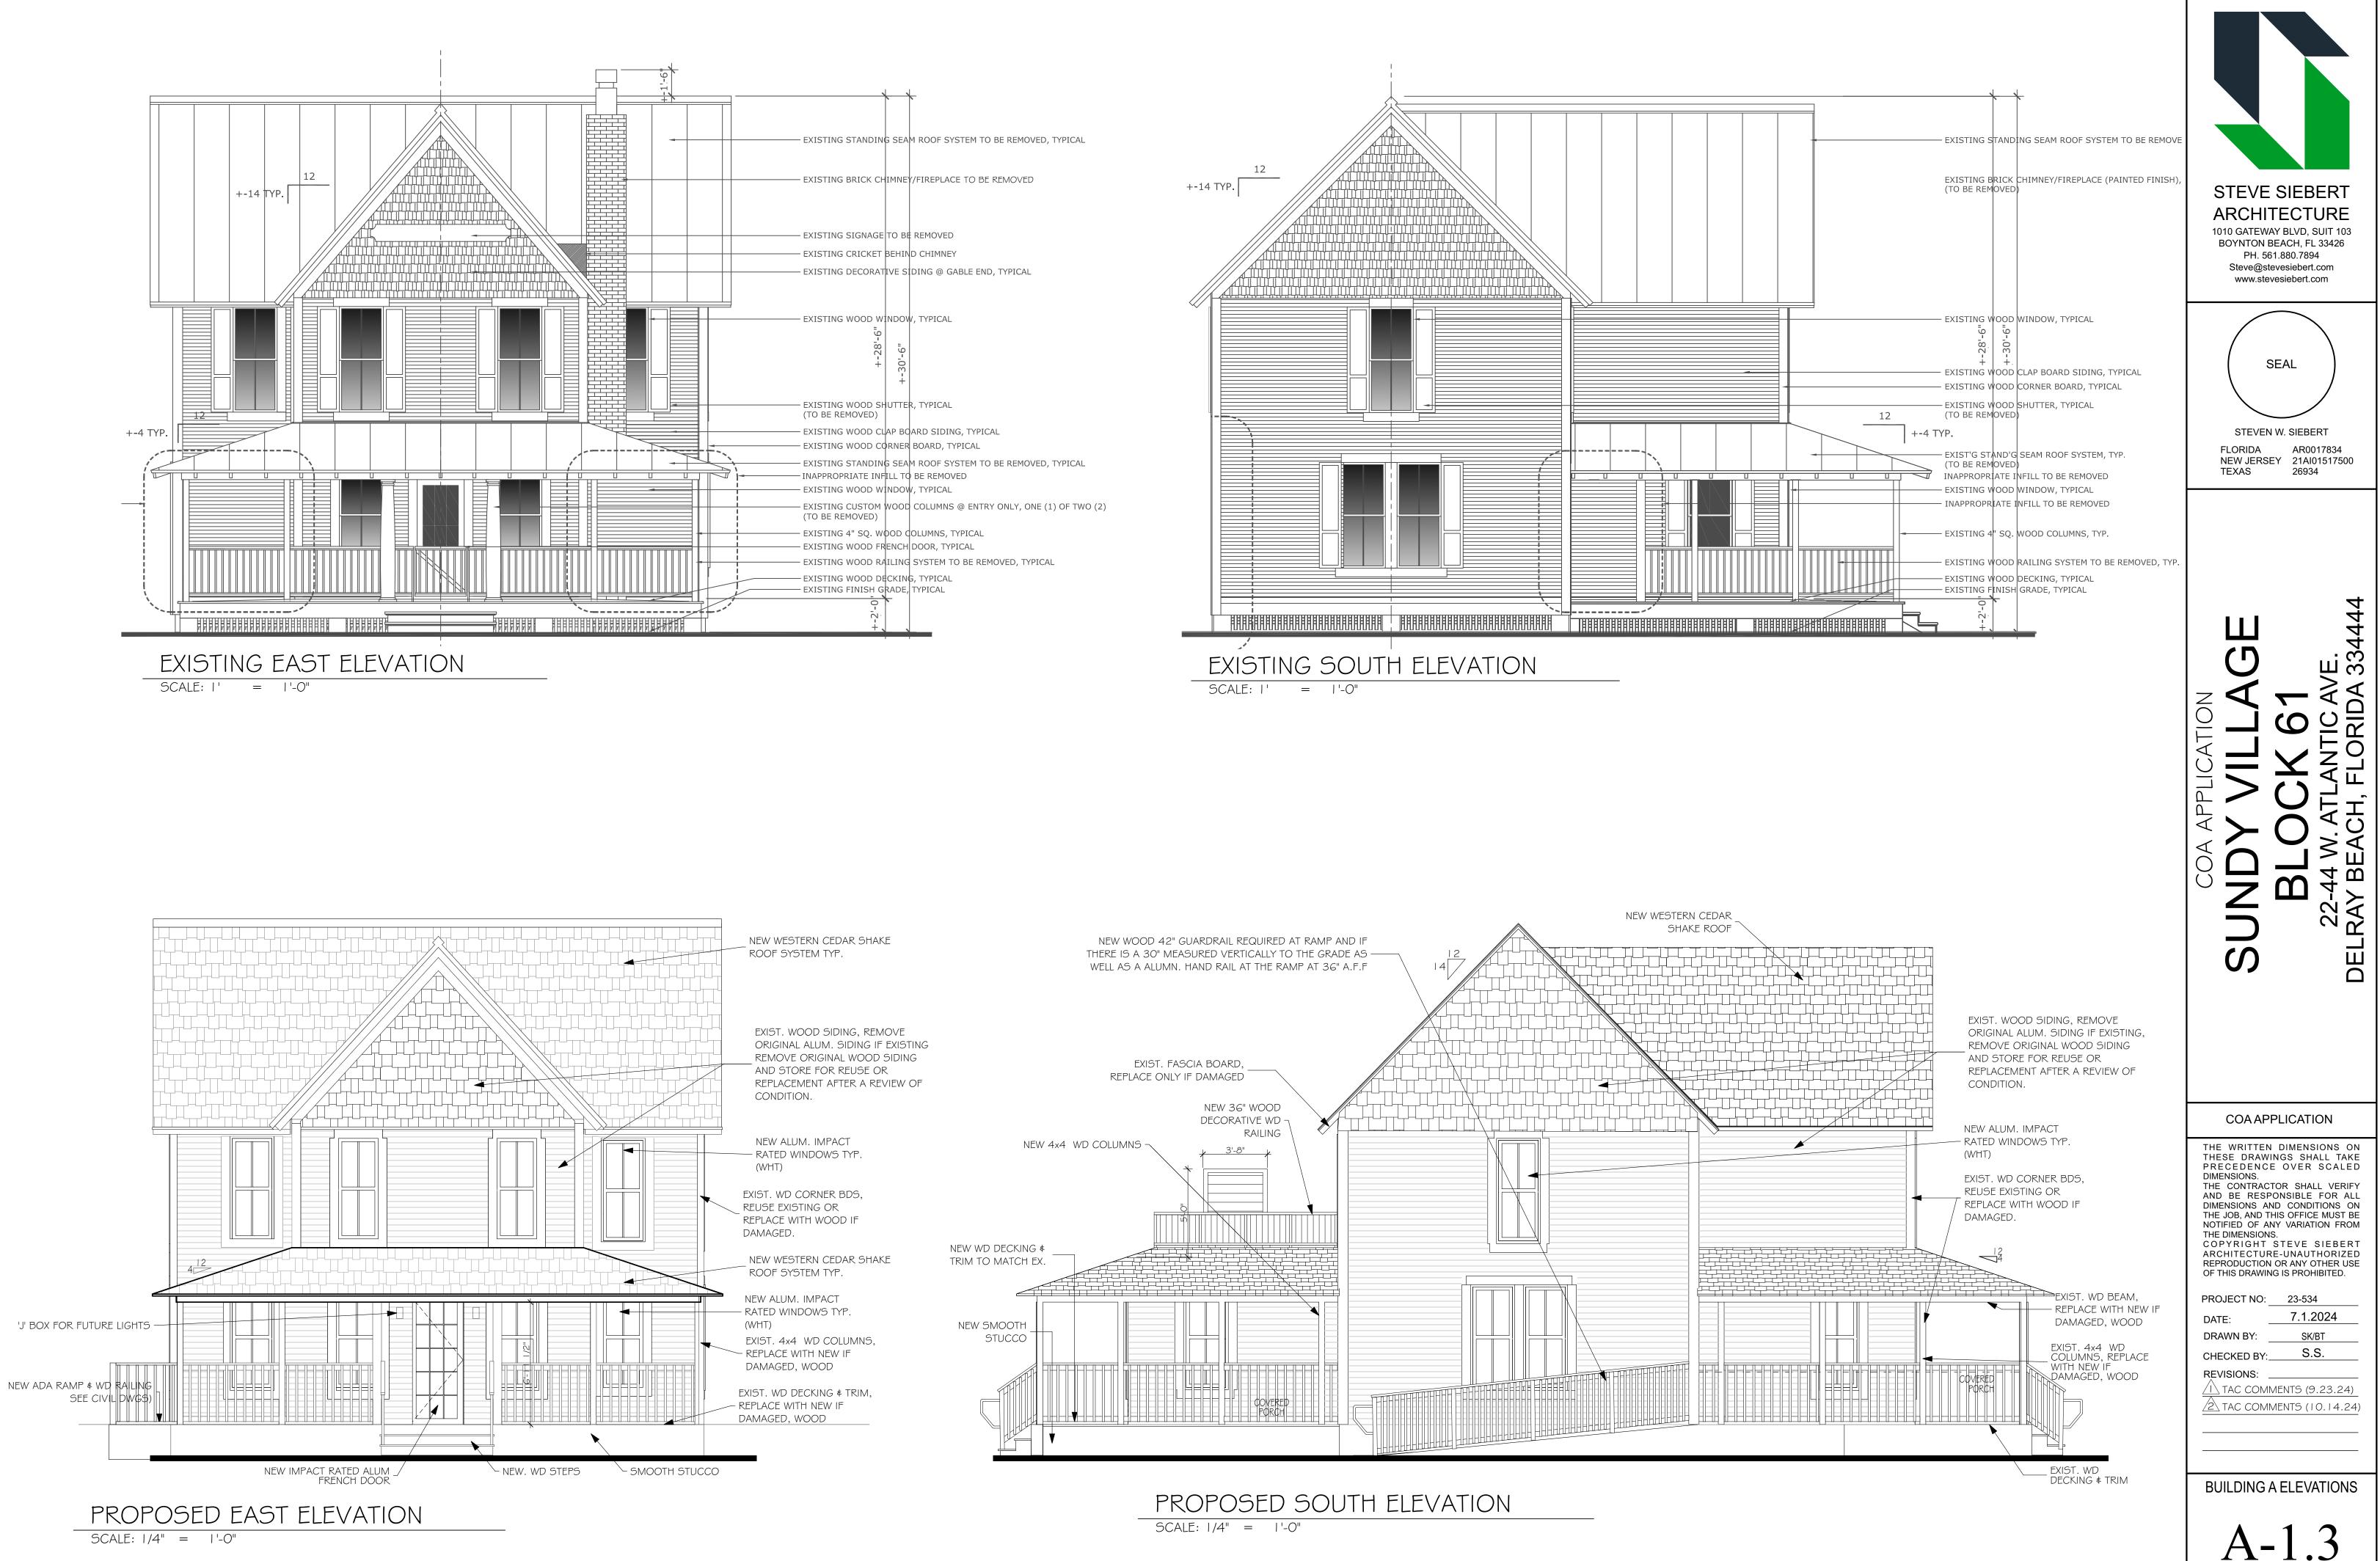

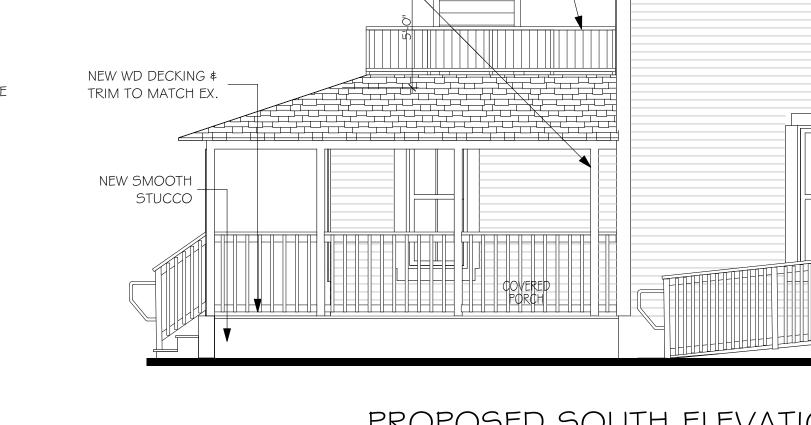

A-1.3

DEMOLITION NOTES:

CONTRACTOR.

OF ALL DEBRIS FROM THE SITE.

CONTAINMENT CONTRACTOR.

SUBMITTED BY THE GENERAL CONTRACTOR

- I. DEMOLITION PLANS SHOW APPROXIMATE LAYOUT OF EXISTING BUILDING AND ARE NOT INTENDED TO REPRESENT "AS-BUILT" CONDITIONS. CONTRACTOR
- SHALL VISIT THE SITE AND BECOME FAMILIAR WITH ACTUAL CONDITIONS WHEN BIDDING THE WORK, PRIOR TO THE START OF CONSTRUCTION.
- 2. WALLS, PARTITIONS, DOORS, FRAMES, AND OTHER ITEMS TO BE

4. ALL ELECTRICAL DEMOLITION (DISCONNECT) WORK SHALL BE PERFORMED

COMPLETED IN ACCORDANCE WITH CURRENT APPLICABLE CODES.

DISCONNECTED AND TEMPORARILY CAPPED TO BE EXTENDED AND RELOCATED ACCORDING TO THE FUTURE (SIGNED AND SEALED ENGINEERING DOCUMENTS) BY A FLORIDA LICENSED PLUMBING

7. THE DEMOLITION CONTRACTOR SHALL BE RESPONSIBLE FOR THE REMOVAL

8. ANY AND ALL HAZARDOUS MATERIAL TO BE REMOVED SHALL BE PROPERLY

IO. SELECTIVE DEMOLITION SHALL BE PERFORMED WITH A METHOD DESIGNED

9. ASBESTOS REPORT FOR DEMOLITION SHALL BE COMPLETED AND


TO PRESERVE ADJACENT MATERIAL SCHEDULED TO REMAIN.

REMOVED AS REQUIRED BY AN EPA LICENSED AND INSURED MATERIAL

5. ALL PLUMBING LINES; (SUPPLY & DRAIN) SHALL BE PROPERLY

BY A FLORIDA LICENSED ELECTRICAL CONTRACTOR. ALL WORK SHALL BE

- REMOVED ARE SHOWN DASHED. SERVICES (ELECTRICAL, PLUMBING, LOW-
- VOLTAGE, ETC) WITHIN DASHED (WALLS) SHALL ALSO BE REMOVED. 3. PROVIDE ALL NECESSARY SHORING, BRACING, AND SUPPORT TO PREVENT
  - MOVEMENT, SETTLEMENT, OR COLLAPSE OF STRUCTURE OR ELEMENT TO BE DEMOLISHED, AND ADJACENT STRUCTURE OR ELEMENT SHOWN TO REMAIN (IF APPLICABLE). SHORING AND BRACING SHALL BE DESIGNED BY A PROFESSIONAL ENGINEER LICENSED IN THE LOCAL JURISDICTION.

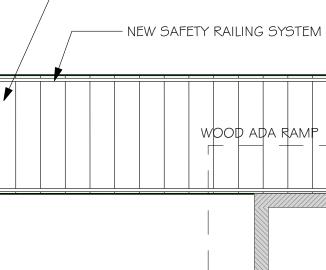

2 A5.0

WI8

W1

WIE


WI

WI

WI2


WI


WIC

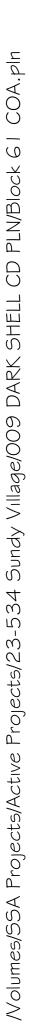


NOTE: ALL NEW MECHANICAL, PLUMBING, GAS AND ELECTRICAL WORK WILL BE PROVIDED WITH THE FUTURE TENANTS BUILD-OUT AND SHALL MEET ALL CURRENT FBC REQUIREMENTS. THIS IS ONLY A DARK SHELL TO REPAIR THE EXISTING BUILDING WITH NO TENANT.



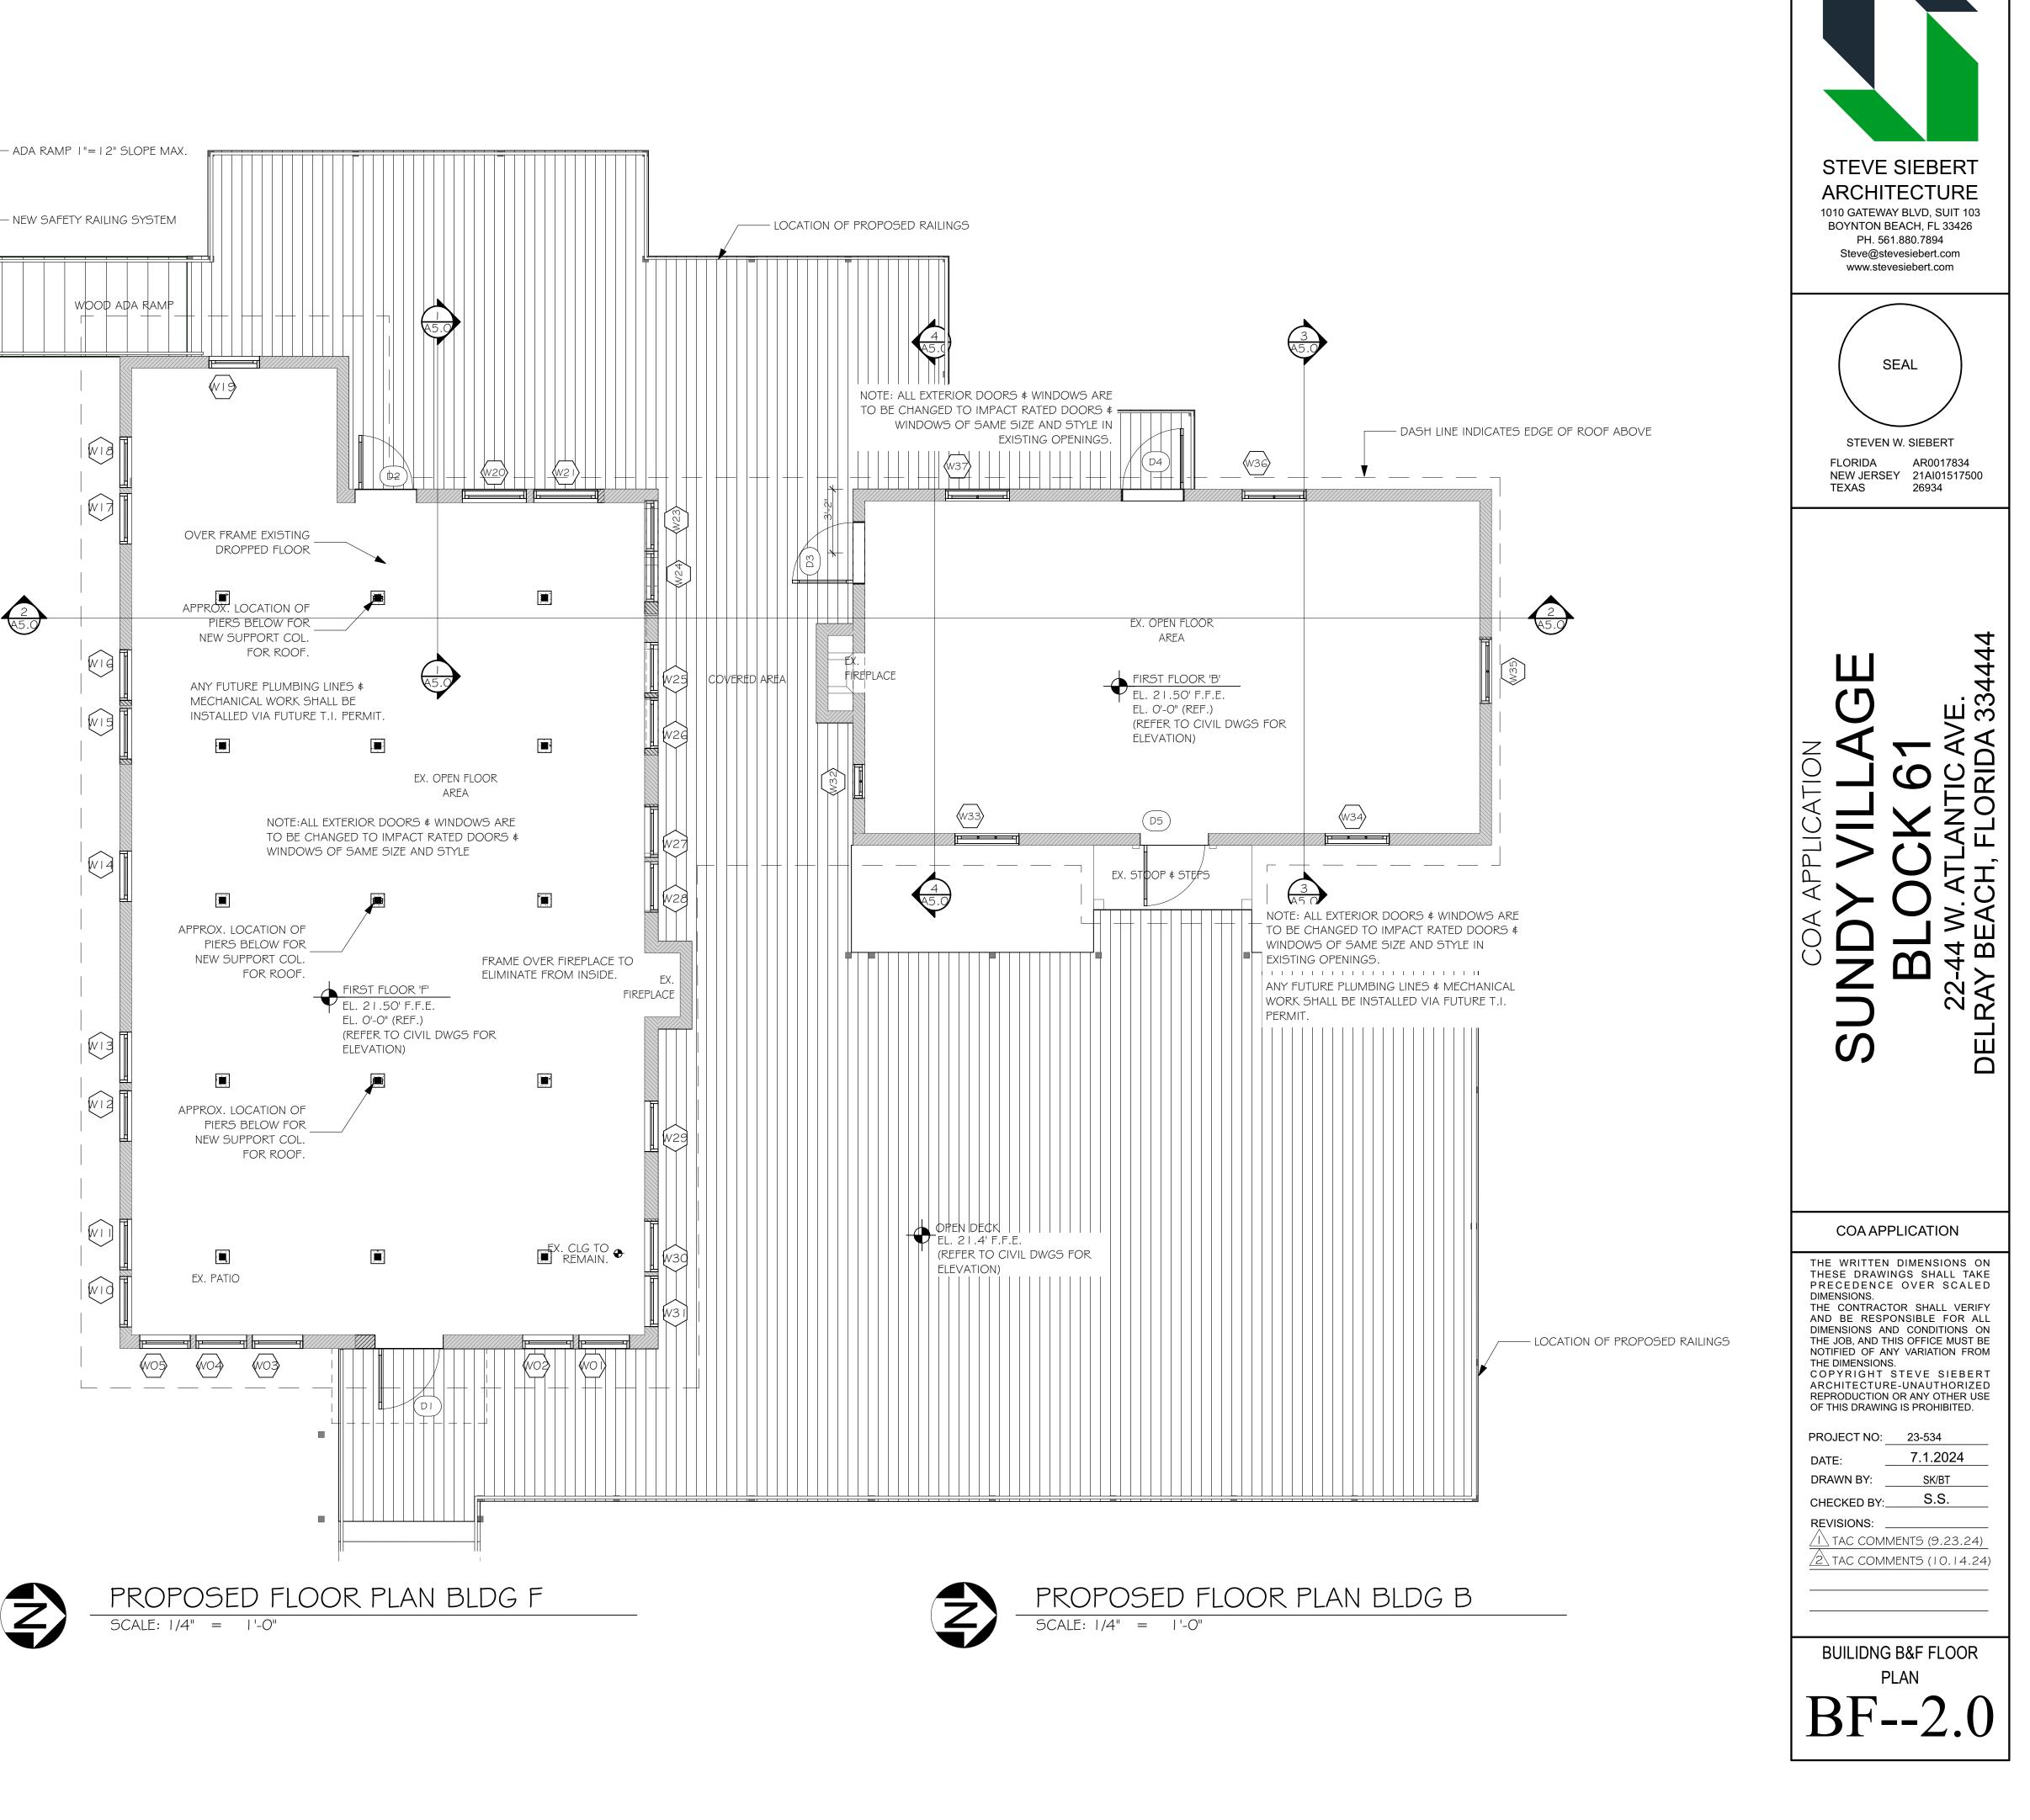

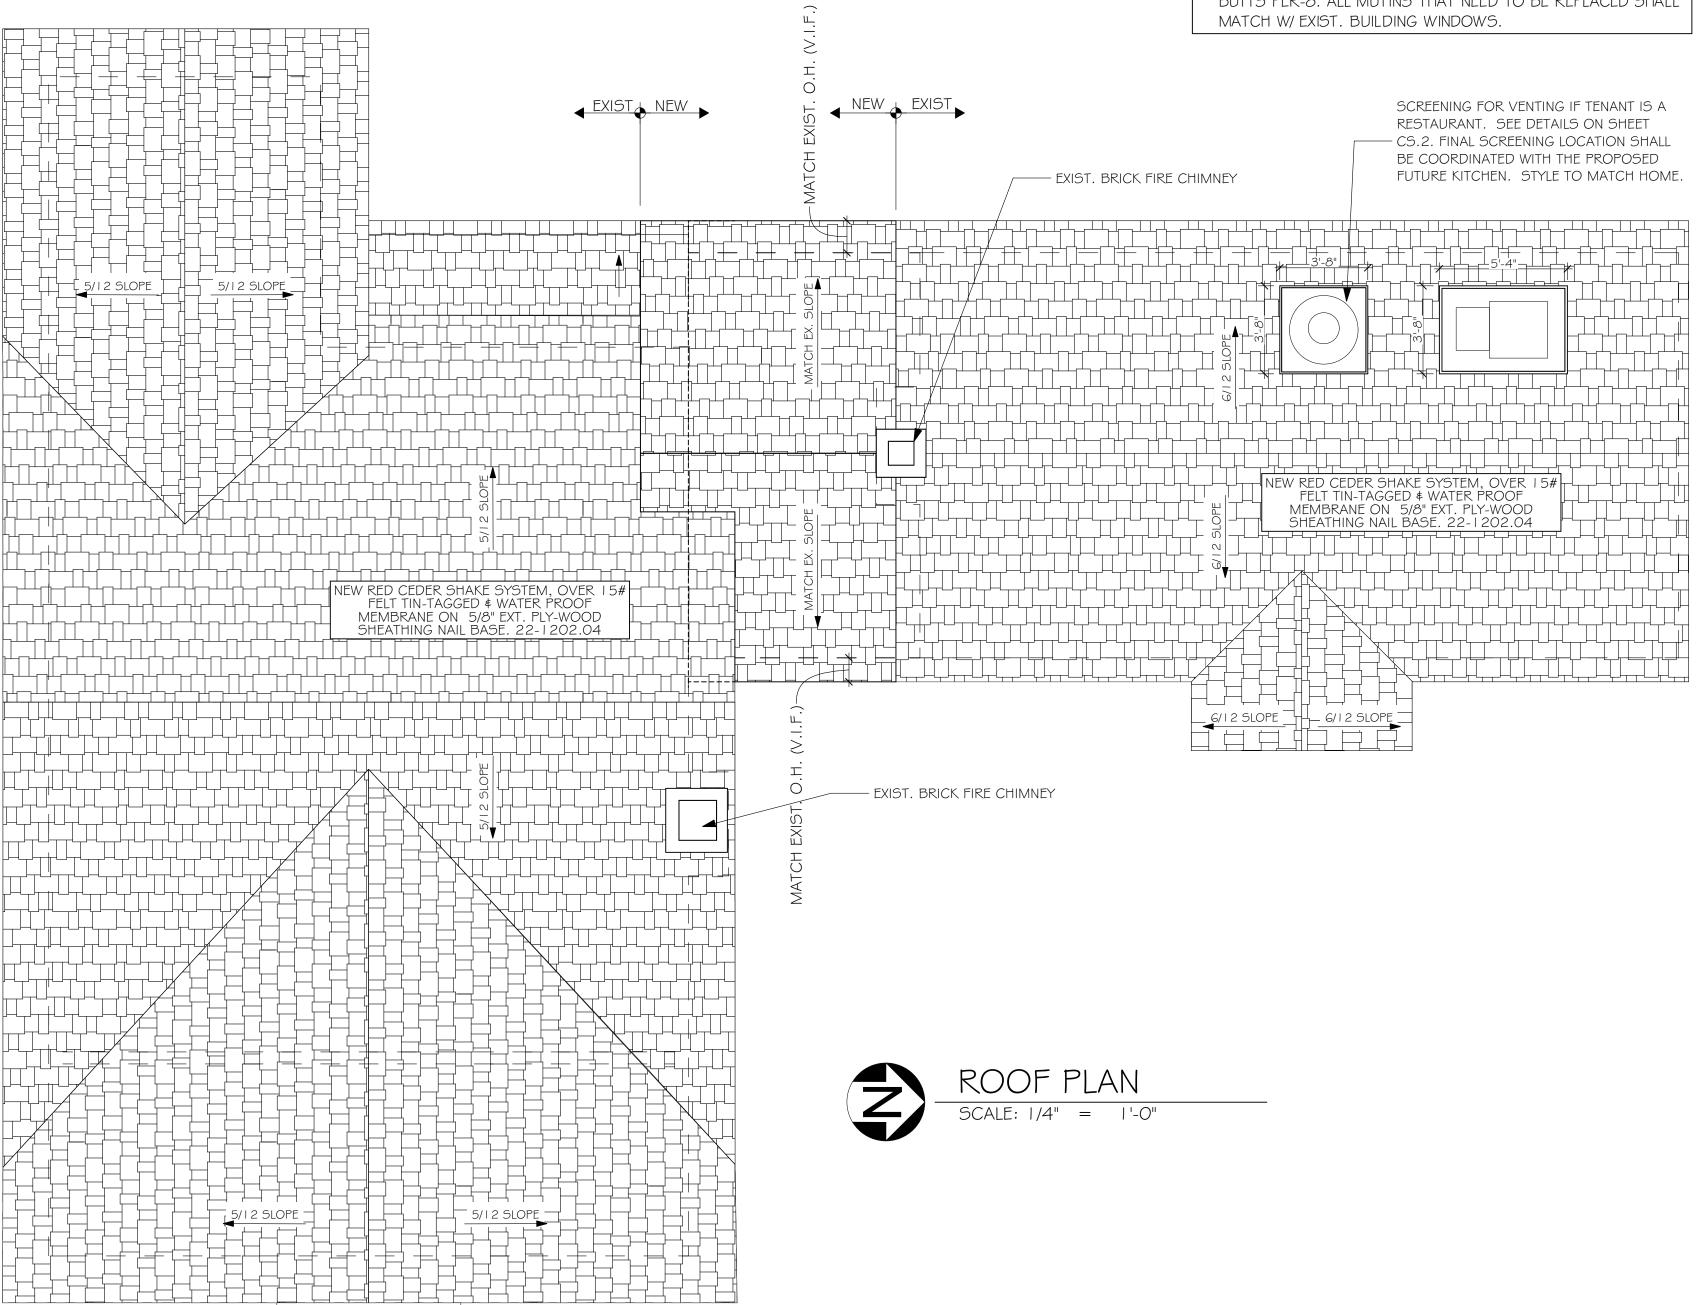

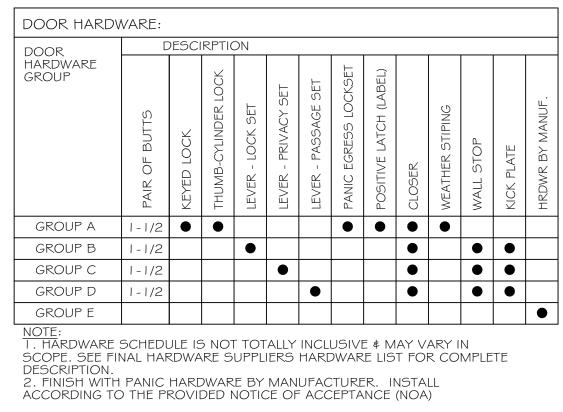

BE TEMP. GLASS "SAFETY GLASS" REFER TO STRUCTRAL DWGS. FOR MIN. PRESSURES REQUIREMENTS. IF APPLICABLE, ALL 8' HIGH DOORS MUST HAVE (2) PAIR OF BUTTS PER-8. ALL MUTINS THAT NEED TO BE REPLACED SHALL

REFER TO GENERAL NOTES \$ SPEC. FOR ADDITIONAL NOTES


G.C. SHALL COORDINATE OPENINGS W/ DOOR & WINDOW


ALL EXTERIOR DOORS AND WINDOWS TO BE IMPACT RATED. ALL NEW INTERIOR GLASS DOORS AND/OR WINDOWS SHALL

DOOR & WINDOW NOTES:

NON-REFLECTIVE).

MANUFACTURER.

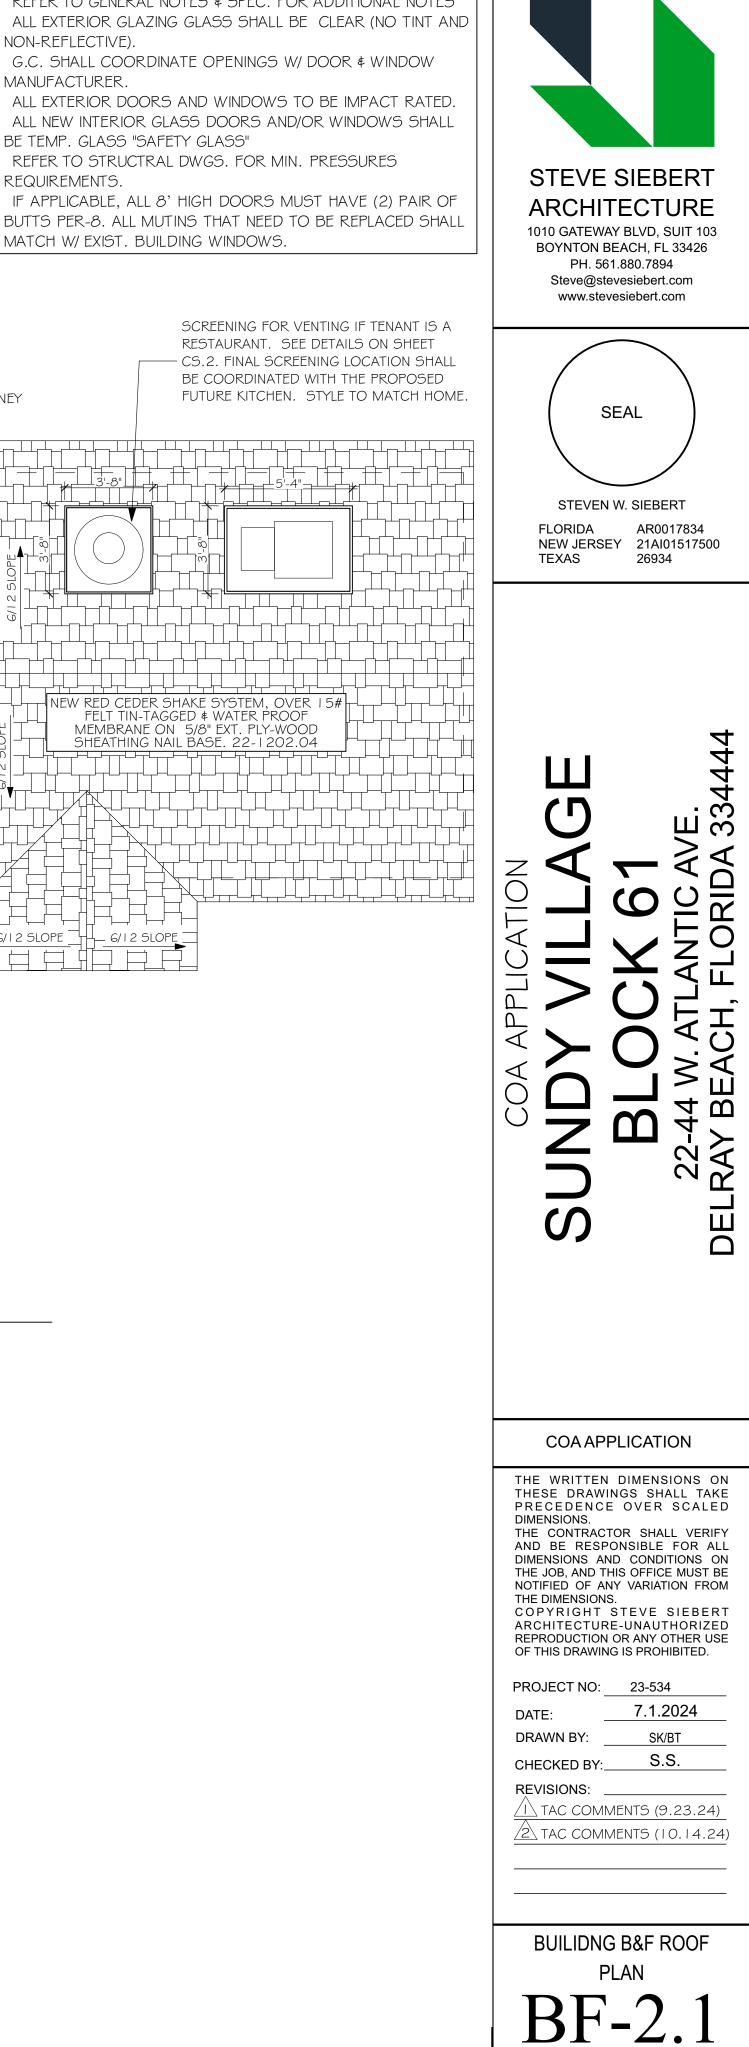

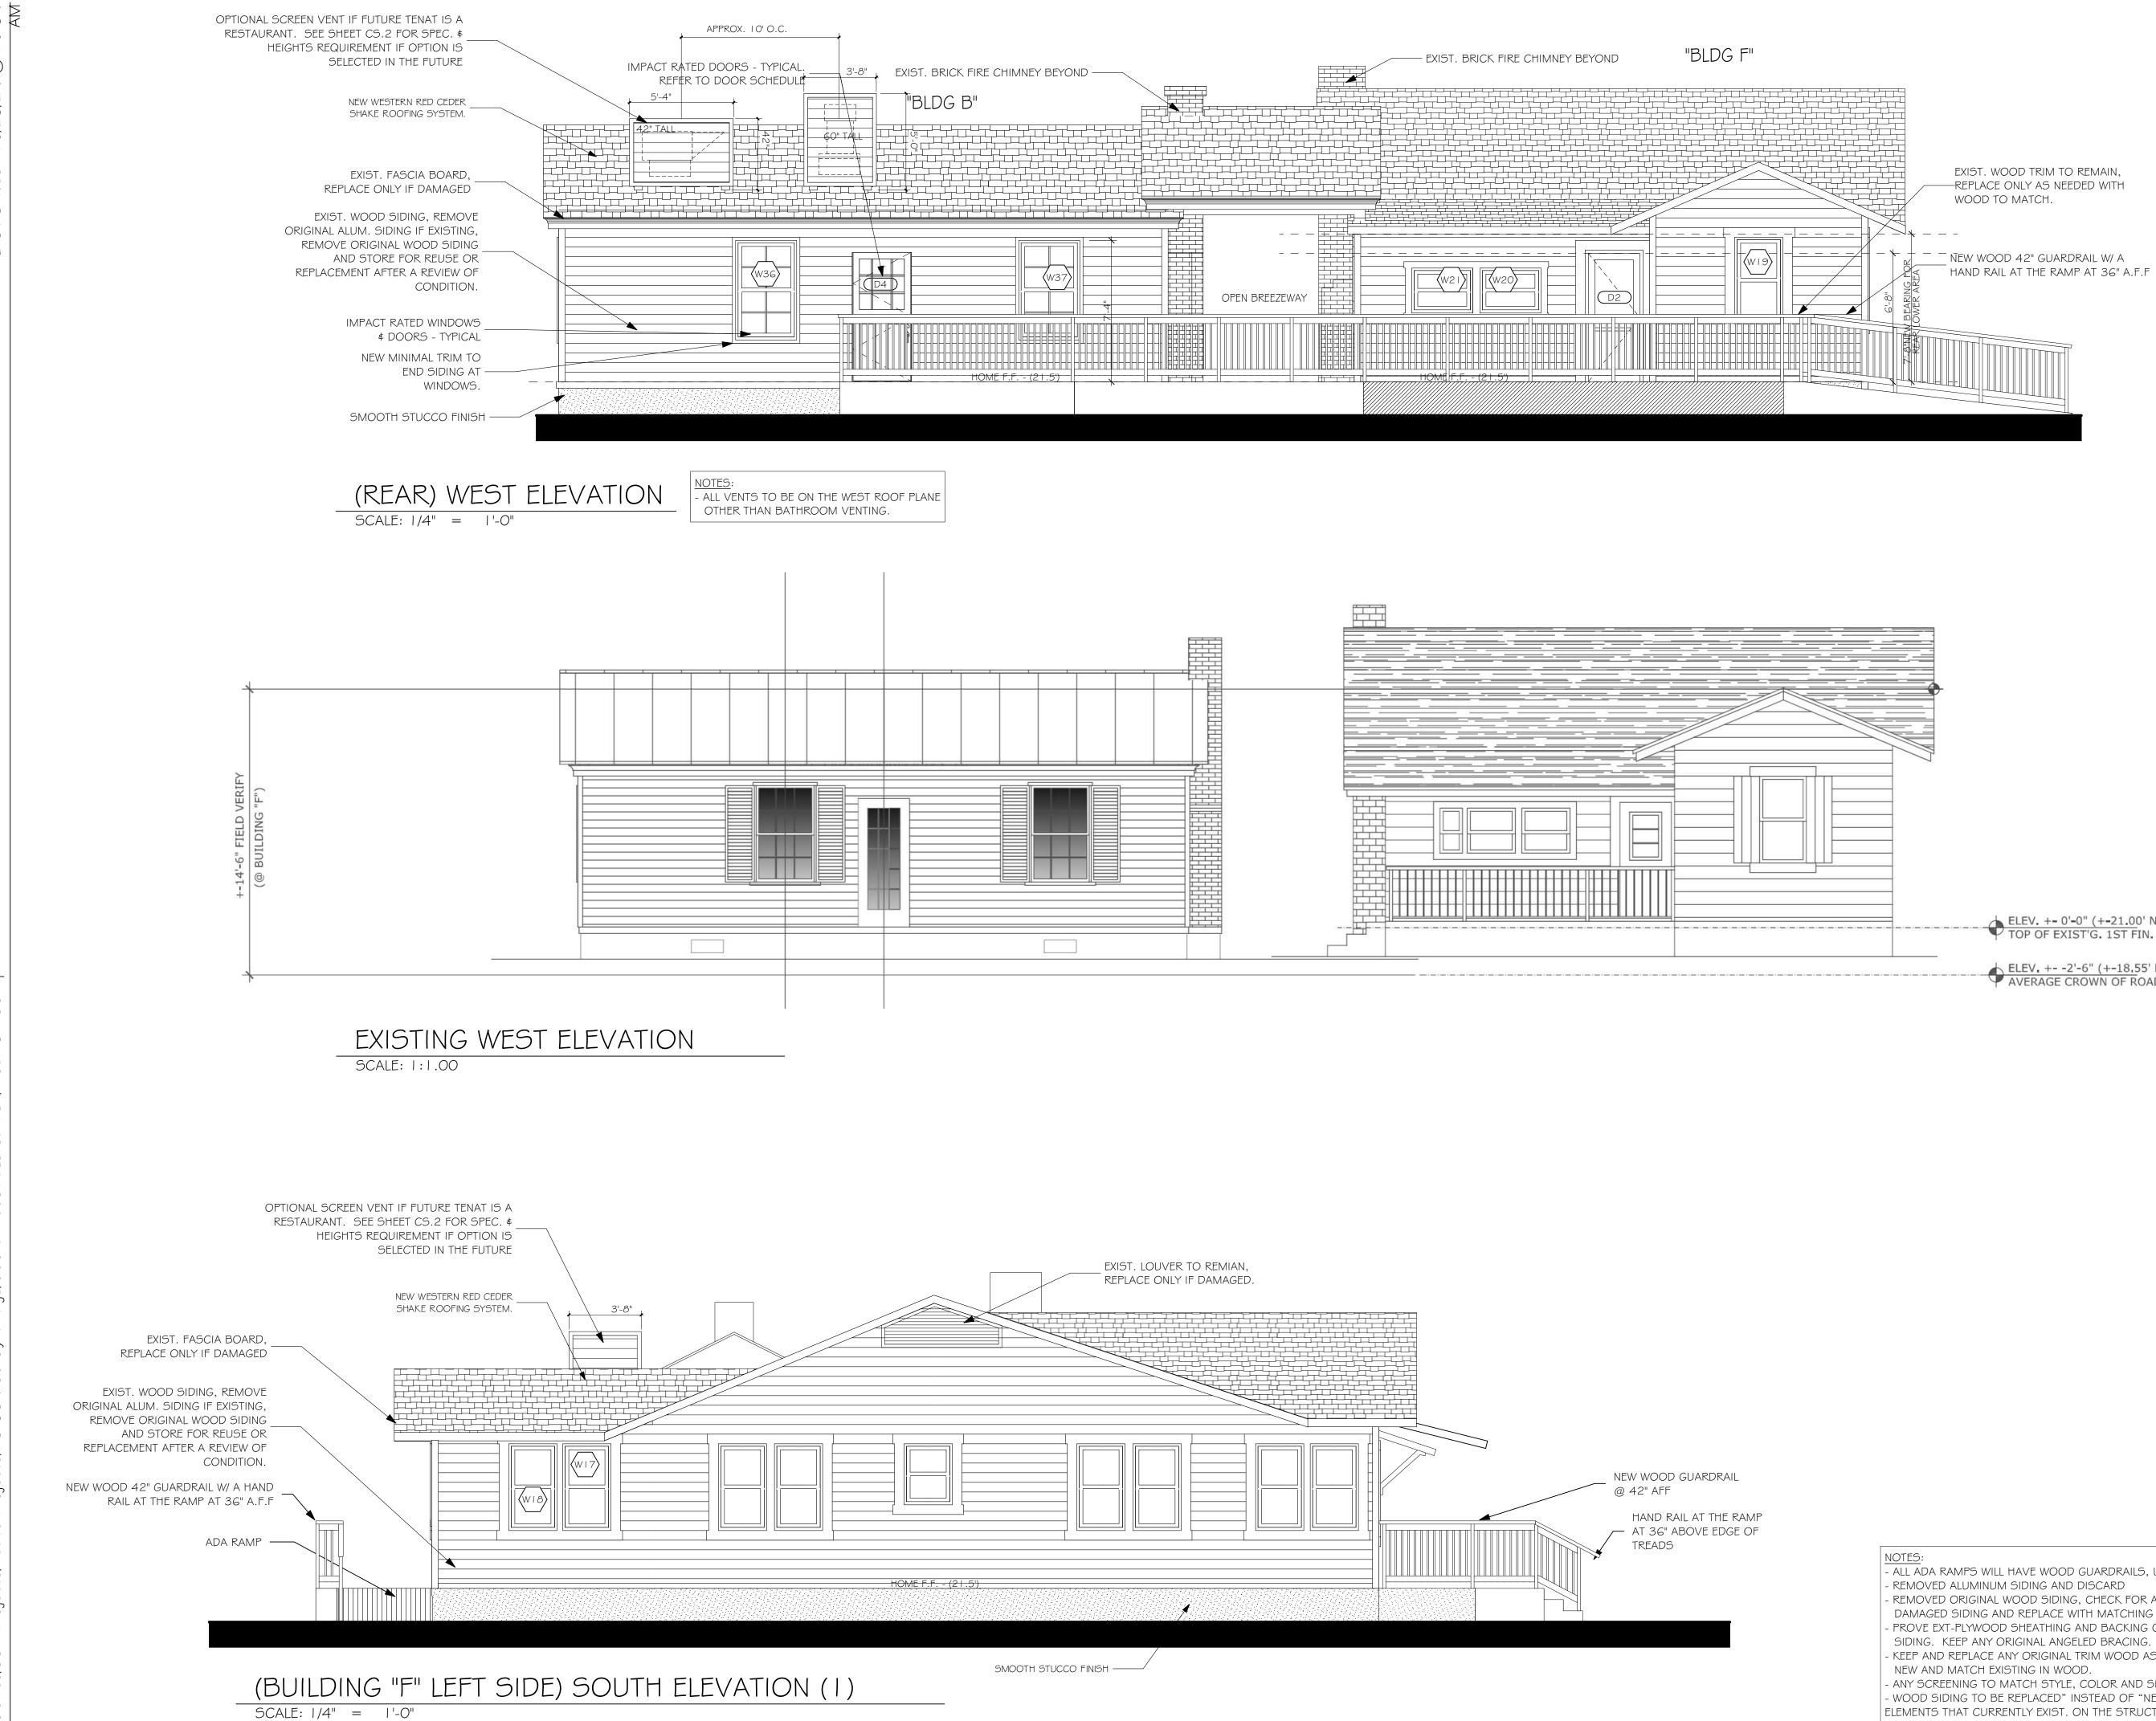

S  $\bigcirc$  $\bigcirc$ O

ELEV. +- 0'-0" (+-21.00' NAVD) TOP OF EXIST'G. 1ST FIN. FLR. ELEV. +- -2'-6" (+-18.55' NAVD) AVERAGE CROWN OF ROAD

- ALL ADA RAMPS WILL HAVE WOOD GUARDRAILS, UNLESS NOTED AS HANDRAIL ONLY. - REMOVED ALUMINUM SIDING AND DISCARD


- REMOVED ORIGINAL WOOD SIDING, CHECK FOR ANY DAMAGE AND REUSE. DISCARD ANY DAMAGED SIDING AND REPLACE WITH MATCHING PROFILE IN WOOD. PROVE EXT-PLYWOOD SHEATHING AND BACKING ON ORIGINAL STUDS AFTER REMOVAL OF

KEEP AND REPLACE ANY ORIGINAL TRIM WOOD AS MUCH AS POSSIBLE, ANY DAMAGED TO BE


- ANY SCREENING TO MATCH STYLE, COLOR AND SIDING OF THE EXISTING HOME.

- WOOD SIDING TO BE REPLACED" INSTEAD OF "NEW SIDING". IF THERE ARE ANY OTHER ELEMENTS THAT CURRENTLY EXIST. ON THE STRUCTURE THAT IS BEING REPLACED WITH THE SAME MATERIAL.


STEVE SIEBERT         ACCULATION BEACH, FL 33426         PH. 561.880.7894         Steve@stevesiebert.com
SEAL SEAL STEVEN W. SIEBERT FLORIDA AR0017834 NEW JERSEY 21AI01517500 TEXAS 26934
COA APPLICATION SUNDY VILLAGE BLOCK 61 22-44 W. ATLANTIC AVE. DELRAY BEACH, FLORIDA 334444
COA APPLICATION
THE WRITTEN DIMENSIONS ON         THESE DRAWINGS SHALL TAKE         PRECEDENCE OVER SCALED         DIMENSIONS.         THE CONTRACTOR SHALL VERIFY         AND BE RESPONSIBLE FOR ALL         DIMENSIONS AND CONDITIONS ON         THE JOB, AND THIS OFFICE MUST BE         NOTIFIED OF ANY VARIATION FROM         THE DIMENSIONS.         COPYRIGHT STEVE SIEBERT         ARCHITECTURE-UNAUTHORIZED         REPRODUCTION OR ANY OTHER USE         OF THIS DRAWING IS PROHIBITED.         PROJECT NO:       23-534         DATE:       7.1.2024         DRAWN BY:       SK/BT         CHECKED BY:       S.S.         REVISIONS:
BUILDING B&F ELEVATIONS BF-2.2

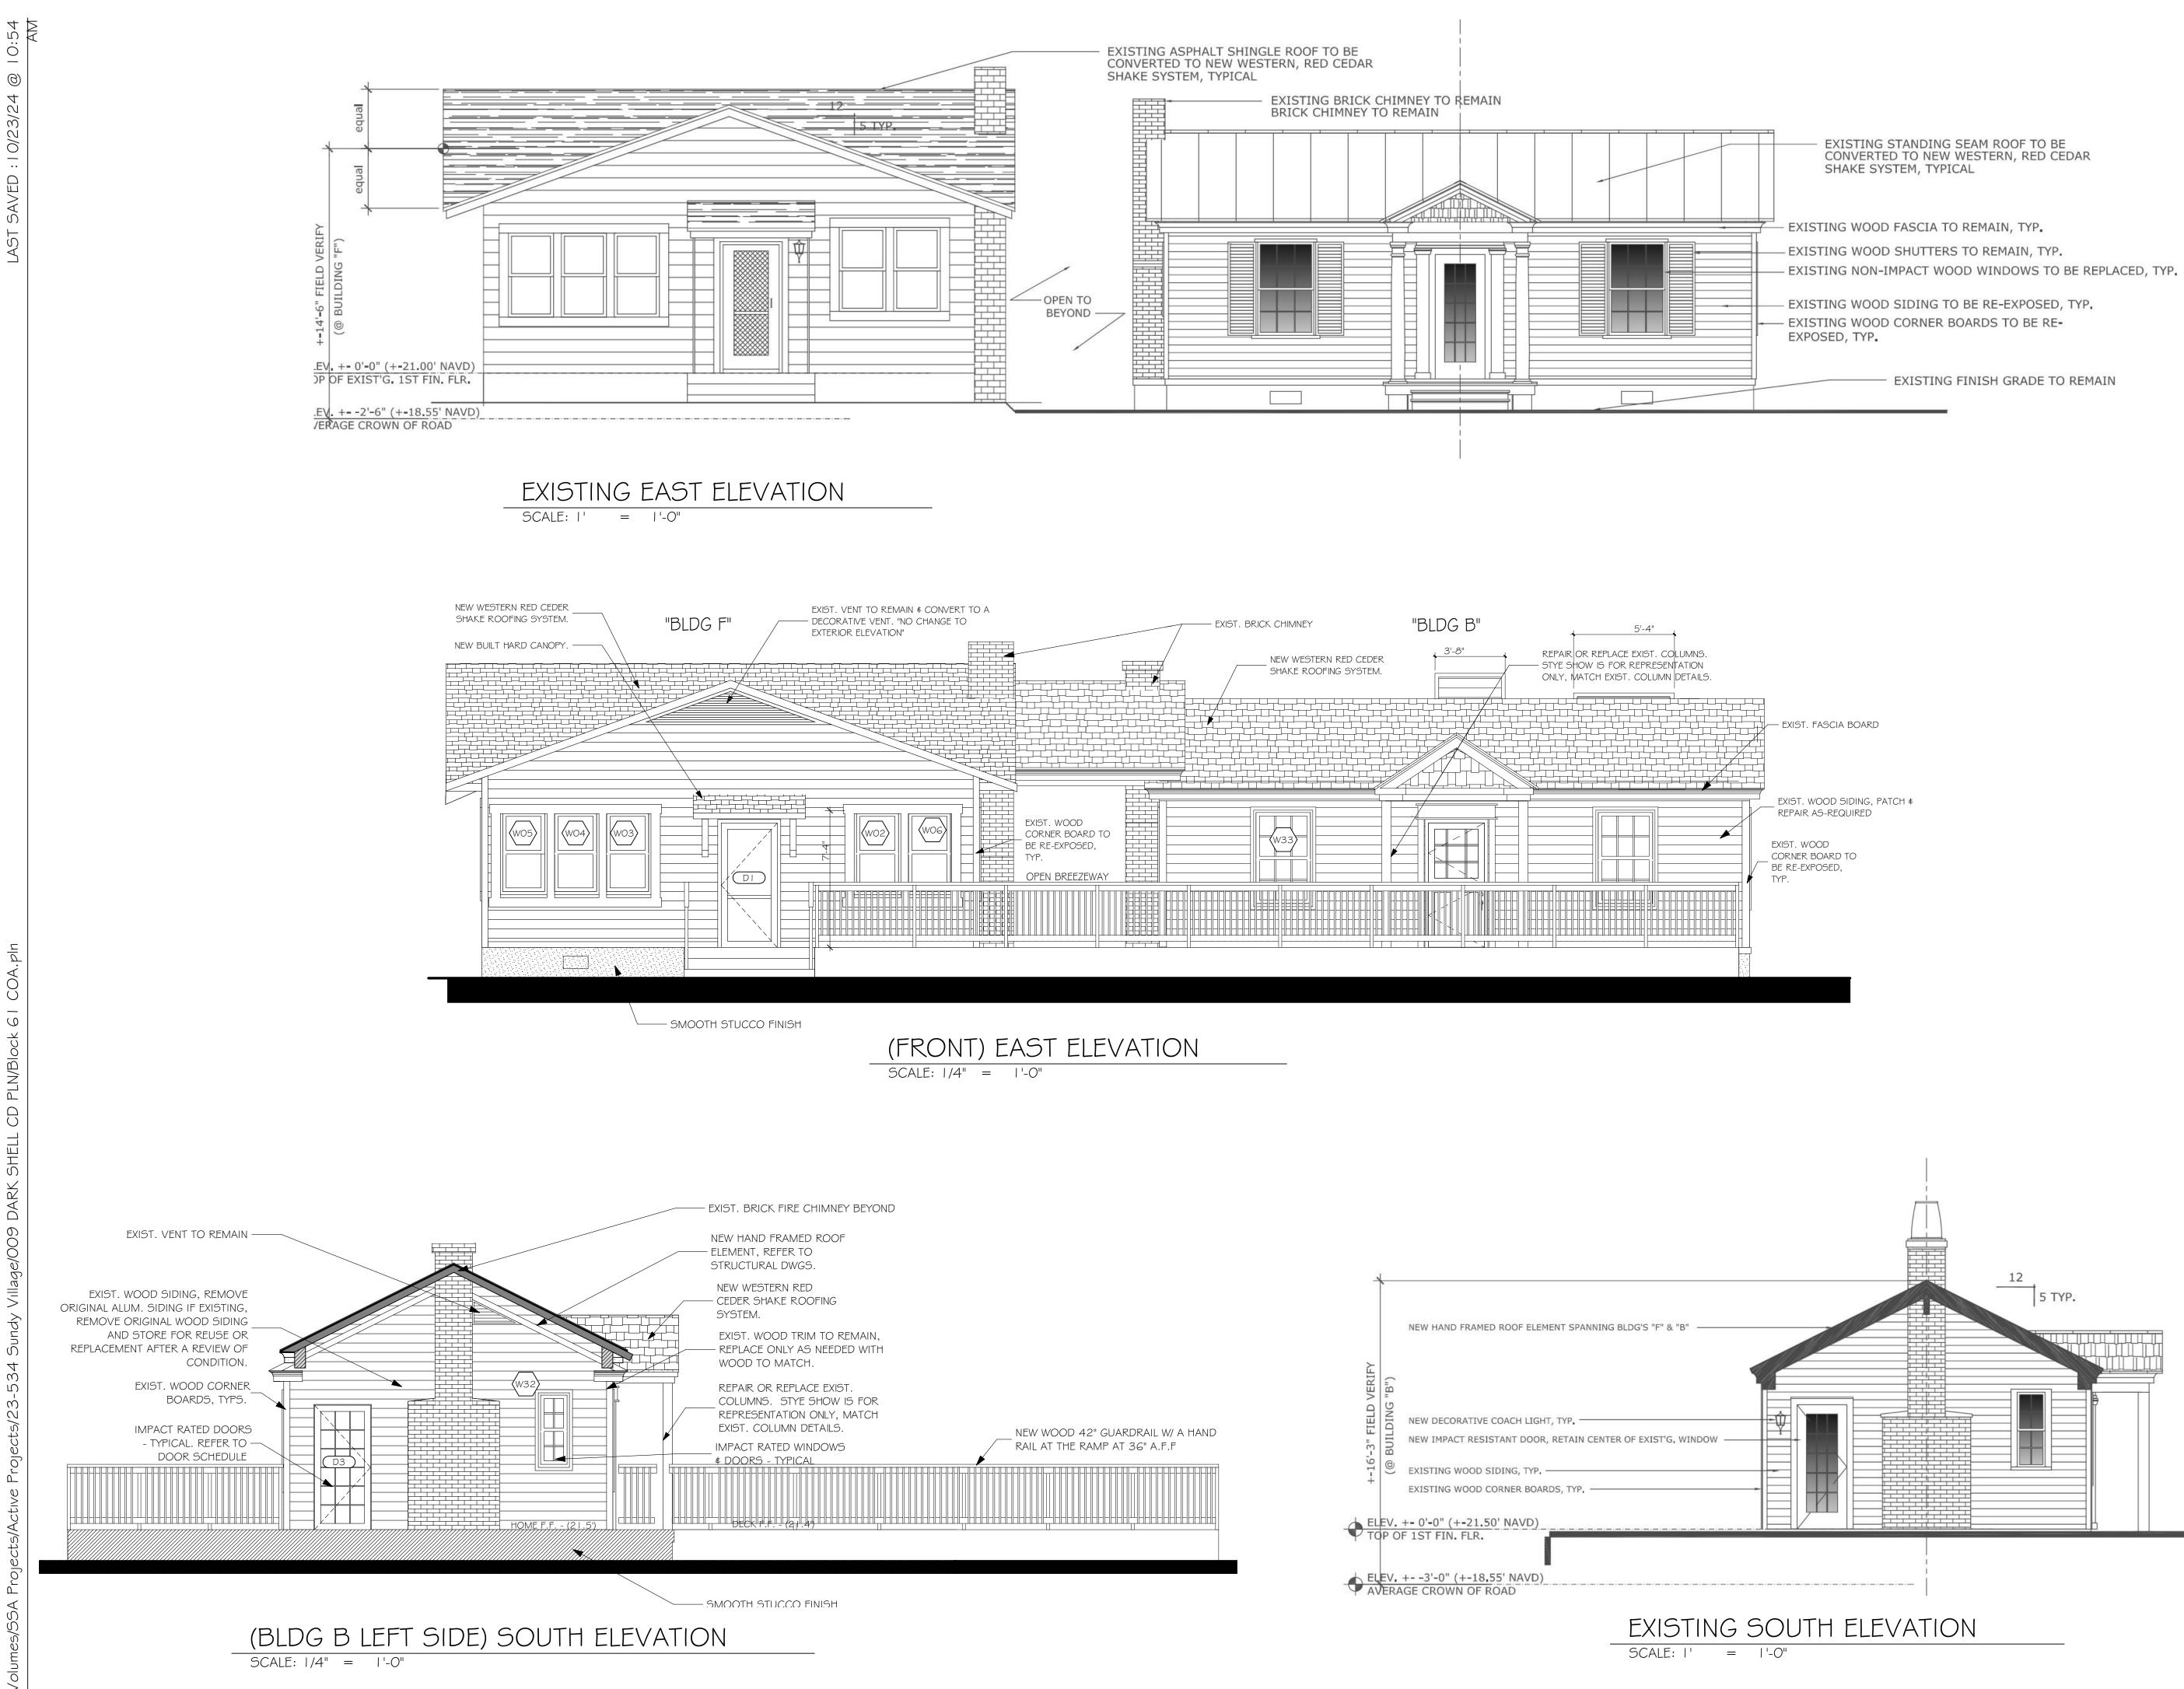




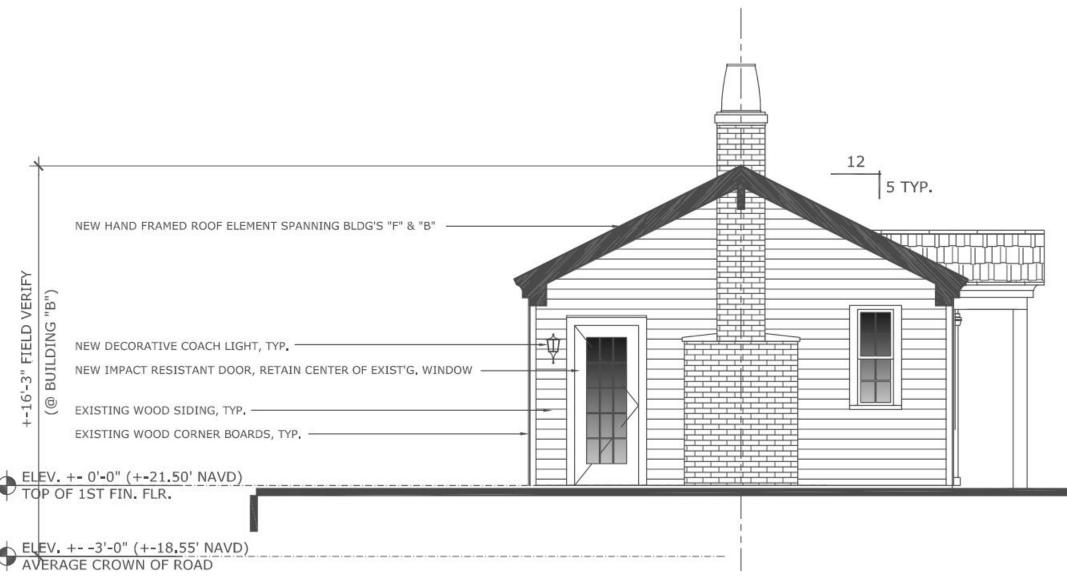

<image/> <section-header></section-header>	
SEAL STEVEN W. SIEBERT FLORIDA AR0017834 NEW JERSEY 21AI01517500 TEXAS 26934	
COA APPLICATION SUNDY VILLAGE BLOCK 61 22-44 W. ATLANTIC AVE. DELRAY BEACH. FLORIDA 334444	
COA APPLICATION         THE WRITTEN DIMENSIONS ON THESE DRAWINGS SHALL TAKE PRECEDENCE OVER SCALED DIMENSIONS.         THE CONTRACTOR SHALL VERIFY AND BE RESPONSIBLE FOR ALL DIMENSIONS AND CONDITIONS ON THE JOB, AND THIS OFFICE MUST BE NOTIFIED OF ANY VARIATION FROM THE DIMENSIONS.         COPYRIGHT STEVE SIEBERT ARCHITECTURE-UNAUTHORIZED REPRODUCTION OR ANY OTHER USE OF THIS DRAWING IS PROHIBITED.         PROJECT NO:       23-534         DATE:       7.1.2024         DRAWN BY:       SK/BT         CHECKED BY:       S.S.         REVISIONS:	
BUILDING B&F ELEVATIONS BF-23	-

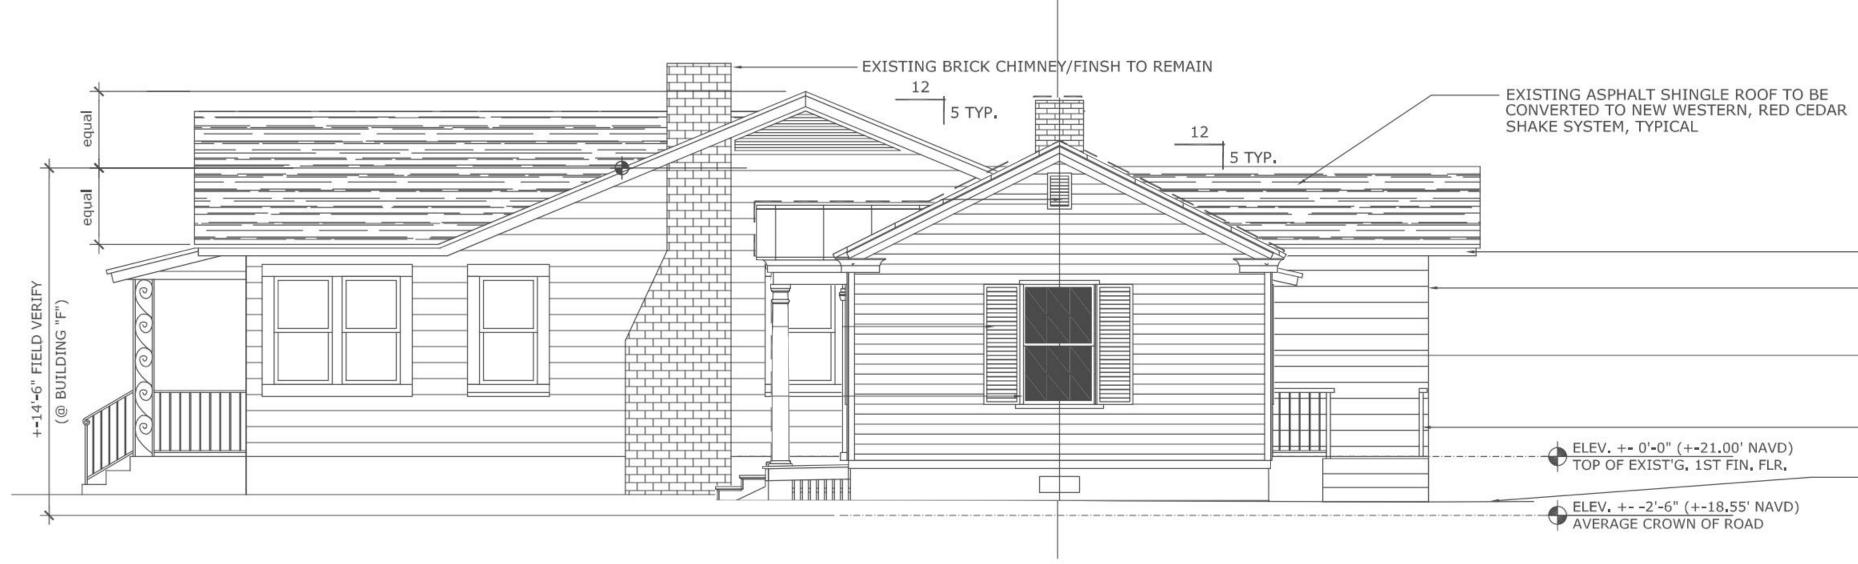



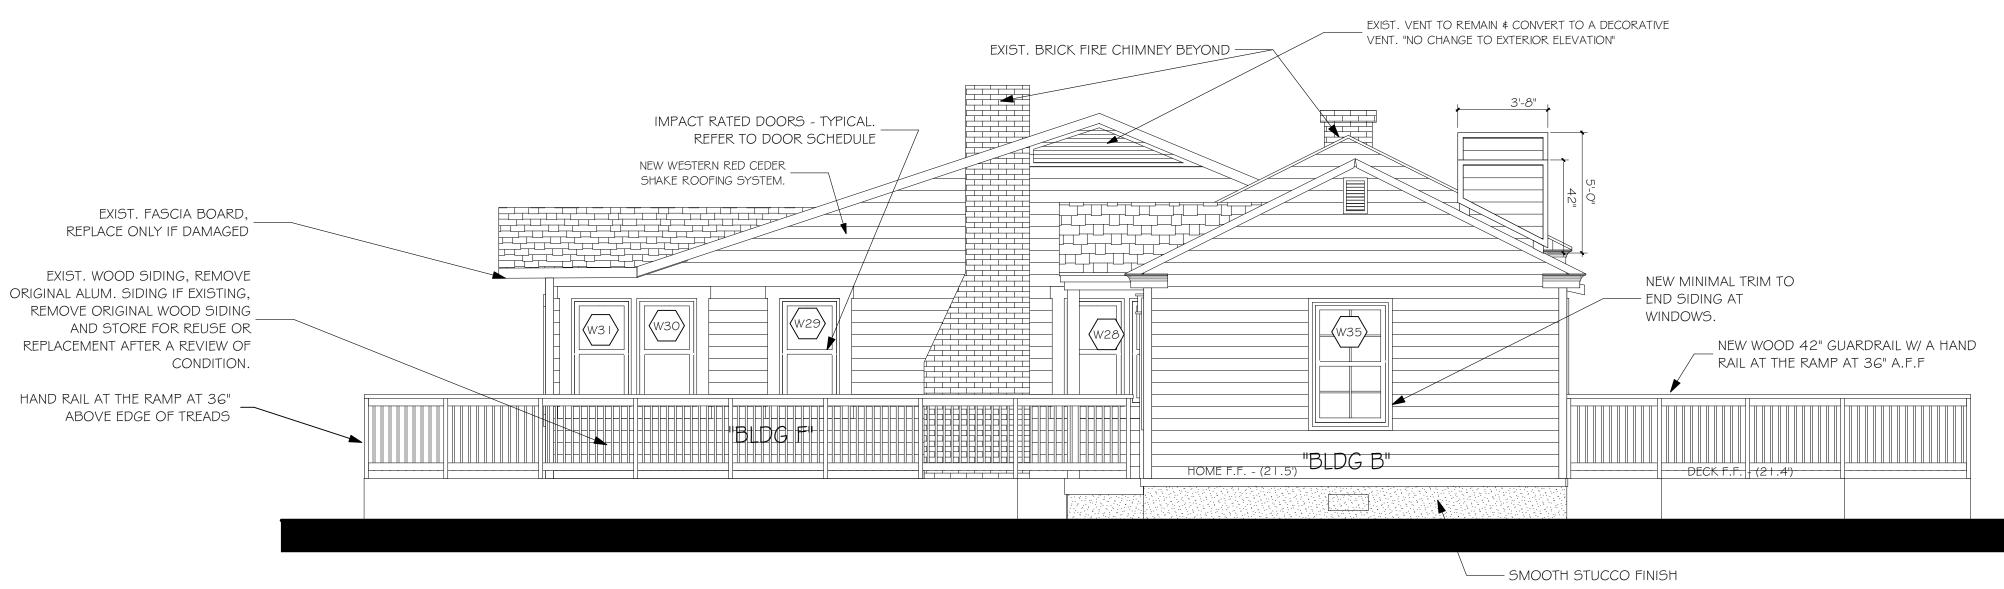

(RIGHT SIDE ) NORTH ELEVATION SCALE: 1/4" = 1'-0"

	EXISTING WOOD ATTIC VENT TO BE CONVERTED INTO A FIXED WINDOW UNIT
	- EXISTING WOOD FASCIA TO REMAIN, TYP.
	- EXISTING WOOD TRIM TO REMAIN, TYP.
	EXISTING SHUTTERS TO BE REMOVED, TYP.
	<ul> <li>EXISTING WOOD, NON IMPACT WINDOWS/DOORS</li> <li>TO BE REPLACED W/ NEW IMPACT RESISTANT</li> <li>ALUM. WINDOWS &amp; DOOR, TYP.</li> </ul>
	- EXISTING WOOD RAILING SYSTEM TO BE REMOVED
0' NAVD) FIN, FLR,	- EXISTING FINISH GRADE TO REMAIN
55' NAVD)	

STEVE SIEBERT         ARCHITECTURE         D10 GATEWAY BLVD, SUIT 103         BOYNTON BEACH, FL 33426         PH. 561.880.7894         Steve@stevesiebert.com
SEAL SEAL STEVEN W. SIEBERT FLORIDA AR0017834 NEW JERSEY 21AI01517500 TEXAS 26934
COA APPLICATION SUNDY VILLAGE BLOCK 61 22-44 W. ATLANTIC AVE. DELRAY BEACH, FLORIDA 33444
COA APPLICATION
THE WRITTEN DIMENSIONS ON THESE DRAWINGS SHALL TAKE PRECEDENCE OVER SCALED DIMENSIONS. THE CONTRACTOR SHALL VERIFY AND BE RESPONSIBLE FOR ALL DIMENSIONS AND CONDITIONS ON THE JOB, AND THIS OFFICE MUST BE NOTIFIED OF ANY VARIATION FROM THE DIMENSIONS. COPYRIGHT STEVE SIEBERT ARCHITECTURE-UNAUTHORIZED REPRODUCTION OR ANY OTHER USE OF THIS DRAWING IS PROHIBITED. PROJECT NO: 23-534 DATE: 7.1.2024 DRAWN BY: SK/BT CHECKED BY: S.S. REVISIONS:
BUILDING B&F ELEVATIONS $BF-2.4$

NOTES:


- ALL ADA RAMPS WILL HAVE WOOD GUARDRAILS, UNLESS NOTED AS HANDRAIL ONLY. - REMOVED ALUMINUM SIDING AND DISCARD
- REMOVED ORIGINAL WOOD SIDING, CHECK FOR ANY DAMAGE AND REUSE. DISCARD ANY DAMAGED SIDING AND REPLACE WITH MATCHING PROFILE IN WOOD.

PROVE EXT-PLYWOOD SHEATHING AND BACKING ON ORIGINAL STUDS AFTER REMOVAL OF SIDING. KEEP ANY ORIGINAL ANGELED BRACING.

- KEEP AND REPLACE ANY ORIGINAL TRIM WOOD AS MUCH AS POSSIBLE, ANY DAMAGED TO BE NEW AND MATCH EXISTING IN WOOD.

- ANY SCREENING TO MATCH STYLE, COLOR AND SIDING OF THE EXISTING HOME

- WOOD SIDING TO BE REPLACED" INSTEAD OF "NEW SIDING". IF THERE ARE ANY OTHER - ELEMENTS THAT CURRENTLY EXIST. ON THE STRUCTURE THAT IS BEING REPLACED WITH THE SAME MATERIAL.

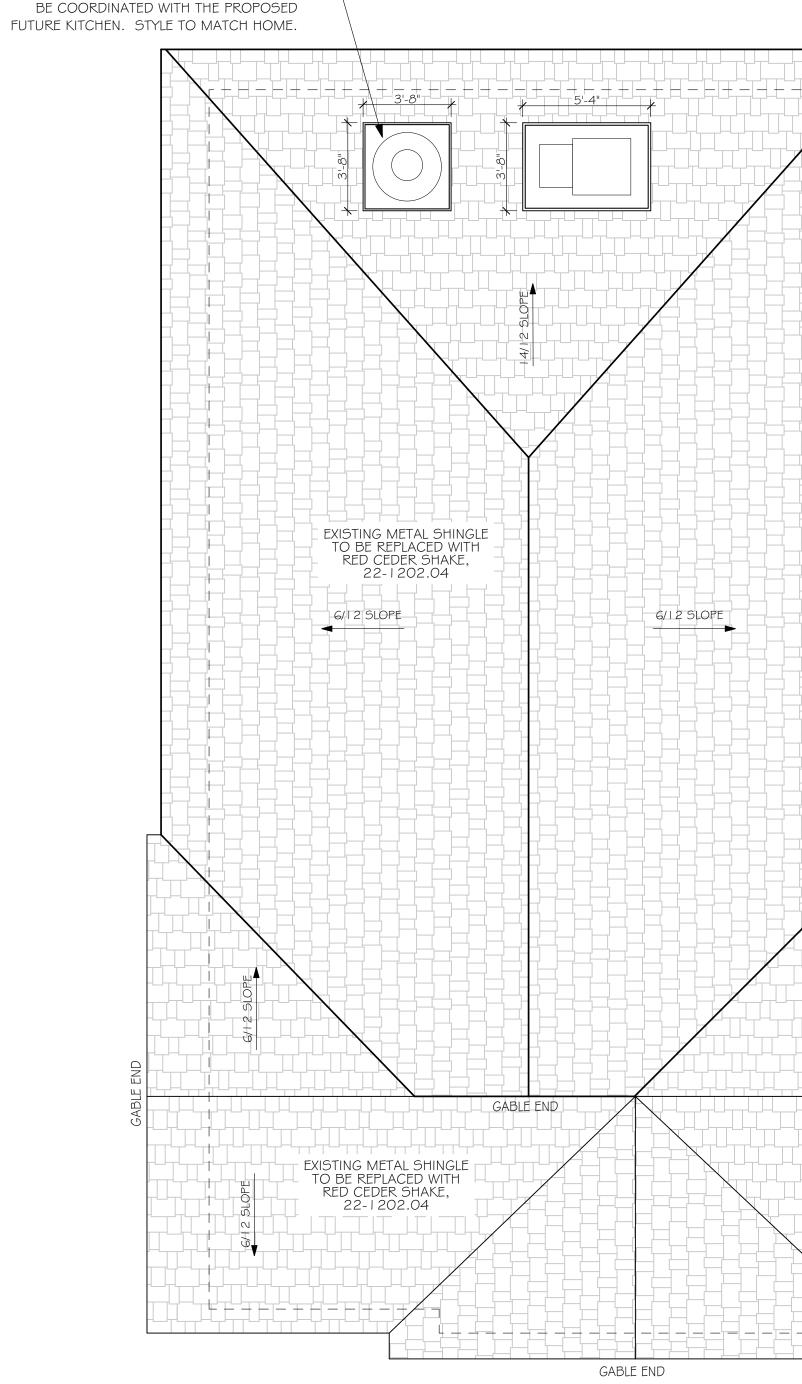


SCREENING FOR VENTING IF TENANT IS A

RESTAURANT. SEE DETAILS ON SHEET

CS.2. FINAL SCREENING LOCATION SHALL -----

NOTE:



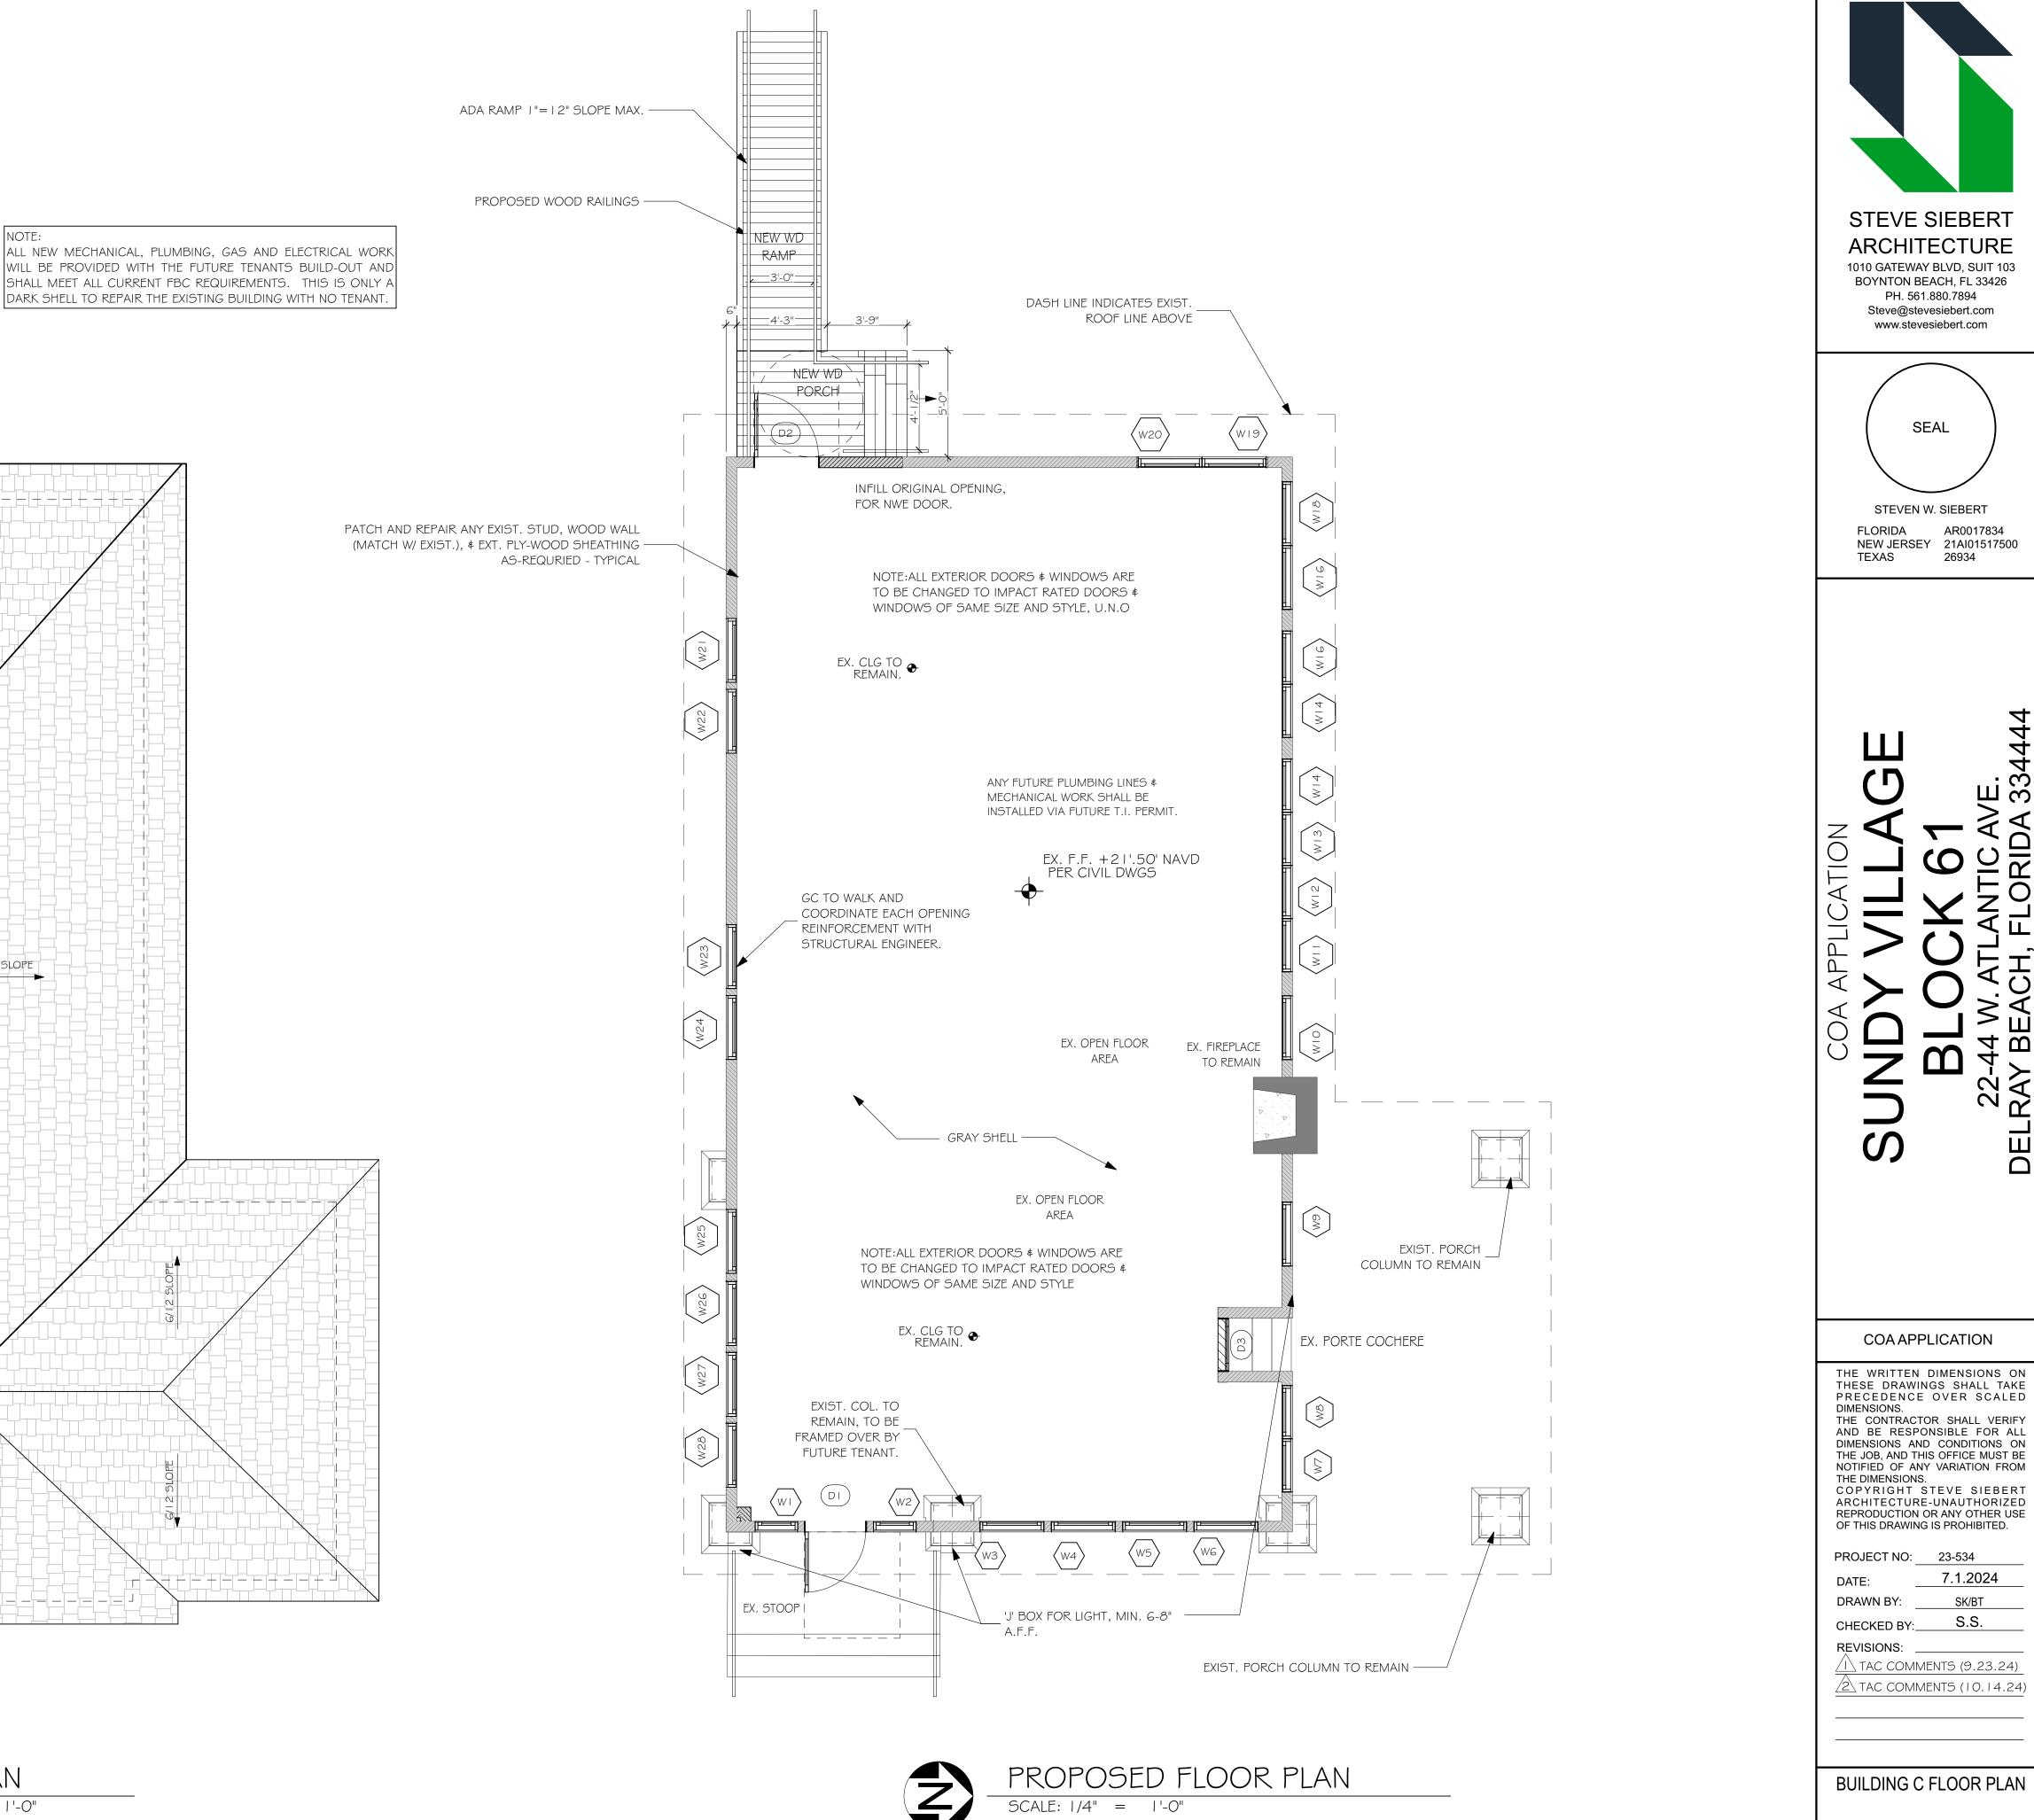

Z

C-3.0

SK/BT

S.S.

4

3

RIDA


AC

Ш 4 <u></u>

22-4 DELRAY

၂ က




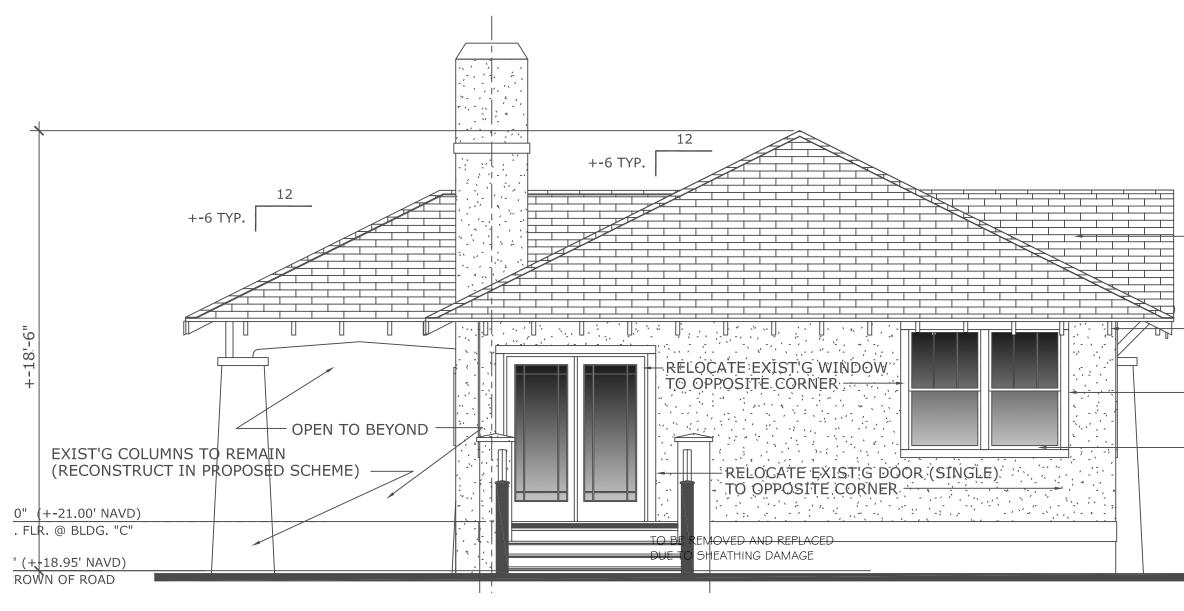



EXISTING WEST ELEVATION SCALE: |' = |'-O''


NOTES:
- ALL ADA RAMPS WILL HAVE WOOD GUARDRAILS, UNLESS NOTED AS HANDRAIL ONLY.
- REMOVED ALUMINUM SIDING AND DISCARD
- REMOVED ORIGINAL STUCCO FINISH AND SUBSTRATE DUE TO DAMAGED WATER PROOFING
AND SHEATHING.
- PROVE EXT-PLYWOOD SHEATHING AND BACKING ON ORIGINAL STUDS AFTER REMOVAL OF
STUCCO.
- KEEP AND REPLACE ANY ORIGINAL TRIM WOOD AS MUCH AS POSSIBLE, ANY DAMAGED TO BE
NEW AND MATCH EXISTING IN WOOD.
- ANY SCREENING TO MATCH STYLE, COLOR AND SIDING OF THE EXISTING HOME.
- WOOD SIDING TO BE REPLACED" INSTEAD OF "NEW SIDING". IF THERE ARE ANY OTHER
- ELEMENTS THAT CURRENTLY EXIST. ON THE STRUCTURE THAT IS BEING REPLACED WITH THE
SAME MATERIAL.



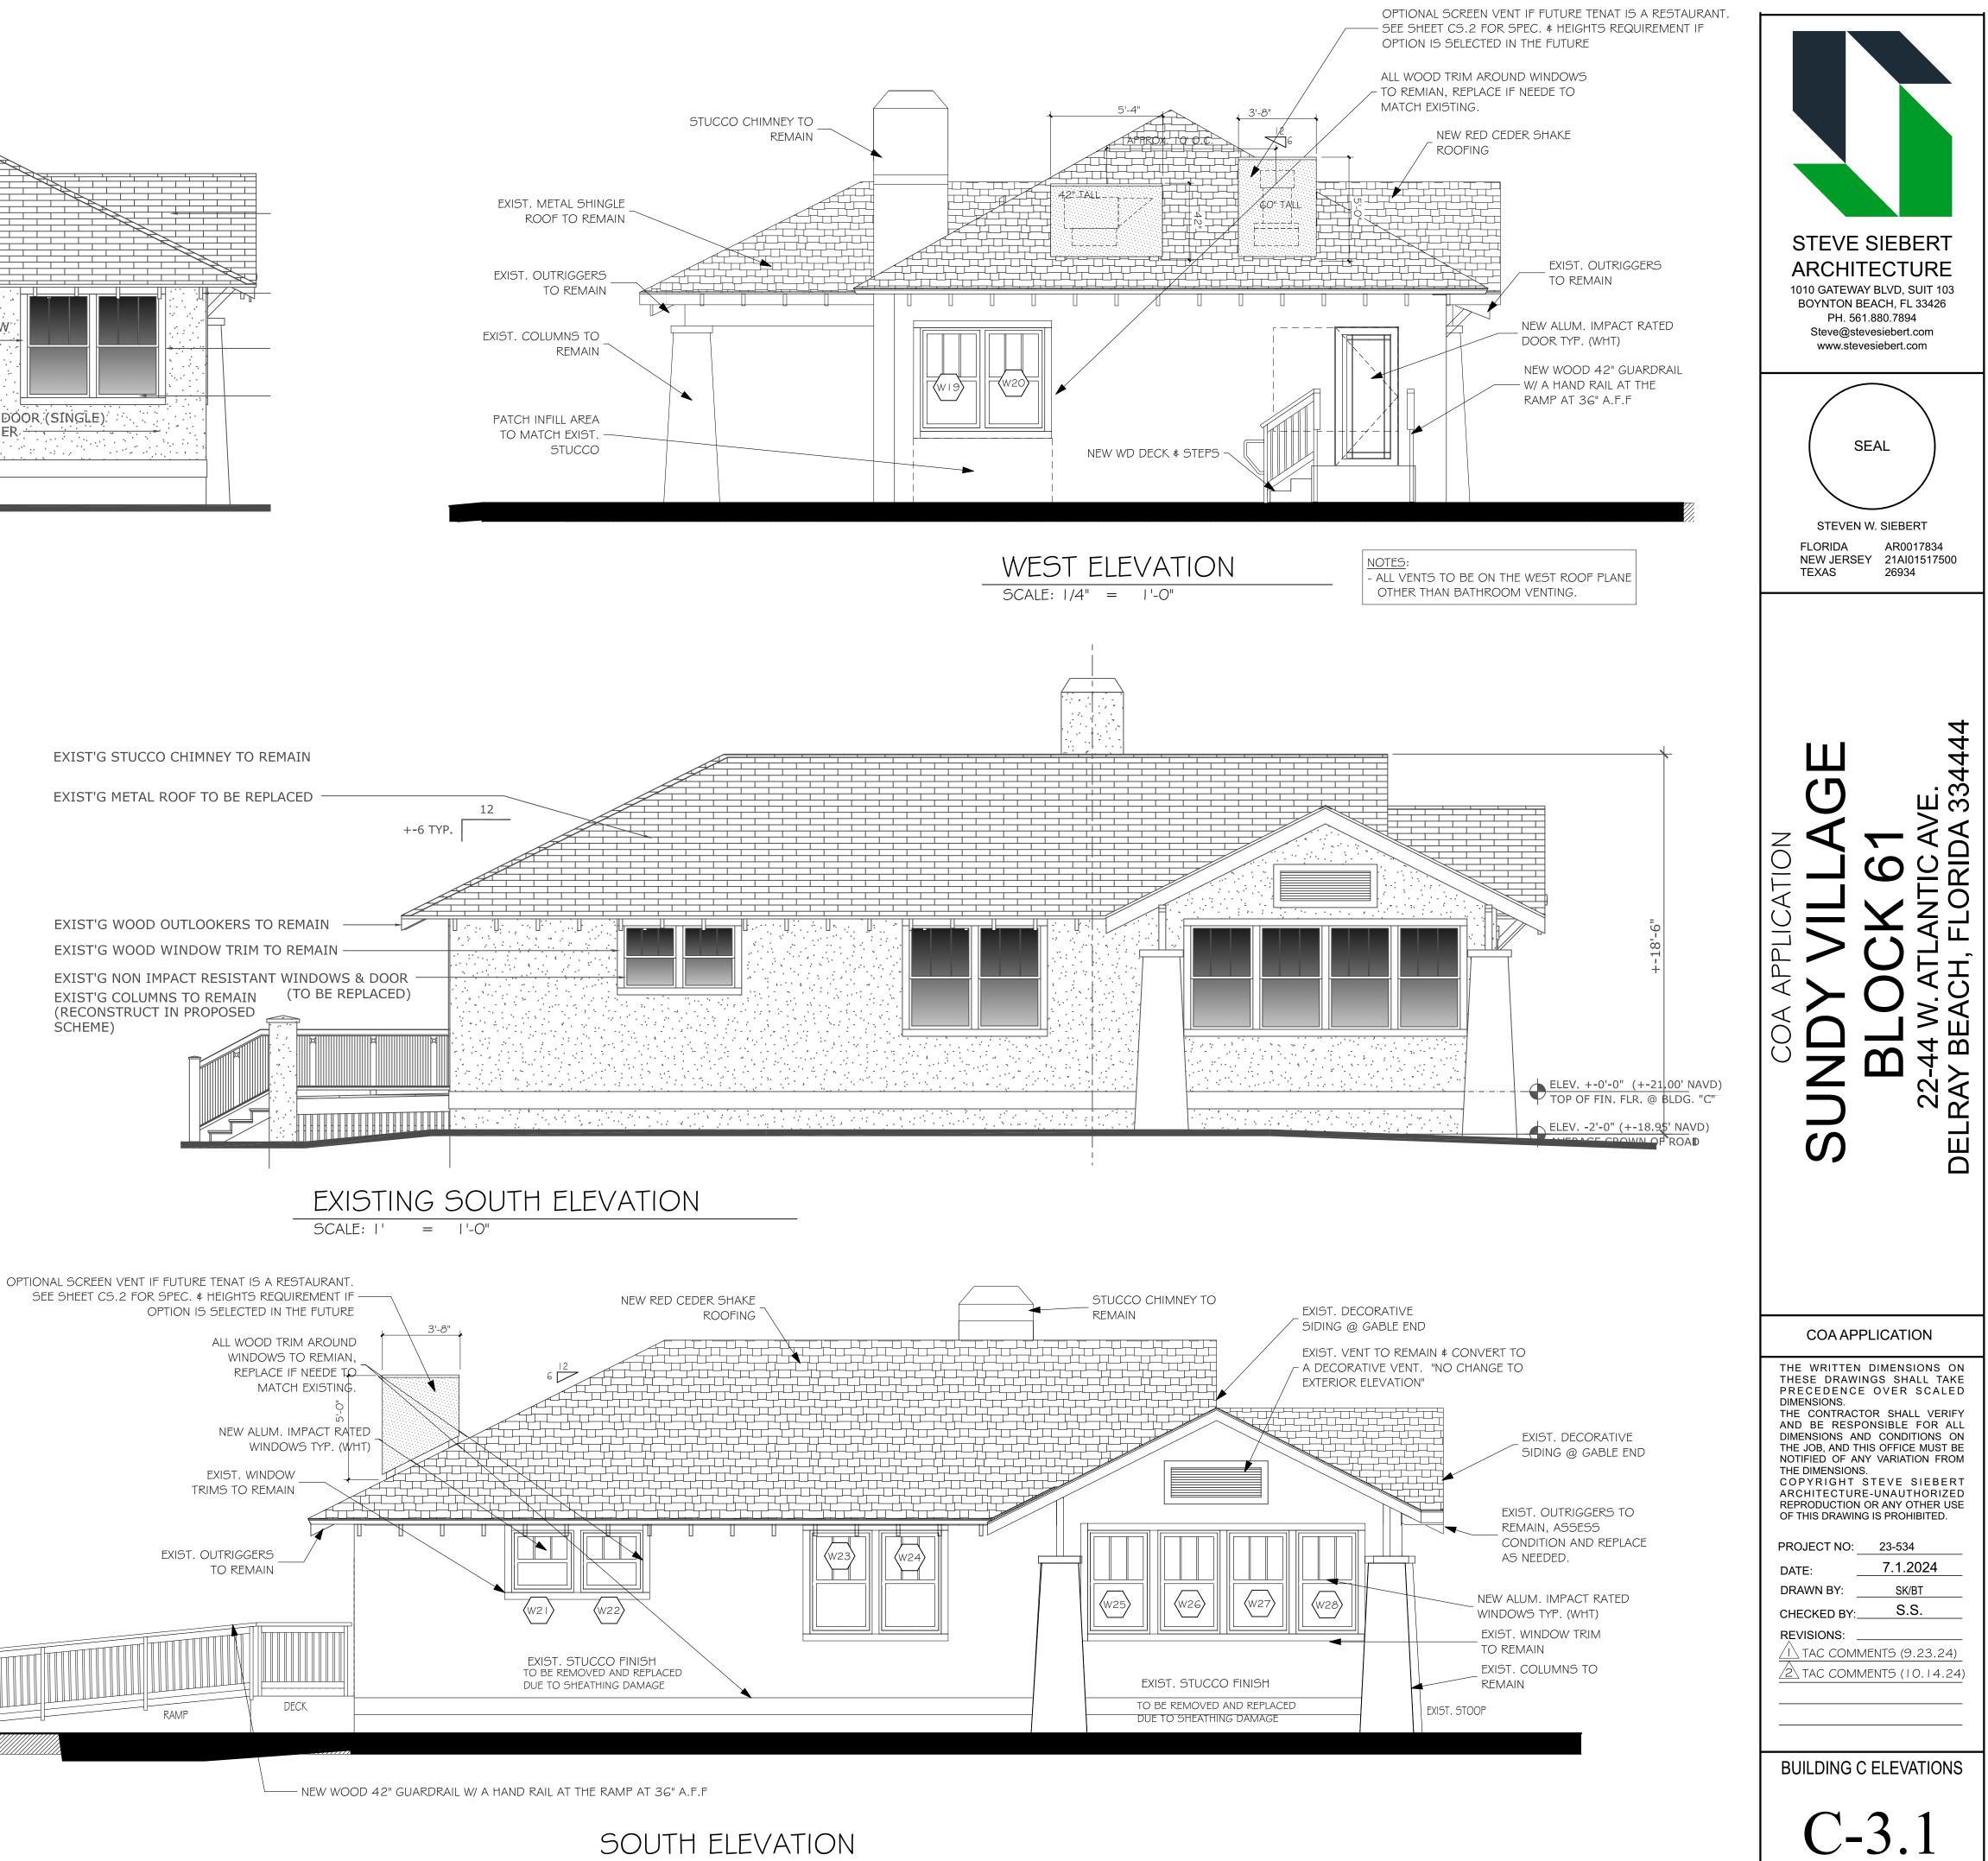

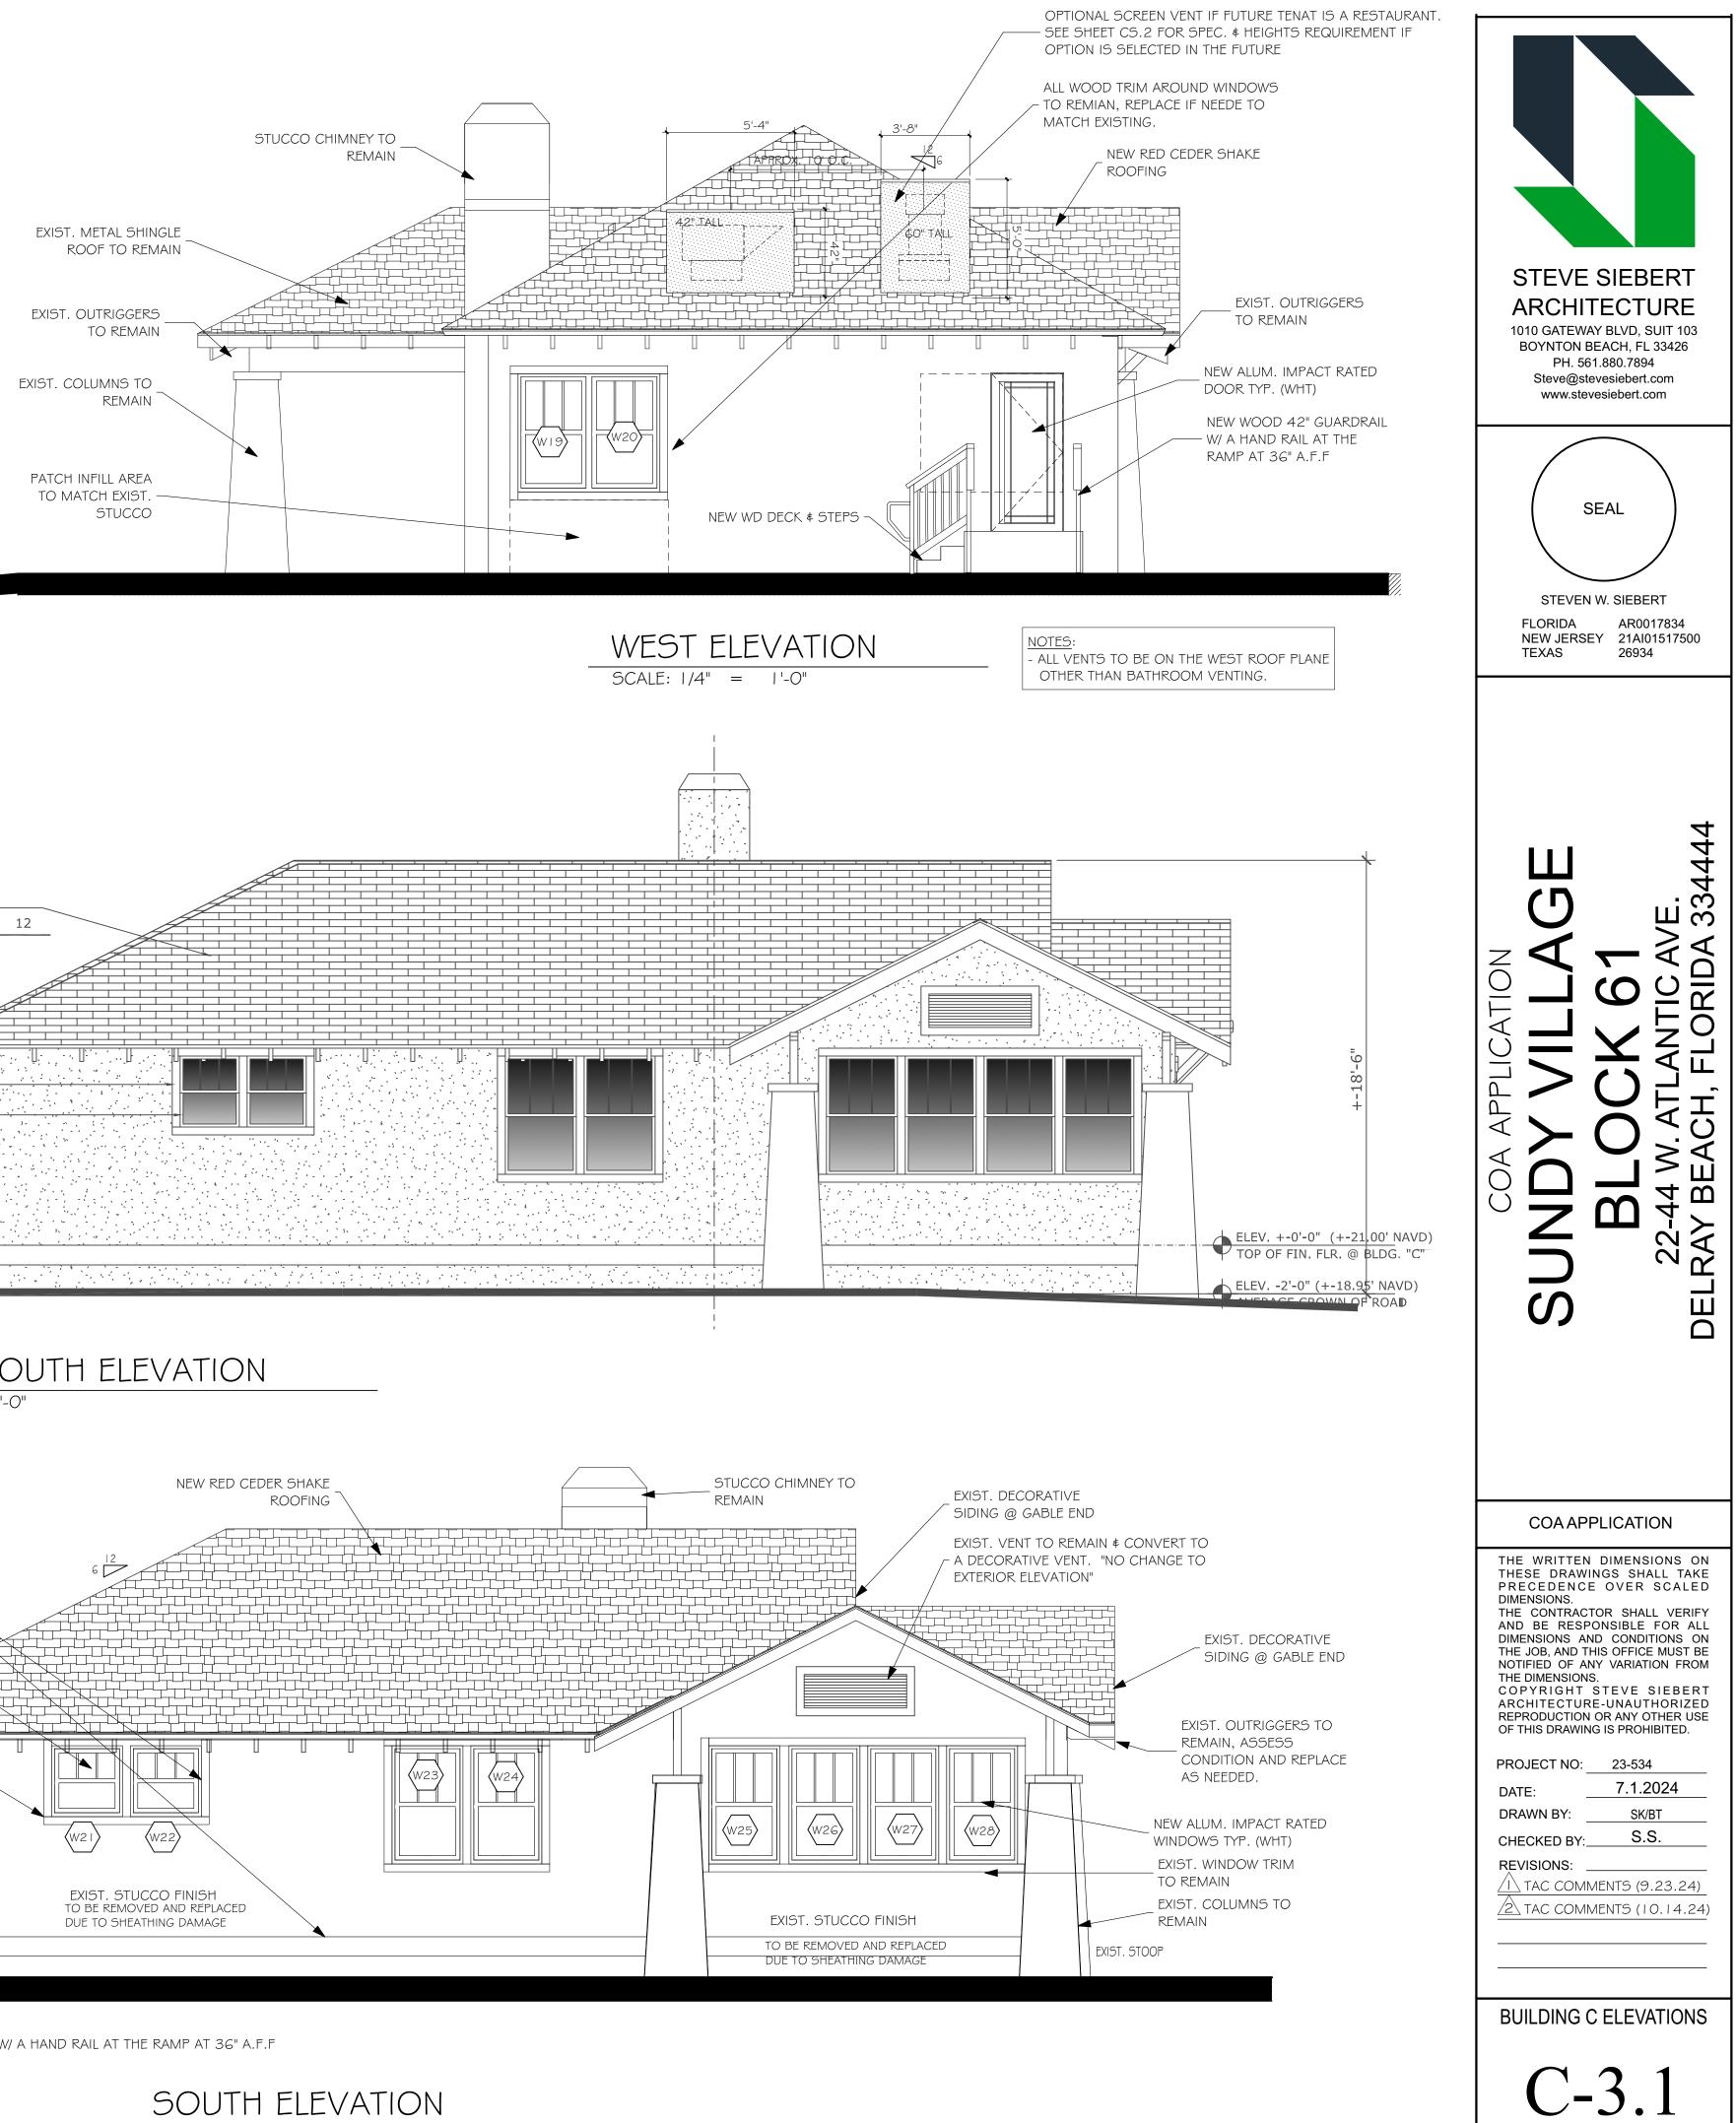

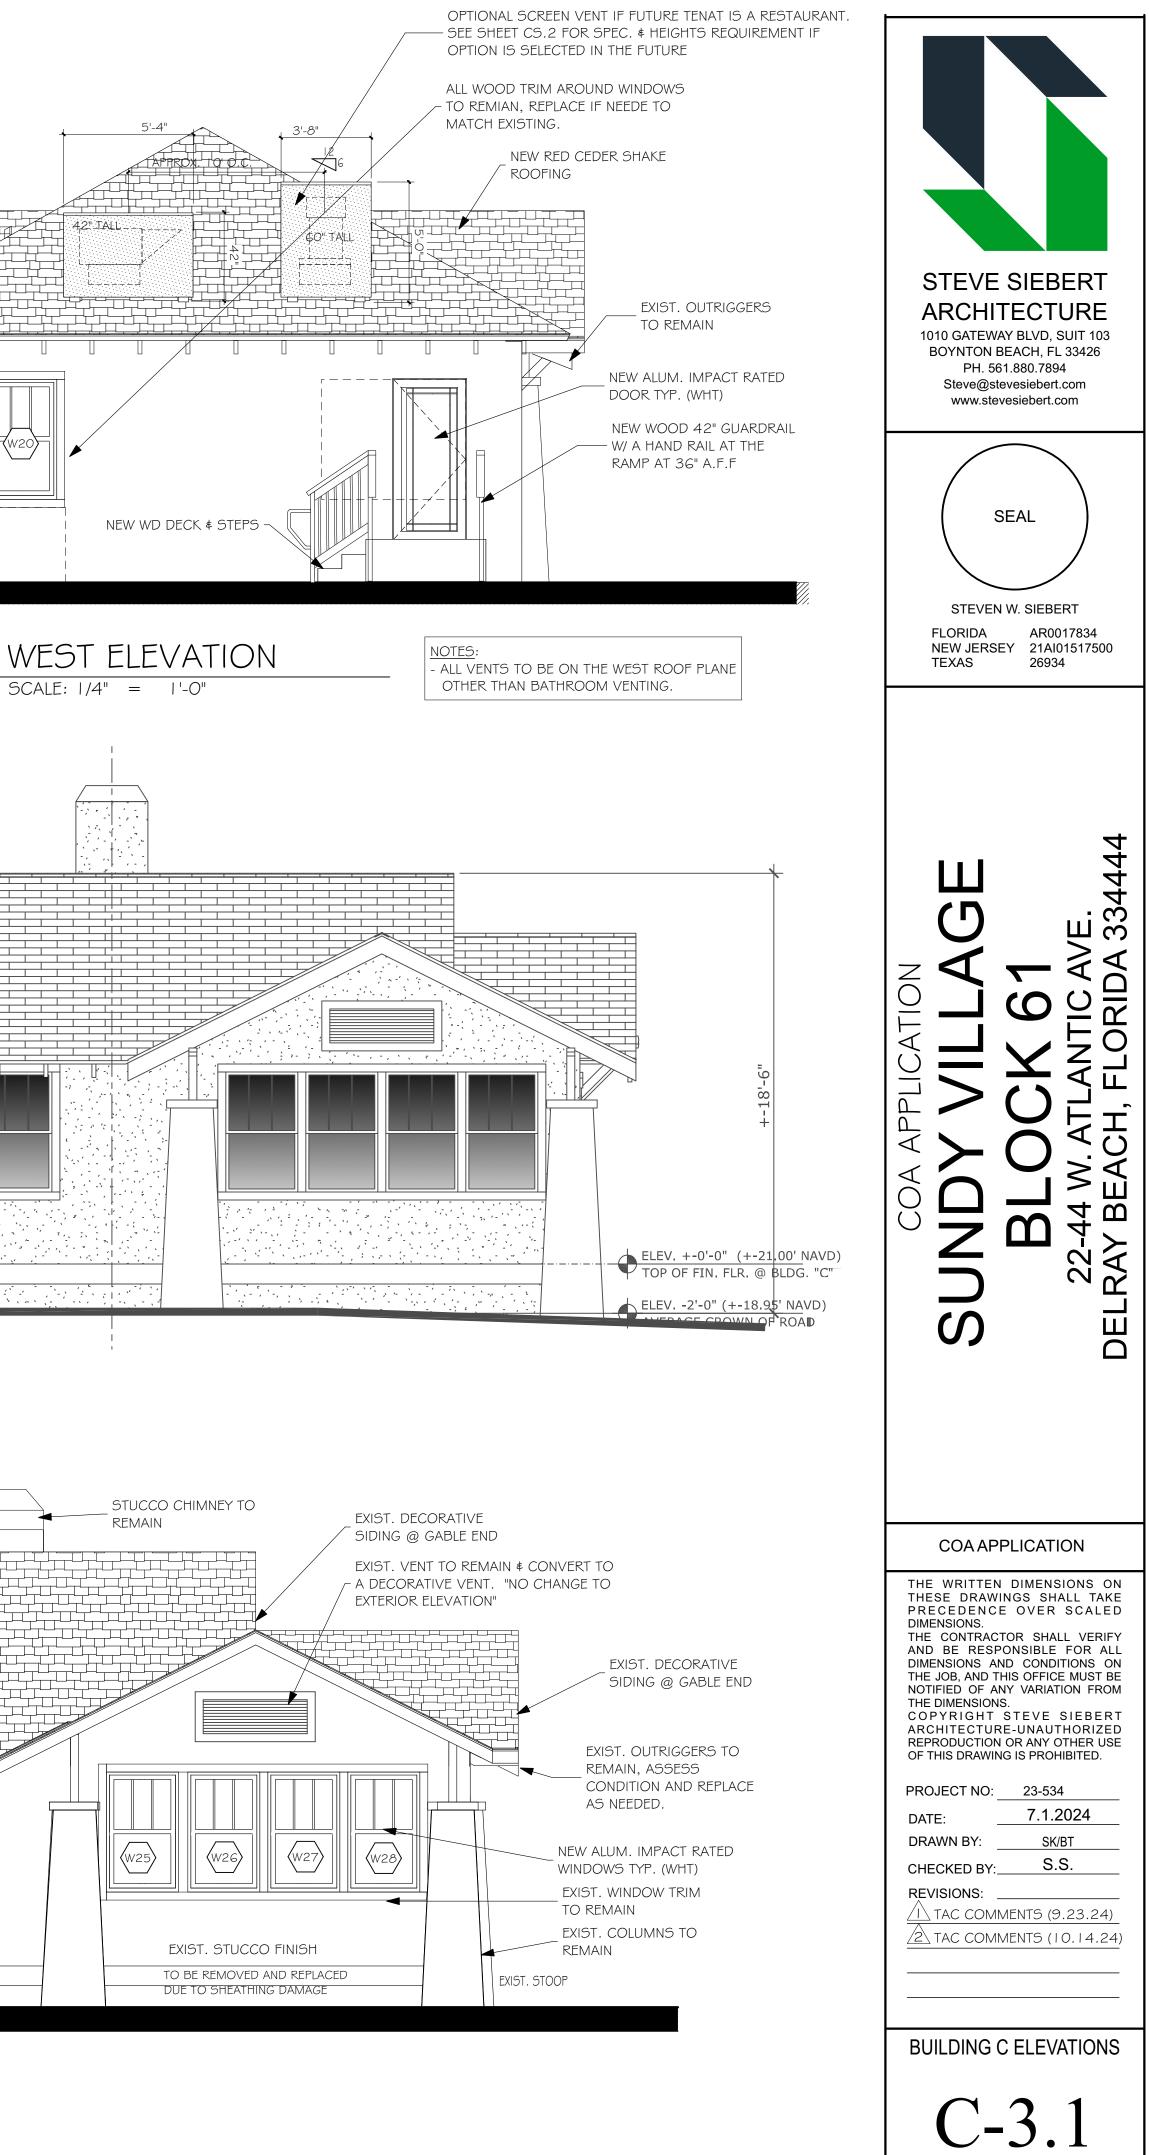


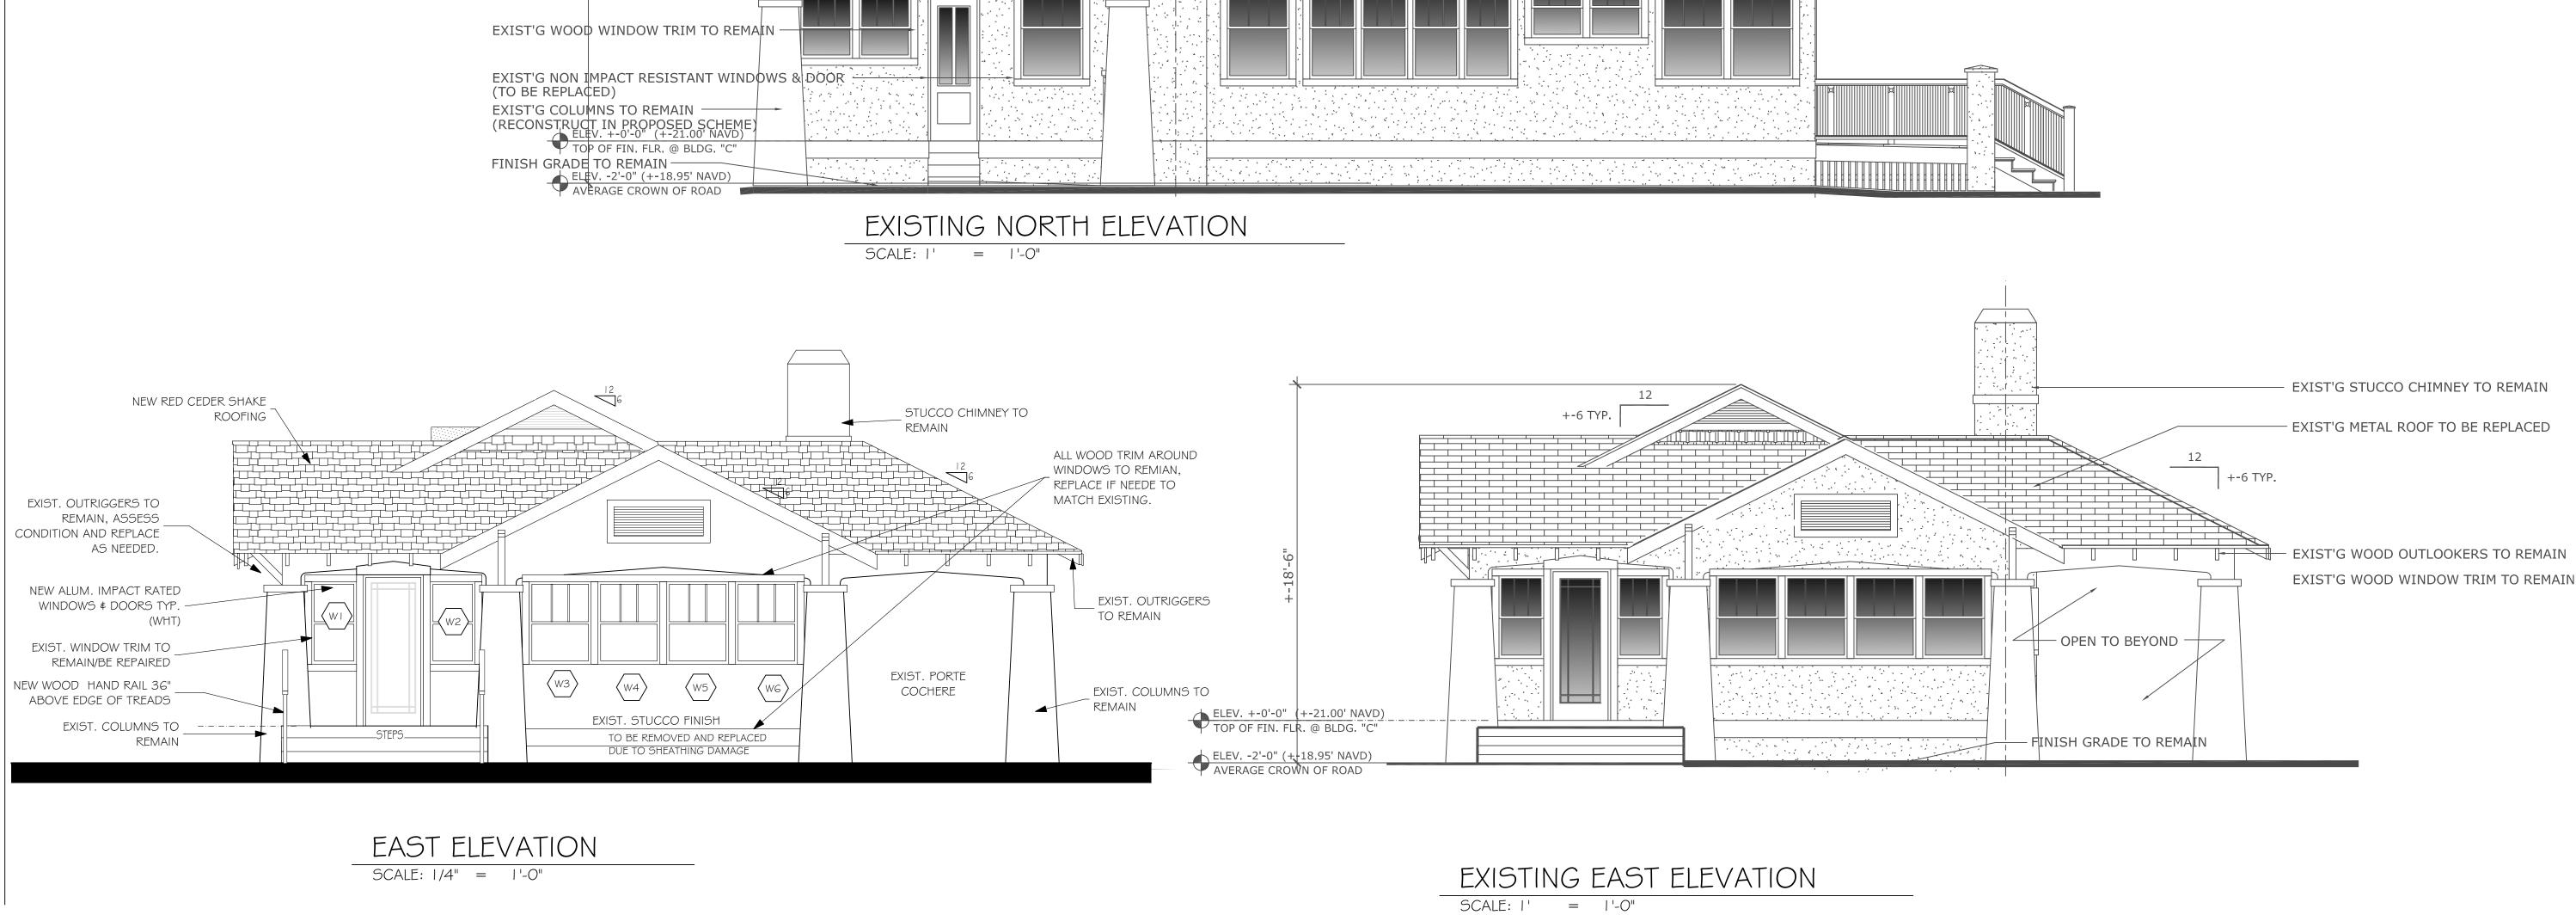




EXIST'G METAL ROOF TO BE REPLACED

EXIST'G WOOD OUTLOOKERS TO REMAIN

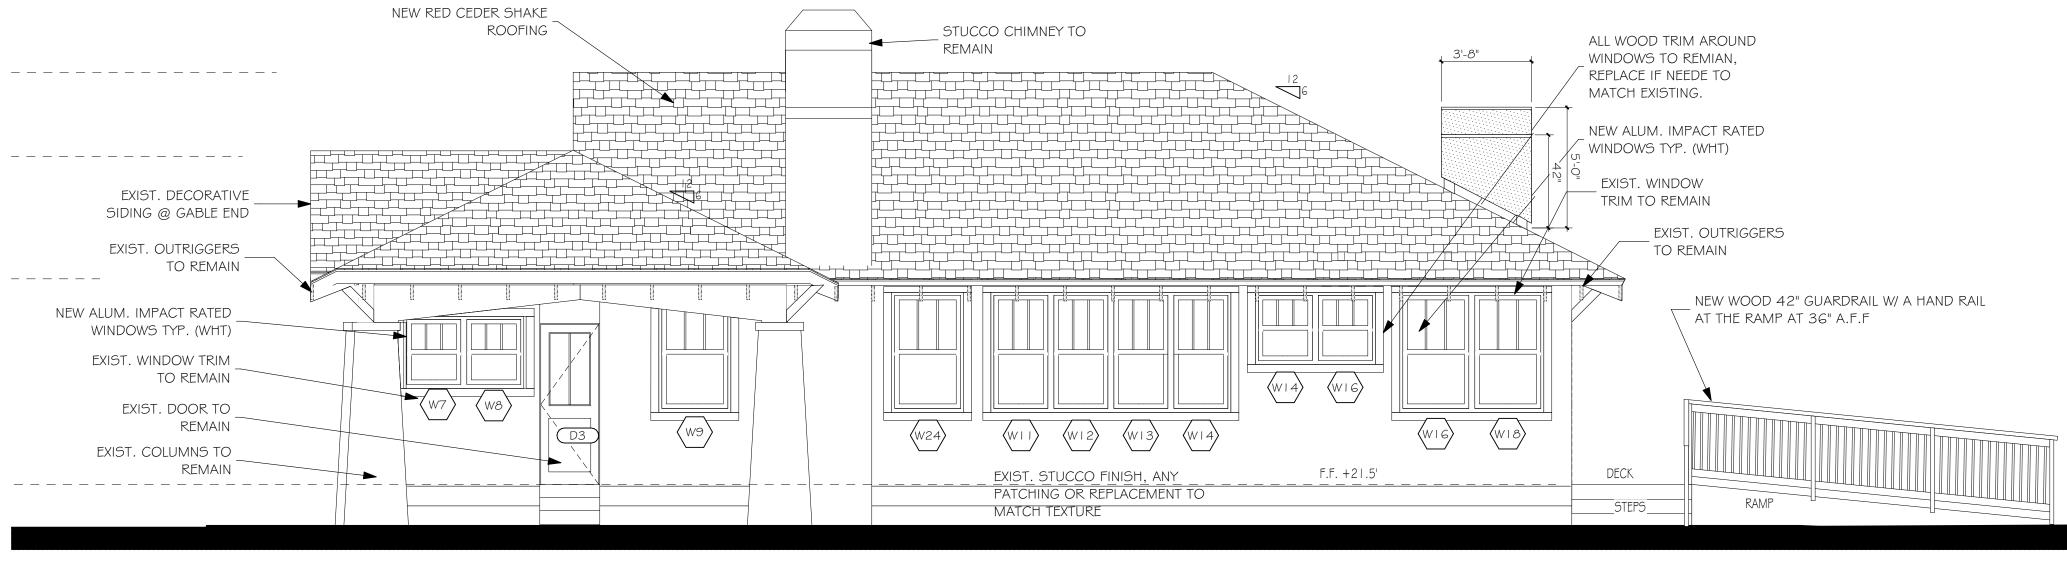





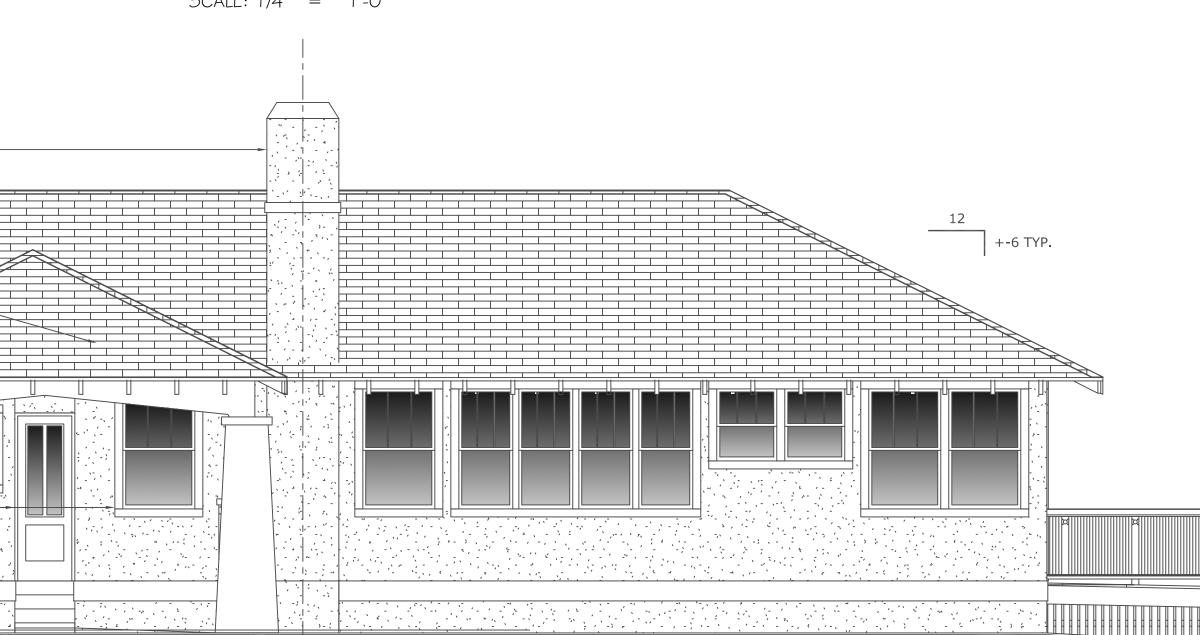



- ()

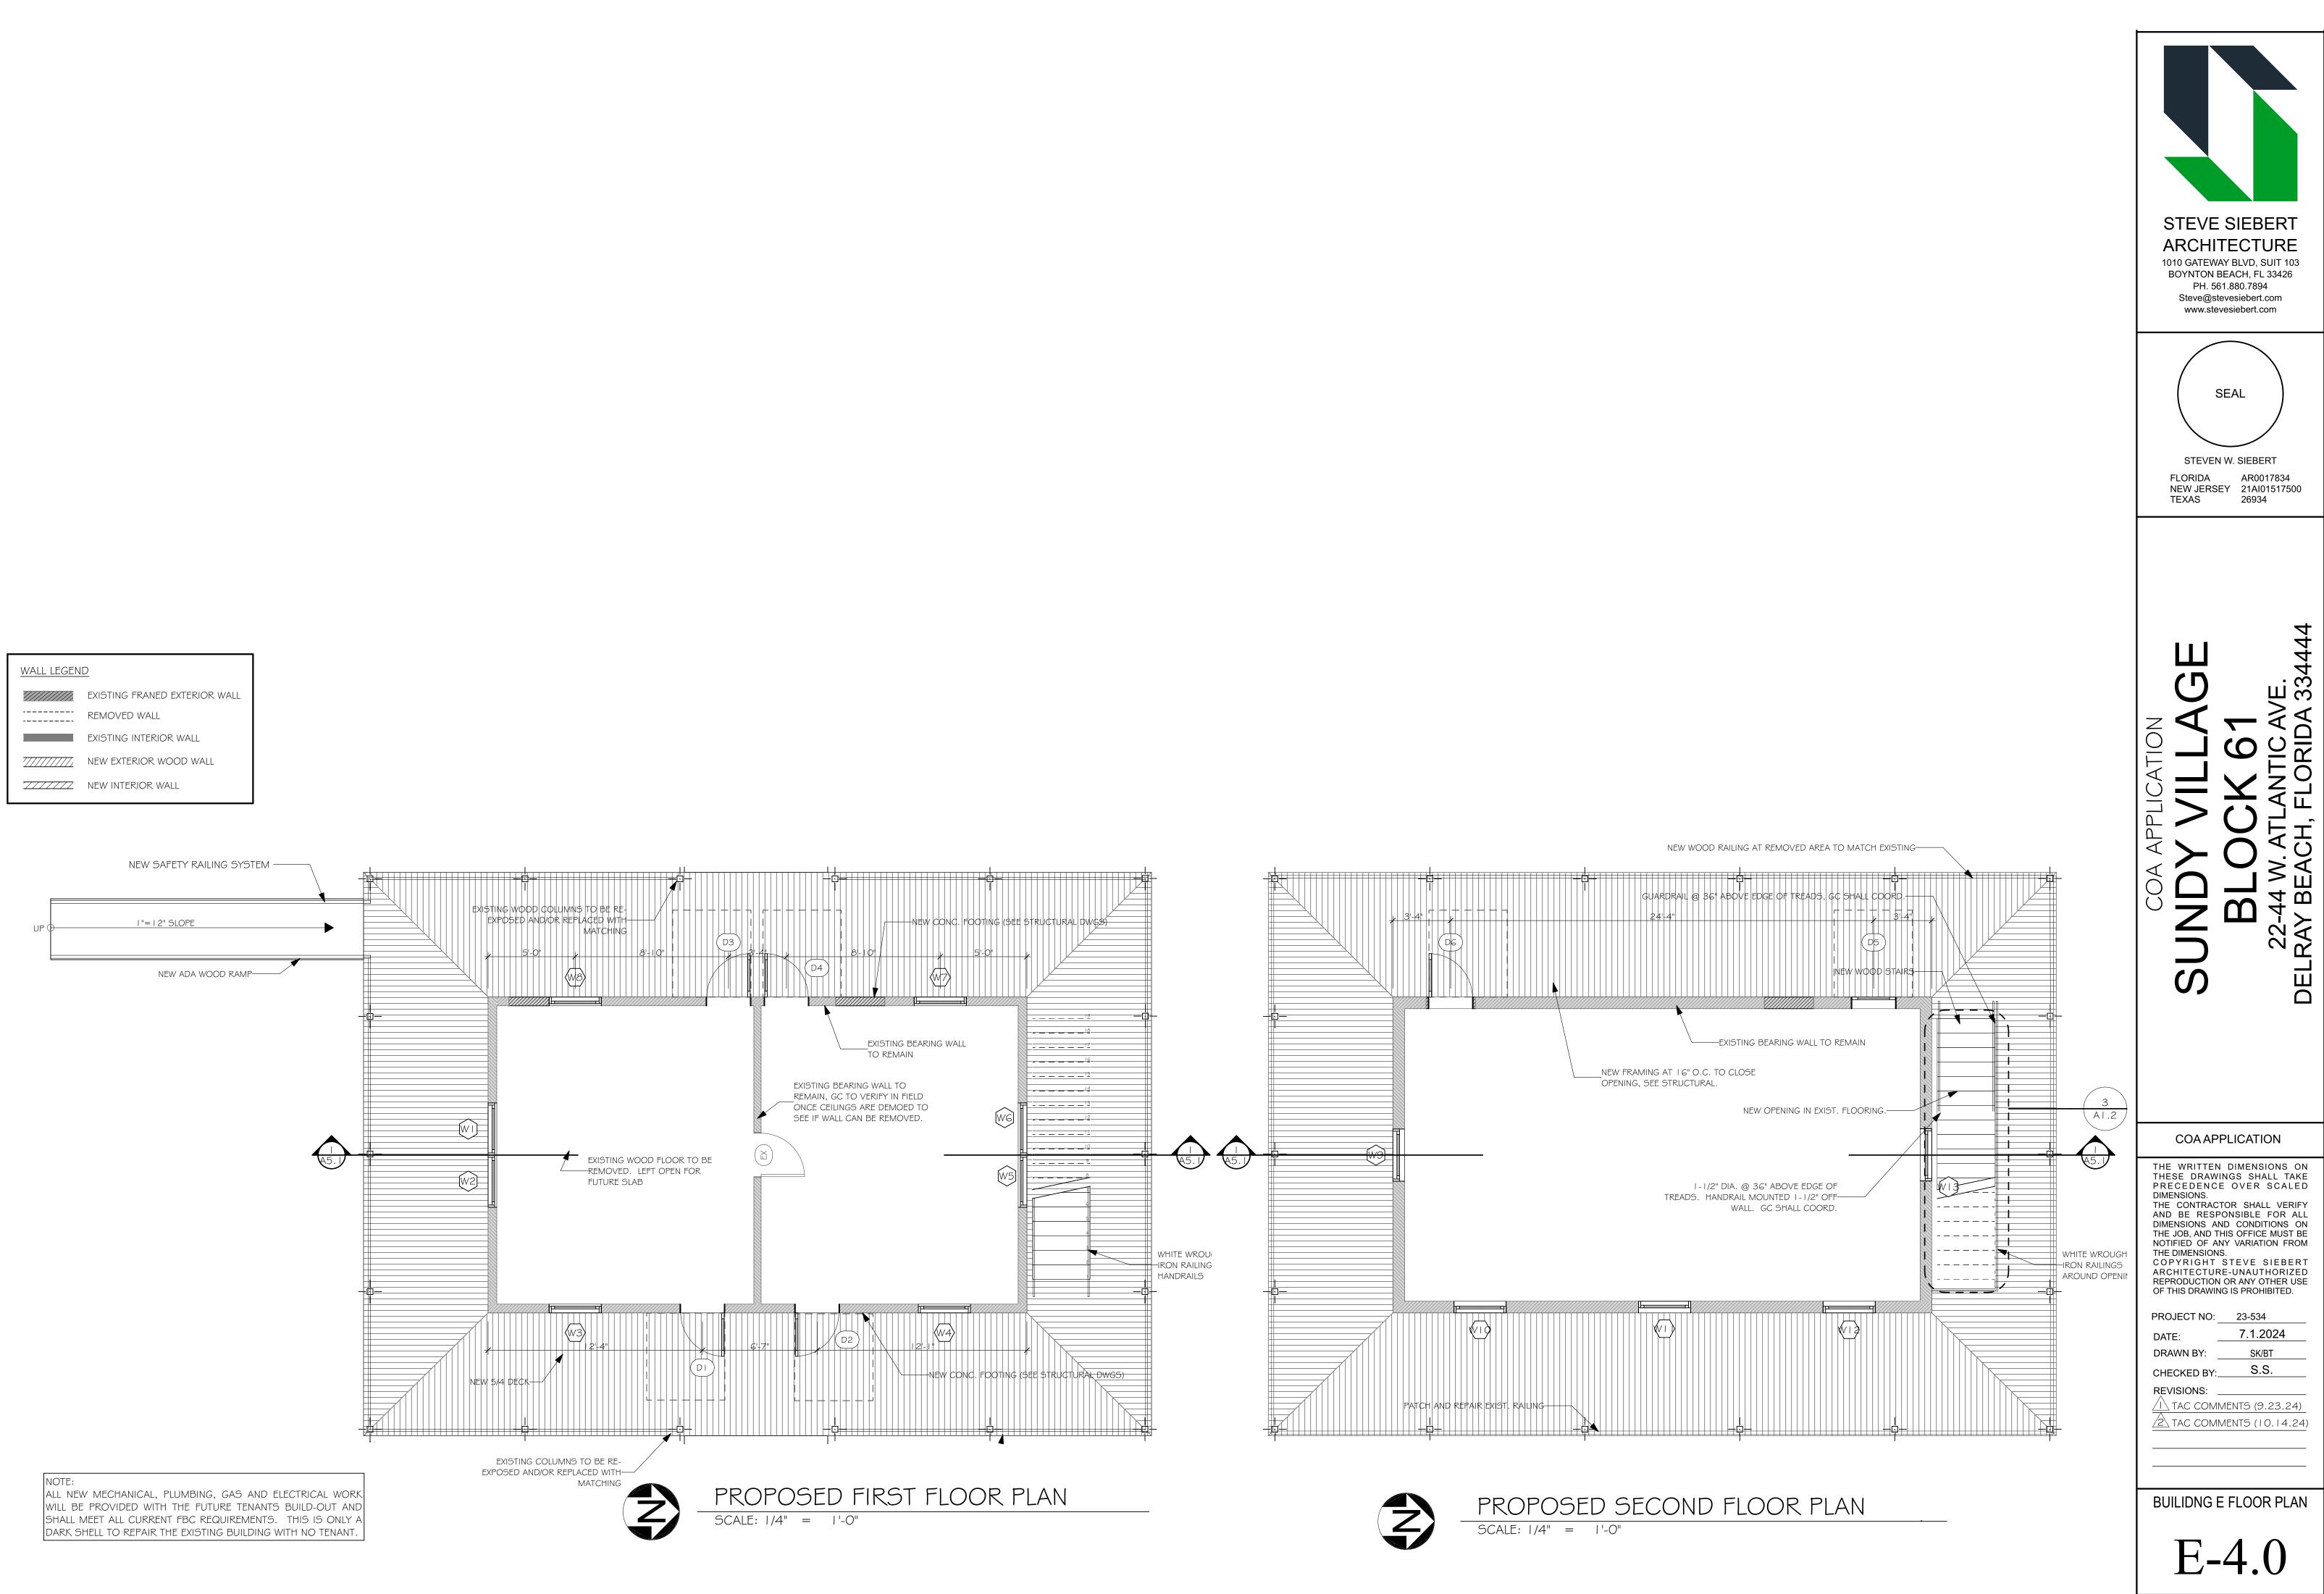


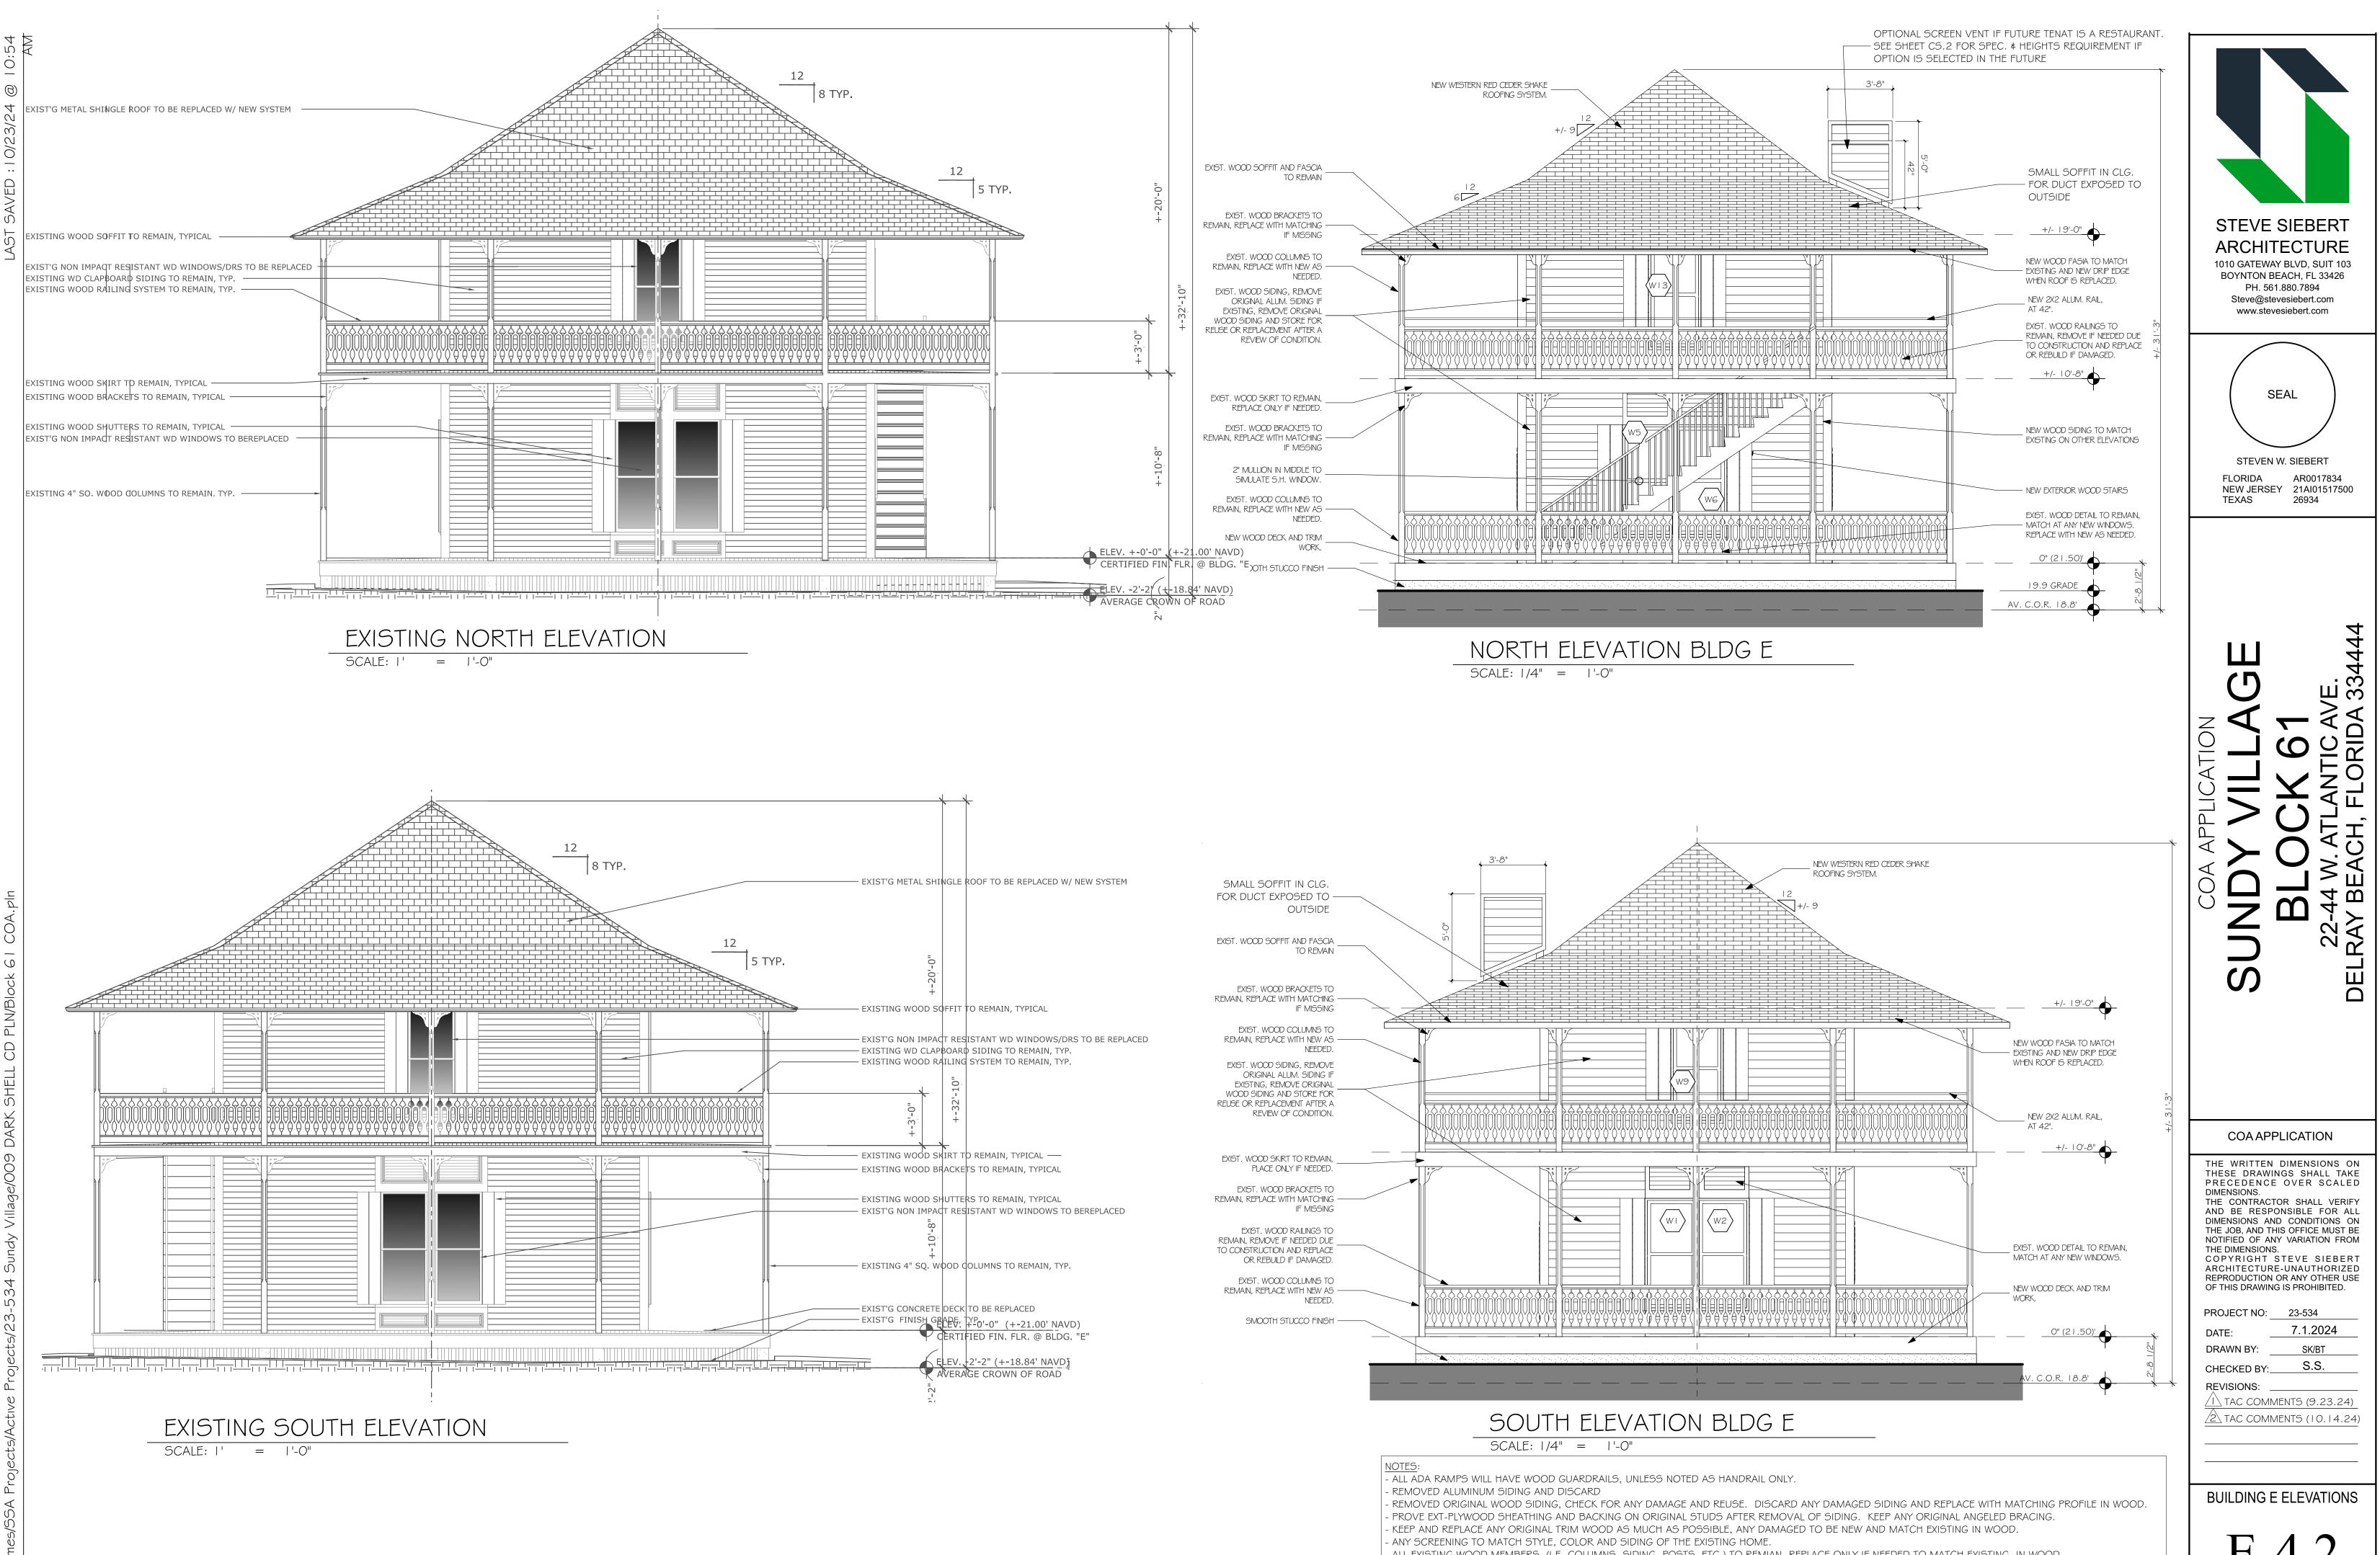

- ALL EXISTING WOOD MEMBERS, (I.E. COLUMNS, SIDING, POSTS, ETC.) TO REMIAN, REPLACE ONLY IF NEEDED TO MATCH EXISTING, IN WOOD.

- WOOD SIDING TO BE REPLACED" INSTEAD OF "NEW SIDING". IF THERE ARE ANY OTHER - ELEMENTS THAT CURRENTLY EXIST. ON THE STRUCTURE THAT IS BEING REPLACED WITH THE SAME MATERIAL.



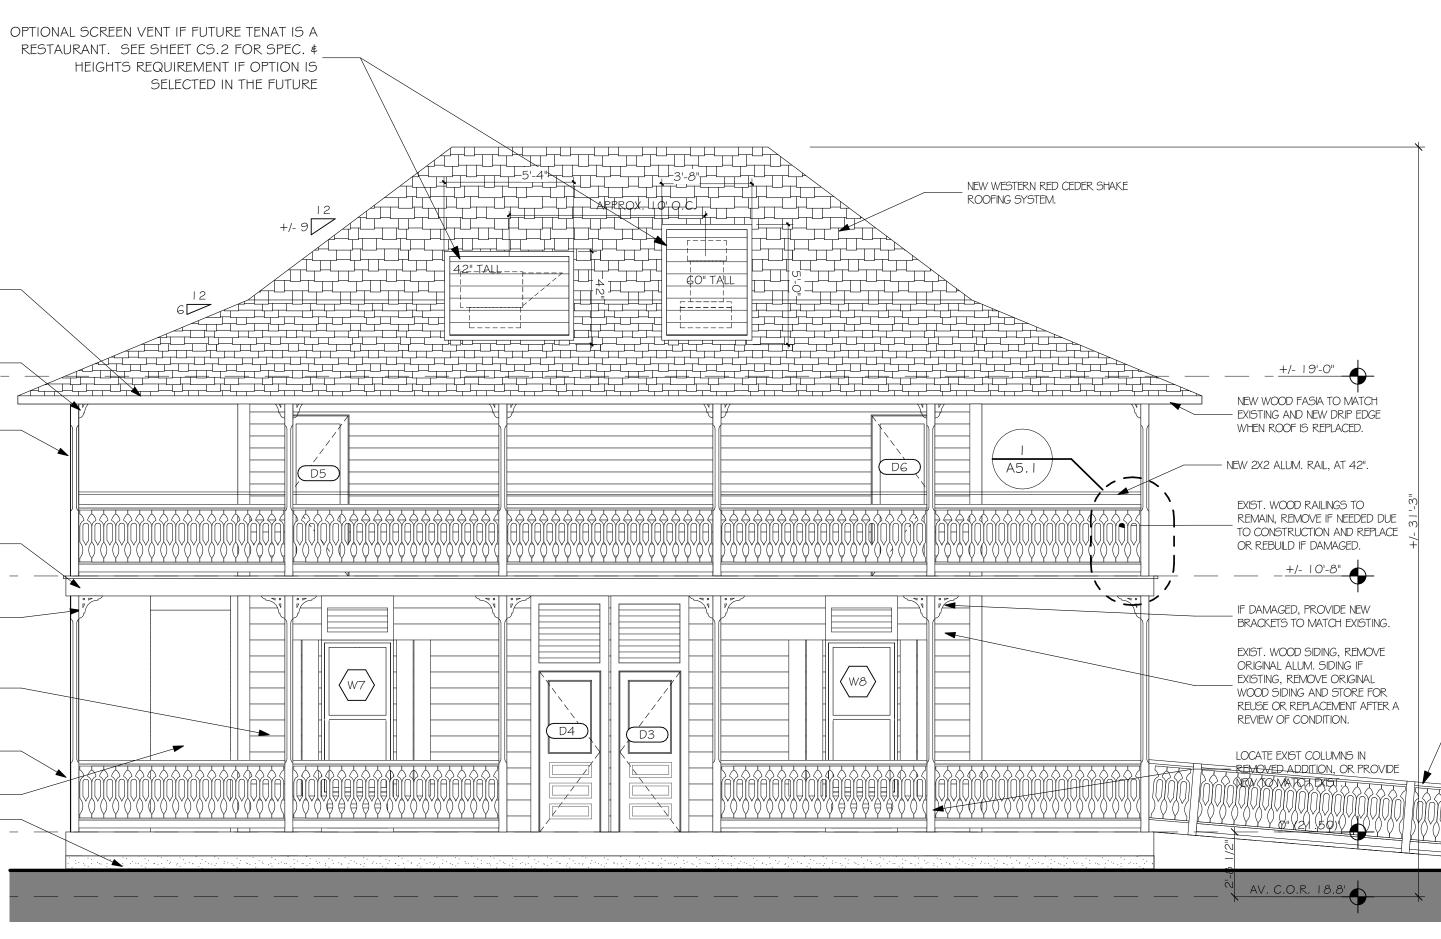

EXIST. WOOD SOFFIT AND FASCIA TO REMAIN

EXIST. WOOD BRACKETS TO REMAIN, REPLACE WITH MATCHING — IF MISSING

EXIST. WOOD SKIRT TO REMAIN, PLACE ONLY IF NEEDED.

EXIST. WOOD BRACKETS TO REMAIN, REPLACE WITH MATCHING -IF MISSING

NEW WOOD SHUTTERS TO MATCH EXISTING

EXIST. WOOD COLUMNS TO REMAIN, REPLACE WITH NEW AS — NEEDED.

> NEW WOOD STAIRS -SMOOTH STUCCO FINISH —


> > SCALE: 1/4" = 1'-0"


WEST ELEVATION BLDG E


NOTES: - ALL VENTS TO BE ON THE WEST ROOF PLANE OTHER THAN BATHROOM VENTING.

STEVE SIEBE ARCHITECTU 1010 GATEWAY BLVD, SU BOYNTON BEACH, FL 33 PH. 561.880.7894 Steve@stevesiebert.co	RE IT 103 3426
SEAL STEVEN W. SIEBER FLORIDA AR0017 NEW JERSEY 21AI015 TEXAS 26934	7834
BLOA APP BLOY	DELRAY BEACH, FLORIDA 334444
COA APPLICATIO	N
THE WRITTEN DIMENSION THESE DRAWINGS SHAL PRECEDENCE OVER S DIMENSIONS. THE CONTRACTOR SHALL AND BE RESPONSIBLE F DIMENSIONS AND CONDITION THE JOB, AND THIS OFFICE M NOTIFIED OF ANY VARIATION THE DIMENSIONS. COPYRIGHT STEVE SI ARCHITECTURE-UNAUTHOR REPRODUCTION OR ANY OTHOF THIS DRAWING IS PROHIB PROJECT NO: 23-534 DATE: 7.1.20 DRAWN BY: SK/BT CHECKED BY: SK/BT CHECKED BY: S.S. REVISIONS:	L TAKE CALED VERIFY OR ALL DNS ON MUST BE N FROM EBERT ORIZED HER USE ITED. 24 
BUILDING E ELEVAT	TIONS
E-4.3	3

NEW WOOD 42" GUARDRAIL REQUIRED AT RAMP AND IF THERE IS - A 30" MEASURED VERTICALLY TO THE GRADE AS WELL AS A ALUMN. HAND RAIL AT THE RAMP AT 36" A.F.F

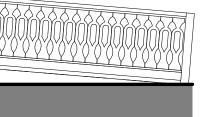

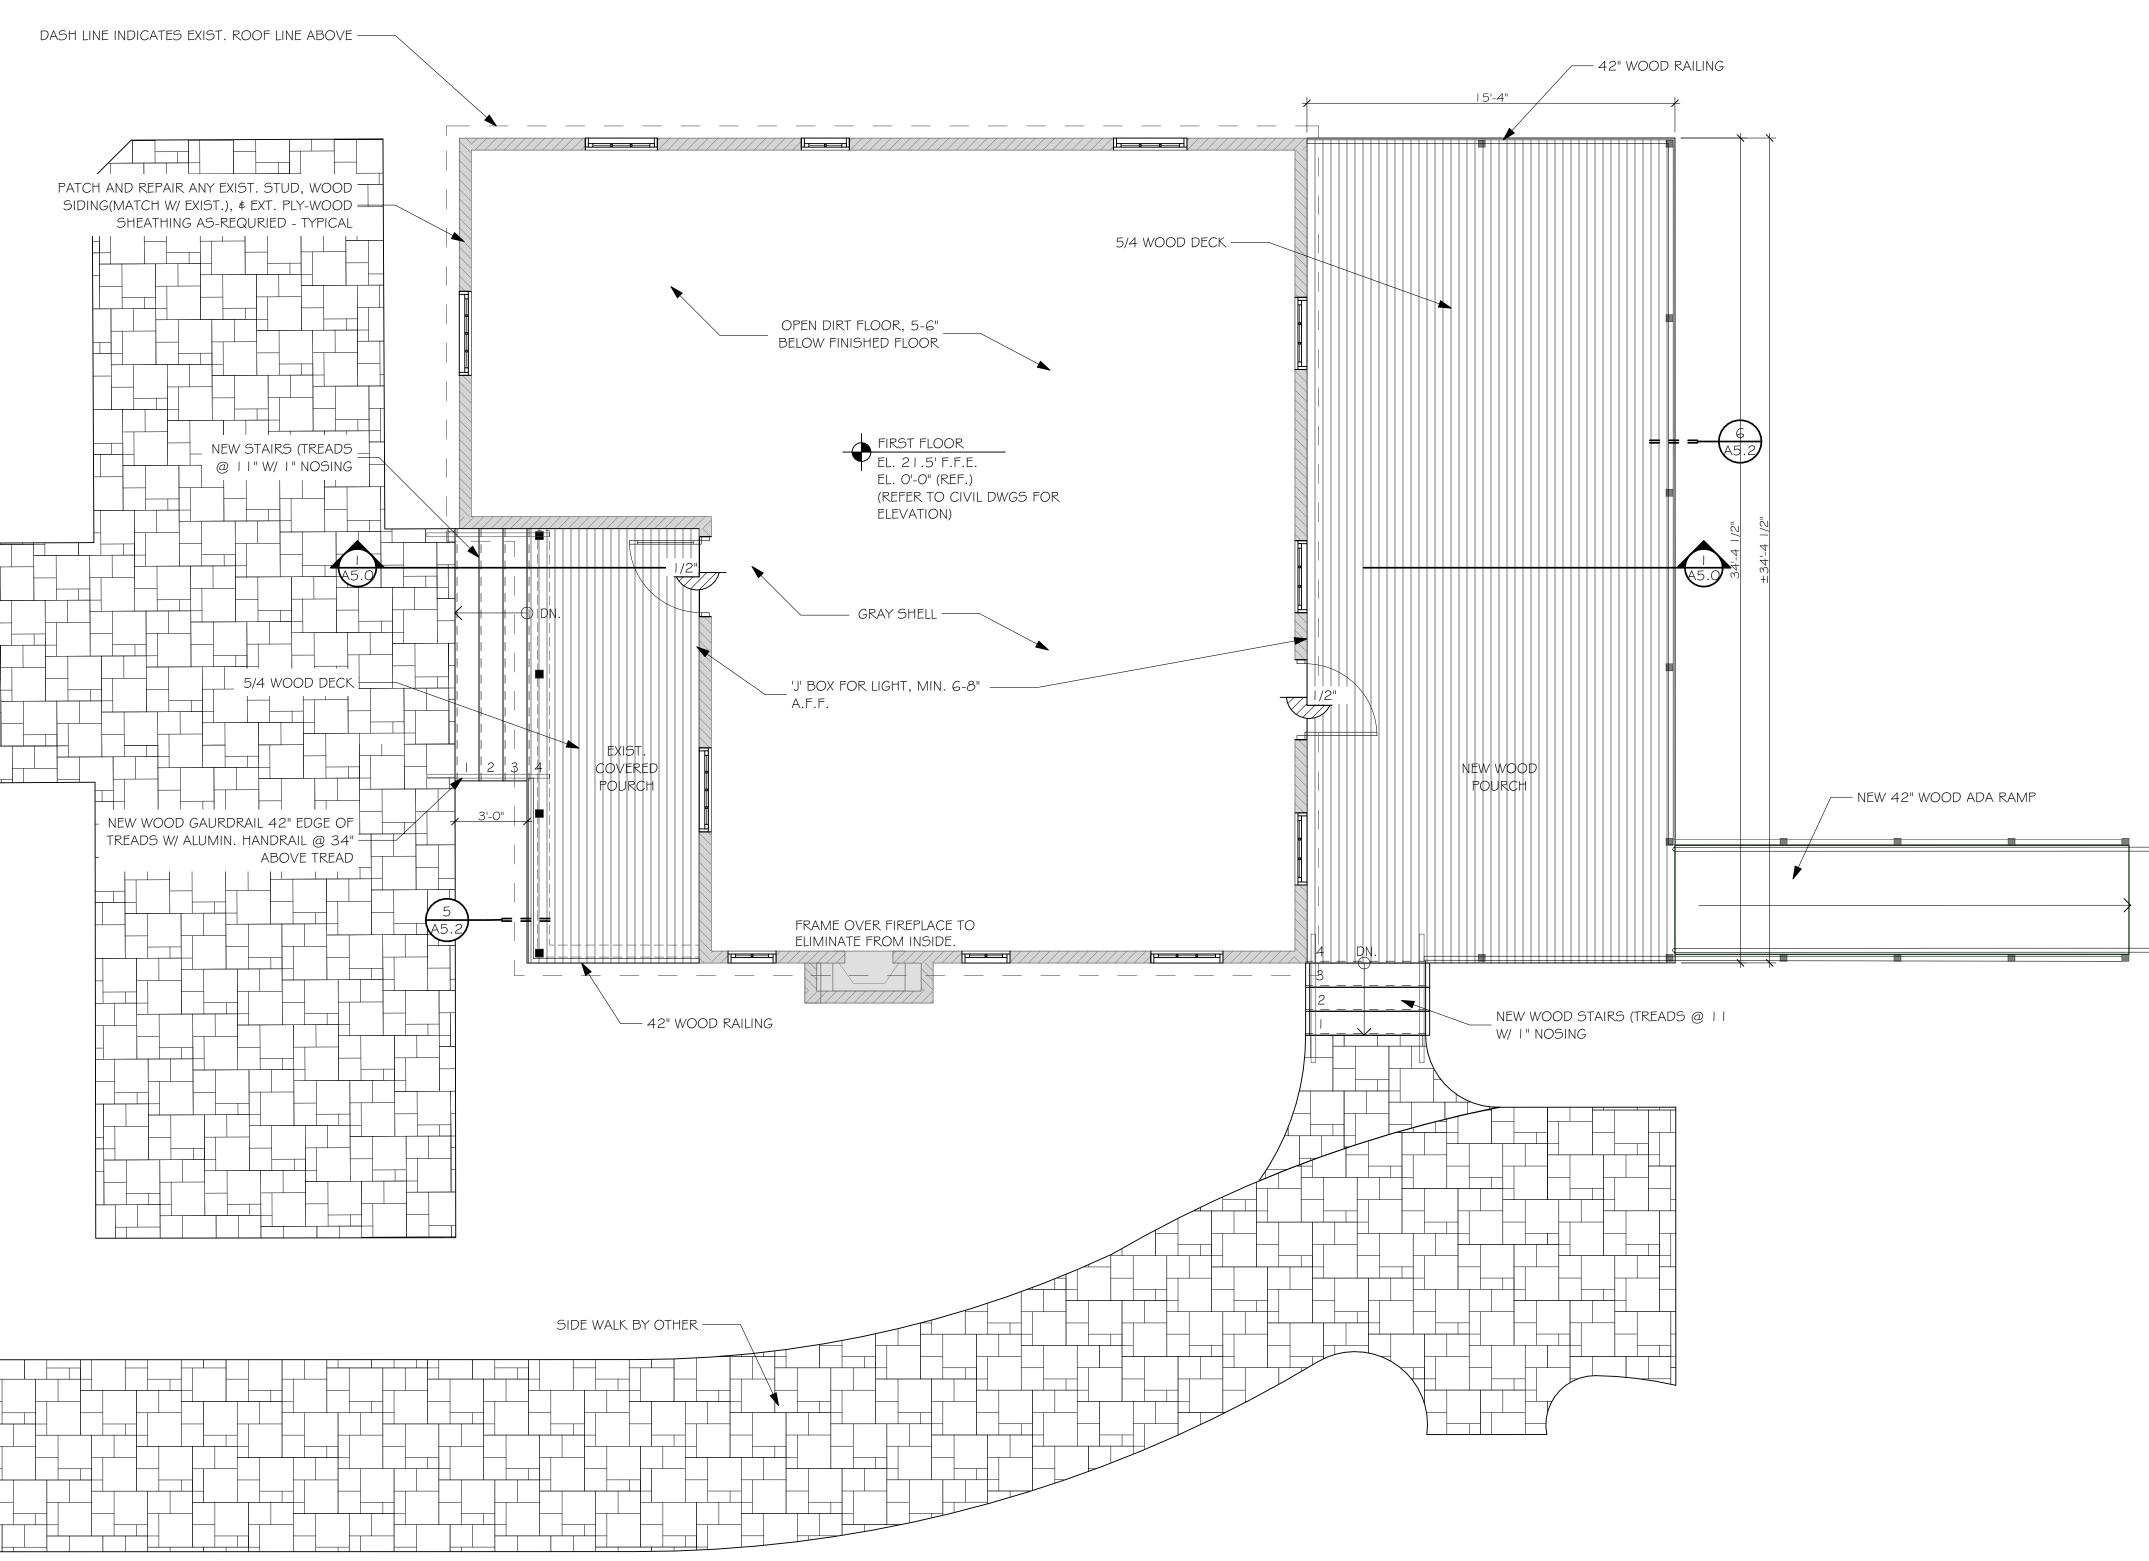

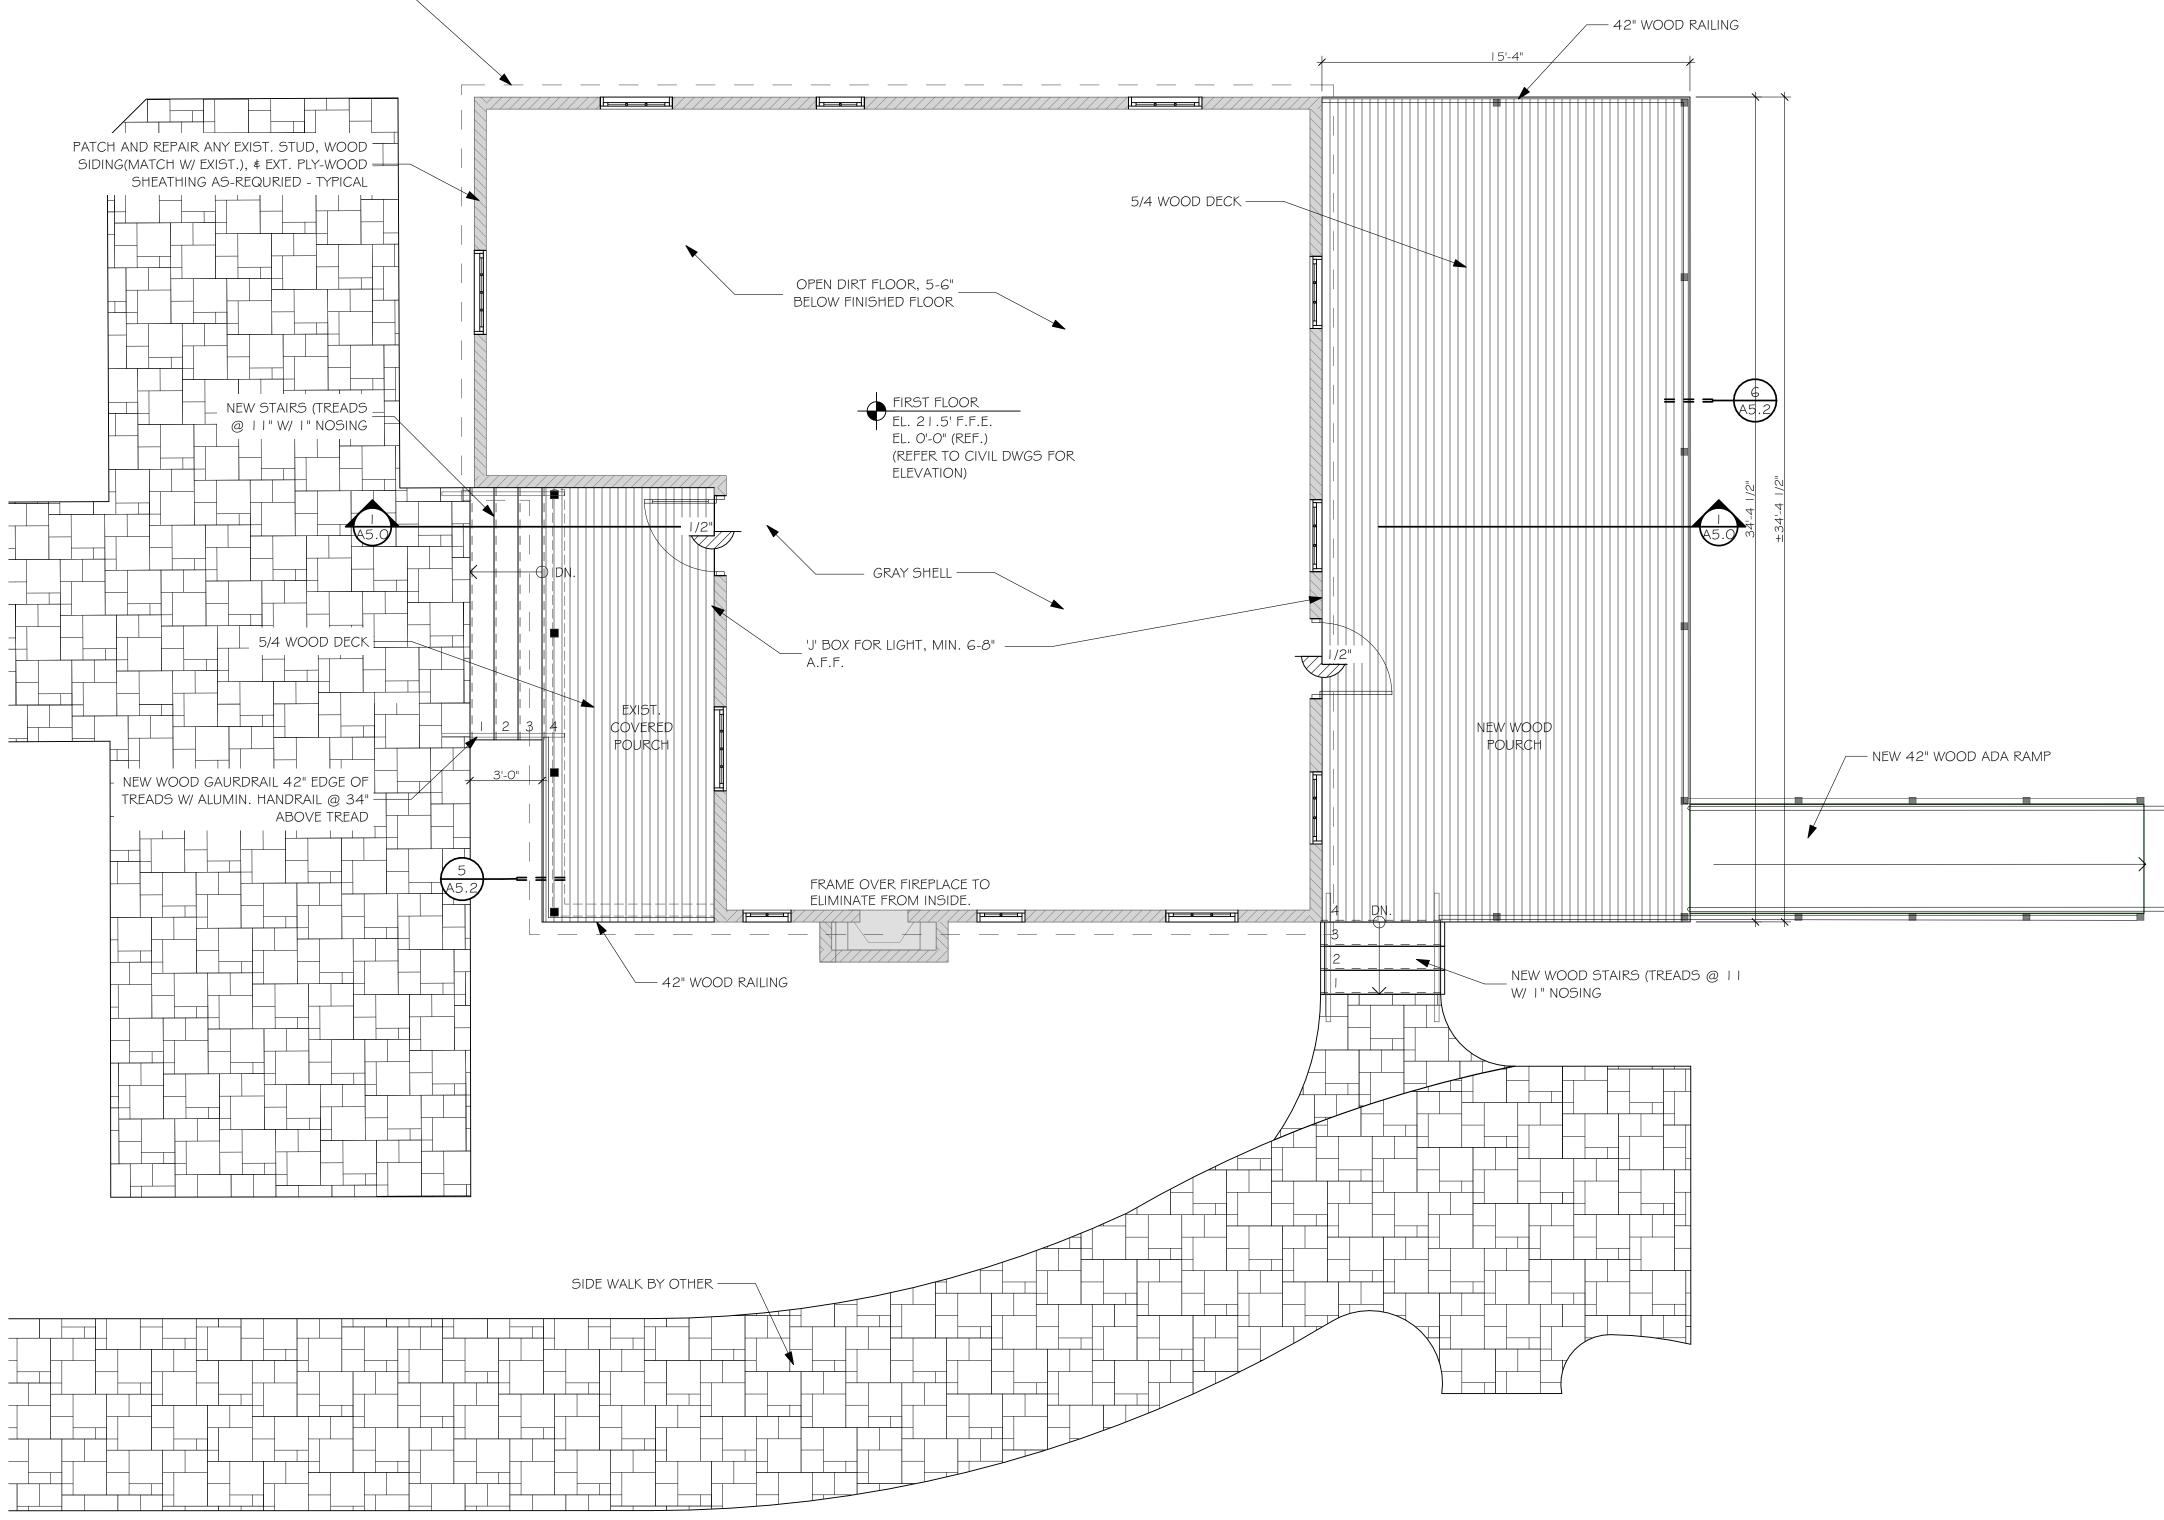




PROPOSED FLOOR PLAN SCALE: |/4" = |'-0"

Image: constraint of the second sec
SEAL SEAL STEVEN W. SIEBERT FLORIDA AR0017834 NEW JERSEY 21AI01517500 TEXAS 26934
COA APPLICATION SUNDY VILLAGE BLOCK 61 22-44 W. ATLANTIC AVE. DELRAY BEACH, FLORIDA 334444
COA APPLICATION
THE WRITTEN DIMENSIONS ON THESE DRAWINGS SHALL TAKE PRECEDENCE OVER SCALED DIMENSIONS. THE CONTRACTOR SHALL VERIFY AND BE RESPONSIBLE FOR ALL DIMENSIONS AND CONDITIONS ON THE JOB, AND THIS OFFICE MUST BE NOTIFIED OF ANY VARIATION FROM THE DIMENSIONS. COPYRIGHT STEVE SIEBERT ARCHITECTURE-UNAUTHORIZED REPRODUCTION OR ANY OTHER USE OF THIS DRAWING IS PROHIBITED. PROJECT NO: 23-534 DATE: 7.1.2024 DRAWN BY: SK/BT CHECKED BY: S.S. REVISIONS: TAC COMMENTS (9.23.24) TAC COMMENTS (10.14.24)
BUILDING G FLOOR PLAN
G-5.0

Ο () $\cap$ 



EXISTING ROOF PLAN SCALE: 1/4" = 1'-0"

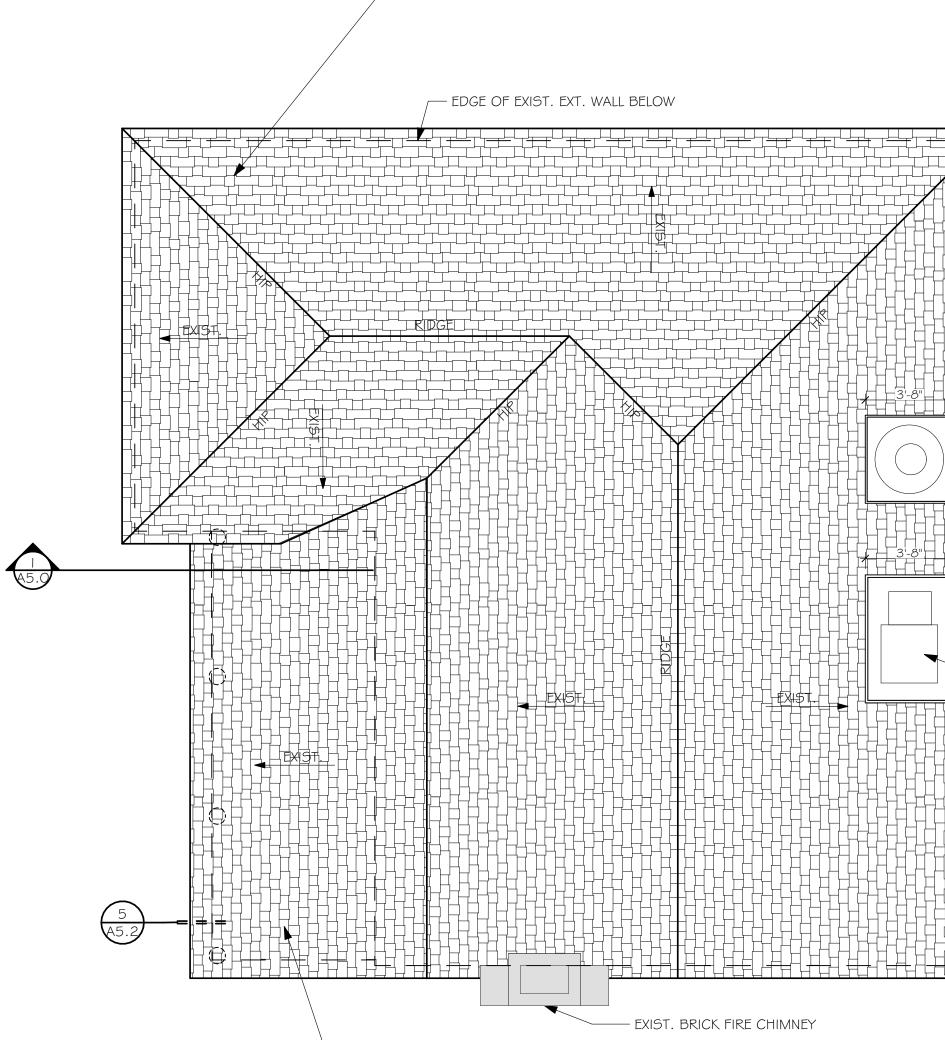


- REPLACE EXIST. SHINGLES WITH NEW, RED CEDER SHAKE, 22-1 202.04

LEAD FLASHING CAP, MIN. 2-4 LB. SET PRIMED FLANGE IN - ROOFCEMENT PER MANUF. SPECS. ROLL LEAD FLASHING I MIN. DOWN PIPE. BASESHEET. — SECONDARY TOP - FLASHING, OVERLAP VENT. EXIST. 2X BASE — NEW NAIL BASE —

SCALE: | " = | '-0"

2

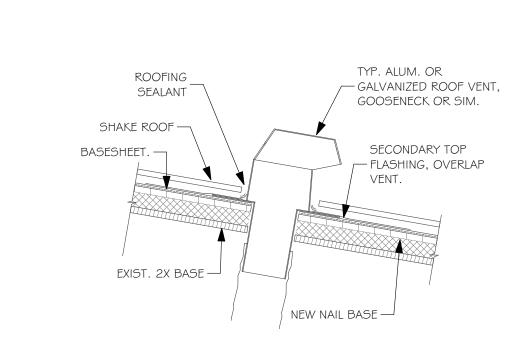

## ROOF PENETRATION DTL.

(IF APPLICABLE)

- REPLACE EXIST. SHINGLES WITH NEW, RED CEDER SHAKE, 22-1202.04, SEE SPEC. SHEET AO.4

SCREENING FOR VENTING IF TENANT IS A RESTAURANT. SEE DETAILS ON SHEET - AO.3. FINAL SCREENING LOCATION SHALL BE COORDINATED WITH THE PROPOSED FUTURE KITCHEN. STYLE TO MATCH HOME.

www.stevesiebert.com SEAL STEVEN W. SIEBERT FLORIDA AR0017834 NEW JERSEY21AI01517500TEXAS26934 334444 Ш () RIDA Z C Ι HAW. 22-4 DELRAY S COA APPLICATION THE WRITTEN DIMENSIONS ON THESE DRAWINGS SHALL TAKE PRECEDENCE OVER SCALED DIMENSIONS. THE CONTRACTOR SHALL VERIFY AND BE RESPONSIBLE FOR ALL DIMENSIONS AND CONDITIONS ON THE JOB, AND THIS OFFICE MUST BE NOTIFIED OF ANY VARIATION FROM THE DIMENSIONS. COPYRIGHT STEVE SIEBERT ARCHITECTURE-UNAUTHORIZED REPRODUCTION OR ANY OTHER USE OF THIS DRAWING IS PROHIBITED. PROJECT NO: 23-534 7.1.2024 DATE: DRAWN BY: SK/BT S.S. CHECKED BY:\_\_\_\_ **REVISIONS:** <u>/I</u> TAC COMMENTS (9.23.24) 2 TAC COMMENTS (10.14.24) BUILDING G ROOF PLAN G-5.1

STEVE SIEBERT


ARCHITECTURE

1010 GATEWAY BLVD, SUIT 103

BOYNTON BEACH, FL 33426 PH. 561.880.7894 Steve@stevesiebert.com

NOTE: PROVIDE 100% GUTTER COVERAGE. GUTTERS (BY OTHERS), PROVIDE DOWNSPOUTS BY GUTTER INSTALLER. GC SHALL COORDINATE W/ OWNER. GC SHALL COORDINATE DOWN SPOUTS LOCATIONS W/ CIVIL ENGINEER PRIOR TO WORK.

45.0

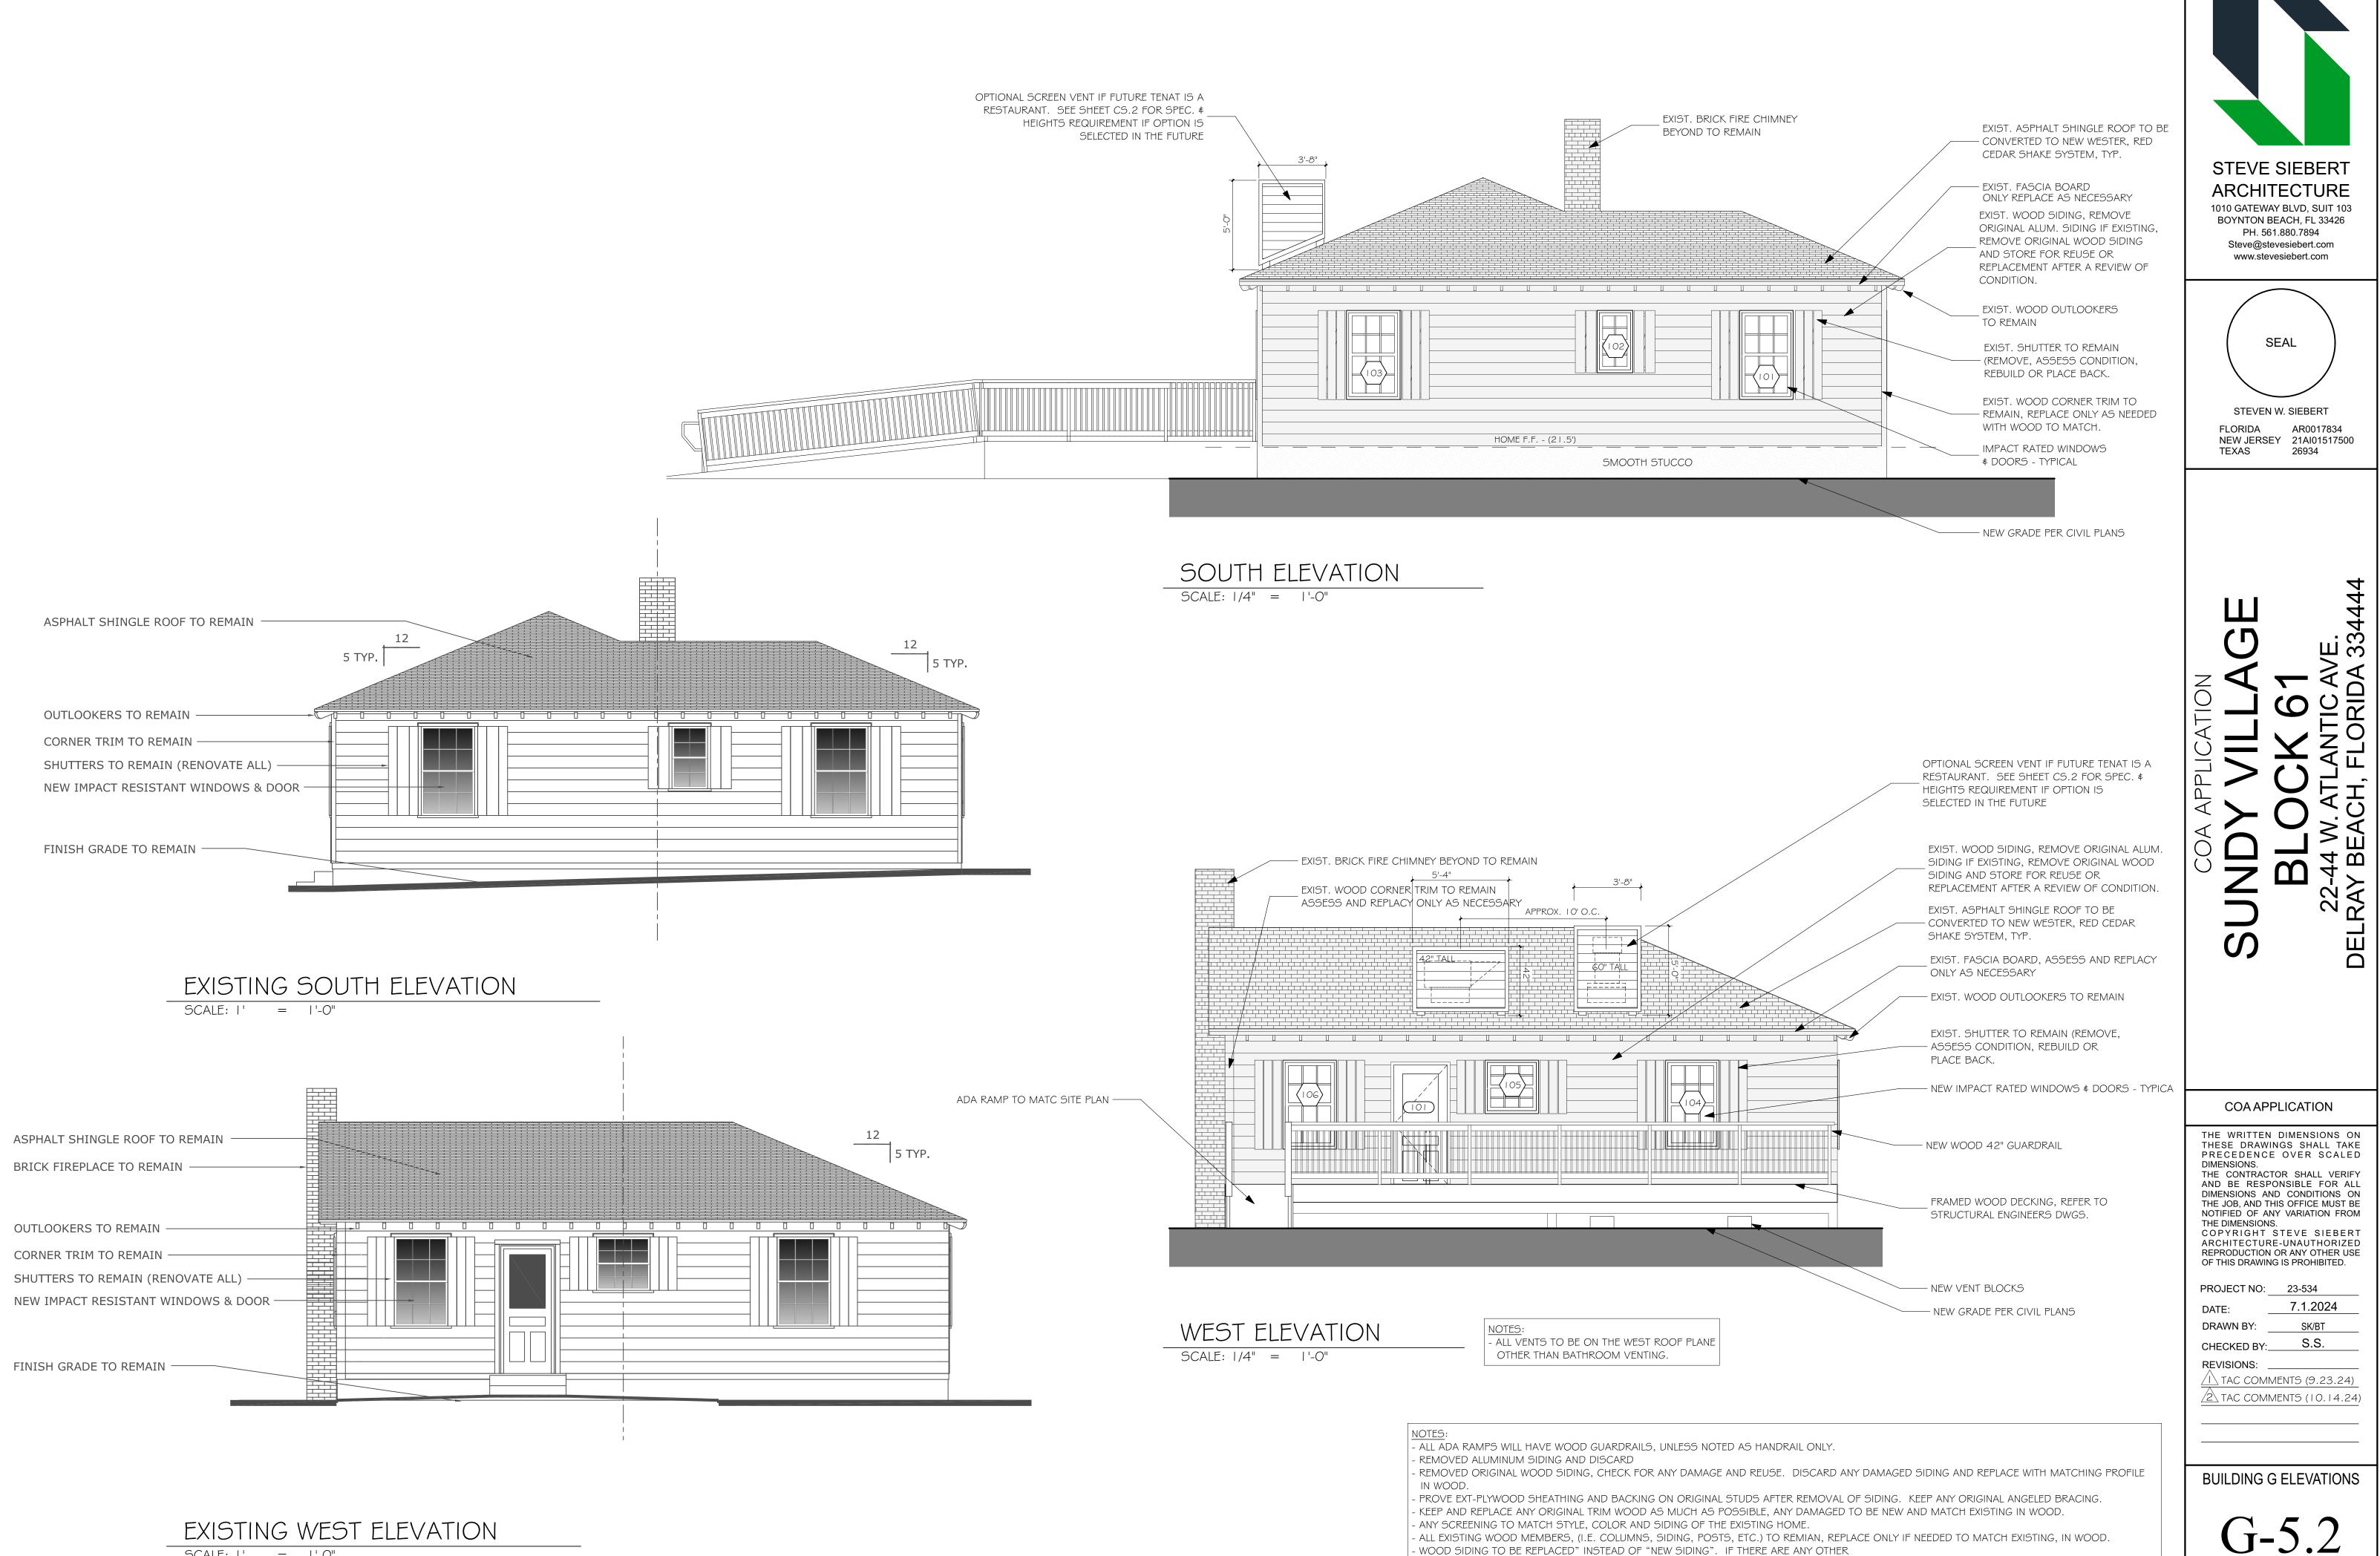


EXISTING WEST ELEVATION

SCALE: |' = |'-O''


- ANY SCREENING TO MATCH STYLE, COLOR AND SIDING OF THE EXISTING HOME.

- ALL EXISTING WOOD MEMBERS, (I.E. COLUMNS, SIDING, POSTS, ETC.) TO REMIAN, REPLACE ONLY IF NEEDED TO MATCH EXISTING, IN WOOD. - WOOD SIDING TO BE REPLACED" INSTEAD OF "NEW SIDING". IF THERE ARE ANY OTHER - ELEMENTS THAT CURRENTLY EXIST. ON THE STRUCTURE THAT IS BEING REPLACED WITH THE SAME MATERIAL.

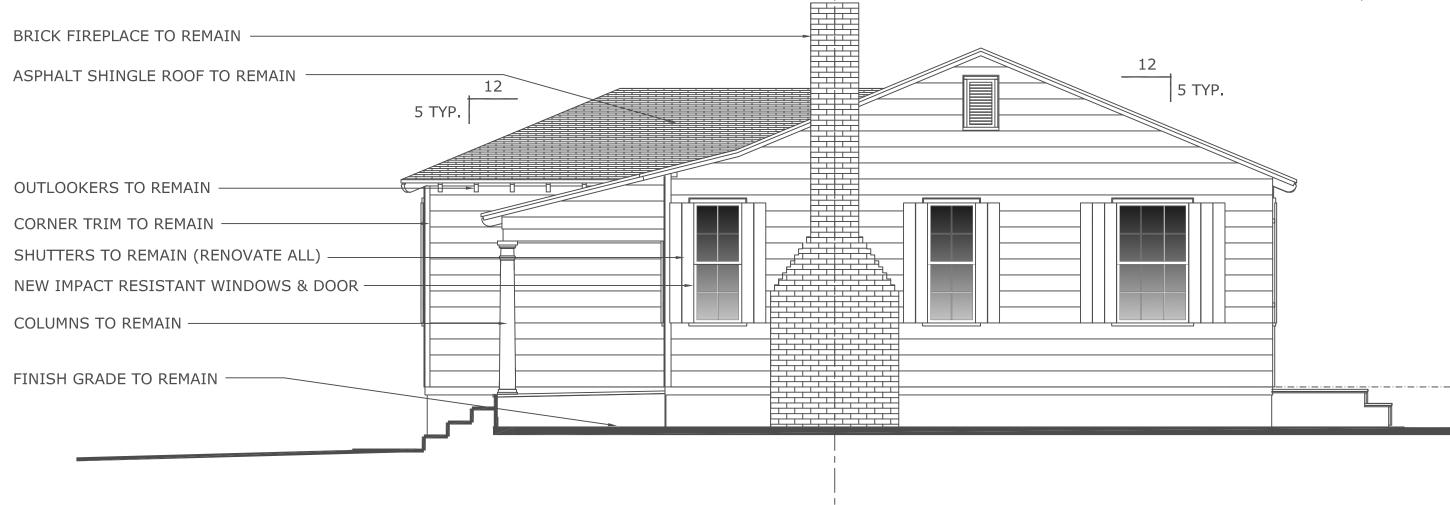





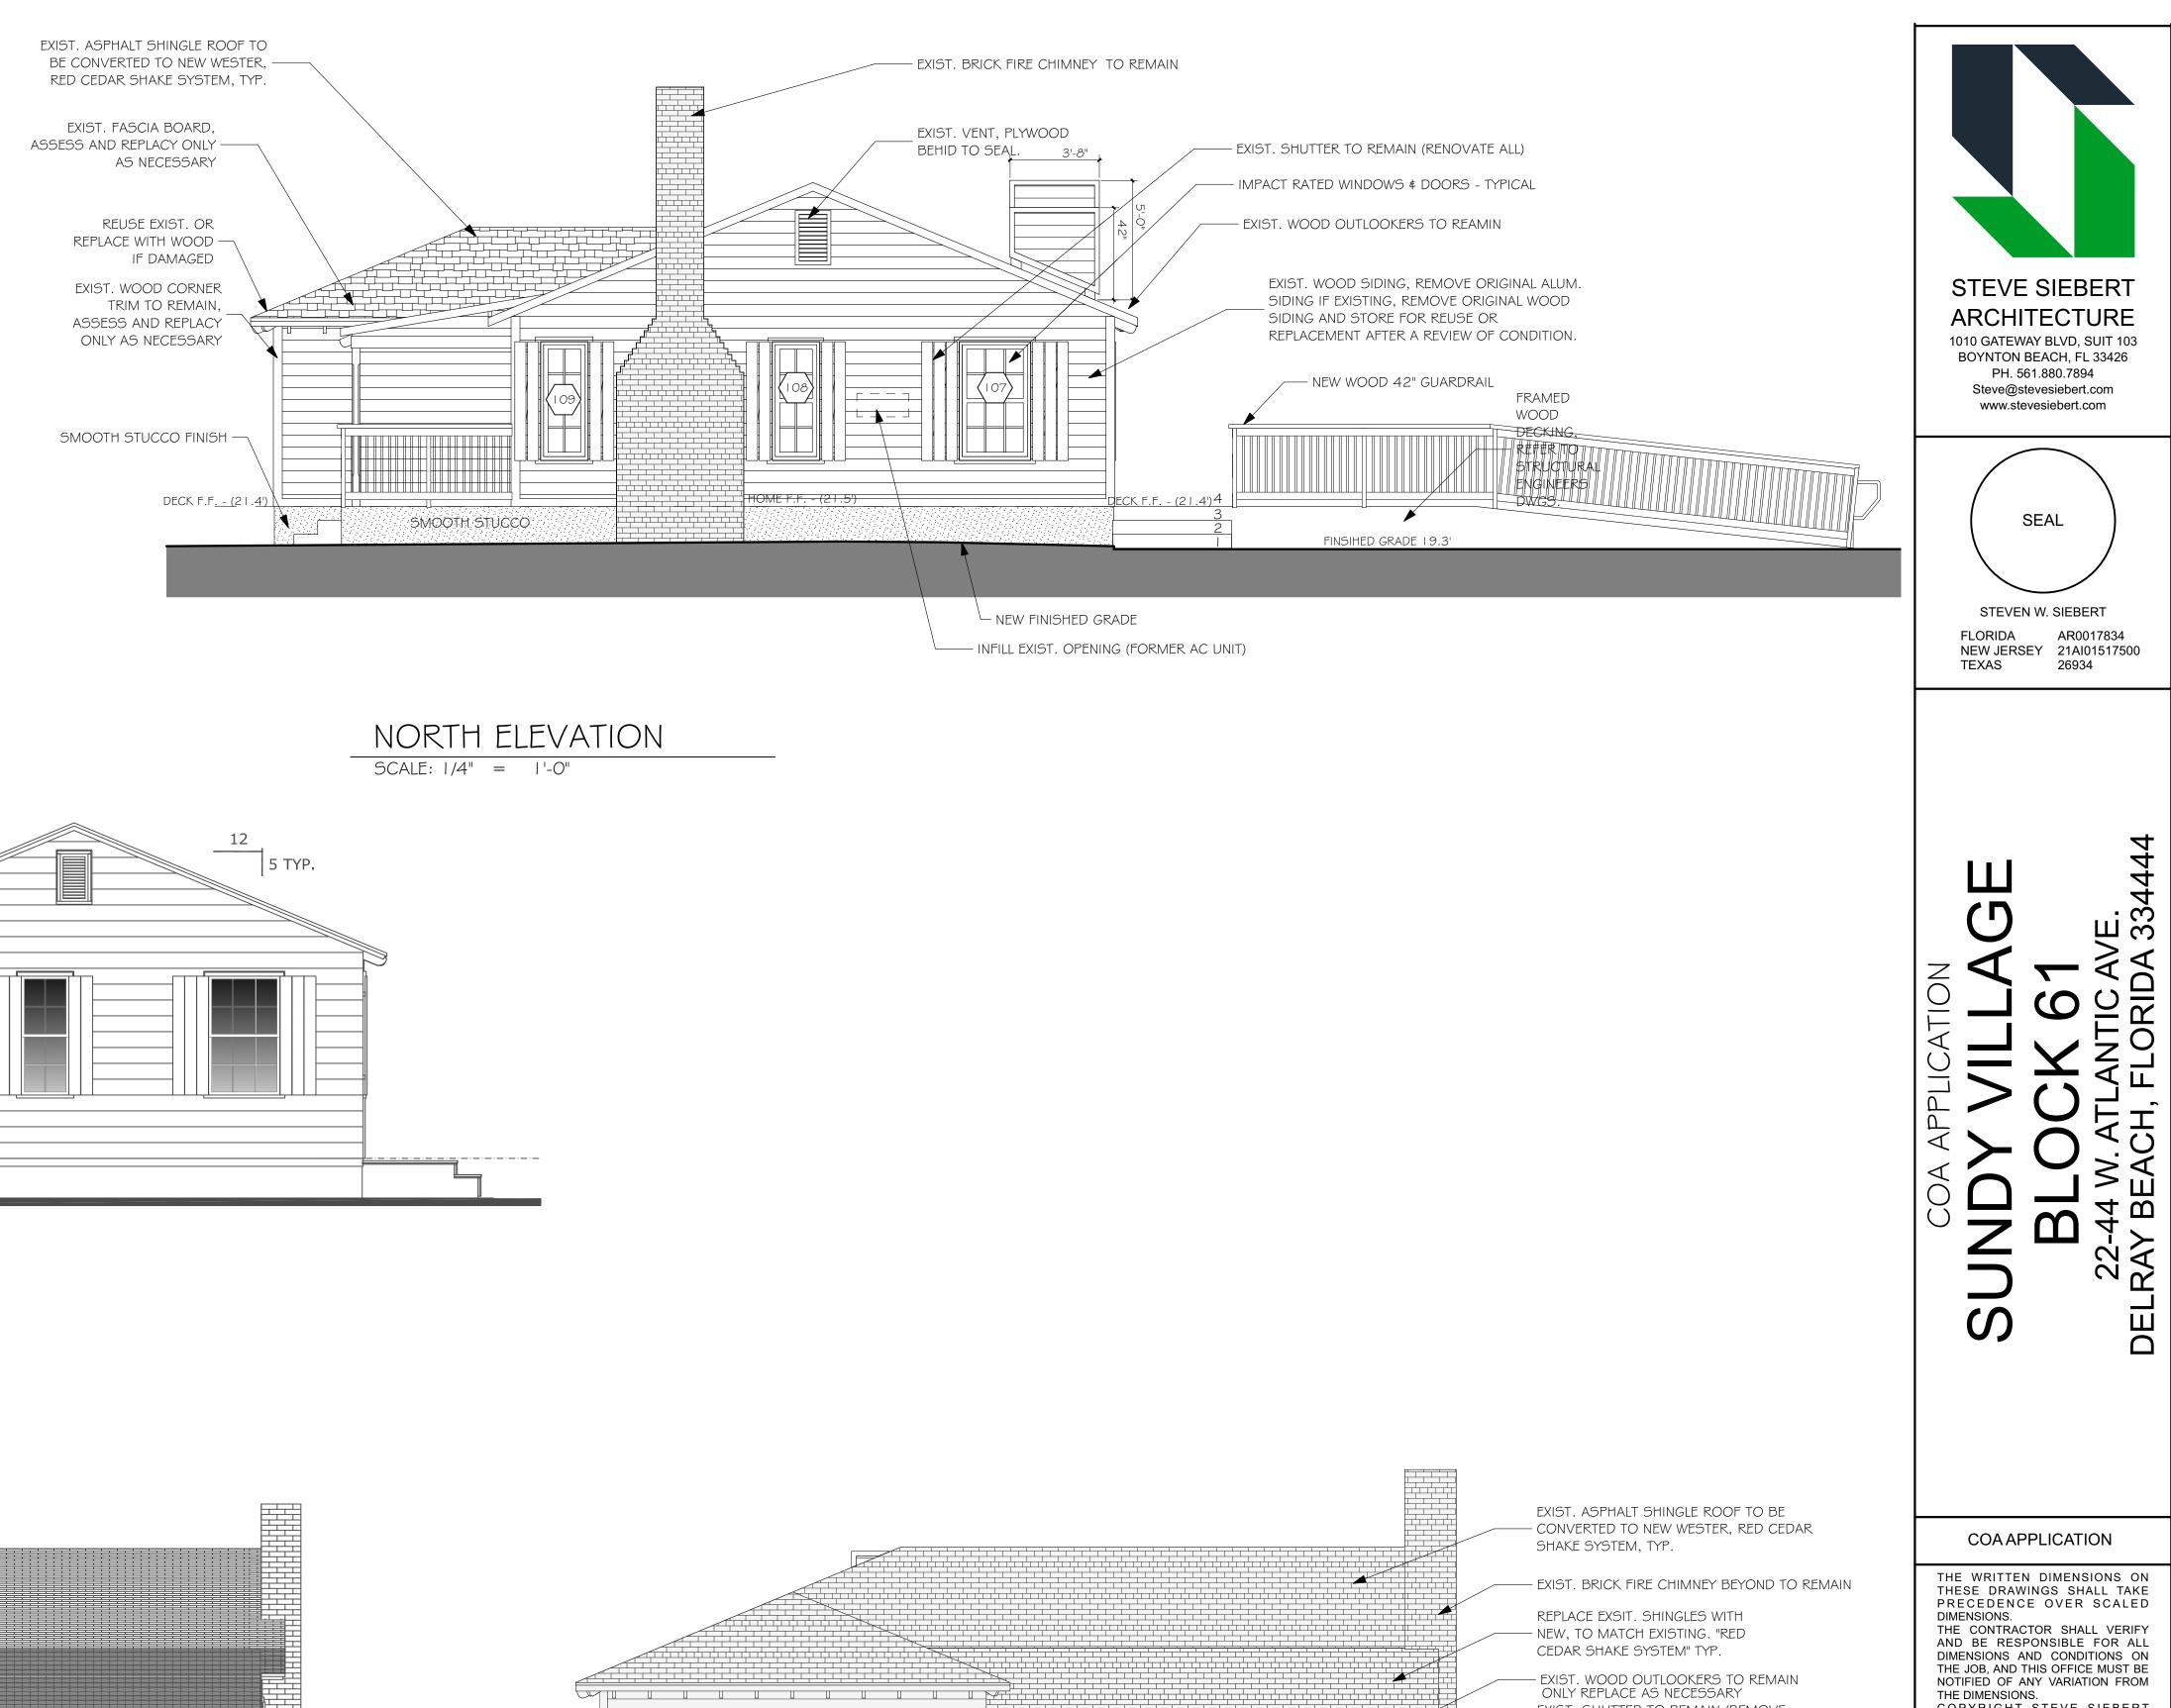

COPYRIGHT STEVE SIEBERT ARCHITECTURE-UNAUTHORIZED REPRODUCTION OR ANY OTHER USE EXIST. SHUTTER TO REMAIN (REMOVE, - ASSESS CONDITION, REBUILD OR PLACE BACK. OF THIS DRAWING IS PROHIBITED. EXIST. 4x4 WOOD COLUMNS TO REMAIN, PROJECT NO: 23-534 TYP. OF FOUR (4) ONLY REPLACE AS NECESSARY DATE: - IMPACT RATED WINDOWS & DOORS - TYPICAL DRAWN BY: CHECKED BY:\_\_\_\_ 0" (2 | .5') FINISH FLOOR **REVISIONS:** FINSIHED GRADE 19.3 - NEW GRADE PER CIVIL PLANS

S.S. /1 TAC COMMENTS (9.23.24) 2 TAC COMMENTS (10.14.24) **BUILDING G ELEVATIONS** G-5.3

7.1.2024

SK/BT