DERRICKSON RESIDENCE RENOVATIONS & ADDITIONS 330 NE First Avenue, Delray Beach, Florida 33444

Note: COA 2021-199 & Submitted for Historic Preservation Board Review on December 1, 2021



STRUCTURAL ENGINEER:

PENNONI, INC.

Consulting Structural Engineers
Robert Selinsky, PE, SI,
601 N. Congress Ave, Ste. 106a,
Delray Beach, FL 33445
(561) 870-8826
email: rselinsky@pennoni.com
PE # 49952

MEP ENGINEER:

ROCAMAR ENGINEERING SERVICES, INC. Mr. Bernardo Cardenal, PE 6401 Congress Ave., Ste 230 Boca Raton, FL. 33487 (561) 276-9898, cell: (561) xxxx email: bernardoc@rocamareng.com PE #38300

ARCHITECT:

SLOAN & SLOAN, INC.-ARCHITECTS & INT. DESIGNERS Dan Sloan, AIA, Project Mgr. 106 SE 7th Ave., Ste. B Delray Beach, FL 33483 (561) 243-8755 email: dan@sloandesign.biz

AR 95577 & AA26002208

CIVIL ENGINEER:

ENVIRODESIGN ASSOC., INC.-CIVIL ENGINEERS Joe Pike, PE, Project Mgr. 298 Pineapple Grove Way Delray Beach, FL 33444 (561) 274-6500 email: jpike@envdesign.Com

LANDSCAPE ARCHITECT:

Murakami Landscape Architects,Inc.-LANDSCAPE ARCHITECTS Don Murakami, LA, Project Mgr. 326 NE 1st Ave, Delray Beach, FL. 33444 (561) 276-7750 email: don@mlandscape.net LA 0001477

OCCUPANCY CLASSIFICATION: SINGLE FAMILY RESIDENTIAL

TYPE OF CONSTRUCTION:

TYPE V -Unprotected / Unsprinkled (Existing 1 Single Family Residential Structure)

APPLICABLE CODES:


2020 FLORIDA BUILDING CODE
2020 FLORIDA MECHANICAL CODE
2020 FLORIDA ELECTRICAL CODE
2020 FLORIDA PLUMBING CODE
2020FLORIDA BUILDING CODE
2008 ICC 600- std. for residential construction in high wind areas

Public Super Marks of Public Super Marks of

	RE 1st Avenue, Delray Beach, FL esign Parameters- revised 2/10/202 ng: Single Family: OSSHAD	21	
#	Perrickson_SiteTblns&DsnParamtrs.xls		_
1	OCCUPANCY: (Single Family, Multifamily, Commercial, Industrial, Institutional)	Single Family	SEC. R301.2.1.4.3 2020 FLORIDA RESIDENTIAL CODE
2	EXPOSURE CONDITION:	<u>B</u>	
3	MEAN ROOF HEIGHT: Feet (Principal Roof Form)	<u>22.3'</u>	(above average grade)
4	BUILDING HEIGHT: (if < or = 60' may use FBC 2020 Low Rise Provisions. If >60' use ASCE7-16		X < or = 60' Height > 60' Height
5	BUILDING DESIGNED AS:		Partly enclosed X Enclosed Open Tested (Wind Tunnel)
6	IMPORTANCE FACTOR: (Determined by Building Use /Occupancy. Refer to FBC 2020 or ASCE 7-16)	<u>1.0</u>	
7	BASIC WIND VELOCITY PRESURES: FBC 2020. VE POSITIVE/VEGATIVE PRESSURE COEFFICIENTS APPLIED TO MAIN WIND FORCE RESISTING SYS ENVELOPE COMPONENTS & CLADDING AS APPLI	HAVE BEEN TEM, OR BUILI	
	FBC 2020 WIND SPEED: FBC 2020 BASIC VELOCITY PRESSURE:	132 32	(Wind Speed in mph) IN PSF
	ASCE 7-16 WIND SPEED: ASCE 7-16 BASIC VELOCITY PRESSURE:	<u>170</u> n/a	(Ultimate Wind Speed in m IN PSF
	NOTE: Actual Design Pressures for All Exterior W Garage Doors, and Similar Envelope Elements Mu Indicated on Construction Plans.		ō,
	ROOF DEAD LOAD (Actual Dead Load of Materials Used for Determining Net Uplift Reactions.	<u>15</u>	LBS
8		2500	PSF
8	SOIL BEARING CAPACTIY: (Supported by Soils Report from Geotechnical Engineer)		

Reviseu: 0/22/	21 By Dan Sloan	
#	Title	Includes
A0.00	Cover Sheet	W/ Consultant List, Location Map, Drawing List
A1.01	Site Plan- Existing Configuration	Showing Setbacks, Driveway, Pool Deck Areas
A1.02	Site Plan- New Proposed Configuration	Showing New Additions, Garage, Gst Cott. Addition
A1.03	Composite Site Plan- Old/New Configurations	Showing New Additions, Garage, Gst Cott. Addition
A1.04	Streetscape & Areal Photo Site Plan-	Showing Subject Property & Adj. Homes to North & South
A1.05	Area Site Plan-	Showing Subject Property & Adj. Homes to North & South
A2.01	Existing First Floor Plan	Showing EXTG Elements & General Notes
A2.01.1	Demolition Plans- 1st & 2nd Floors	Showing Walls, Doors, Windows, etc. to be removed
A2.02	NEW First Floor Plan	
A2.02b	Enlarged Door & Window Schedules	
A2.02coa	NEW & OLD First Floor Plans	of Main Residence
A2.02c	NEW Outbuildings First & 2nd Floor Plans	For New 2 Story Garage & 1 Story Guest Cottage
A2.03	Existing Second Floor Plan	With Additional Notes/Details
A2.04 A2.04coa	NEW Second Floor Plan NEW & OLD Second Floor Plans	With Additional Notes/Details of Main Residence
A2.04coa A2.05	NEW Roof Plan	With Roofing Notes/Details/Specs
		The state of the s
A3.01	EXISTING North, South, East, & West Elevations	Main Hse: Showing Extg. Windows, Doors, & Exterior Elements
A3.02	NEW East, & West Elevations of Main House	Showing Extg Home & New Additions to Home
A3.02coa	NEW & OLD East, & West Elevtns of Main House	Showing Both Extg & New Elevations of Main House
	NEW & OLD East, & West Elevtns of Main House	Extg & New Elevations w SIMPLIFIED RAILING DESIGN
	NEW North & South Florations of Main House	With Materials/Colors/Finishes Noted
A3.03 A3.03coa	NEW North, & South Elevations of Main House NEW & OLD North, & So. Elevtns of Main House	Showing Extg Home & New Additions to Home Showing Both Extg & New Elevations of Main House
	NEW & OLD North, & So. Elevtns of Main House	Extg & New Elevations of Main House Extg & New Elevations w SIMPLIFIED RAILING DESIGN
A3.03b	NEW North, South, East, West Outbldg Elevation:	
A4.02	NEW E. Elevation/Section "3" at Dbl.Ht.Front Porch	Showing Section "2" & Section/Elevation "3"
2	The Folding Section 5 at District Folding	Showing New Proposed French & BiFold French Doors

The Work Shown in these Plans Shall Comply with the 2020 Florida Building Code w/ any Amendments and (as applicable) the same version of the Florida Mechanical, Electrical, Plumbing, and Existing Building Code(s). Framing and Other Structural Details will also comply with ICC-600 (Previously SSTD 10-99).

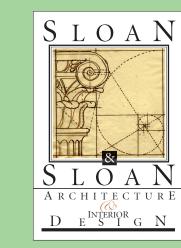

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No.	Date	Appr	Revision Notes
1	xx/xx/21		Issued for HPB Review
2	xx/xx/21		Issued for Permitting

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ue Note	<u>Derrickson Residence</u>

A 5/16/09 Issue Note

No. Date Issue Notes

Daniel Sloan, AR95577
Date:


"Sloan & Sloan- Architecture + I.D. 106 SE 7th Avenue, Ste. B Delray Bch, FL 33483 (561) 243-8755

Derrickson Residence Renovations & Additions 330 NE 1st Avenue

COVER SHEET

	D. Sloan	Derrickson Residence Project
	Drawn By D. Sloan	Scale As Noted
	Reviewed By D. Sloan	A0.00 coa
	Date 10/18/2021	———— of ————
Der	CAD File Name rickson_Reno_ExtgBldg.	Total Sheets


Cover Sheet A0.00

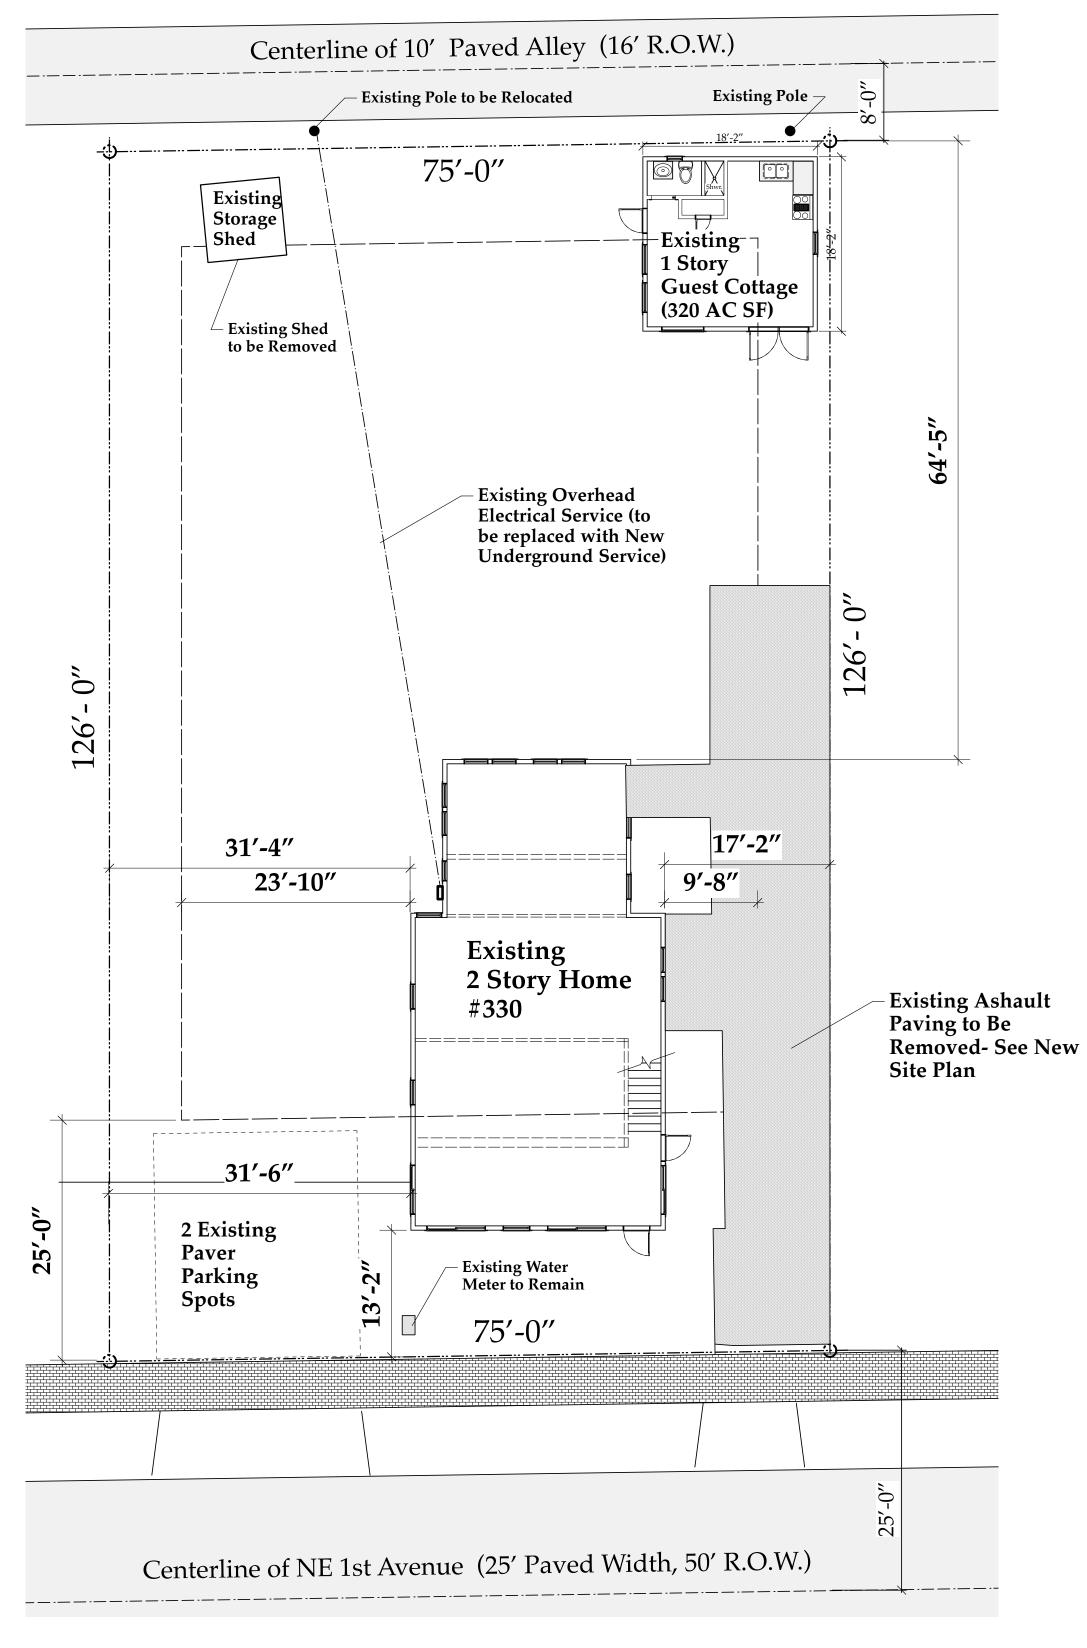

EXISTING SITE PLAN Scale: 1" = 10 ft



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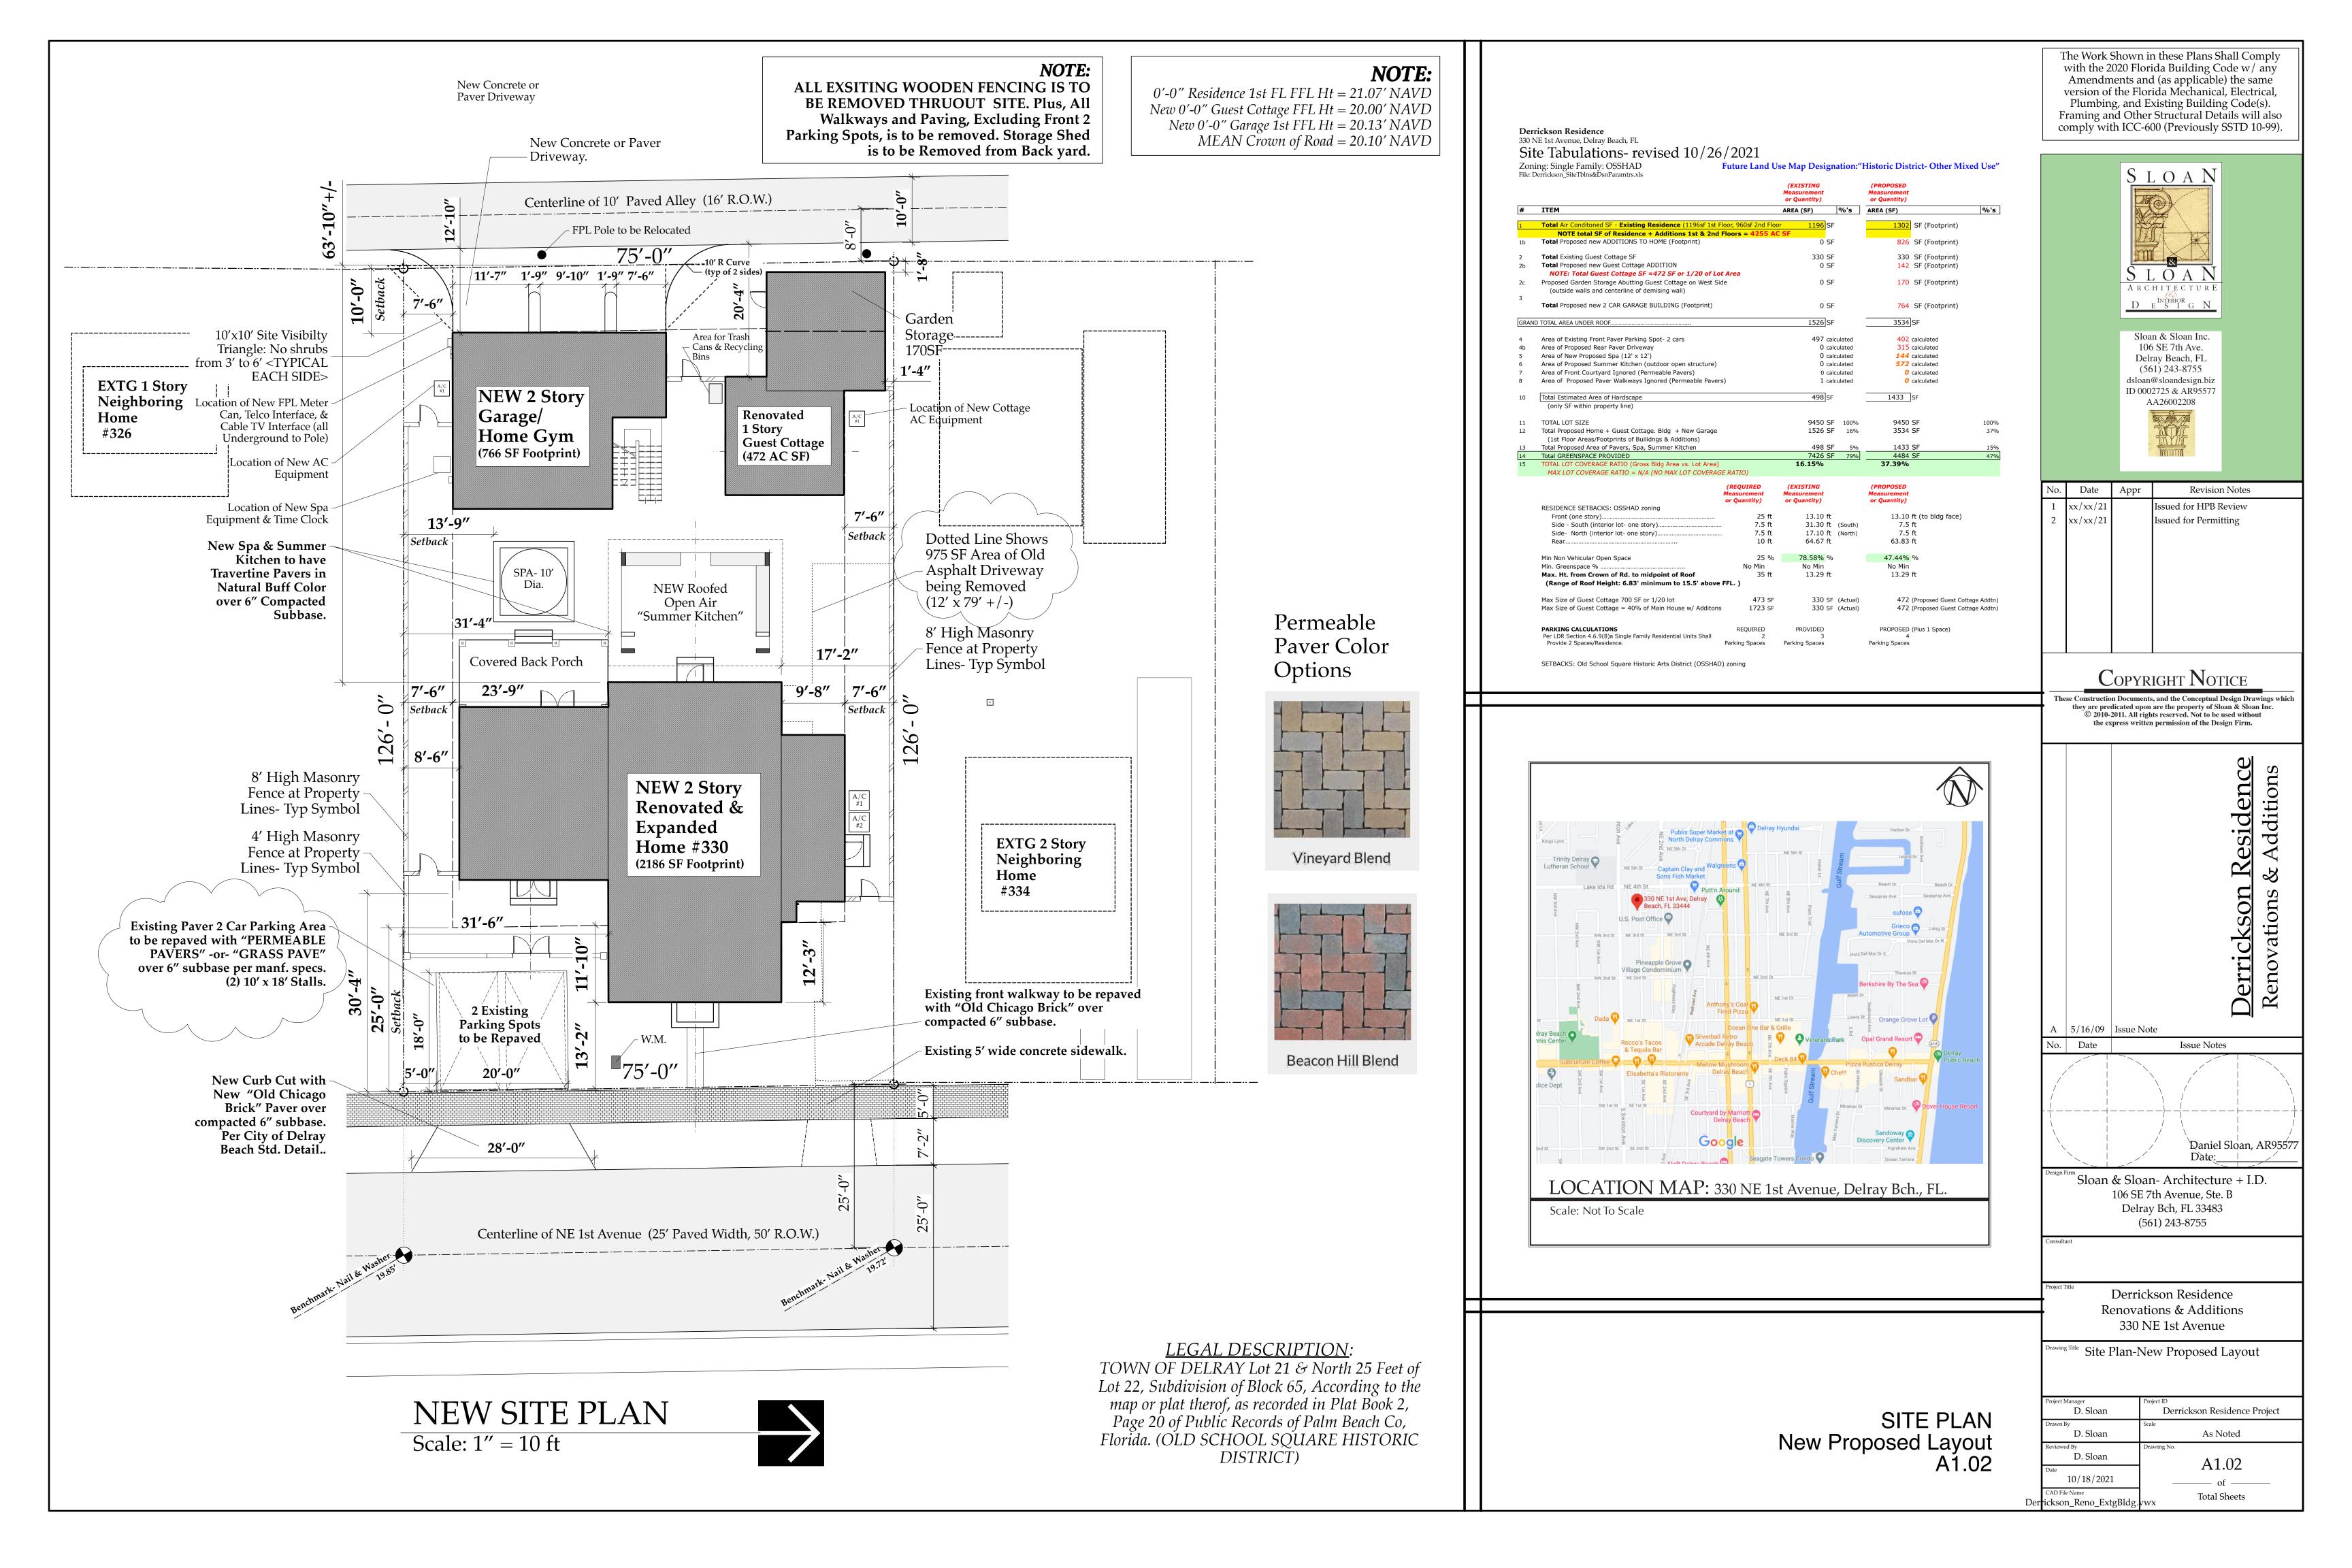
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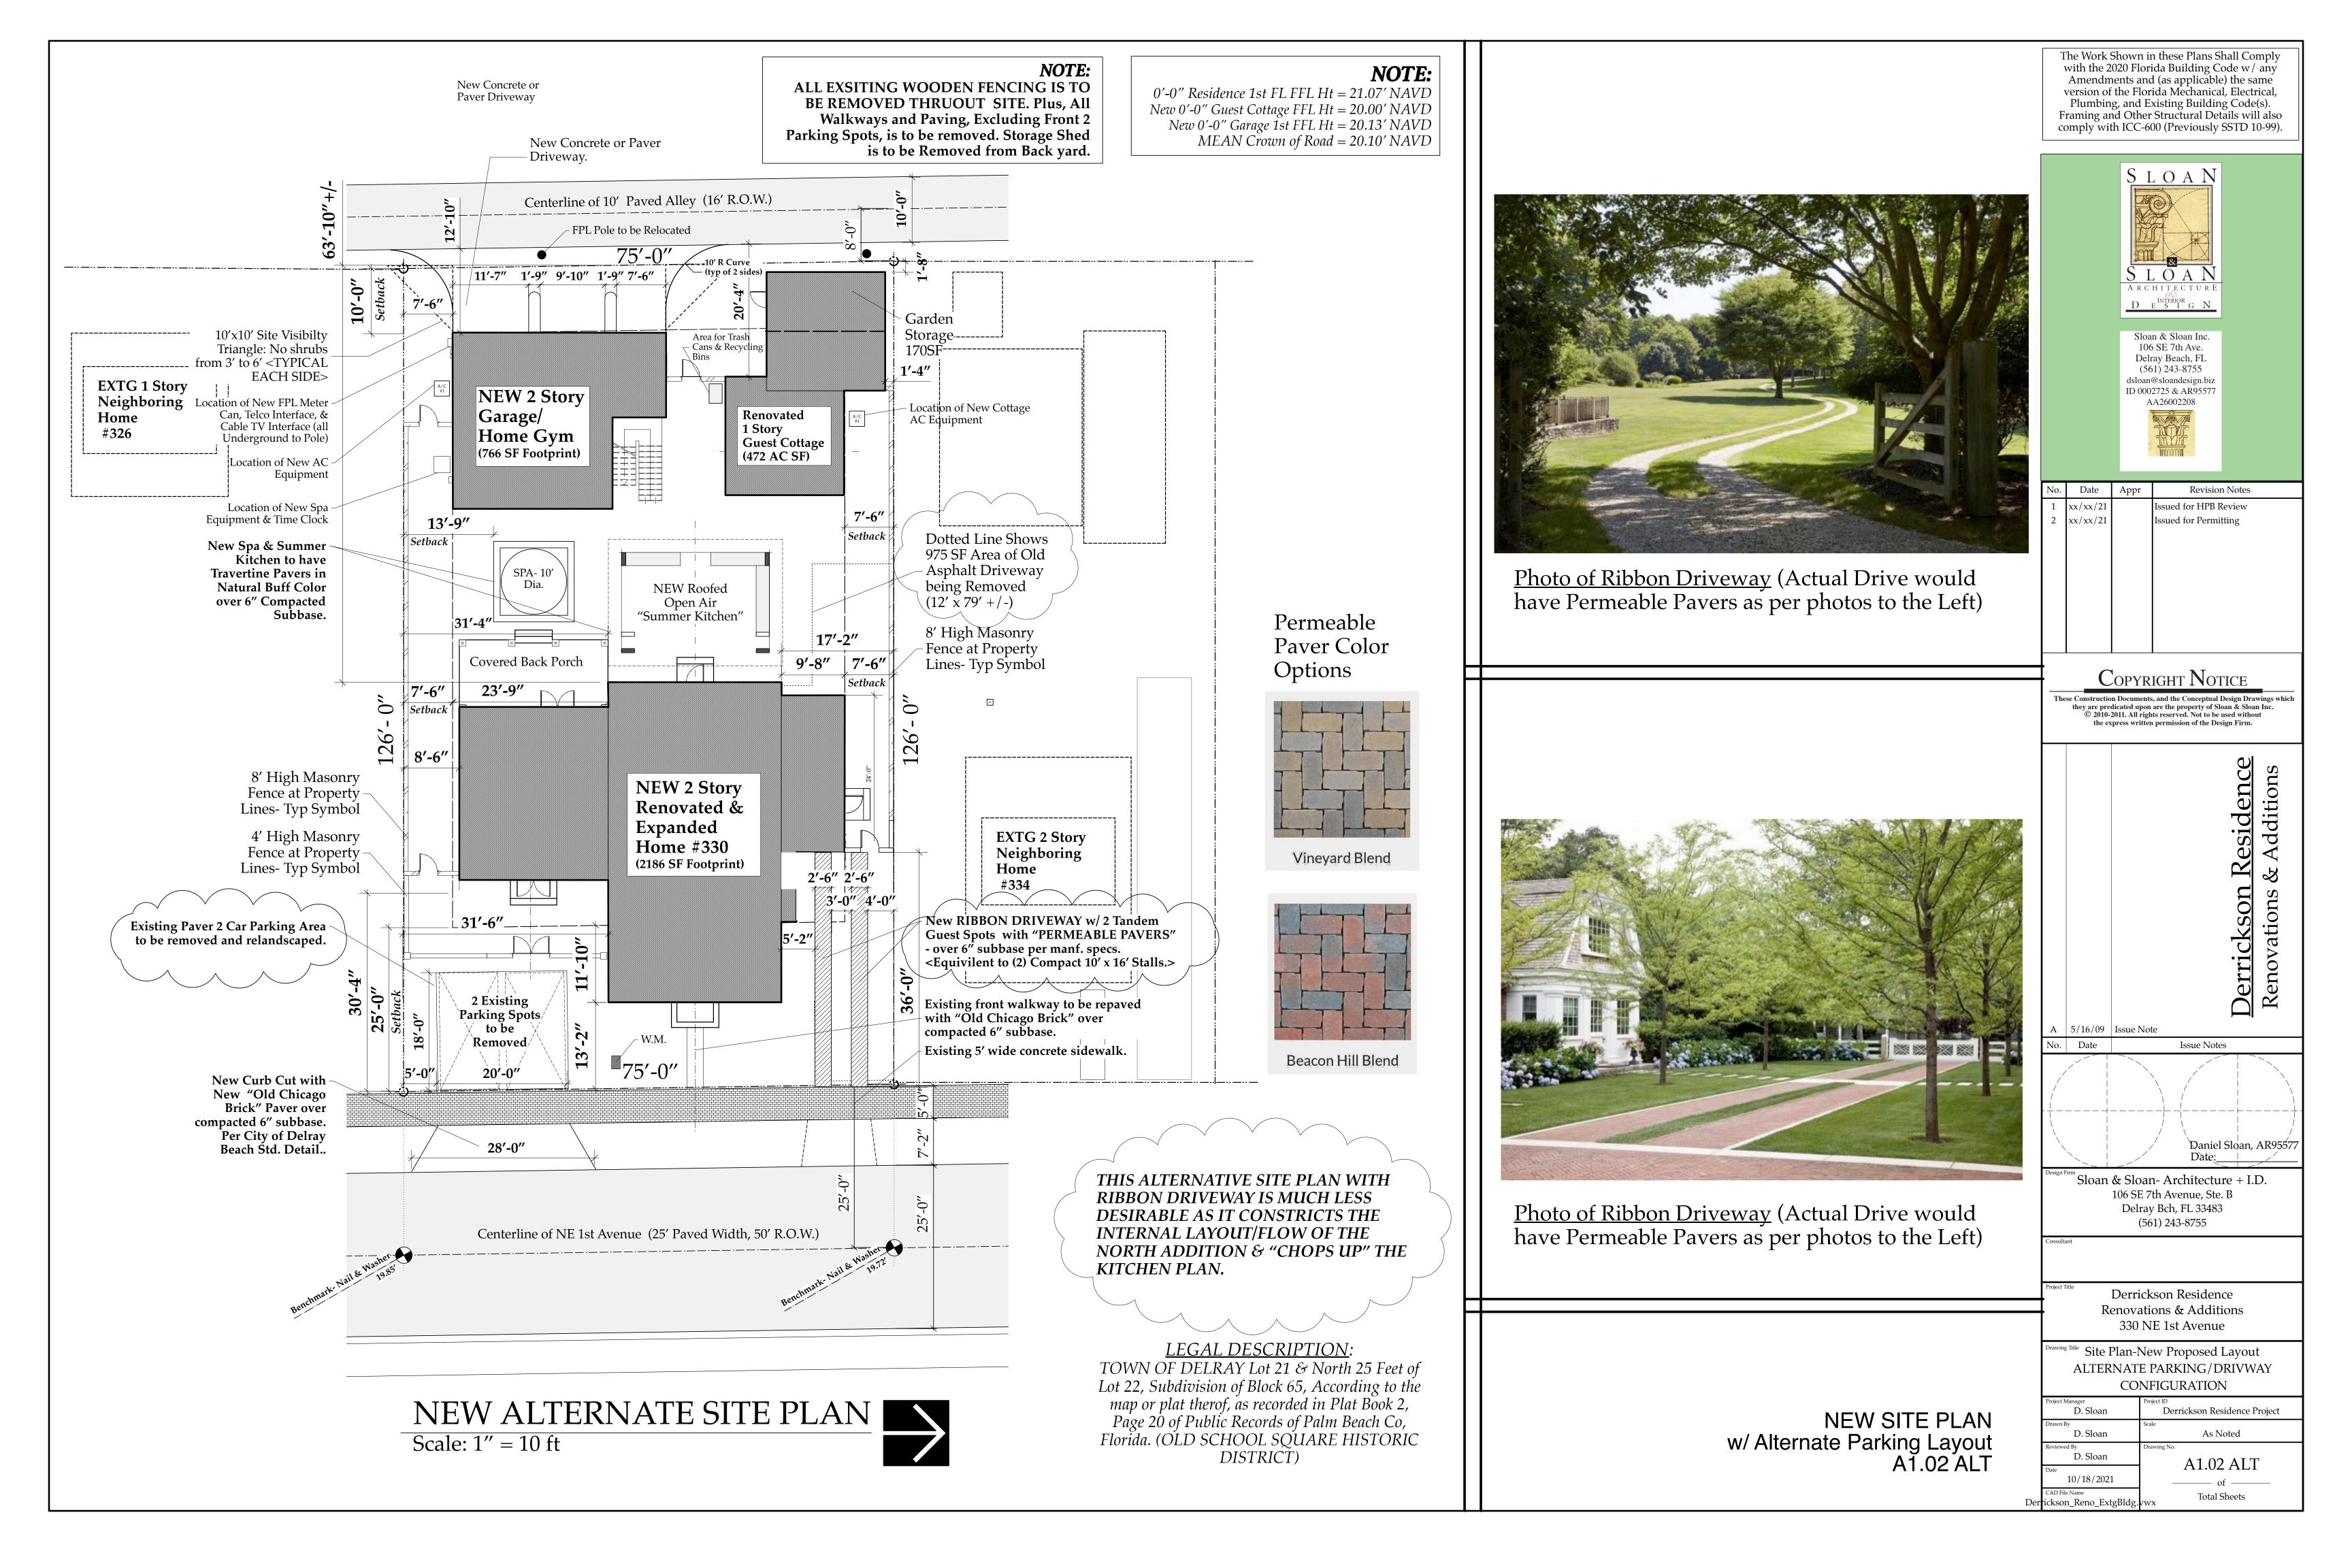
SITE PLAN Exsiting Conditions A1.01

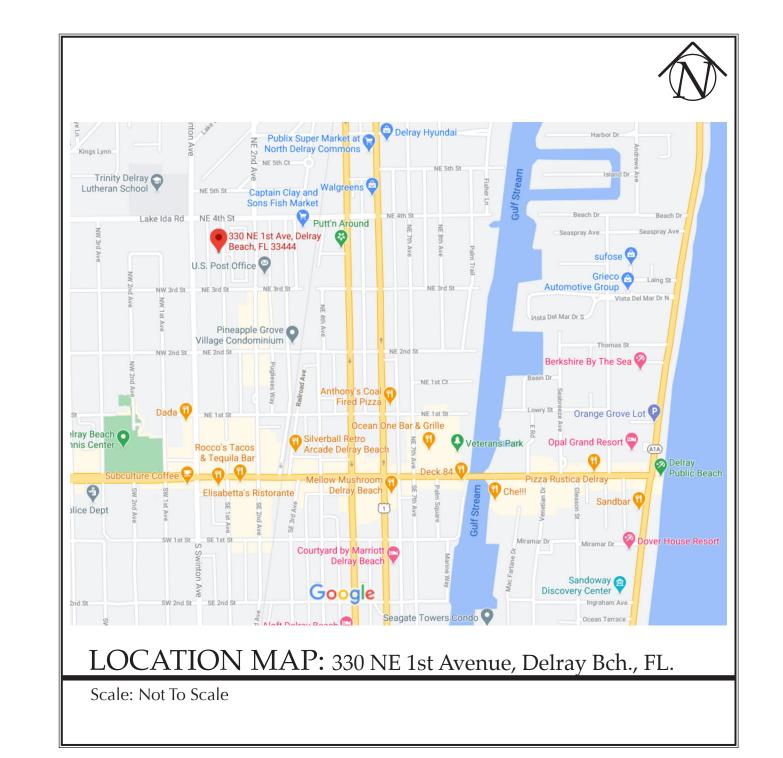
Derrickson Residence Renovations & Additions 330 NE 1st Avenue

Site Plan-Extg Conditions

D. Sloan Derrickson Residence Project D. Sloan As Noted D. Sloan A1.01 10_18_21 **Total Sheets**





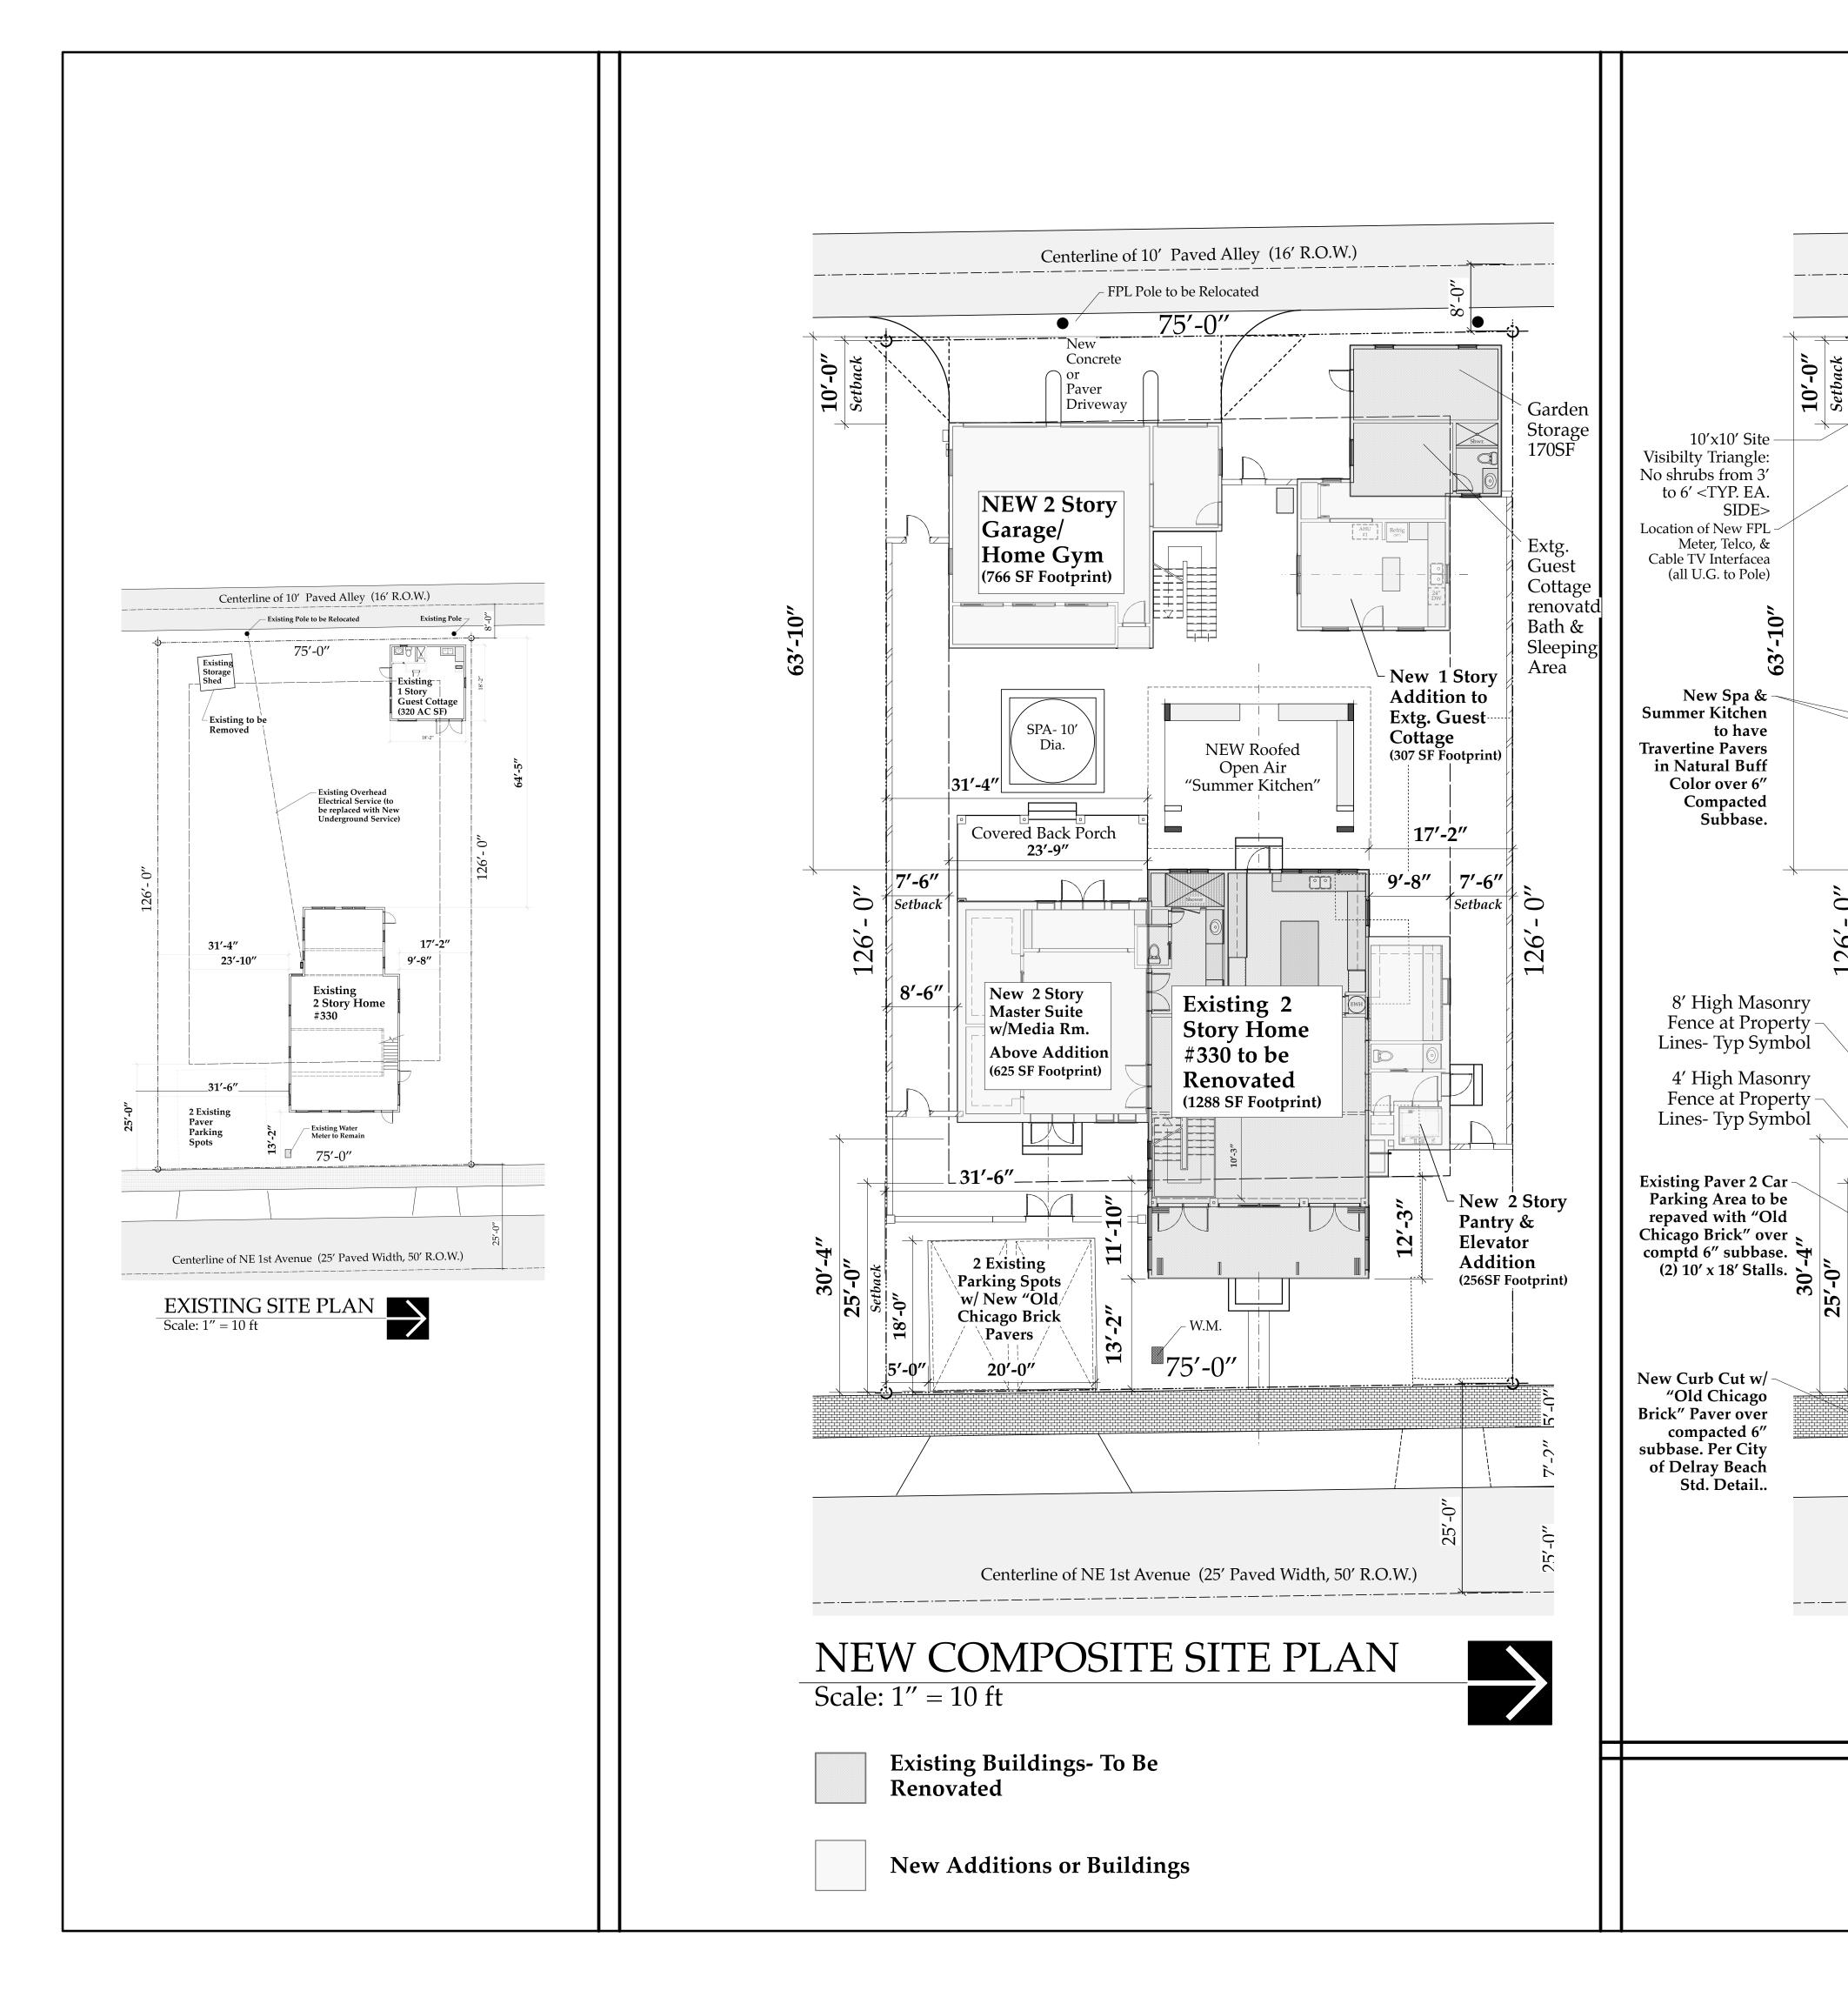

NOTE:

Garden

Storage

0'-0" Residence 1st FL FFL Ht = 21.07' NAVD *New 0'-0" Guest Cottage FFL Ht* = 20.00' *NAVD* New 0'-0" Garage 1st FFL Ht = 20.13' NAVD MEAN Crown of Road = 20.10' NAVD

Centerline of 10' Paved Alley (16' R.O.W.)

FPL Pole to be Relocated

75′-0′

- Cans & Recycling

NEW Roofed

Open Air

"Summer Kitchen"

NEW 2 Story

Renovated &

Expanded

¹75'-0''

Centerline of NE 1st Avenue (25' Paved Width, 50' R.O.W.)

Old Curb Cut- to be

removed

Home #330

(2186 SF Footprint)

Renovated

(472 AC SF)

Guest Cottage

17'-2"

0

Concrete

Driveway

Paver

NEW 2 Story

Home Gym

(766 SF Footprint)

SPA- 10'

Covered Back Porch

23'-9"

Garage/

 $\frac{10'}{Setb}$

Ó

126′

Setback

∟31′**-**6″

2 Existing

Parking Spots w/ New "Old/


Chicago Brick

Pavers

20'-0"

to have

The Work Shown in these Plans Shall Comply with the 2020 Florida Building Code w/ any Amendments and (as applicable) the same version of the Florida Mechanical, Electrical, Plumbing, and Existing Building Code(s). Framing and Other Structural Details will also comply with ICC-600 (Previously SSTD 10-99).

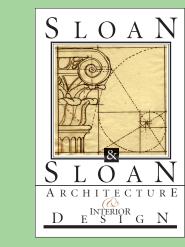

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A | 5/16/09 | Issue Note No. Date Issue Notes Daniel Sloan, AR9557

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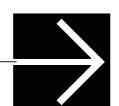
> Derrickson Residence Renovations & Additions 330 NE 1st Avenue

Composite Site Plan-Extg & New Proposed Layouts

Derrickson Residence Project D. Sloan D. Sloan As Noted D. Sloan A1.03 10/18/2021 **Total Sheets** Derrickson_Reno_ExtgBld

NEW SITE PLAN Scale: 1'' = 10 ft

DISTRICT)



LEGAL DESCRIPTION: TOWN OF DELRAY Lot 21 & North 25 Feet of Lot 22, Subdivision of Block 65, According to the map or plat therof, as recorded in Plat Book 2, Page 20 of Public Records of Palm Beach Co, Florida. (OLD SCHOOL SQUARE HISTORIC

.0.

COMPOSITE SITE PLAN Existing & Proposed Layouts A1.03

Existing front walkway to be repaved with "Old Chicago Brick" over

compacted 6" subbase




Aerial Photo: 326 thru 338 NE 1st Avenue, Delray Beach



326 NE 1st Avenue- East Facade (View from Street)



330 NE 1st Avenue- East Facade (View from Street)

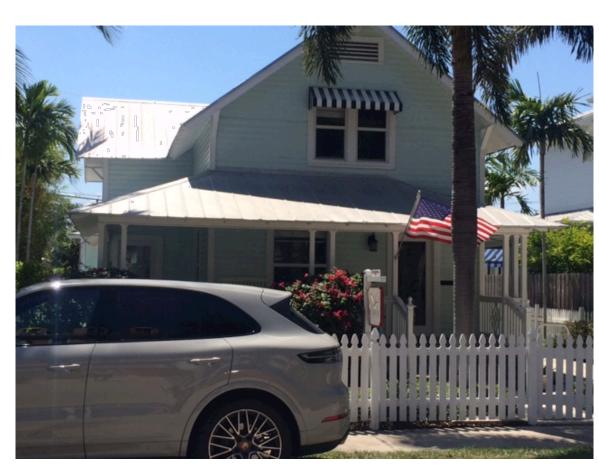


334NE 1st Avenue- East Facade (View from Street)



338 NE 1st Avenue- East Facade (View from Street)

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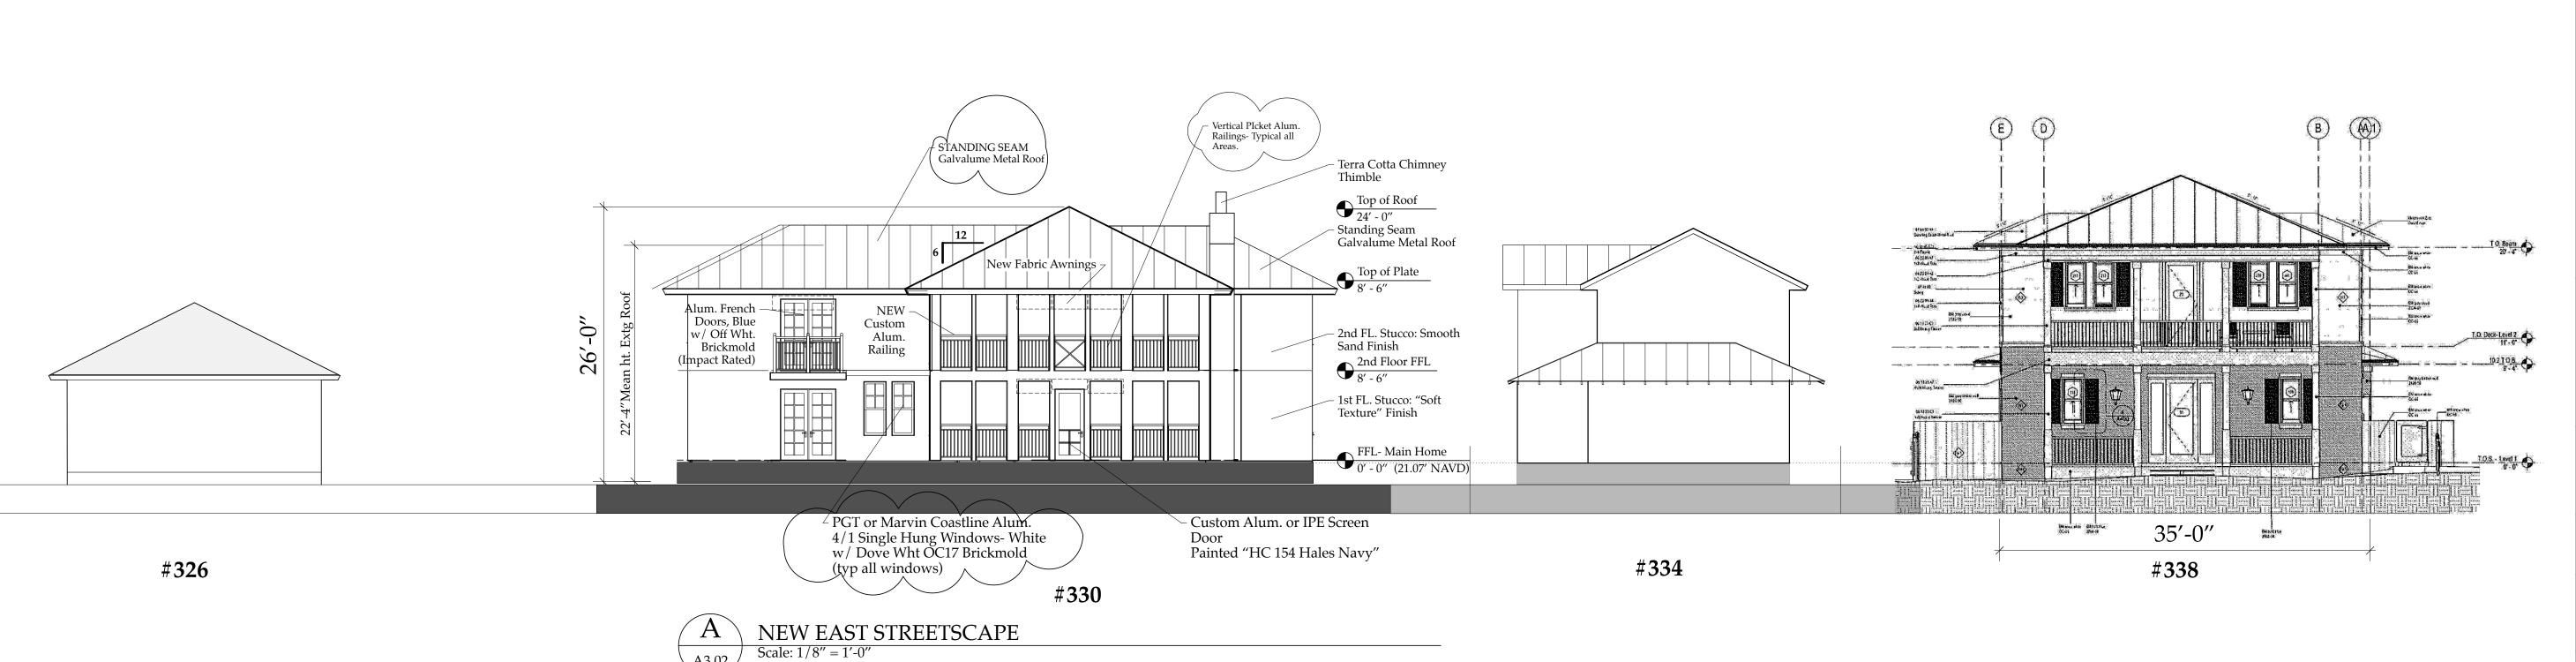
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SITE VIEWS & New Proposed Streetscape A1.04 Derrickson Residen
Renovations & Addition

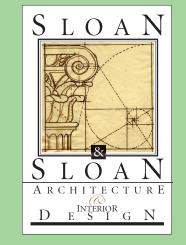A 5/16/09 Issue Note

No. Date Issue Notes

Daniel Sloan, AR9557

Date:


Design Firm Sloan & Sloan- Architecture + I.D.


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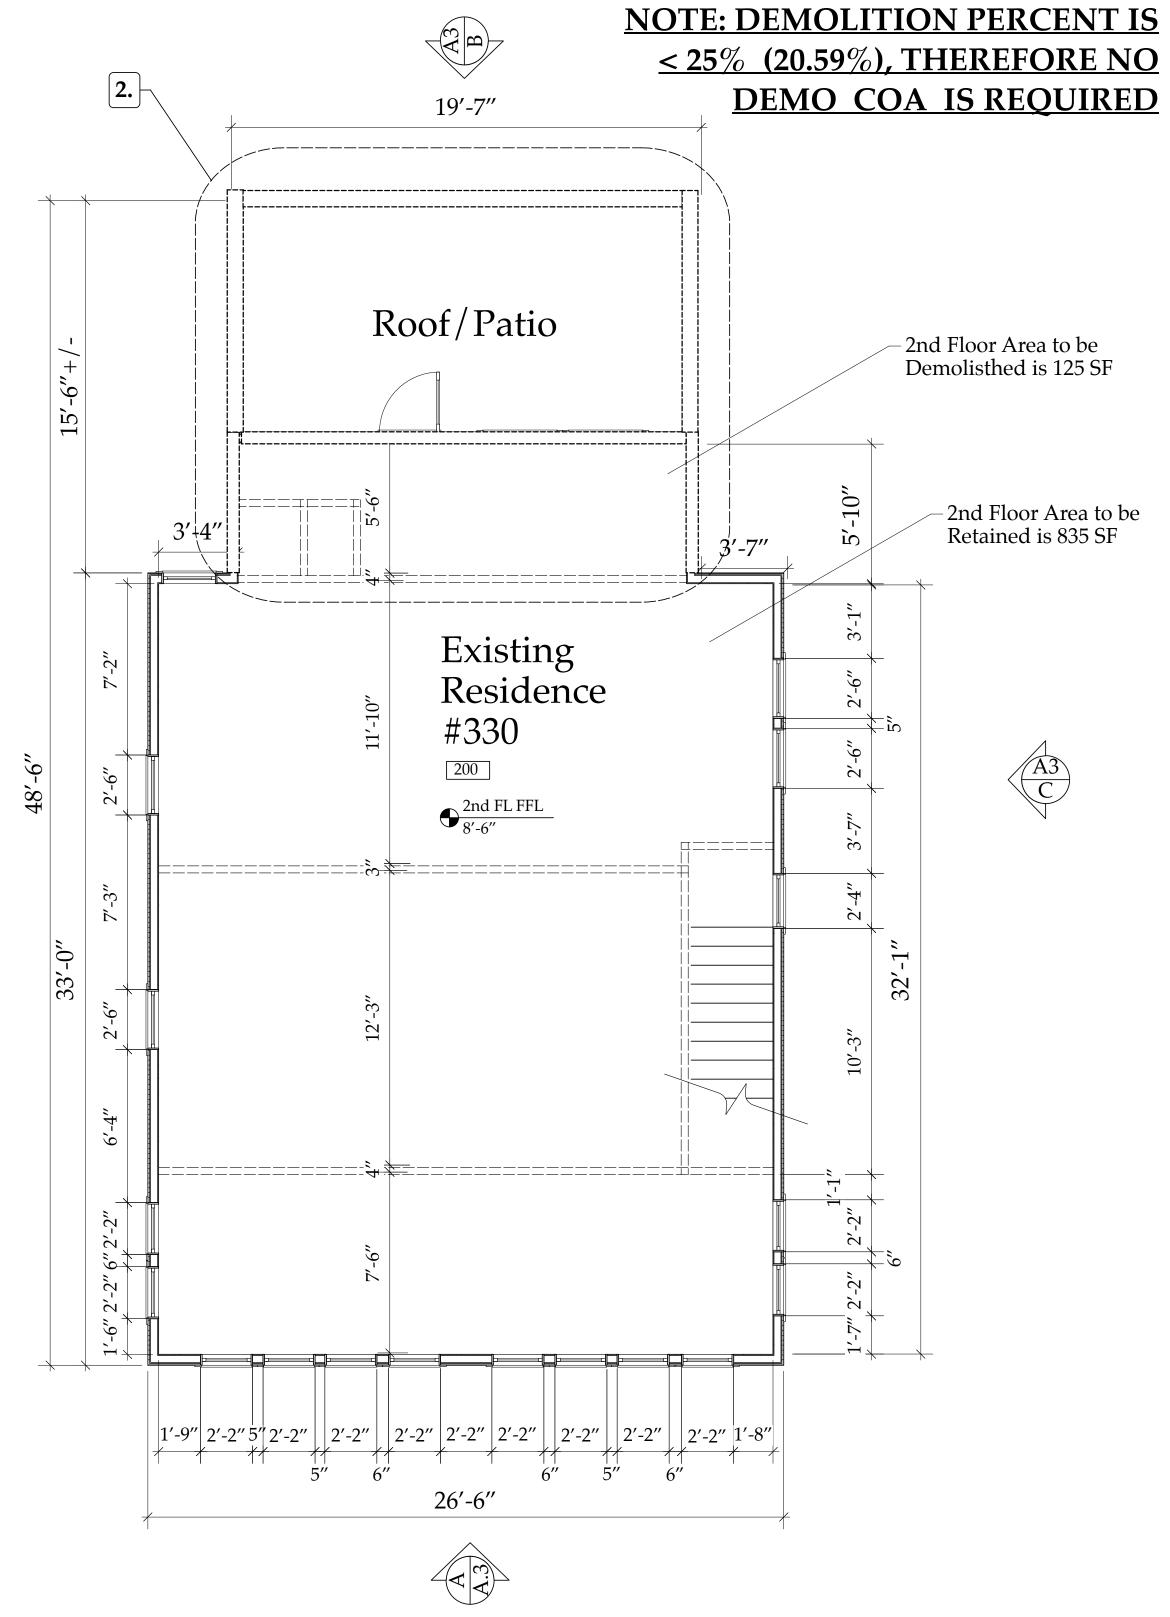
> Derrickson Residence Renovations & Additions

> > 330 NE 1st Avenue

Proposed Streetscape
-NE 1st Ave View
328 to 338 NE 1st Ave Homes



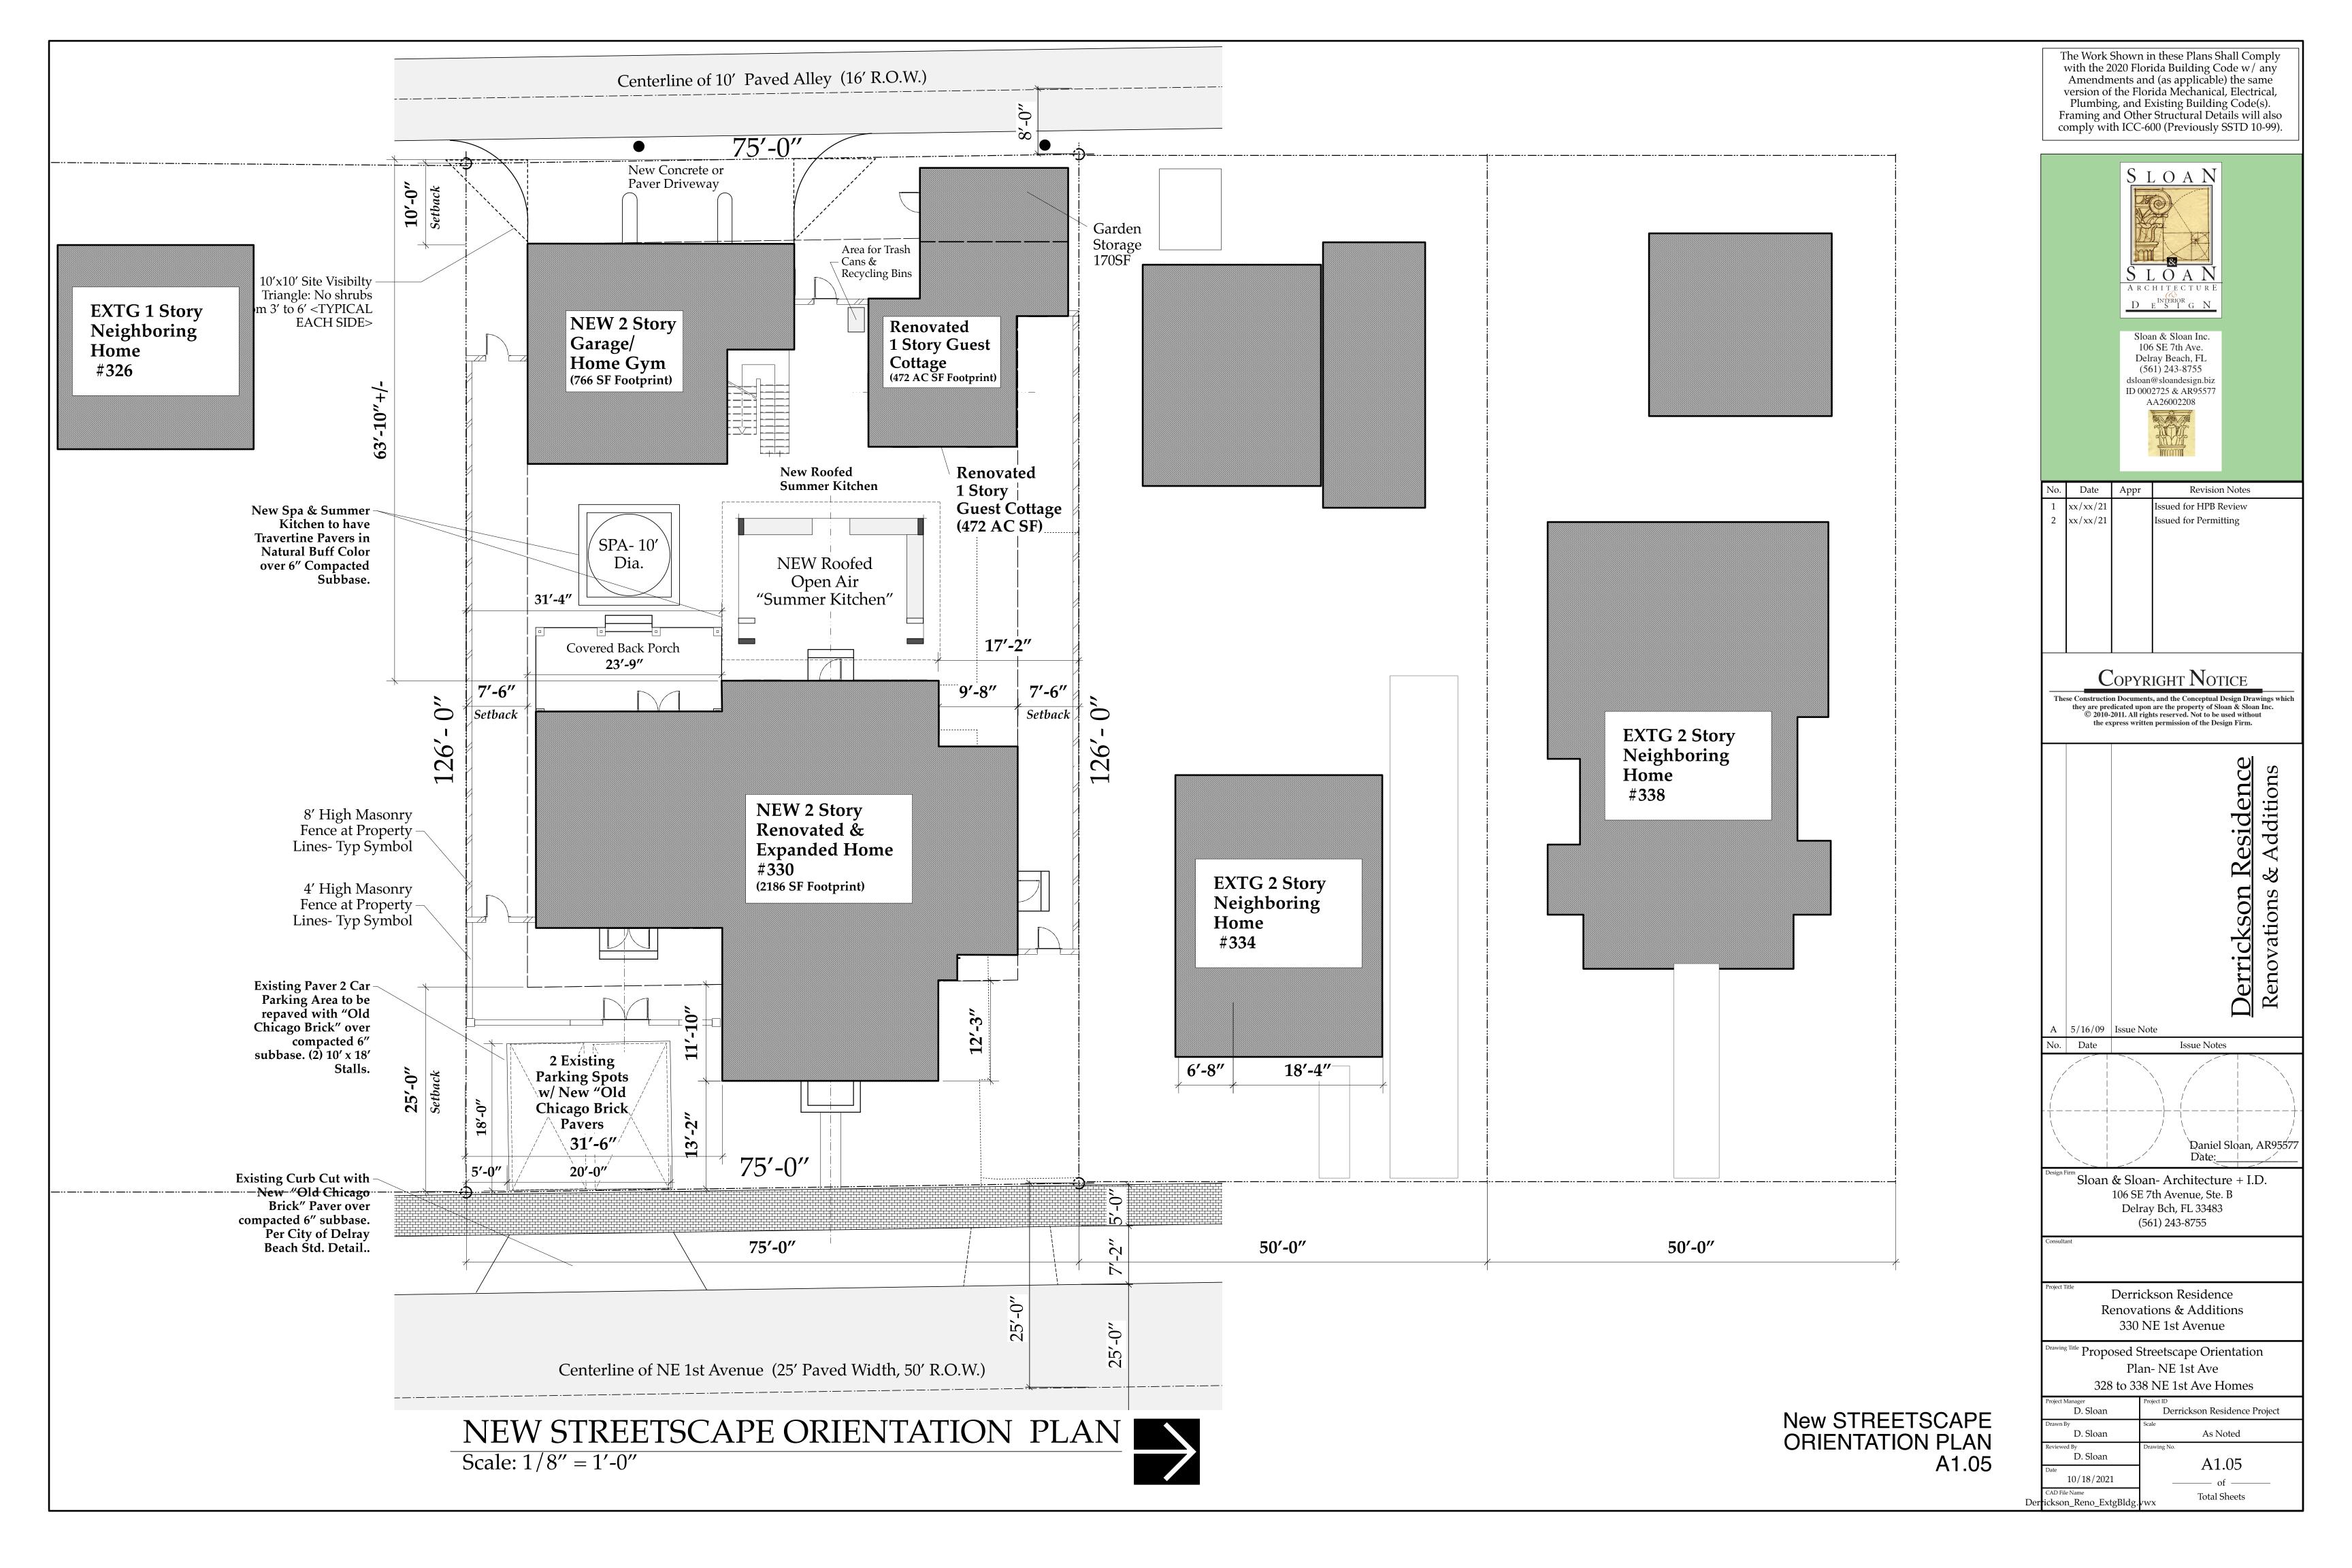

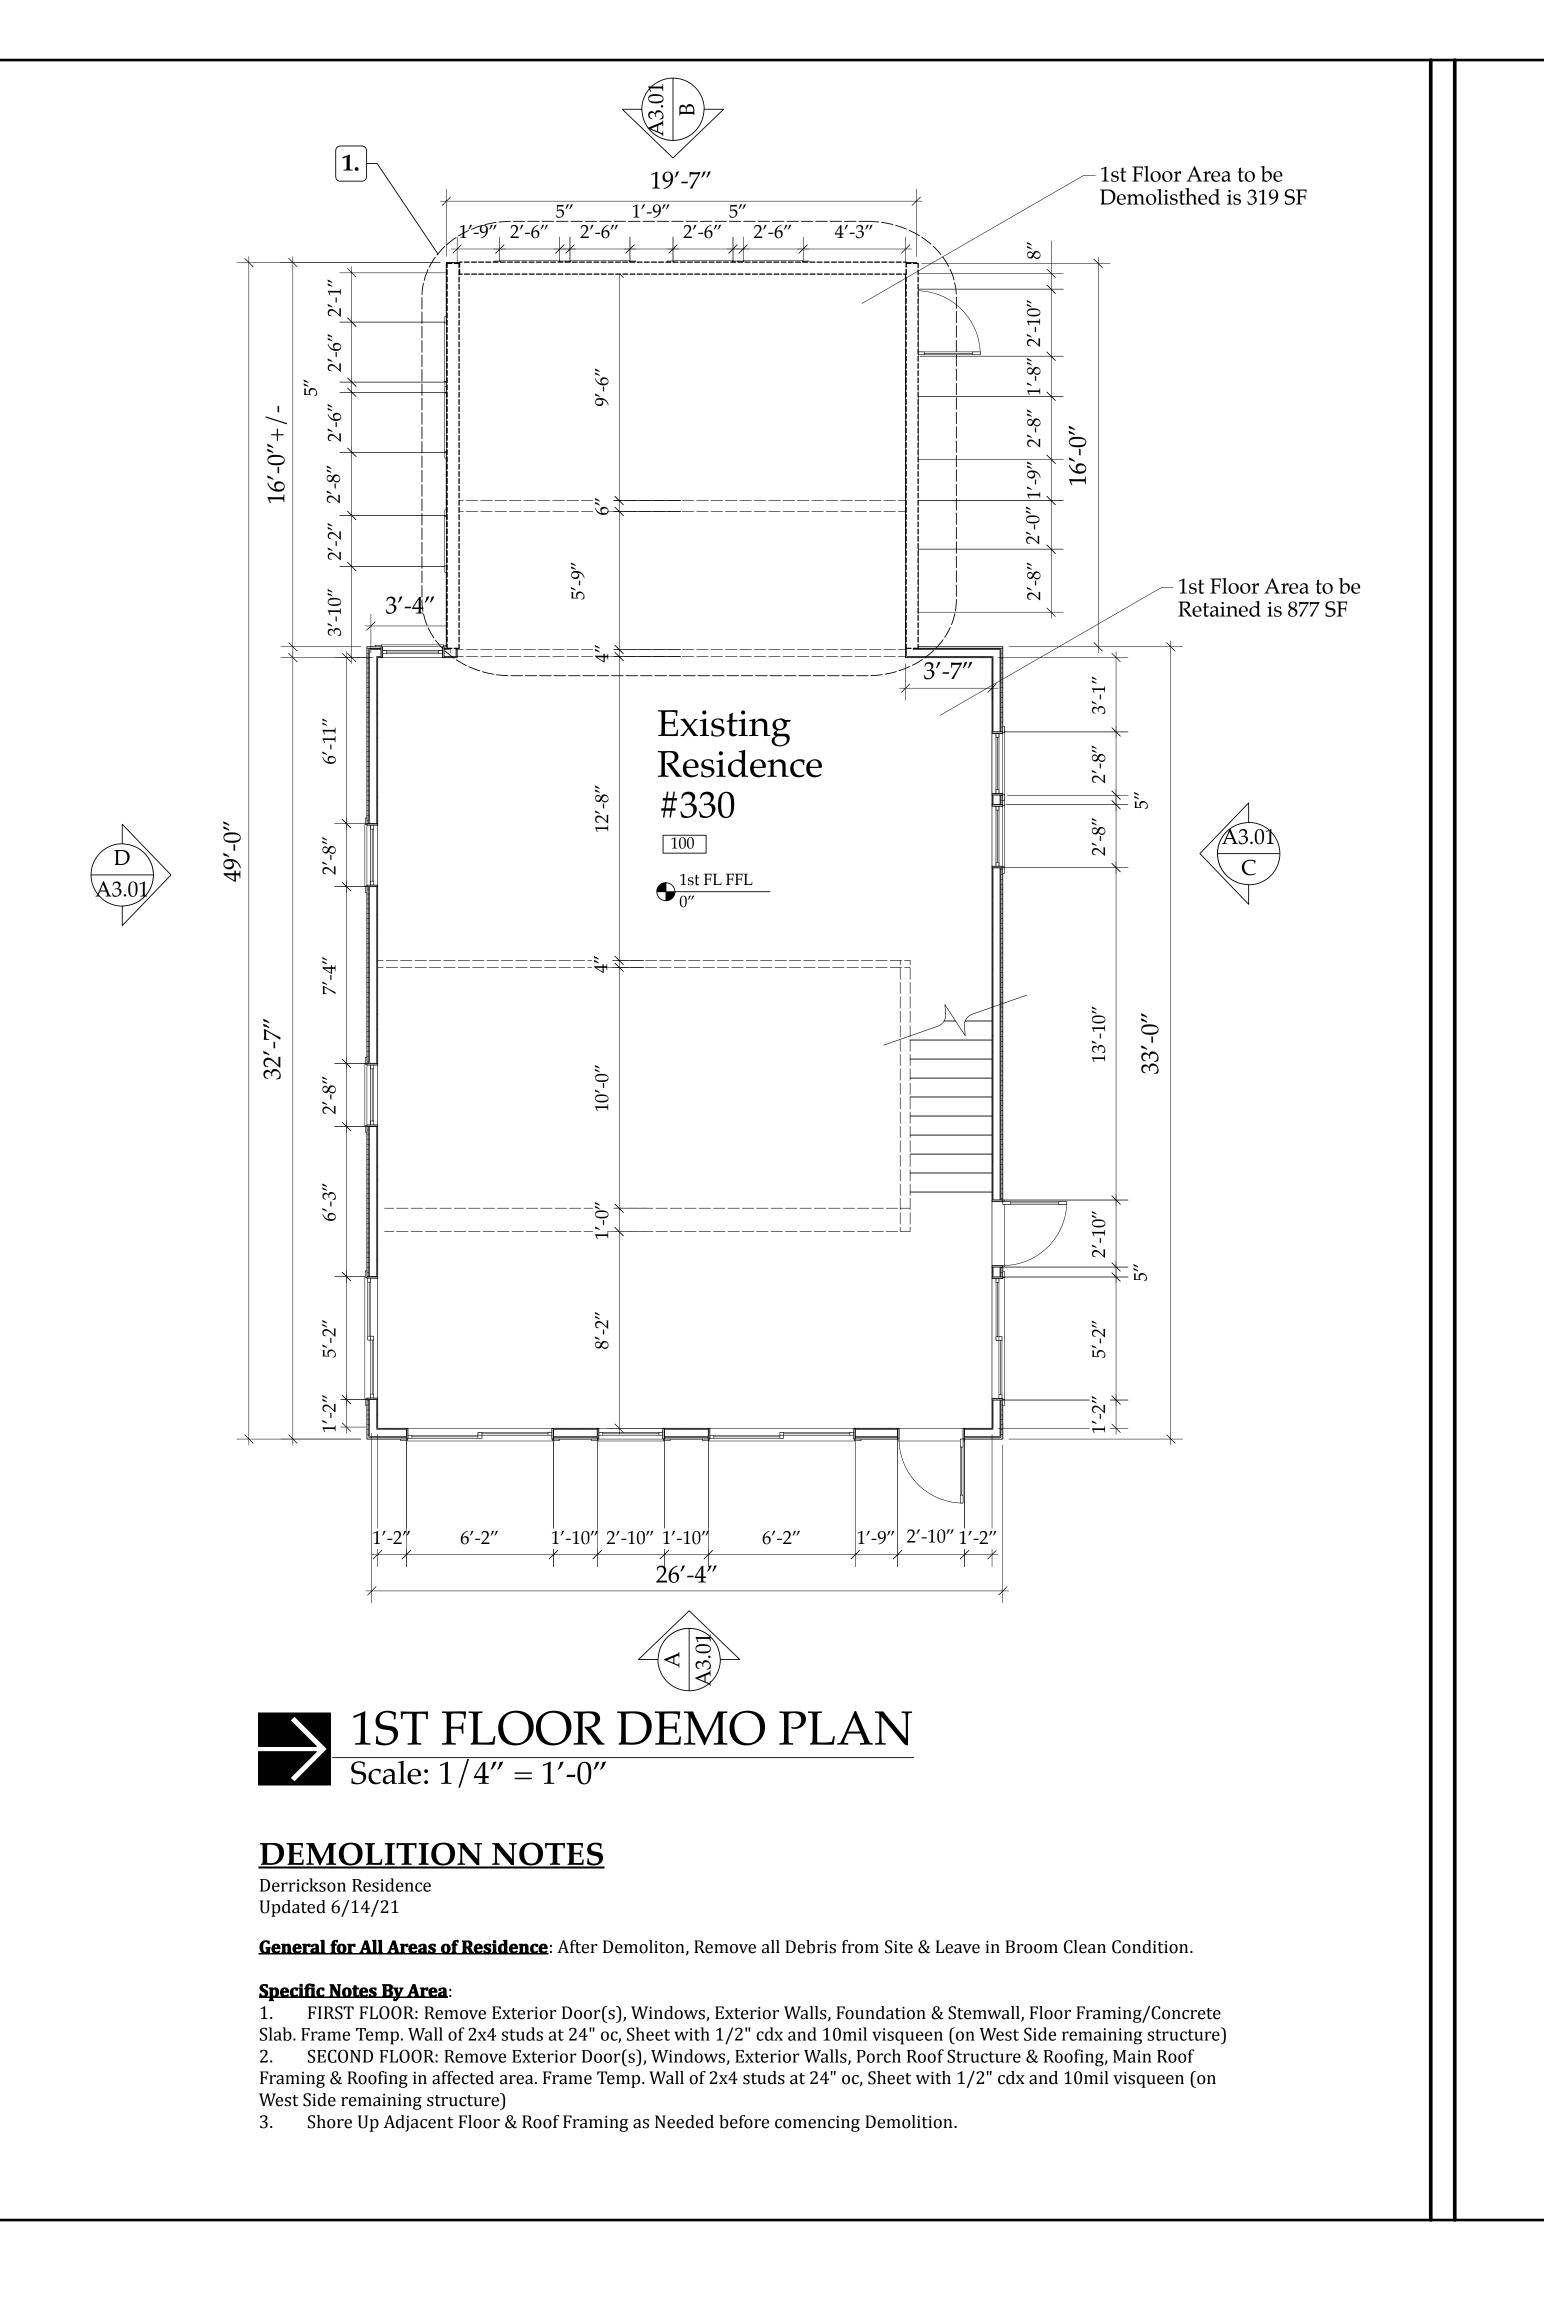

SECOND FLOOR DEMO PLAN

Scale: 1/4" = 1'-0"

Derrickson Residence 330 NE 1st Avenue, Delray Beach, FL Demolition Tabulations- revised 8/14/2021 Zoning: Single Family: OSSHAD File: Derrickson_SiteTblns&DsnParamtrs.xls

(EXISTING Measurement or Quantity) # ITEM AREA (SF)


1 Existing First Floor Area 1196 SF 2 Existing Second Floor Area 960 SF 3 Grand Total Existing Floor Area Under Roof 2156 SF 319 SF 4 Proposed First Floor Area to be DEMOLISHED 5 Proposed 2nd Floor Area to be DEMOLISHED 125 SF 6 Grand Total Floor Area To be DEMOLISHED 444 SF

PECENT OF BUILDING TO BE DEMOLISHED IS..... 20.59%

NOTE: Reframe all Window & Door Openings as needed to Accomodate New Floor **Plan Configuration**

Demolition Plans

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Daniel Sloan, AR9557

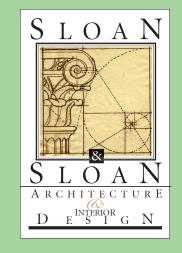
Derrickson Residence Renovations & Additions

330 NE 1st Avenue

DEMOLITION PLANSof Main Residence

D. Sloan Derrickson Residence Project D. Sloan As Noted D. Sloan A2.01.1 8/16/2021 **Total Sheets** Der ickson_Reno_ExtgBlds


A2.01.1

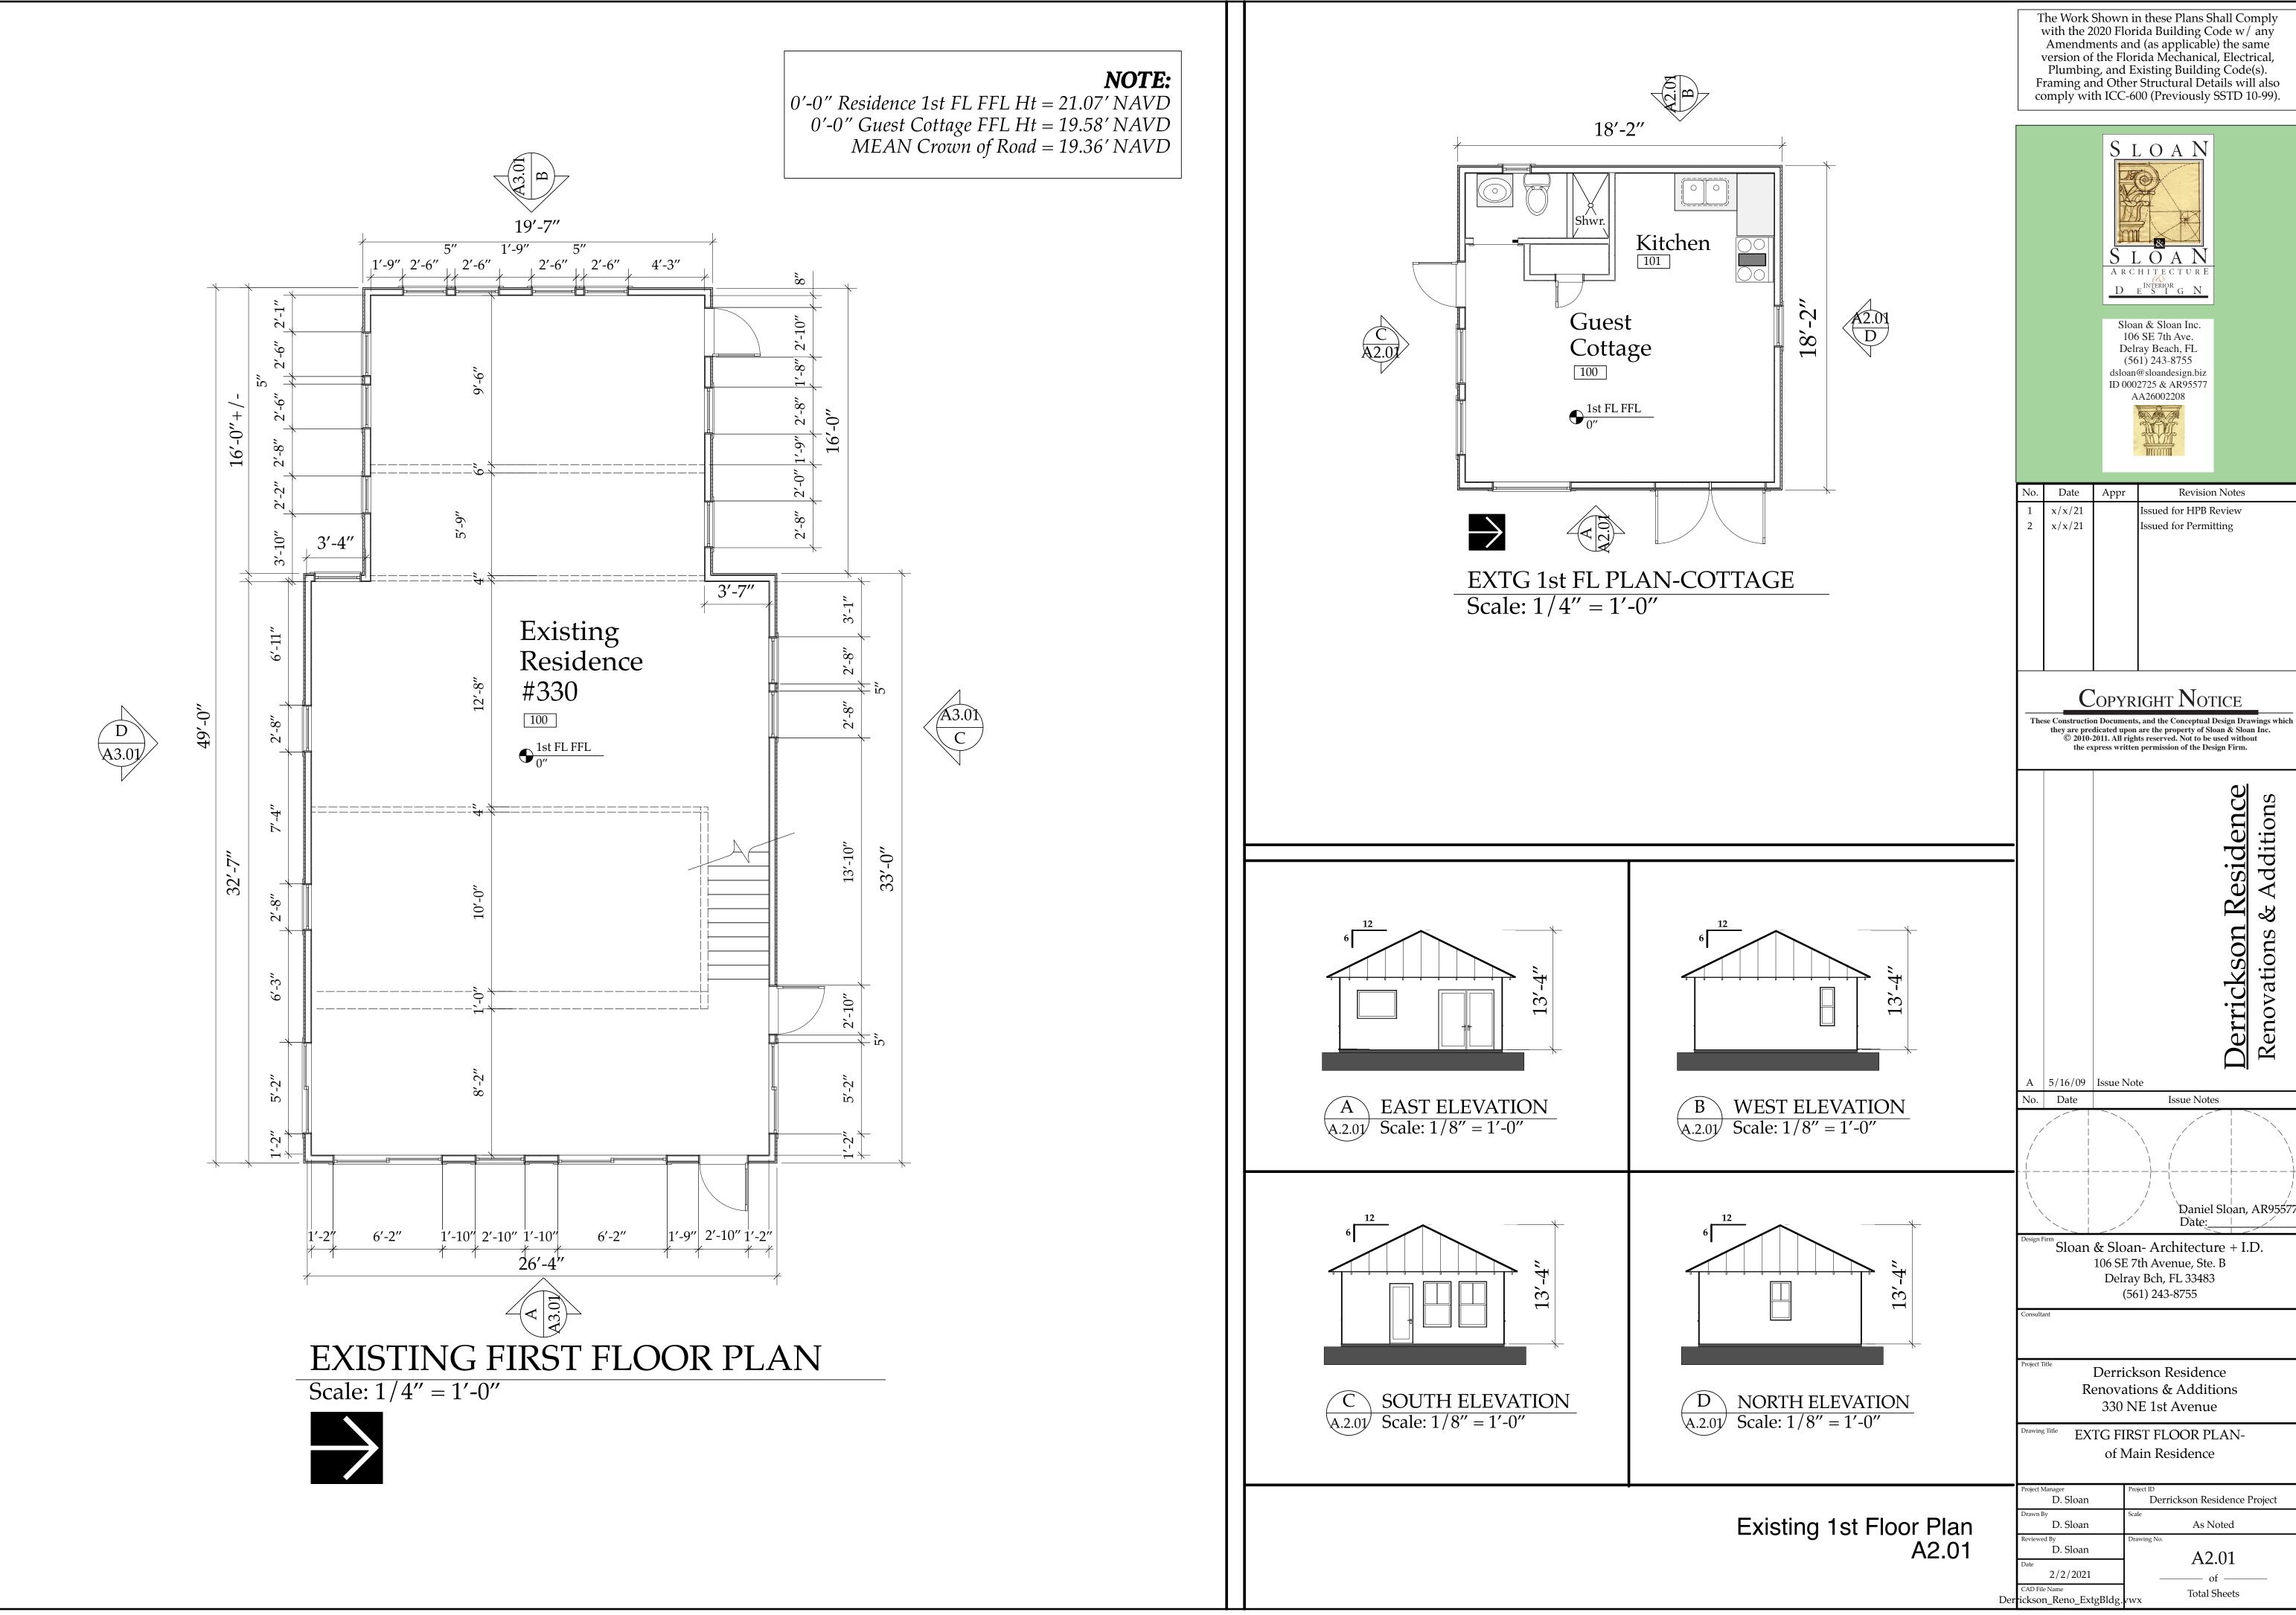

No.	Date	Appr	Revision Notes
1	x/x/21		Issued for HPB Review
2	x/x/21 $x/x/21$		Issued for Permitting

Daniel Sloan, AR95577 Date:

Project Manager	Project ID
D. Sloan	Derrickson Residence Project
Drawn By	Scale
D. Sloan	As Noted
Reviewed By	Drawing No.
D. Sloan	A2.01
Date	A2.01
2/2/2021	of
CAD File Name	m + 1.01 +

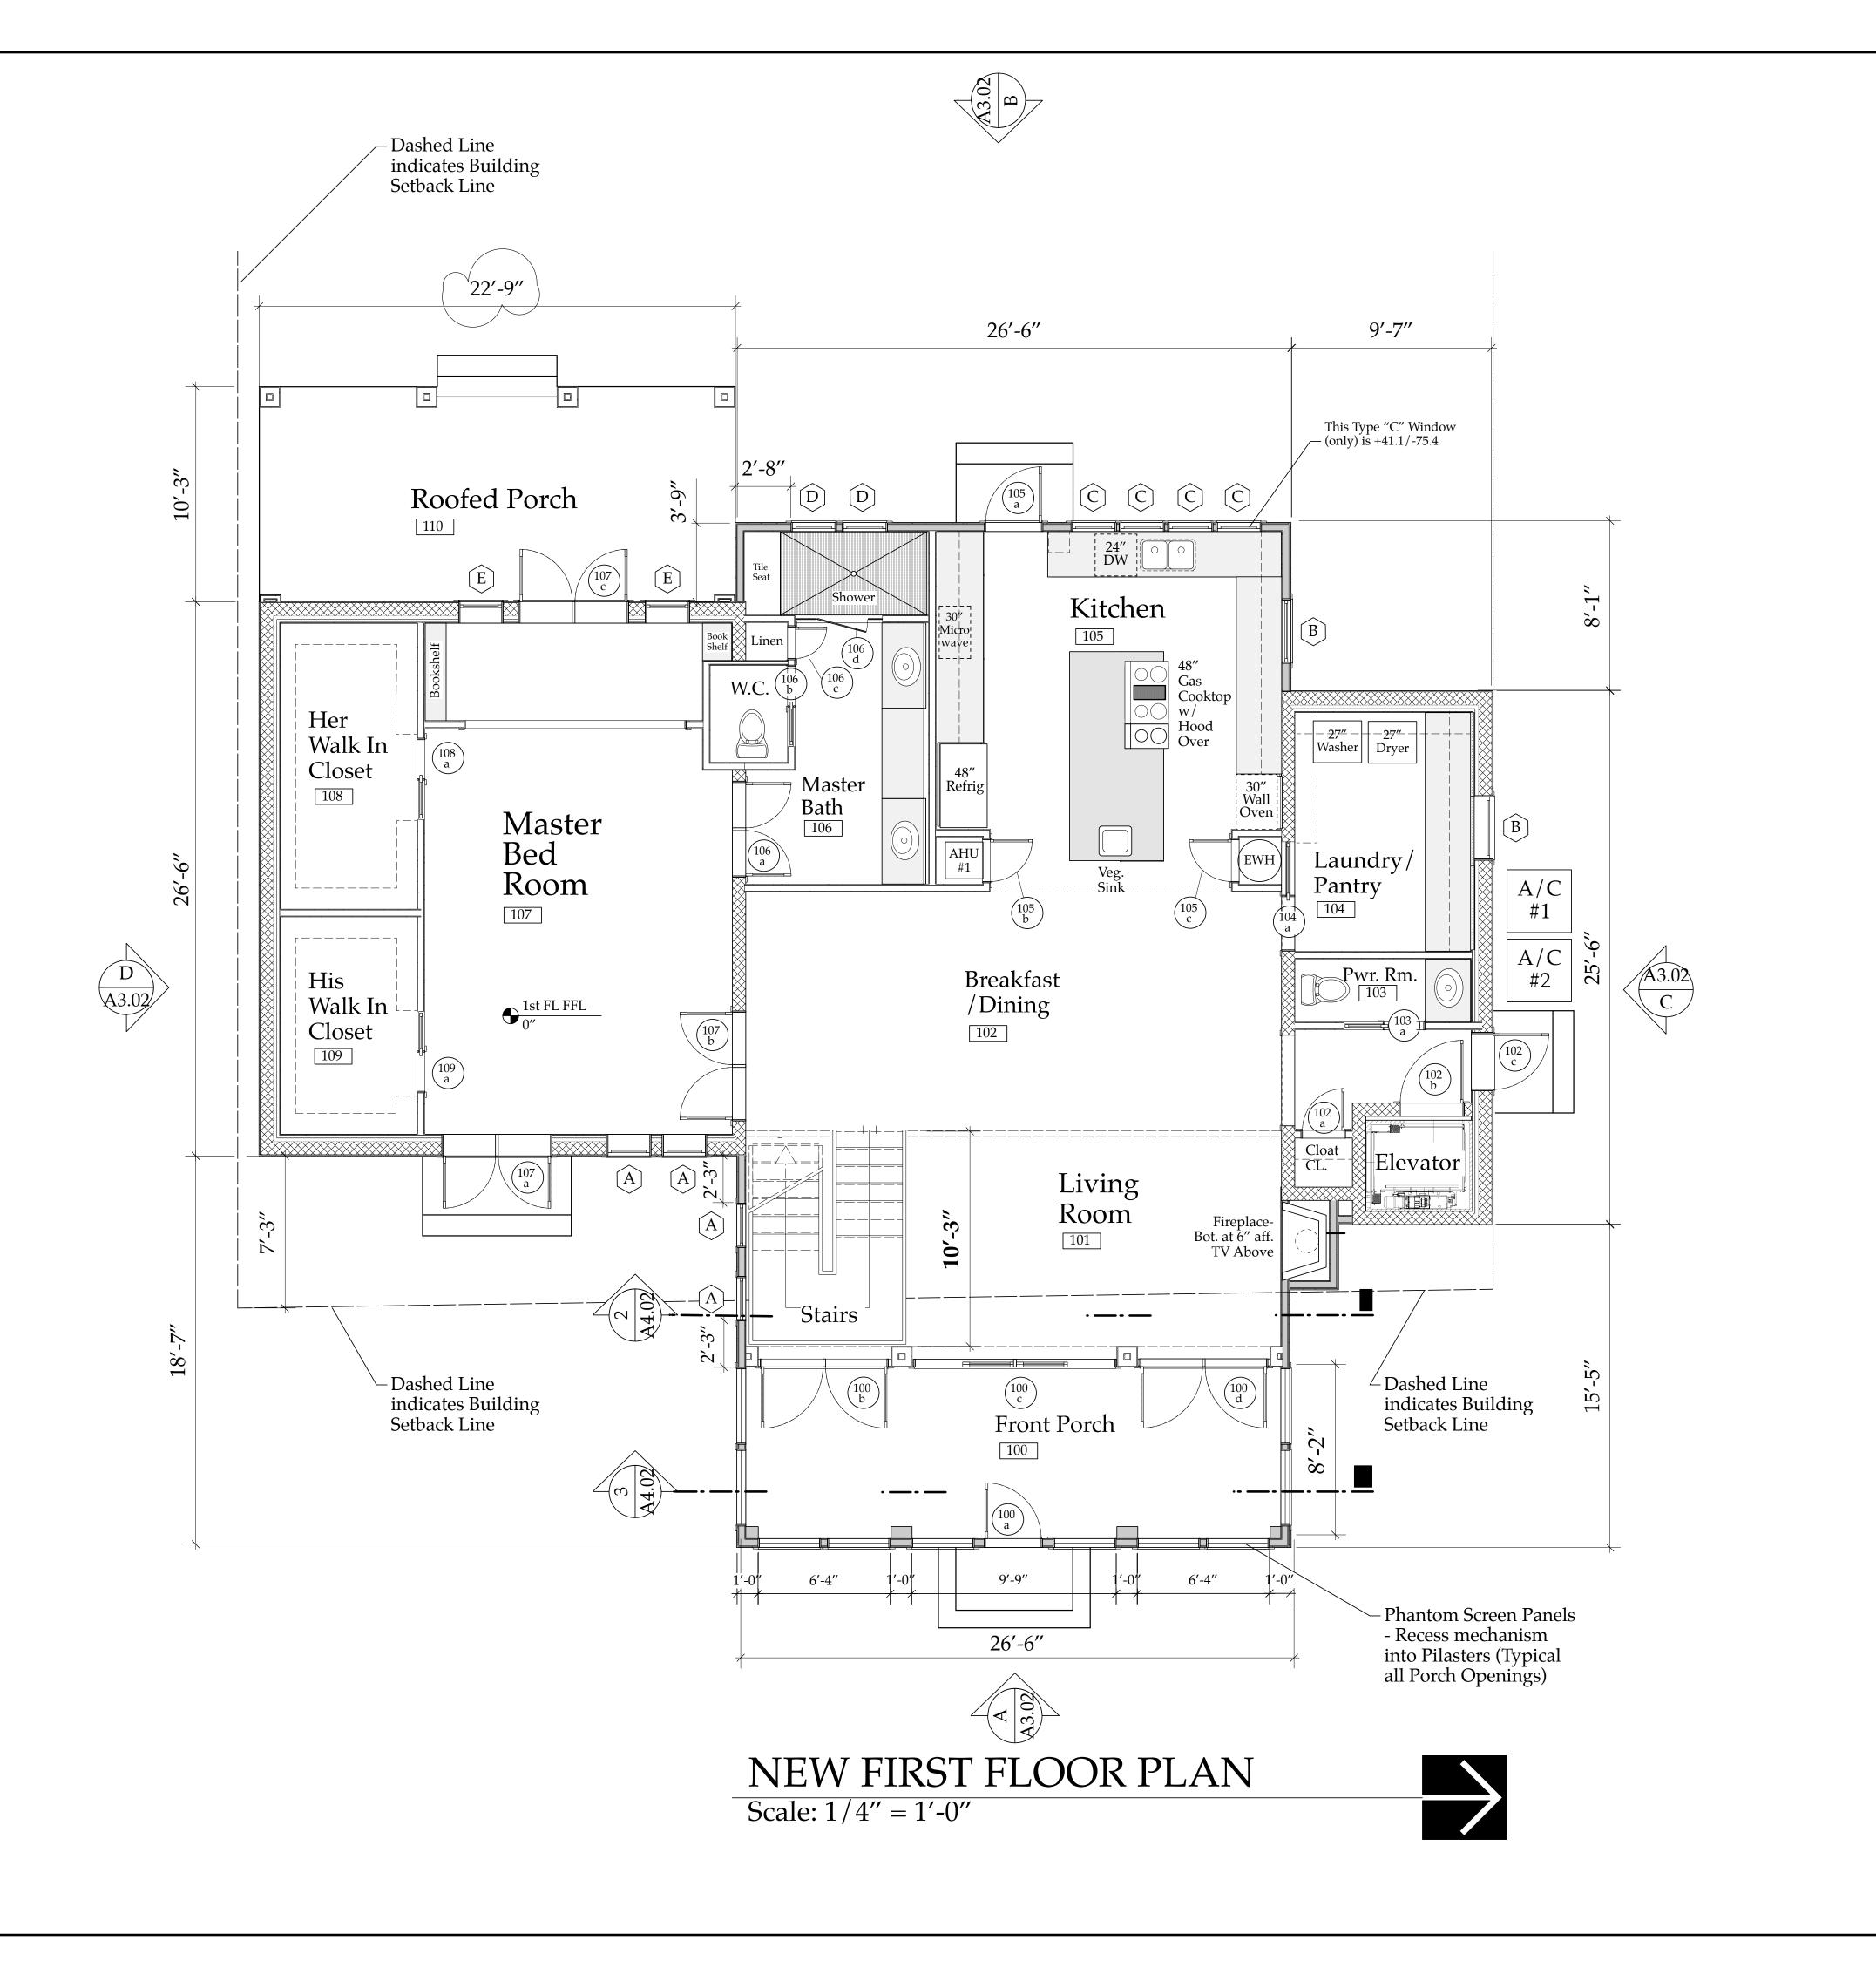


NOTE:

NOTE:

NOTE: 0'-0'' Residence 1st FL FFL Ht = 21.07' NAVD

With the 2020 Florid Amendments and version of the Florid Plumbing, and Exist Framing and Other States.

New 0'-0" Guest Cottage FFL Ht = 20.00' NAVD New 0'-0" Garage 1st FFL Ht = 20.13' NAVD MEAN Crown of Road = 20.10' NAVD The Work Shown in these Plans Shall Comply with the 2020 Florida Building Code w/ any Amendments and (as applicable) the same version of the Florida Mechanical, Electrical, Plumbing, and Existing Building Code(s). Framing and Other Structural Details will also comply with ICC-600 (Previously SSTD 10-99).

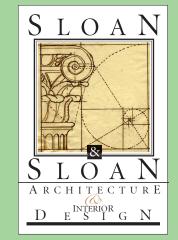

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5/16/09	Issue Note		Derrickson Residence Renovations & Additions
Date	1004011010	Issue Notes	
/ 			

Daniel Sloan, AR9557
Date:
Sloan & Sloan- Architecture + I.D.
106 SE 7th Avenue, Ste. B
Delray Bch, FL 33483

Consultant

Derrickson Residence Renovations & Additions 330 NE 1st Avenue

(561) 243-8755

NEW FIRST FLOOR PLANof Main Residence

	Project Manager	Project ID
	D. Sloan	Derrickson Residence Project
	Drawn By	Scale
	D. Sloan	As Noted
	Reviewed By	Drawing No.
	D. Sloan	A2.02
	Date	A2.02
	10/18/2021	of
	CAD File Name	Total Sheets
Der	ickson Reno ExtgBldg.	wx

New 1st Floor Plan-MAIN RESIDENCE A2.02 6/18/21 Derrickson_DOOR Schedule.xls 2:11 PM

	DOOR SIZE/TYPE		CONST.	FINISH		Hardware TYPE	Hardware Style & Finish			Rating per manf	
)0a	2868 Prehung Screen Door	Cusom	1 1/8" Composite	Hales Navy HC154	3/4 Composite Wd. prehung	IR2	TBS	TBS		N/A	N/A
00b	Double 3068 Alum. French Doors w/ 1 Light- IMPACT RATED	PGT Window Co. Mod. FD750 "WinGuard"	"Energy Max" Low E, Laminated Insulated Glass	Powdercoated Black Factory Finish	SS Tapcons	EMTEK (model TBS) Plate in SS Schlage Keyway (Lever & Deadbolt)	EMTEK (model TBS) Lever & Dummy on Inactive side		Impact Rated- Provide NOA.	+70/-80	+37.1/-65
00c	9868 Alum. BiFold French Doors w/ 1 Light- IMPACT RATED (Custom to Fit Exact RO)	4 panel Bi-Fold	"Energy Max" Low E, Laminated Insulated Glass	Powdercoated Black Factory Finish	SS Tapcons	EMTEK (model TBS) Plate in SS Schlage Keyway (Lever & Deadbolt)	EMTEK (model TBS) Lever & Dummy on Inactive side	Marvin Factory Installed	Impact Rated- Provide NOA.	+70/-80	+40.5/-45
00d	Doubl 3068 Alum. French Doors w/ 1 Light- IMPACT RATED	PGT Window Co. Mod. FD750 "WinGuard"	"Energy Max" Low E, Laminated Insulated Glass	Powdercoated Black Factory Finish	Alum.: install w/ SS Tapcons per NOA	EMTEK (model TBS) Plate in SS Schlage Keyway (Lever & Deadbolt)	EMTEK (model TBS) Lever & Dummy on Inactive side		Impact Rated- Provide NOA.	+70/-80	+37.1/-65
02a	2068 Prehung Door	Plantation Style 2" Lvrd	1 3/8" SOLID CORE	Painted- Color TBS	3/4 wood prehung	Passage Set	TBS	Bright Chr. US26	Casing TBS	N/A	N/A
02b	3068 Prehung Door	TBS	1 3/8" SOLID CORE	Painted- Color TBS	3/4 wood prehung	Passage Set	TBS		Inside Face to be Built out per Elevtr Code	N/A	N/A
02c	2868 Prehung Door Plaspro DRS2b IMPACT RATED	PlasPro 2 Panel	1 3/4" SOLID CORE	Painted-Dk Blue		EMTEK (model TBS) (Lever & Deadbolt)	TBS		Casing TBS/2" Composite Fla. Brickmold	+75/-75	+40.5/-45
03a	2068 Pocket Door	Composite	1 3/8" SOLID	Hales Navy HC154 Painted-	Wd. prehung 3/4 wood	TBS:: Flush Edge Pull	TBS		Casing TBS	N/A	N/A
040	in Cased Opening 2868 Pocket Door		CORE	Color TBS	prehung	PRIVACY SET	TDC		-	N/A	N/A
04a	2868 Pocket Door in Cased Opening 	TBS	1 3/8" SOLID CORE	Painted- Color TBS	3/4 wood Frame	TBS:: Flush Edge Pull Passage SET	TBS		Casing TBS	N/A	N/A
05a	2868 Alum. French Door w/ 5 Light- IMPACT RATED	PGT Window Co. Mod. FD750		Factory Black, Painted-Dk Blue	SS Tapcons	EMTEK (model TBS) Plate in SS	EMTEK (model TBS) Lever & Dummy on	PGT Factory Installed	Impact Rated- Provide NOA.	+70/-80	+37.1/-65
		"WinGuard"	Insulated Glass	Hales Navy HC154 on Outer Face	per NOA	Schlage Keyway (Lever & Deadbolt)	Inactive side				
05b	2068 Prehung Door	TBS- Solid Core W/ Weatherstrip'g	1 3/8" SOLID CORE	Painted- Color TBS	3/4 wood prehung	Passage Set	TBS	Bright Chr. US26	Casing TBS w/ Gasketed Threshold	N/A	N/A
05c	_ _2068 Prehung Door _	Plantation Style 2" Lvrd	1 3/8" SOLID CORE	Painted- Color TBS	3/4 wood prehung] Passage Set 	TBS	Bright Chr. US26	Casing TBS	N/A	N/A
06a	Double 2268 Doors	TBS	1 3/8" SOLID	Painted-	3/4 wood	TBS:: Privicay Lock w/	TBS	Bright Chr. US26	Casing TBS	N/A	N/A
06b	w/ T Astragal	TBS	CORE 1 3/8" SOLID	Color TBS Painted-	prehung 3/4 wood	matching dummy TBS:: Flush Edge Pull	TBS		Casing TBS	N/A	N/A
	in Cased Opening		CORE	Color TBS	Frame	PRIVACY SET					
06c	1668 Prehung Door (linen closet)		1 3/8" SOLID CORE	Painted- Color TBS	3/4 wood prehung	Passage Set	TBS	Bright Chr. US26	Casing TBS	N/A	N/A
06d	26" Frameless Shower Door w/Side Lights	Custom	Clear 1/2" Glass w/ sandblasted mo	desty Panel		D Handle Bright Chrome		Bright Chrome hinges and clips	By Shower Door Co.	N/A	N/A
07a	Dbl 2668 Alum. French Door w/ 5 Light- IMPACT RATED	PGT Window Co. Mod. FD750 "WinGuard"	"Energy Max" Low E, Laminated Insulated Glass	Factory Black, Painted-Dk Blue Hales Navy HC154	SS Tapcons	EMTEK (model TBS) Plate in SS Schlage Keyway	EMTEK (model TBS) Lever & Dummy on Inactive side		Impact Rated- Provide NOA.	+70/-80	+40.5/-45
071-	Davida 2000 Dagge	TDC	1 2/01/01/10	on Outer Face		(Lever & Deadbolt)	TDC	Duinha Chu IIC2C	Casina TDC	NI/A	NI/A
07b	Double 2668 Doors w/ T Astragal	TBS	1 3/8" SOLID CORE	Painted- Color TBS	3/4 wood prehung	TBS:: Privicay Lock w/ matching dummy	IBS	Bright Chr. US26	Casing TBS	N/A	N/A
07c	Dbl 2668 Alum. French Door w/ 5 Light- IMPACT RATED	PGT Window Co. Mod. FD750 "WinGuard"	"Energy Max" Low E, Laminated Insulated Glass	Factory Black, Painted-Dk Blue Hales Navy HC154 on Outer Face	SS Tapcons	EMTEK (model TBS) Plate in SS Schlage Keyway (Lever & Deadbolt)	EMTEK (model TBS) Lever & Dummy on Inactive side		Impact Rated- Provide NOA.	+70/-80	+40.5/-45
08a	2068 Pocket Door in Cased Opening	TBS	1 3/8" SOLID CORE	Painted- Color TBS	3/4 wood Frame	TBS:: Flush Edge Pull Passage Set	TBS		Casing TBS	N/A	N/A
09a	2068 Pocket Door in Cased Opening	TBS	1 3/8" SOLID CORE	Painted- Color TBS	3/4 wood Frame	TBS:: Flush Edge Pull Passage Set	TBS		Casing TBS	N/A	N/A
00a	Double 3068 Alum. French Doors w/ 1 Light- IMPACT RATED	PGT Window Co. Mod. FD750	"Energy Max" Low E, Laminated	Powdercoated Black Factory		EMTEK (model TBS) Plate in SS	EMTEK (model TBS) Lever & Dummy on	PGT Factory Installed	Impact Rated- Provide NOA.	+70/-80	+37.1/-65
00b	9868 Alum. BiFold French Doors	"WinGuard"	Insulated Glass	Finish	per NOA	Schlage Keyway (Lever & Deadbolt)	Inactive side EMTEK (model TBS)		Impact Rated- Provide	+70/-80	+40.5/-45
	w/ 1 Light- IMPACT RATED (Custom to Fit Exact RO)	4 panel Bi-Fold French Door	Low E, Laminated Insulated Glass	Black Factory Finish	SS Tapcons per NOA	Plate in SS Schlage Keyway	Lever & Dummy on Inactive side		NOA.	+10,00	+10.57 13
00c	Doubl 3068 Alum. French Doors w/ 1 Light- IMPACT RATED	PGT Window Co. Mod. FD750 "WinGuard"	"Energy Max" Low E, Laminated Insulated Glass	Powdercoated Black Factory Finish		(Lever & Deadbolt) EMTEK (model TBS) Plate in SS Schlage Keyway	EMTEK (model TBS) Lever & Dummy on Inactive side		Impact Rated- Provide NOA.	+70/-80	+37.1/-65
				I IIIISII	per NOA	(Lever & Deadbolt)					
01a	2868 Glass Door- Tempered		1/2" Temp. Glass w/ Sidelights		TBS	Privacy Set	TBS	Bright Chr. US26	Casing TBS	N/A	N/A
01b	3068 Prehung Door	TBS	1 3/8" SOLID CORE	Painted- Color TBS	3/4 wood prehung	Passage Set	TBS		Inside Face to be Built out per Elevtr Code	N/A	N/A
01c	2068 Prehung Door	TBS- Solid Core	1 3/8" SOLID	Painted-	3/4 wood	Passage Set	TBS	Bright Chr. US26	Casing TBS	N/A	N/A
03a	2068 Prehung Door	W/ Weatherstrip'g TBS	1 3/8" SOLID	Color TBS Painted-	prehung 3/4 wood	Privacy Set	TBS	Bright Chr. US26	w/ Gasketed Threshold Casing TBS	N/A	N/A
			CORE	Color TBS	prehung						
04a	2068 Prehung Door	TBS	1 3/8" SOLID CORE	Painted- Color TBS	3/4 wood prehung	Privacy Set	TBS	Bright Chr. US26	Casing TBS	N/A	N/A
	BiPass Shower Door	TBS	Clear 3/8" Glass w/ sandblasted mo	desty Panel	Frameless	D Handle Bright Chrome		Bright Chrome rails and clips	By Shower Door Co.	N/A	N/A
04b			1 3/8" SOLID	Painted-	3/4 wood prehung	 Privacy Set 	TBS	Bright Chr. US26	Casing TBS	N/A	N/A
04b 05a	2868 Prehung Door	TBS								N/A	N/A
	2868 Prehung Door 2668 Prehung Door	Plantation Style	CORE 1 3/8" SOLID CORE	Color TBS Painted- Color TBS	3/4 wood prehung	Passage Set	TBS	Bright Chr. US26	Casing TBS		
05a]	Plantation Style 2" Lvrd TBS	CORE 1 3/8" SOLID	Painted-Color TBS Painted-Pain	3/4 wood prehung 3/4 wood	Passage Set Privacy Set	TBS TBS	Bright Chr. US26 Bright Chr. US26		N/A	N/A
05a 05b 06a	2668 Prehung Door	Plantation Style 2" Lvrd TBS	1 3/8" SOLID CORE 1 3/8" SOLID CORE CORE	Painted- Color TBS Painted- Color TBS Painted- Color TBS	3/4 wood prehung 3/4 wood prehung Frameless	Privacy Set D Handle		Bright Chr. US26 Bright Chrome			N/A N/A
05a 05b 06a	2668 Prehung Door 2068 Prehung Door BiPass Shower Door	Plantation Style 2" Lvrd TBS	1 3/8" SOLID CORE 1 3/8" SOLID CORE CORE Clear 3/8" Glass w/ sandblasted mo	Painted- Color TBS Painted- Color TBS Color TBS desty Panel	3/4 wood prehung 3/4 wood prehung Frameless	Privacy Set D Handle Bright Chrome	TBS	Bright Chr. US26 Bright Chrome rails and clips	Casing TBS By Shower Door Co.	N/A N/A	N/A
05a 05b 06a 06b	2668 Prehung Door 2068 Prehung Door BiPass Shower Door 2868 Prehung Door	Plantation Style 2" Lvrd TBS TBS	CORE 1 3/8" SOLID CORE 1 3/8" SOLID CORE Clear 3/8" Glass w/ sandblasted mo 1 3/8" SOLID CORE	Painted- Color TBS Painted- Color TBS Color TBS desty Panel Painted- Color TBS	3/4 wood prehung 3/4 wood prehung Frameless 3/4 wood prehung	Privacy Set D Handle Bright Chrome Privacy Set	TBS TBS	Bright Chr. US26 Bright Chrome rails and clips Bright Chr. US26	Casing TBS By Shower Door Co. Casing TBS	N/A N/A	N/A N/A
05a 05b	2668 Prehung Door 2068 Prehung Door BiPass Shower Door	Plantation Style 2" Lvrd TBS TBS TBS Plantation Style	1 3/8" SOLID CORE 1 3/8" SOLID CORE CORE Clear 3/8" Glass w/ sandblasted mo	Painted- Color TBS Painted- Color TBS Color TBS desty Panel Painted-	3/4 wood prehung 3/4 wood prehung Frameless 3/4 wood prehung 3/4 wood prehung	Privacy Set D Handle Bright Chrome	TBS	Bright Chr. US26 Bright Chrome rails and clips	Casing TBS By Shower Door Co. Casing TBS	N/A N/A	N/A
05a 05b 06a 06b	2668 Prehung Door 2068 Prehung Door BiPass Shower Door 2868 Prehung Door Dbl 3068 BiPass Closet Door Double 2668 Doors	Plantation Style 2" Lvrd TBS TBS TBS Plantation Style 2" Lvrd	CORE 1 3/8" SOLID CORE 1 3/8" SOLID CORE Clear 3/8" Glass w/ sandblasted mo 1 3/8" SOLID CORE	Painted- Color TBS Painted- Color TBS Painted- Color TBS desty Panel Painted- Color TBS Painted- Painted- Painted- Painted-	3/4 wood prehung 3/4 wood prehung Frameless 3/4 wood prehung 3/4 wood prehung 3/4 wood prehung 3/4 wood prehung	Privacy Set D Handle Bright Chrome Privacy Set JOHNSON 100 Series Track & Cars TBS:: Privicay Lock w/	TBS TBS TBS	Bright Chr. US26 Bright Chrome rails and clips Bright Chr. US26	Casing TBS By Shower Door Co. Casing TBS Casing TBS	N/A N/A	N/A N/A
05a 05b 06a 06b 07a	2668 Prehung Door 2068 Prehung Door BiPass Shower Door 2868 Prehung Door Dbl 3068 BiPass Closet Door	Plantation Style 2" Lvrd TBS TBS Plantation Style 2" Lvrd TBS Plantation Style 2" Lvrd PGT Window Co. Mod. FD750	CORE 1 3/8" SOLID CORE 1 3/8" SOLID CORE Clear 3/8" Glass w/ sandblasted mo 1 3/8" SOLID CORE Low E, Laminated	Color TBS Painted- Color TBS Painted- Color TBS desty Panel Painted- Color TBS Painted- Color TBS Painted- Color TBS Painted- Factory Black, Painted-Dk Blue	3/4 wood prehung 3/4 wood prehung Frameless 3/4 wood prehung 3/4 wood prehung 3/4 wood prehung Alum.: install w/ SS Tapcons	Privacy Set D Handle Bright Chrome Privacy Set JOHNSON 100 Series Track & Cars TBS:: Privicay Lock w/ matching dummy EMTEK (model TBS) Plate in SS	TBS TBS TBS TBS EMTEK (model TBS) Lever & Dummy on	Bright Chr. US26 Bright Chrome rails and clips Bright Chr. US26 Bright Chr. US26 Bright Chr. US26 PGT Factory	Casing TBS By Shower Door Co. Casing TBS Casing TBS	N/A N/A N/A	N/A N/A N/A
05a 05b 06a 06b 07a 07b	2668 Prehung Door 2068 Prehung Door BiPass Shower Door 2868 Prehung Door Dbl 3068 BiPass Closet Door Double 2668 Doors w/ T Astragal Dbl 2668 Alum. French Door	Plantation Style 2" Lvrd TBS TBS Plantation Style 2" Lvrd TBS Plantation Style 2" Lvrd TBS PGT Window Co. Mod. FD750 "WinGuard"	CORE 1 3/8" SOLID CORE 1 3/8" SOLID CORE Clear 3/8" Glass w/ sandblasted mo 1 3/8" SOLID CORE	Color TBS Painted- Color TBS Painted- Color TBS desty Panel Painted- Color TBS Painted- Color TBS Painted- Color TBS Painted- Factory Black, Painted-Dk Blue Hales Navy HC154 on Outer Face	3/4 wood prehung 3/4 wood prehung Frameless 3/4 wood prehung 3/4 wood prehung 3/4 wood prehung Alum.: install w/ SS Tapcons per NOA	Privacy Set D Handle Bright Chrome Privacy Set JOHNSON 100 Series Track & Cars TBS:: Privicay Lock w/ matching dummy EMTEK (model TBS) Plate in SS Schlage Keyway (Lever & Deadbolt)	TBS TBS TBS TBS TBS Lever & Dummy on lnactive side	Bright Chr. US26 Bright Chrome rails and clips Bright Chr. US26 Bright Chr. US26 Bright Chr. US26 PGT Factory Installed	Casing TBS By Shower Door Co. Casing TBS Casing TBS Casing TBS Lasing TBS Impact Rated- Provide NOA.	N/A N/A N/A N/A	N/A N/A N/A +40.5/-45
05a 05b 06a 06b 07a 07b	2668 Prehung Door 2068 Prehung Door BiPass Shower Door 2868 Prehung Door Dbl 3068 BiPass Closet Door Double 2668 Doors w/ T Astragal Dbl 2668 Alum. French Door	Plantation Style 2" Lvrd TBS TBS Plantation Style 2" Lvrd TBS Plantation Style 2" Lvrd PGT Window Co. Mod. FD750	CORE 1 3/8" SOLID CORE 1 3/8" SOLID CORE Clear 3/8" Glass w/ sandblasted mo 1 3/8" SOLID CORE 1 3/8" SOLID CORE 1 3/8" SOLID CORE 1 3/8" SOLID CORE "Energy Max" Low E, Laminated Insulated Glass "Energy Max"	Painted- Color TBS Painted- Color TBS Painted- Color TBS desty Panel Painted- Color TBS Painted- Color TBS Painted- Factory Black, Painted-Dk Blue Hales Navy HC154 on Outer Face Factory Black,	3/4 wood prehung 3/4 wood prehung Frameless 3/4 wood prehung 3/4 wood prehung 3/4 wood prehung Alum.: install w/ SS Tapcons per NOA Alum.: install w/ SS Tapcons	Privacy Set D Handle Bright Chrome Privacy Set JOHNSON 100 Series Track & Cars TBS:: Privicay Lock w/ matching dummy EMTEK (model TBS) Plate in SS Schlage Keyway	TBS TBS TBS TBS EMTEK (model TBS) Lever & Dummy on	Bright Chr. US26 Bright Chrome rails and clips Bright Chr. US26 Bright Chr. US26 Bright Chr. US26 PGT Factory Installed PGT Factory	Casing TBS By Shower Door Co. Casing TBS Casing TBS Casing TBS Lasing TBS Casing TBS	N/A N/A N/A N/A	N/A N/A N/A

10/18/21 Derrickson_WINDOW Schedule_10_18_21.xls 1:52 PM

		Quantity	nue, Delray Beach, FL, Revised 10/18/21		Exterior	Exterior			WOOD FRAME	WOOD FRAME	Remarks	Head Ht. above	Door "DP"	Actual Wind
	MULL	of this		GLASS	FRAME	SASH			R. Opening	R. Opening		FFL of that	Wind Pressure	Pressure on
)W #	PATTERN		DESCRIPTION	TYPE	FINISH	FINISH	MANUF.	MODEL #	Width (in)	Height (in)		Room	Rating per manf	
		IDENIOE	140											
MA			Windows											
	4/1	4	Alum. Single Hung Window: SH7700A Series	Note #1	White	White	PGT Windguard	H35	26"	62.5"	Clear Low E Glass	7'- 6"	+65/-80	+43.4/-47.
	4/1	2	Alum. Single Hung Window: SH7700A Series	Note #1	White	White	PGT Windguard	24	36.5"	52.125"	Clear Low E Glass	6'- 10"	+65/-80	+43.4/-47.
	4/1	14	Alum. Single Hung Window: SH7700A Series	Note #1	White	White	PGT Windguard	H34	26"	52.125"	Clear Low E Glass	6'- 10"	+65/-80	+44.9/-48
												NOT	E: (1) type C is	'+41.1/-75.
	4/1	2	Alum. Single Hung Window: SH7700A Series	Note #1	\A/hito	White	PGT Windguard	ПЗЛ	26"	52.125"	Clear Low E Glass	6'- 10"	+65/-80	+41.1/-75
	4/ 1		Adm. Single Hung Window. Sin 7 OOA Series		write	write	FG1 Willuguaru	1137	20	32.123	& Frosted	0-10	+63/-60	+41.1/-73
	4/1	1	Alum. Single Hung Window: SH7700A Series	Note #1	\A/bita	White	PGT Windguard	ПЗС	26"	75.5"	Clear Low E Glass	6'- 10"	+65/-80	+43.4/-47
	4/ 1	1	Alum. Single Hung Window. Sim 100A Series	Note #1	write	write	PGT Willuguaru	1130	20	7 3.3	Clear Low E Glass	0-10	+63/-60	+43.4/-4/
	4/1	2	Alum. Single Hung Window: SH7700A Series	Note #1	\A/bito	White	PGT Windguard	ПЗЕ	26"	62.5"	Class Law E Class	sill at 8"	+65/-80	+43.4/-47
	4/1		Alum. Single Hung Window. SH7700A Series	note #1	write	write	PGT Windguard	пээ	20	62.3	Clear Low E Glass	SIII at 0	+63/-60	+43.4/-4/.
					-									
		-	GENERAL NOTE: Can Substitute Marvin "Coa	stline Se	ries" Sinale	Hung i74 Se	ios In Rlack if PCT	' Rackorde	red (use Same	e Low F Lamin	nated Insulated G	lace)		
				stitute Marvin "Coastline Series" Single Hung iZ4 Series In Black if PGT Backordered. (use Same Low E Laminated, Insulated GIA ACT RESISTANT, Fla. Bldg. Code Approved (Palm Beach Co.), CLEAR glass. mance Impact Rated "Low E" Glass=(Impact Resistant Laminated, Insulated "Energy Star Max")						1433)				
			Note #2: All windows to have GWB interior											
				TM F2090 Window Guard(s) if Required.										
				ve 3/4" Dimensional Grilles OUTSIDE & Low Profile Ogee Inside										
			Note #3: Must Comply with all Local Codes	for Stre	ngth & Insta	allation techn	iques. Also Windov	v Installer t	to follow manu	ıfacturers inst	allation and			
			flashing directions. Window Instal	ler to Fla	ish wi/ WR (Grace VYCOR	PLUS "peel & stick	" system.	Also provide	tempered glas	ss units where co	de required.		
			Note #4: Verify all Wood & Masonry Opening to Create Rough Opening for Fin F											

GENERAL CONSTRUCTION NOTES-

Derrickson Residence New Single Family Home Project

1. All dimensions, Specifications, and Notes provided herein shall be verified by each Subcontractor and Vendor prior to performance of the work, any discrepancies shall be immediately brought to the attention of the GC/Project Manager and Architect. Written dimensions shall take precedence over scale dimensions at all times. The work shall conform to the Florida Building Code latest edition and County/Municipalities Interpretations thereof. *Included in the work is Submitting* Samples/Specifications/Colors/Paperwork as may be required to obtain City of Delray Beach Historic Preservation Board or HOA Board Pre-Approval for any items or assemblies where such approval is required such as WINDOWS and EXTERIOR DOORS.

2. DRAWINGS: These Drawings are diagrammatic only. It is not the intent of these drawings to show every minor detail of construction. The Subcontractor and Vendor shall furnish and install all items needed for a complete building system and provide all requirements for the equipment to be placed in proper working order. Prior to submission of bids, Contractor, Subcontractors, and Vendors shall visit the site and bring any descrepencies at the stie, with the plans, and specs to the attention of the Architect and shall verify that their final bid includes all items and assembiles needed to commply with the FBC, PBC, and City requirements, codes, and rules and the intent depicted in these drawings. A complete set of approved, signed and sealed drawings, together with approved "Change Order" sheets, addenda, Shop Drawings, and Supplemental Information, along with all permit copies shall be maintained at the jobsite at all times.

3. Work shall include all items (building and site) indicated on these drawings unless otherwise noted. (co-ordinate with written specifications, as applicable)

4. Shop drawings shall be submitted for approval for the following items:

1. Trusses	XX	6. Stairs	XX
2. Wall Panels		7. Structural Connections	XX
3. A/C	\underline{XX}	8. Plumbing Riser	
4. Windows/Sto	refront XX	9. Electrical Riser	
5. Doors	\overline{XX}	10. Cabinets	XX
		11. Other	

5. ____ General Contractor or XX Owner: shall maintain Temporary Electrical, Water, and Sanitary Facilities for the duration of construction unless Specifically otherwise provided for in the Construction Contract.

6. Deposits and Fees: Deposits for Water Meter, Telephone, Water, if applicable, shall be billed to Owner at GC net cost.

7.All trades shall be responsible for cleaning up and bringing their own trash and scrap materials to the on site dumpster each day. Jobsite shall be cleaned daily by each Subcontractor. If not done, GC may backcharge Subcontractor for the cost of such cleanup as

8. Every Subcontractor and Vendor shall carry adequate Public Liability and Workers Comp Insurance for the duration of the work. SEE RFP for any limits required above the Statutory Requirements. All work shall be in accordance with applicable National, State, and local Codes, rules, and ordinances. Each Subcontractor shall have Conch Custom Homes added as an Additional Named Insured and furnish GC a Certificate of Insurance attesting to same.

9. TRUSS MANUFACTURER; co-ordinate truss profiles to accommodate HVAC Ductwork per Sheet M-1 & M.2 (as applicable). All Truss to Truss Metal connectors shall be furnished by Truss Manf. as part of Truss Package.

10. All Demolition Work accomplished by Subcontractor shall follow latest EPA Leadsafe Workplace Standards for containment and removal of possible lead paint in any residential structure constructed prior to 1979, unless such demolition work was accomplished by the Owner acting as "Owner/Builder".


11. No Contractor, Subcontractor, or Vendor shall bring onto the site or incorporate into the building any material containing Aebestos or PCBs. If the project is a renovation project the observation of either substance shall immediately be brought to the attention of the Architect and GC so that they can be appropriatley remediated or removed.

12. Each Subcontractor, Speciality Contractor, and Vensdor shall install his/her portion of the work in a neat, workmanlike manner and in accordance with the highest standards and methods promulgated by their appropriate trade group. See Written Specs for added information. Each Contractor will protect the work of other Contractors during the installation of their materials or assemblies. If one Contractor damages the work of antother Contractor the Contractor causing such damage shall be responsible for the costs of repair of such damage. Any such conflicts shall immedialty be brought to the attention of the GC.

13. MILLWORK: Contractor shall coordinate the Millwork/Cabinetry Installer with Electrical, Plumbing, and Gas trades for device & fixture locations prior to roughing in for devices, fixtures, or equipment. All millwork shall have finished interiors be fabricated and installed in accordance with the Architectural Millwork Institute "Premium Grade" standard. No Urea Formaldahyde Glues or VOC containing Stains or Finishes shall be utilized. SEE INTERIOR DESIGN DRAWINGS & WRITTEN SPECS FOR ADDITIONAL INFORMATION.

14: GREEN PROJECT: (ONLY IF STIPULATED IN BIDDING DOCUMENTS) This project is going to be submitting for Green Certification thru the Florida Green Builidng Coaliiton, or the USGBC's LEED program, or Green Globes program. As such, All Vendors, Suppliers, and Subcontractaors shall warrant that they shall not utilize paints, sealants, glues, adhesives, primers, finishes, and other such materials containing VOC's or utilize urea formaldahyde glues (particularly in millwork and cabinetry) SEE WRITTEN SPECS for more information. If in Doubt about a particular item, ask the GC and Green Certification Constultant in advance of ordering or utilizing any such item.

The Work Shown in these Plans Shall Comply with the 2020 Florida Building Code w/ any Amendments and (as applicable) the same version of the Florida Mechanical, Electrical, Plumbing, and Existing Building Code(s). Framing and Other Structural Details will also comply with ICC-600 (Previously SSTD 10-99).

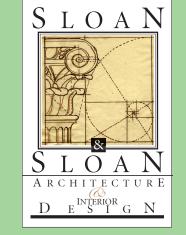


Sloan & Sloan Inc. 106 SE 7th Ave. Delray Beach, FL (561) 243-8755 dsloan@sloandesign.biz ID 0002725 & AR95577 AA26002208



No.	Date	Appr	Revision Notes
 1 1	0/x18/2021	-	Issued for HPB Review, w/ WHITE WINDOWS
 2 :	x/xx/2021		Issued for Permitting

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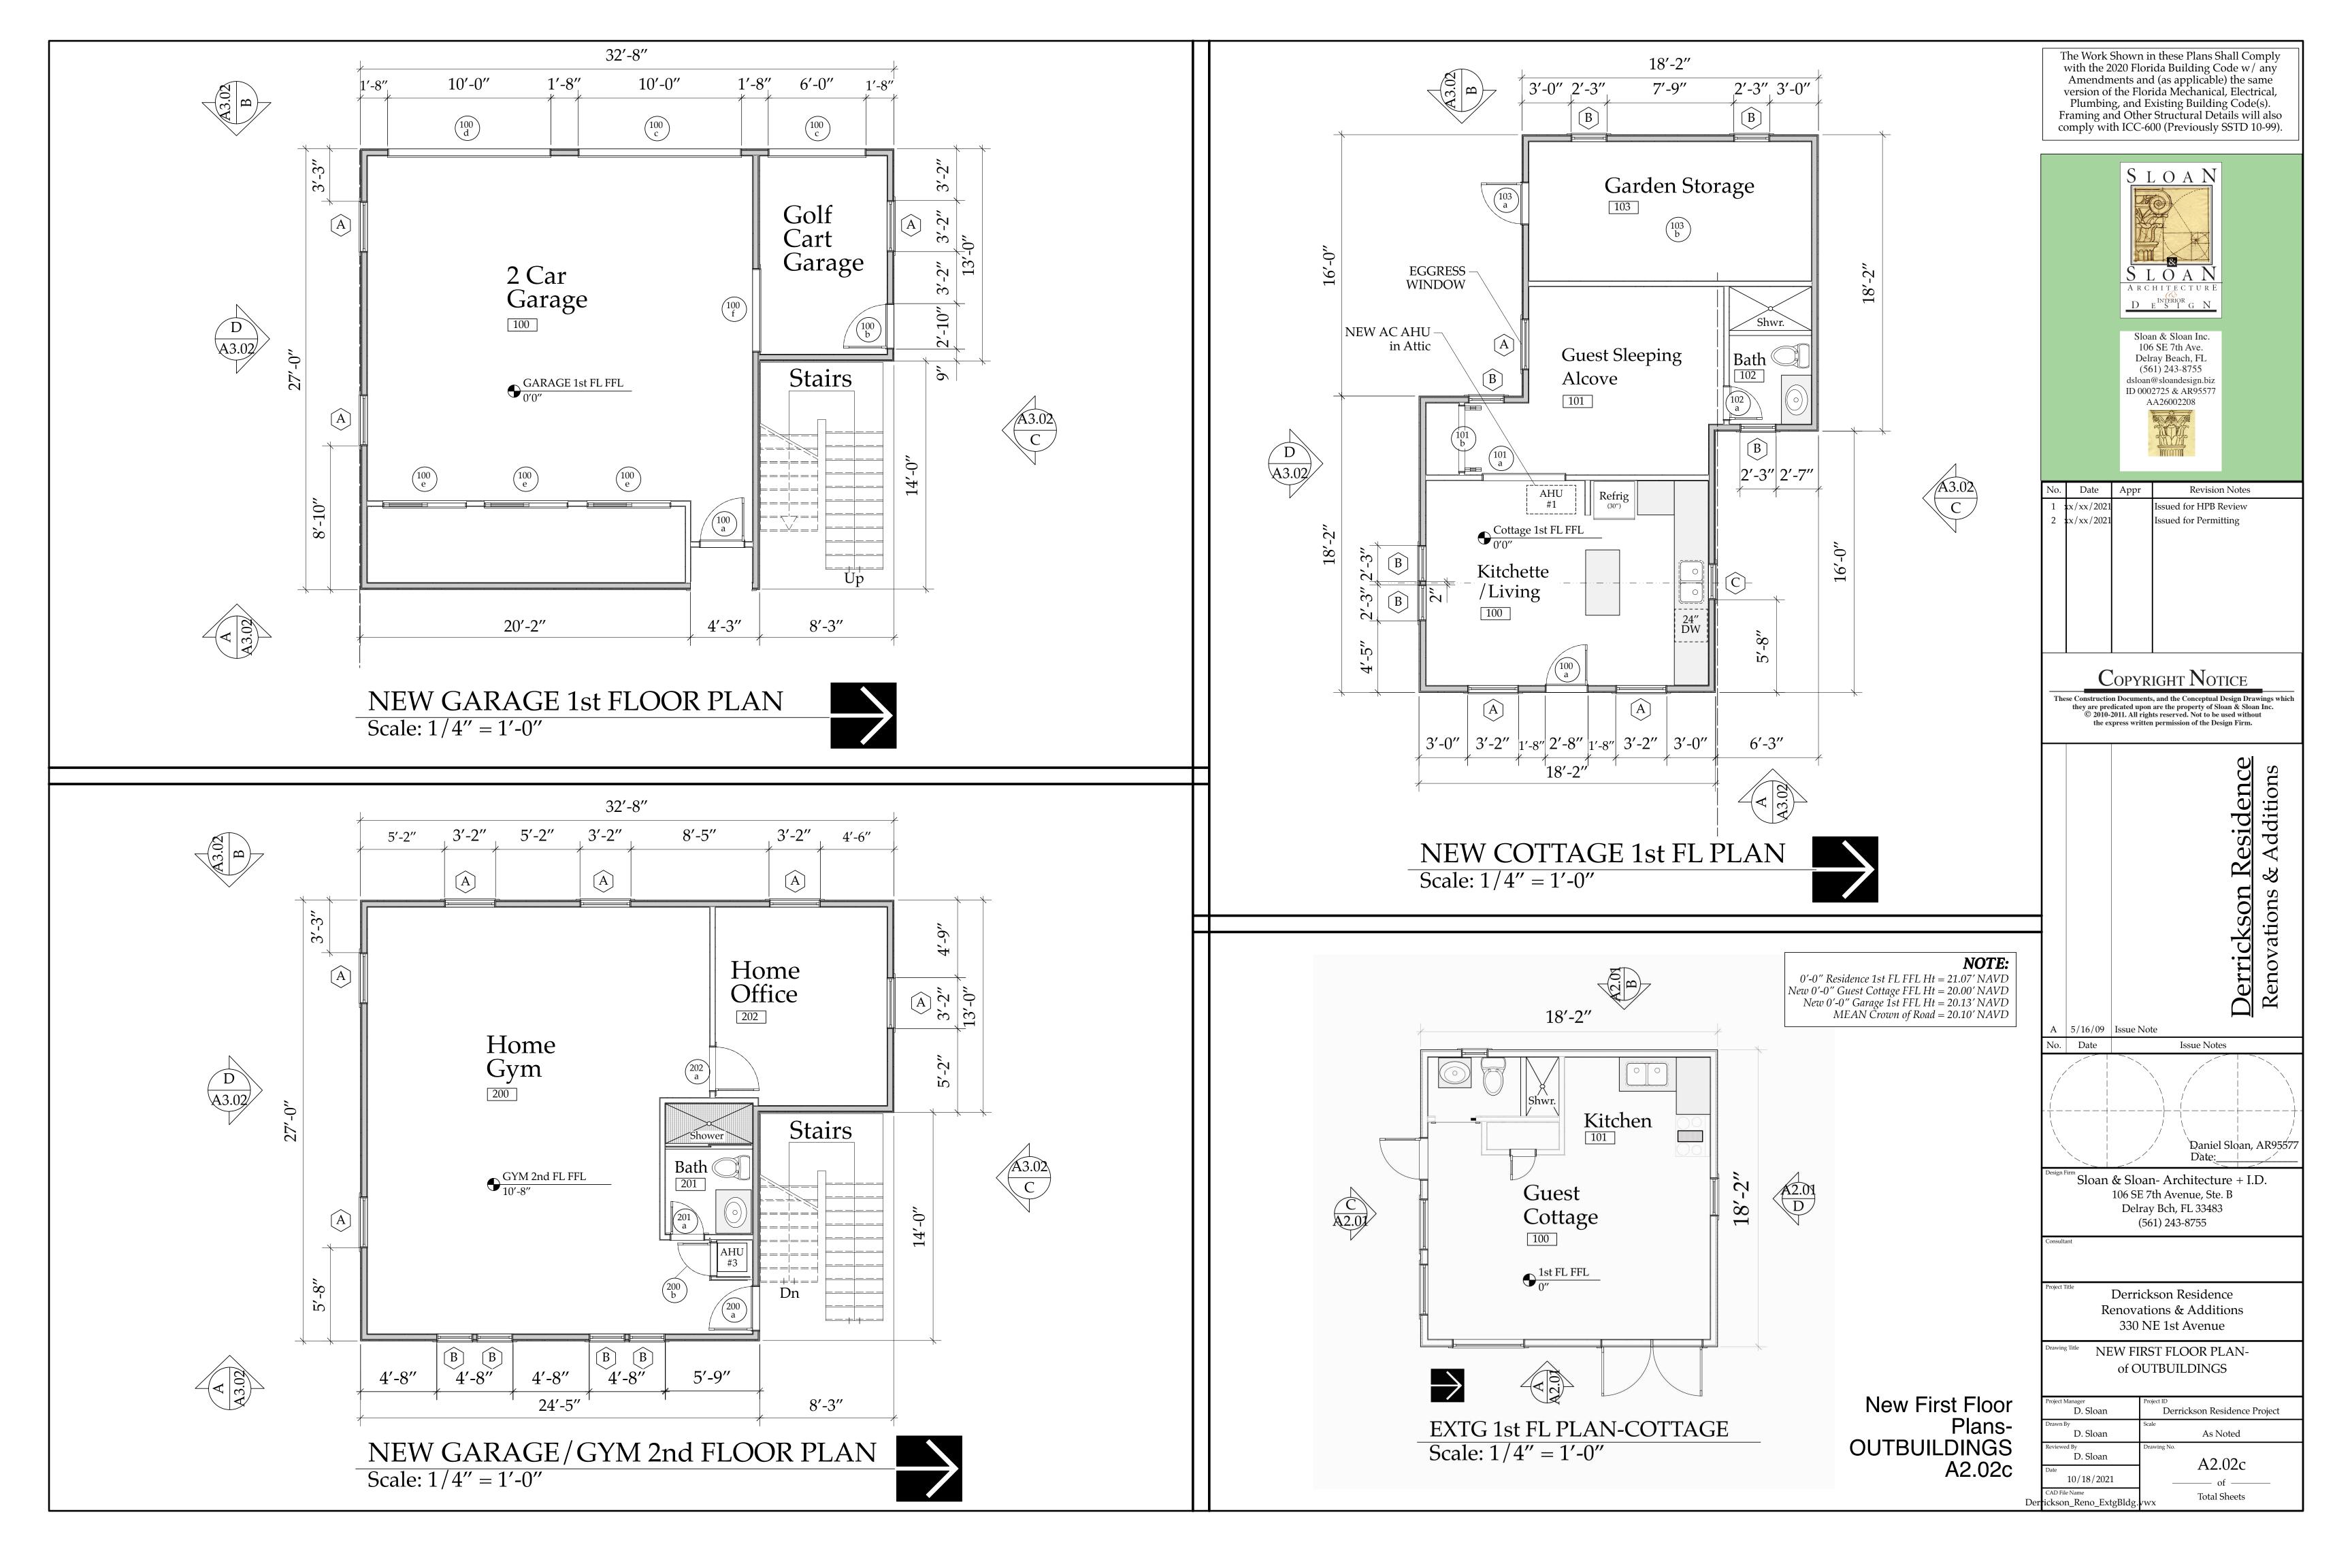
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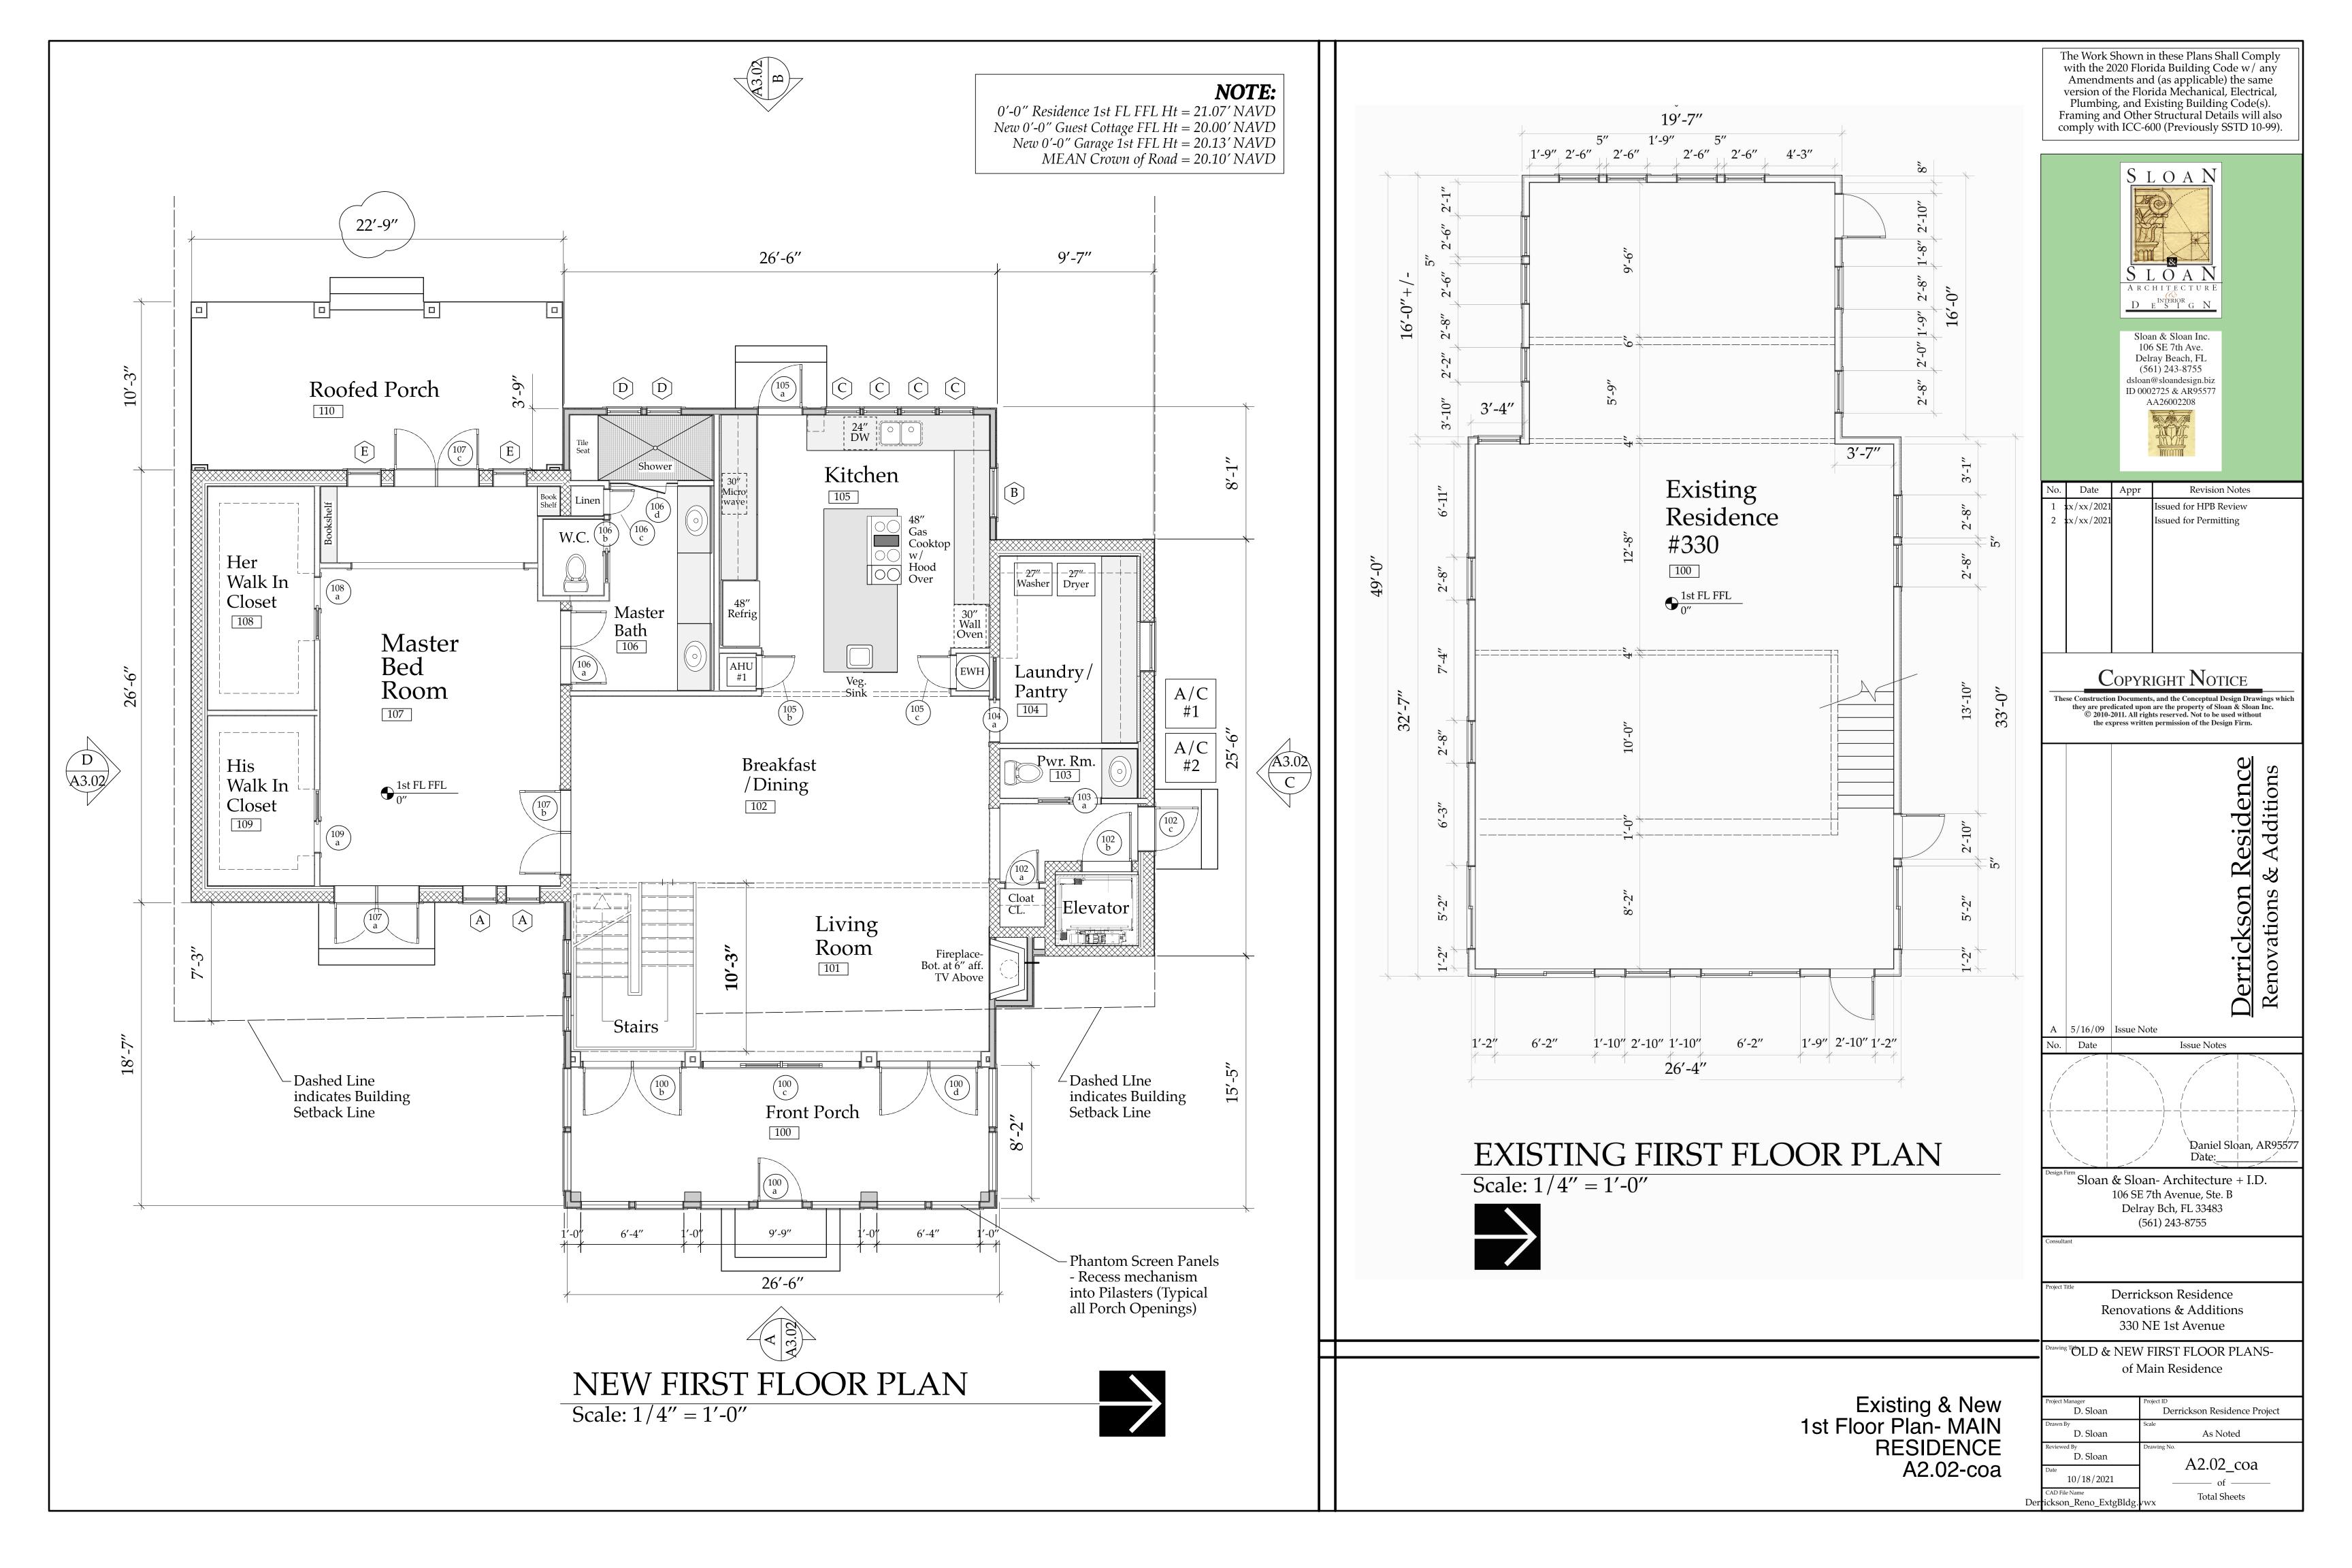
Derrickson Residence Renovations & Additions 330 NE 1st Avenue


Drawing Title NEW Door & Window Schedules & General Notes

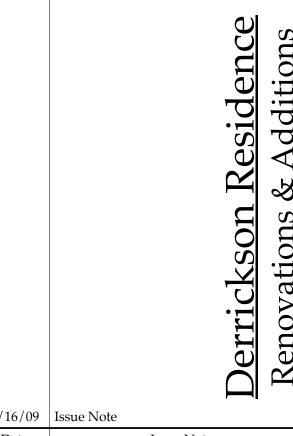	D. Sloan	Derrickson Residence Project			
	Drawn By D. Sloan	Scale As Noted			
	Reviewed By D. Sloan	Drawing No. A2.02b			
	Date 10/18/2021	———— of ————			
Der	CAD File Name rickson_Reno_ExtgBldg.	Total Sheets			

Door & Window Schedules





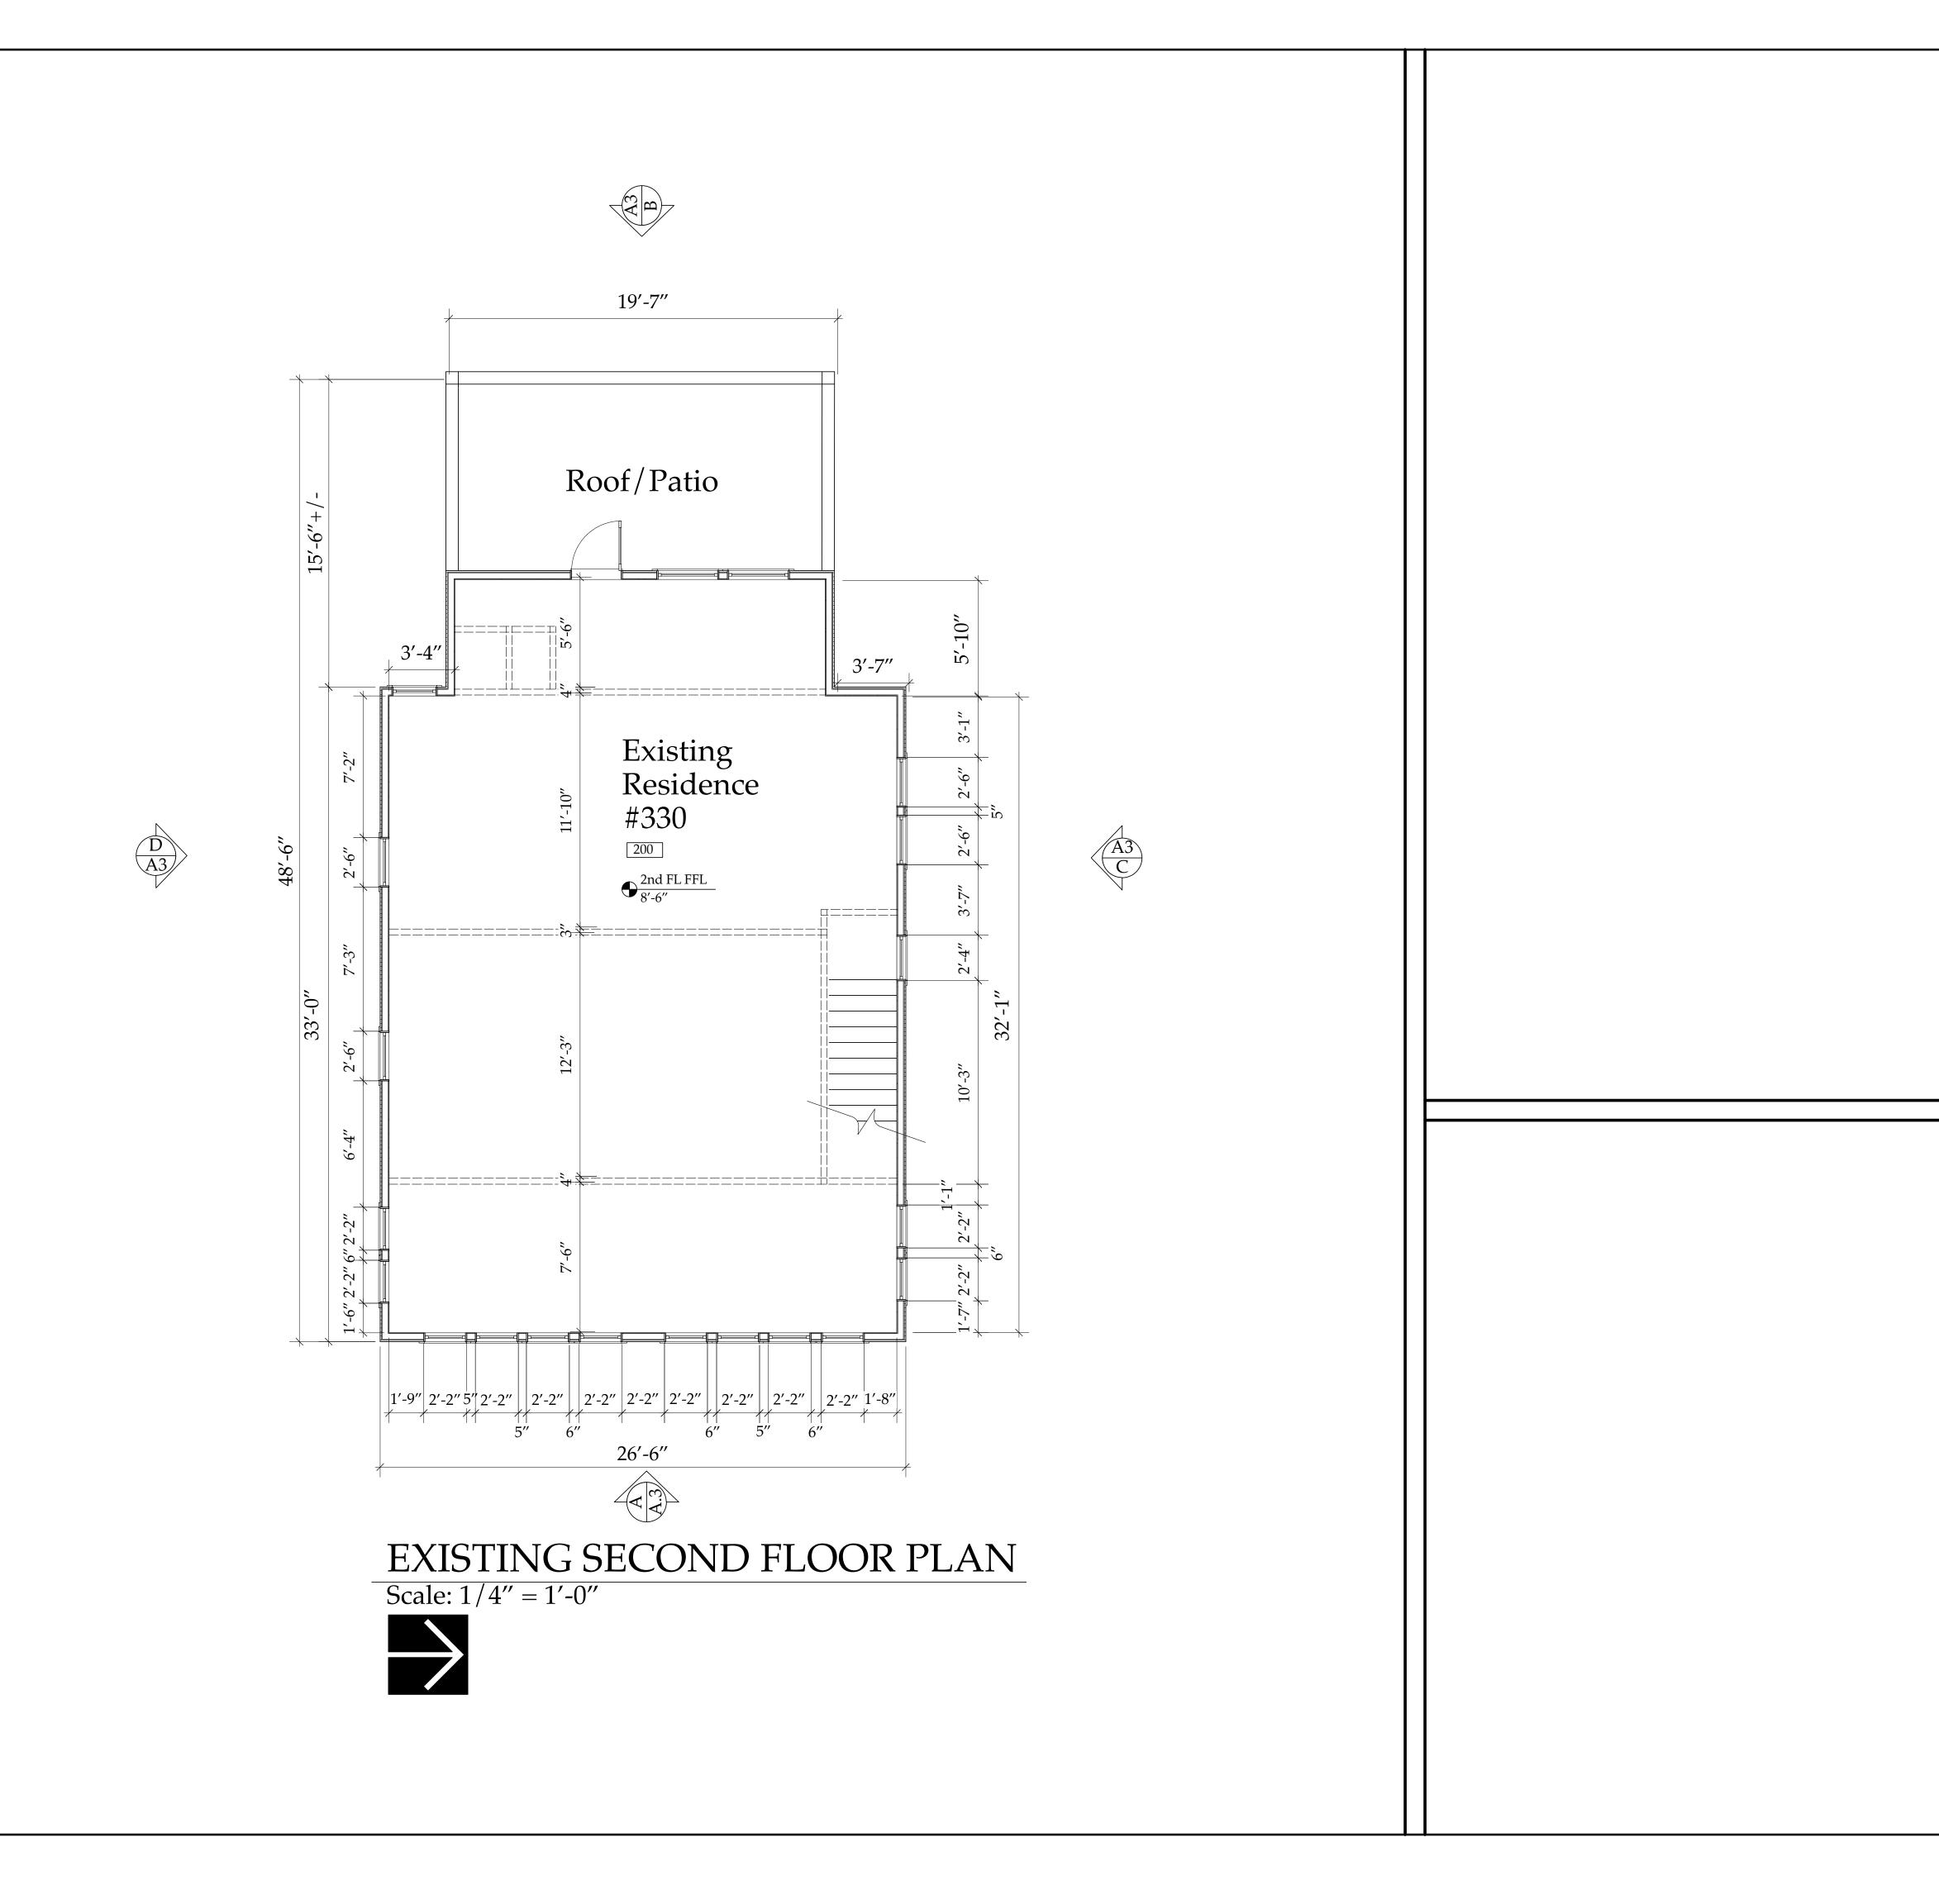

The Work Shown in these Plans Shall Comply with the 2020 Florida Building Code w/ any Amendments and (as applicable) the same version of the Florida Mechanical, Electrical, Plumbing, and Existing Building Code(s). Framing and Other Structural Details will also comply with ICC-600 (Previously SSTD 10-99).



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No.	Date	Appr	Revision Notes
1	xx/xx/21 xx/xx/21		Issued for HPB Review
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Extg 2nd Floor Plan A2.03

Derrickson Residence Renovations & Additions 330 NE 1st Avenue


rawing Title EXTG SECOND FLOOR PLANof Main Residence

Derrickson Residence Project D. Sloan D. Sloan As Noted D. Sloan A2.03 6/16/2021 **Total Sheets**



NOTE:

0'-0" Residence 1st FL FFL Ht = 21.07' NAVD New 0'-0" Guest Cottage FFL Ht = 20.00' NAVD New 0'-0" Garage 1st FFL Ht = 20.13' NAVD MEAN Crown of Road = 20.10' NAVD The Work Shown in these Plans Shall Comply with the 2020 Florida Building Code w/ any Amendments and (as applicable) the same version of the Florida Mechanical, Electrical, Plumbing, and Existing Building Code(s). Framing and Other Structural Details will also comply with ICC-600 (Previously SSTD 10-99).

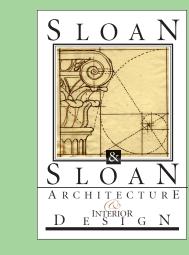


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No.	Date	Appr	Revision Notes
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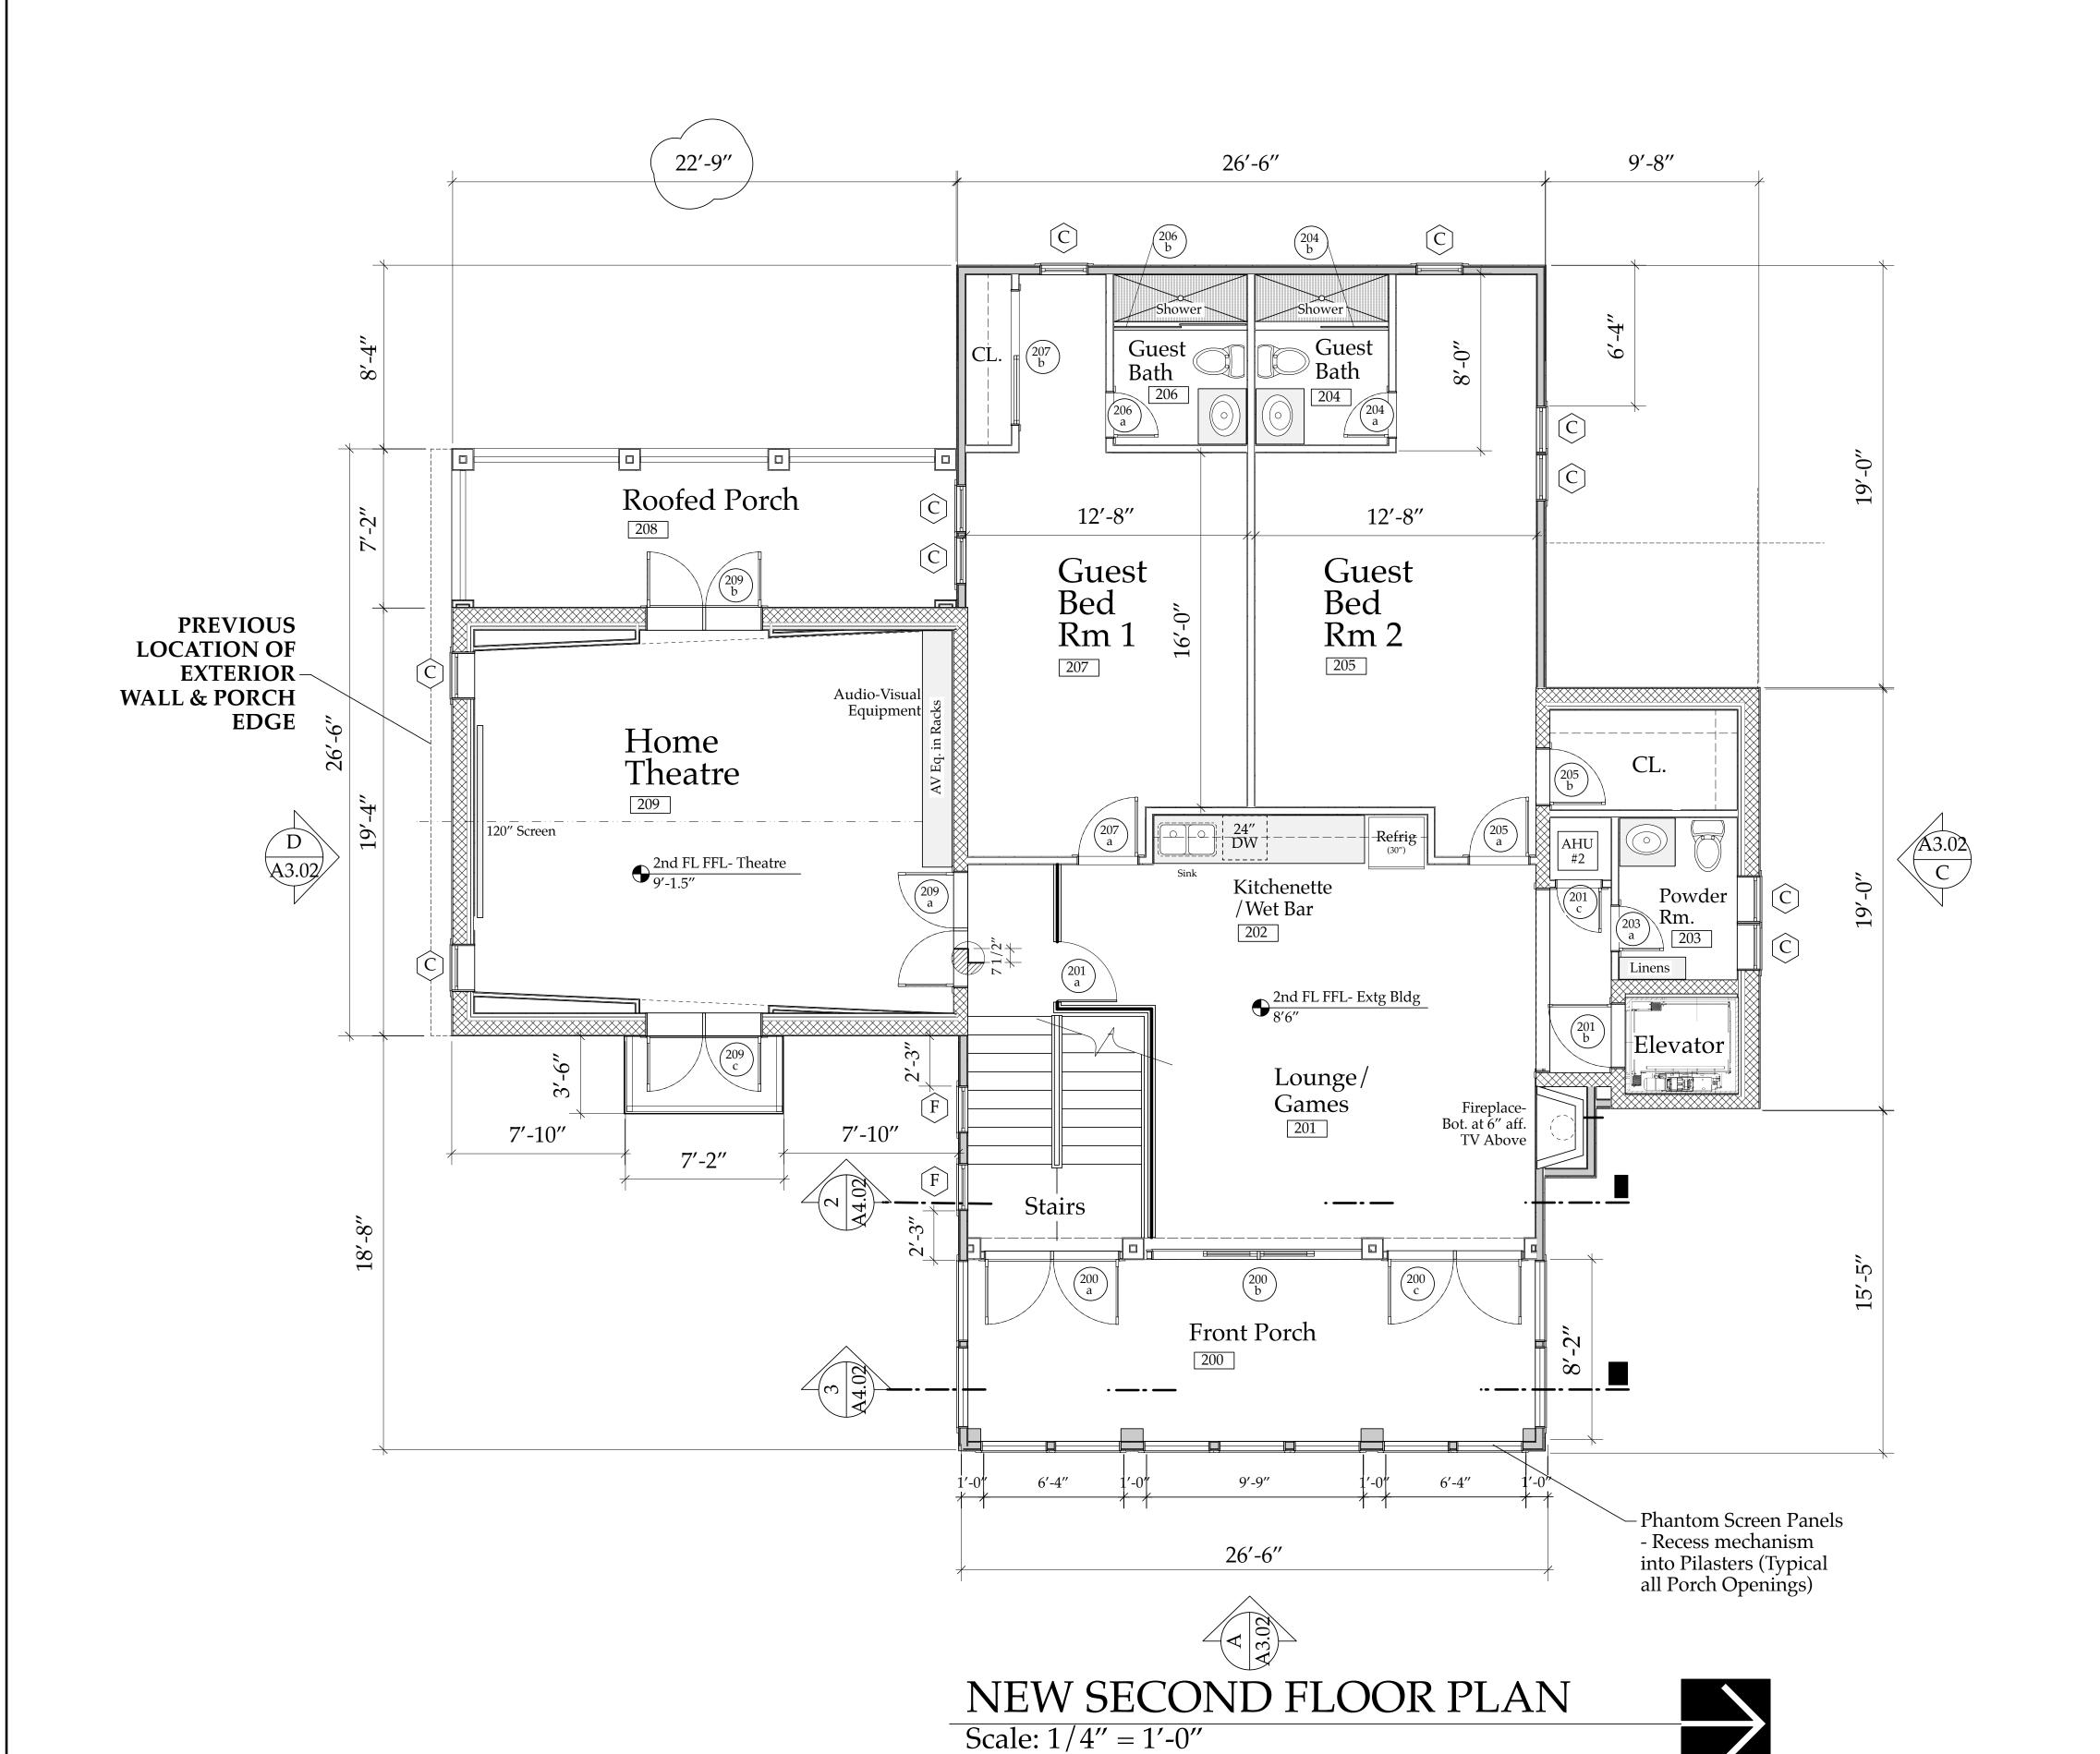
Consultant

Derrickson Residence Renovations & Additions 330 NE 1st Avenue


Orawing Title NEW SECOND FLOOR PLAN-


of Main Residence

	D : ()/	n i in
	Project Manager	Project ID
	D. Sloan	Derrickson Residence Project
	Drawn By	Scale
	D. Sloan	As Noted
	Reviewed By	Drawing No.
	D. Sloan	A2.04
	Date	74.U 1
	10/18/2021	of
)er	CAD File Name rickson_Reno_ExtgBldg.	Total Sheets

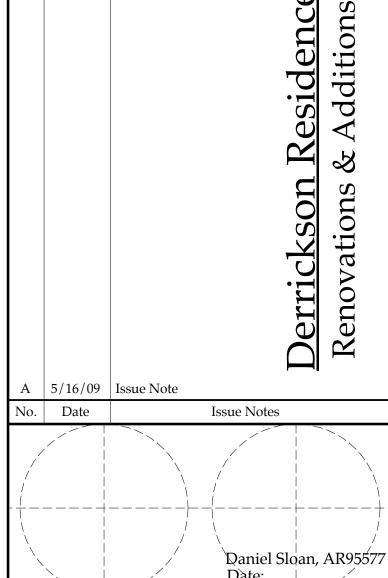



New Second Floor Plan A2.04

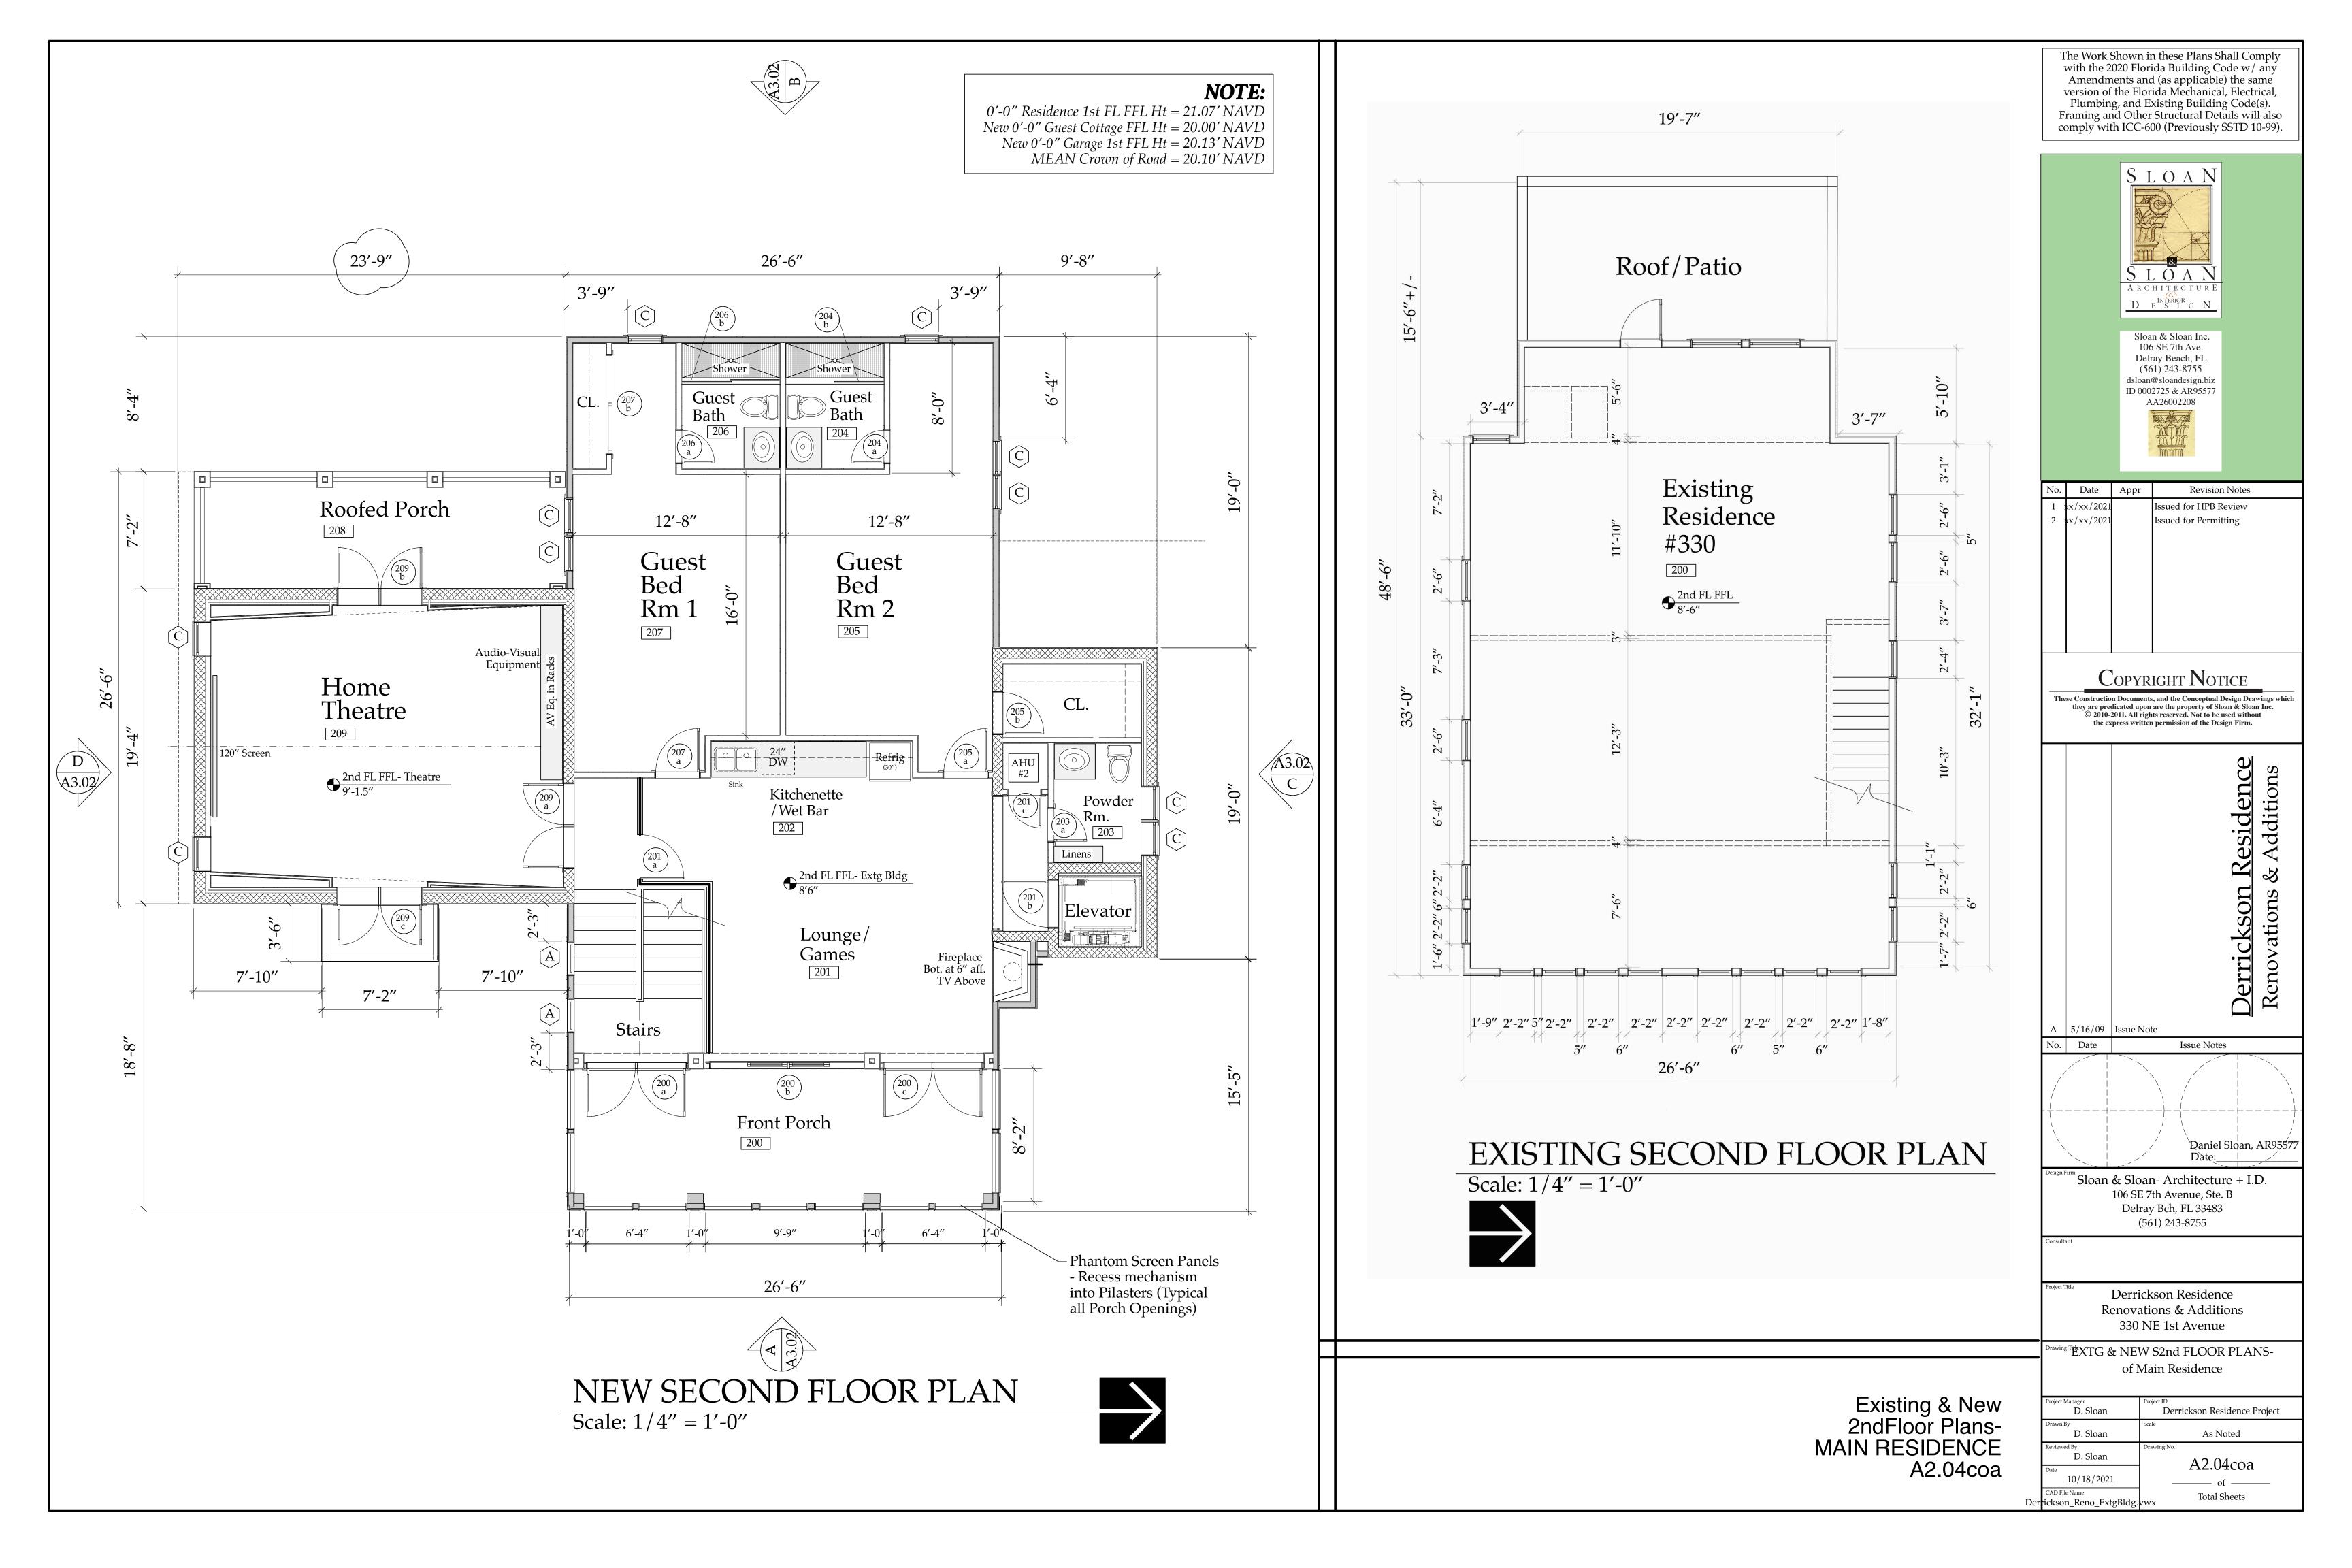

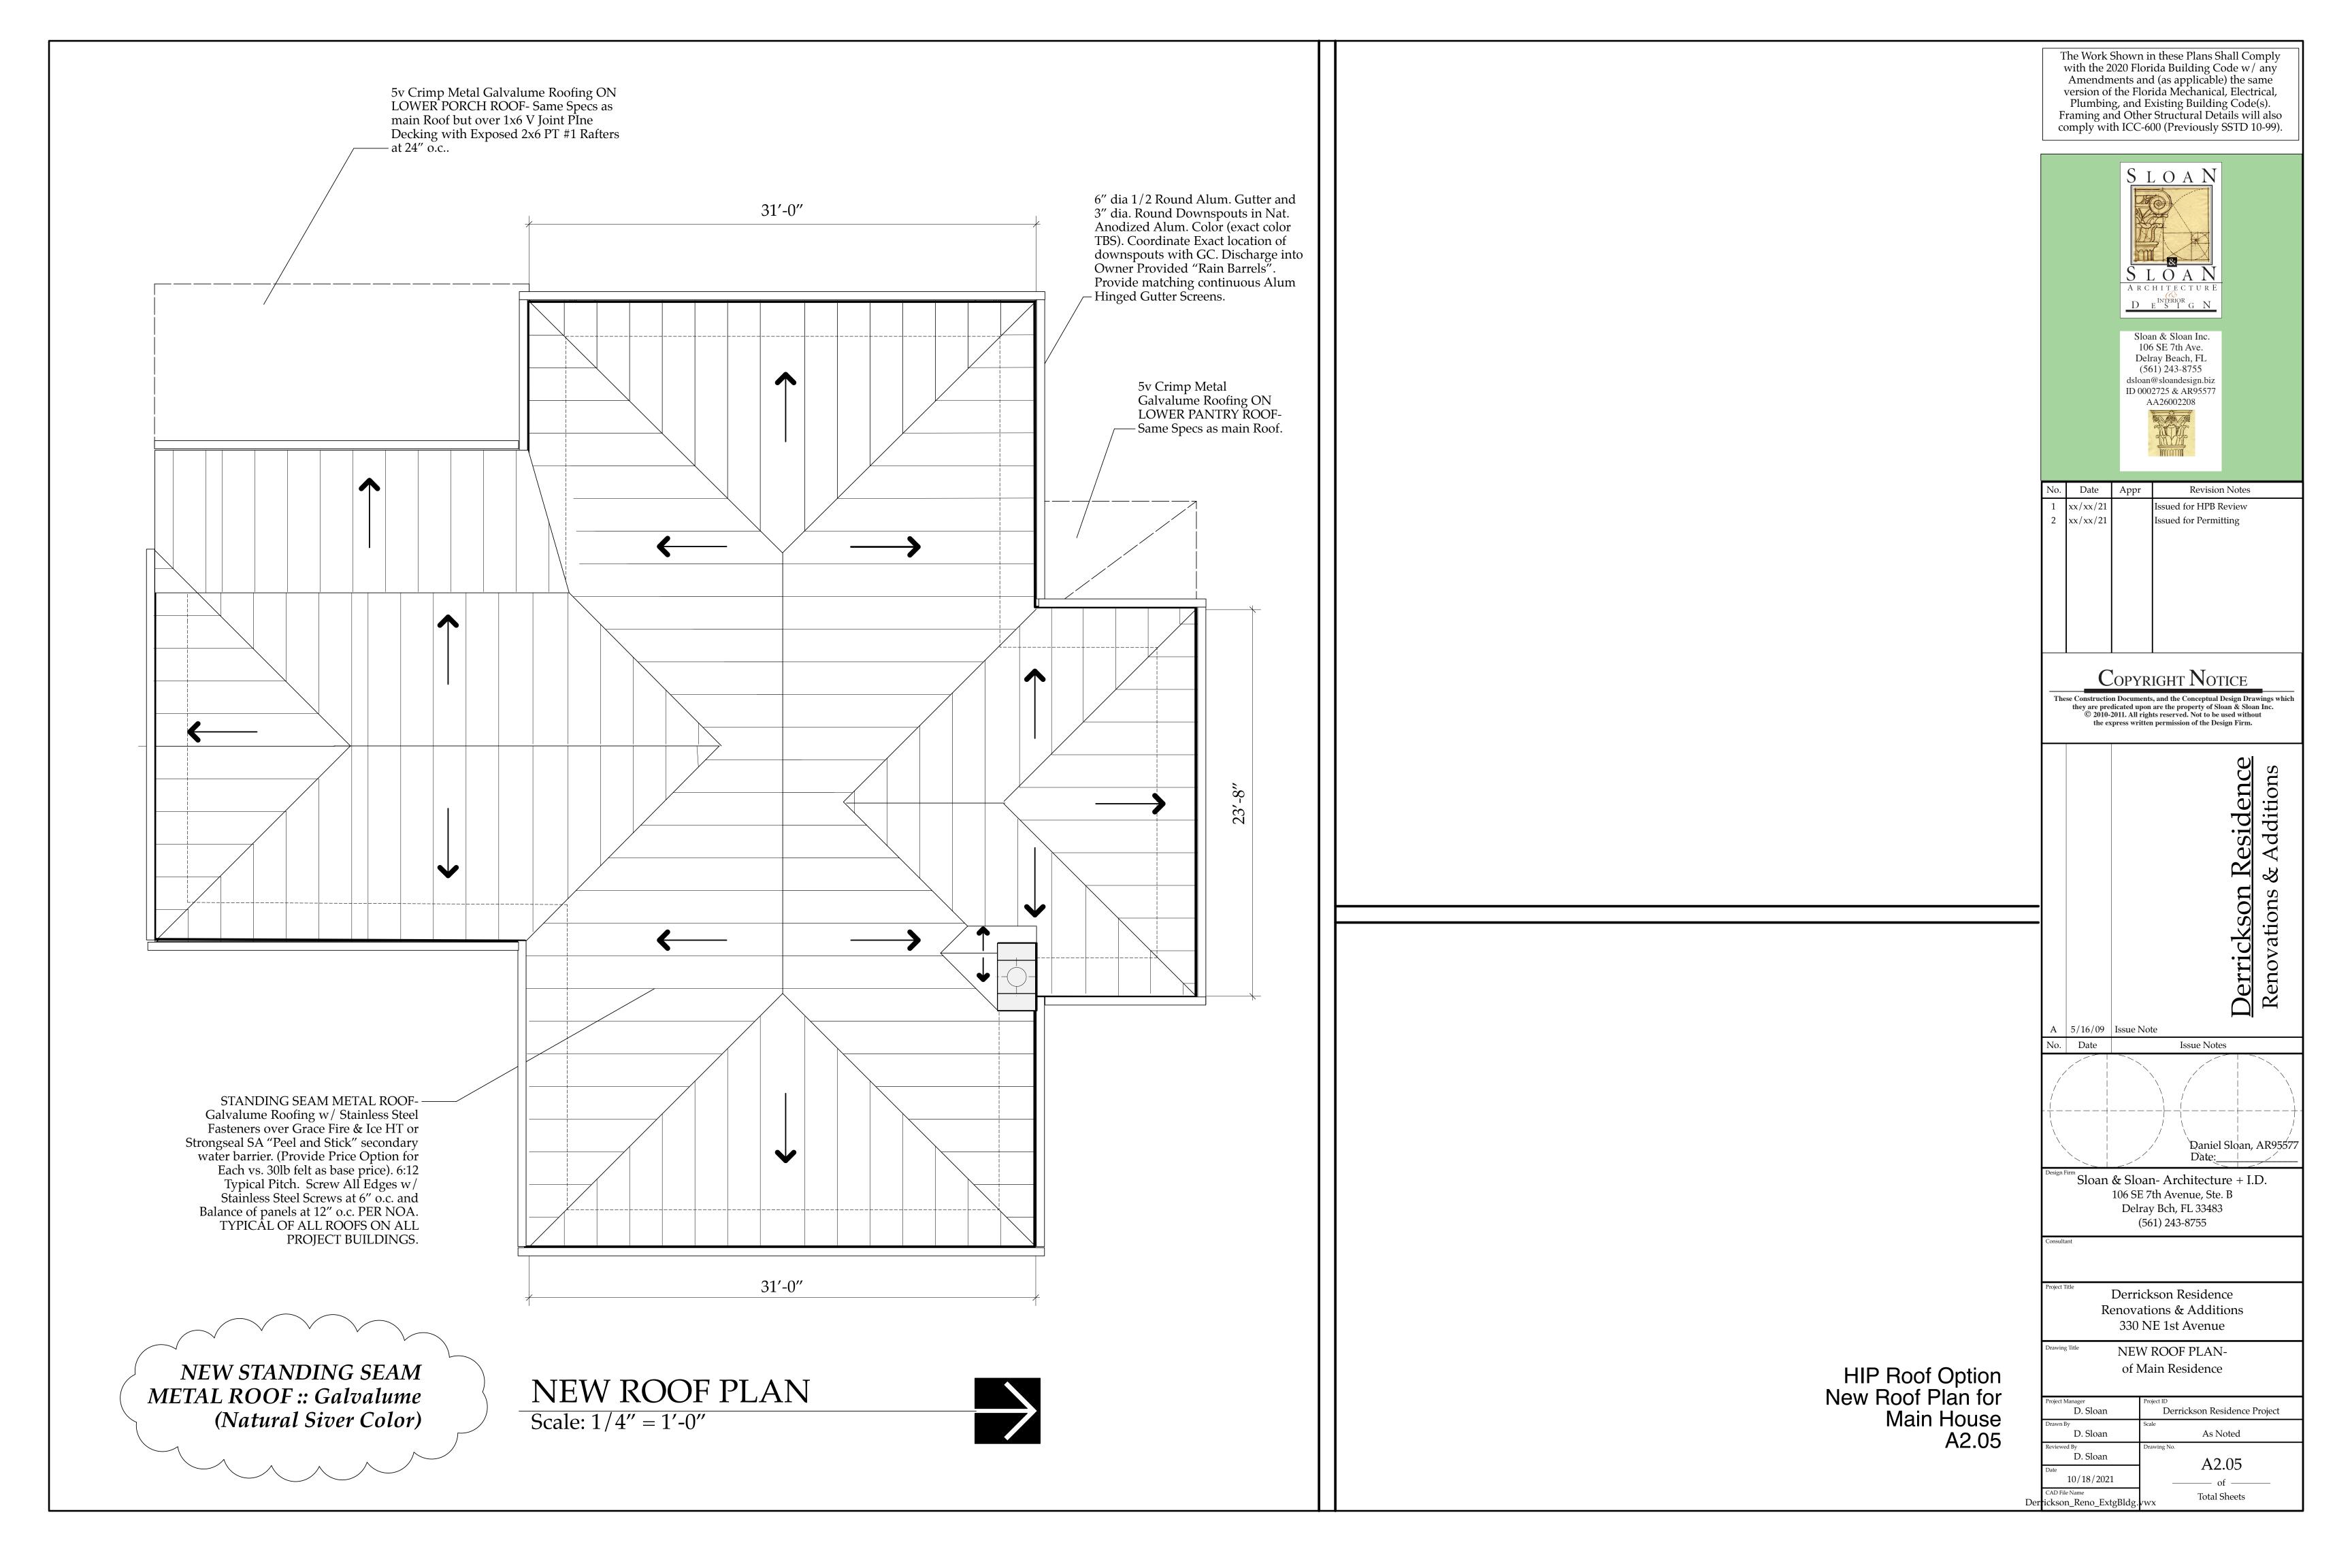




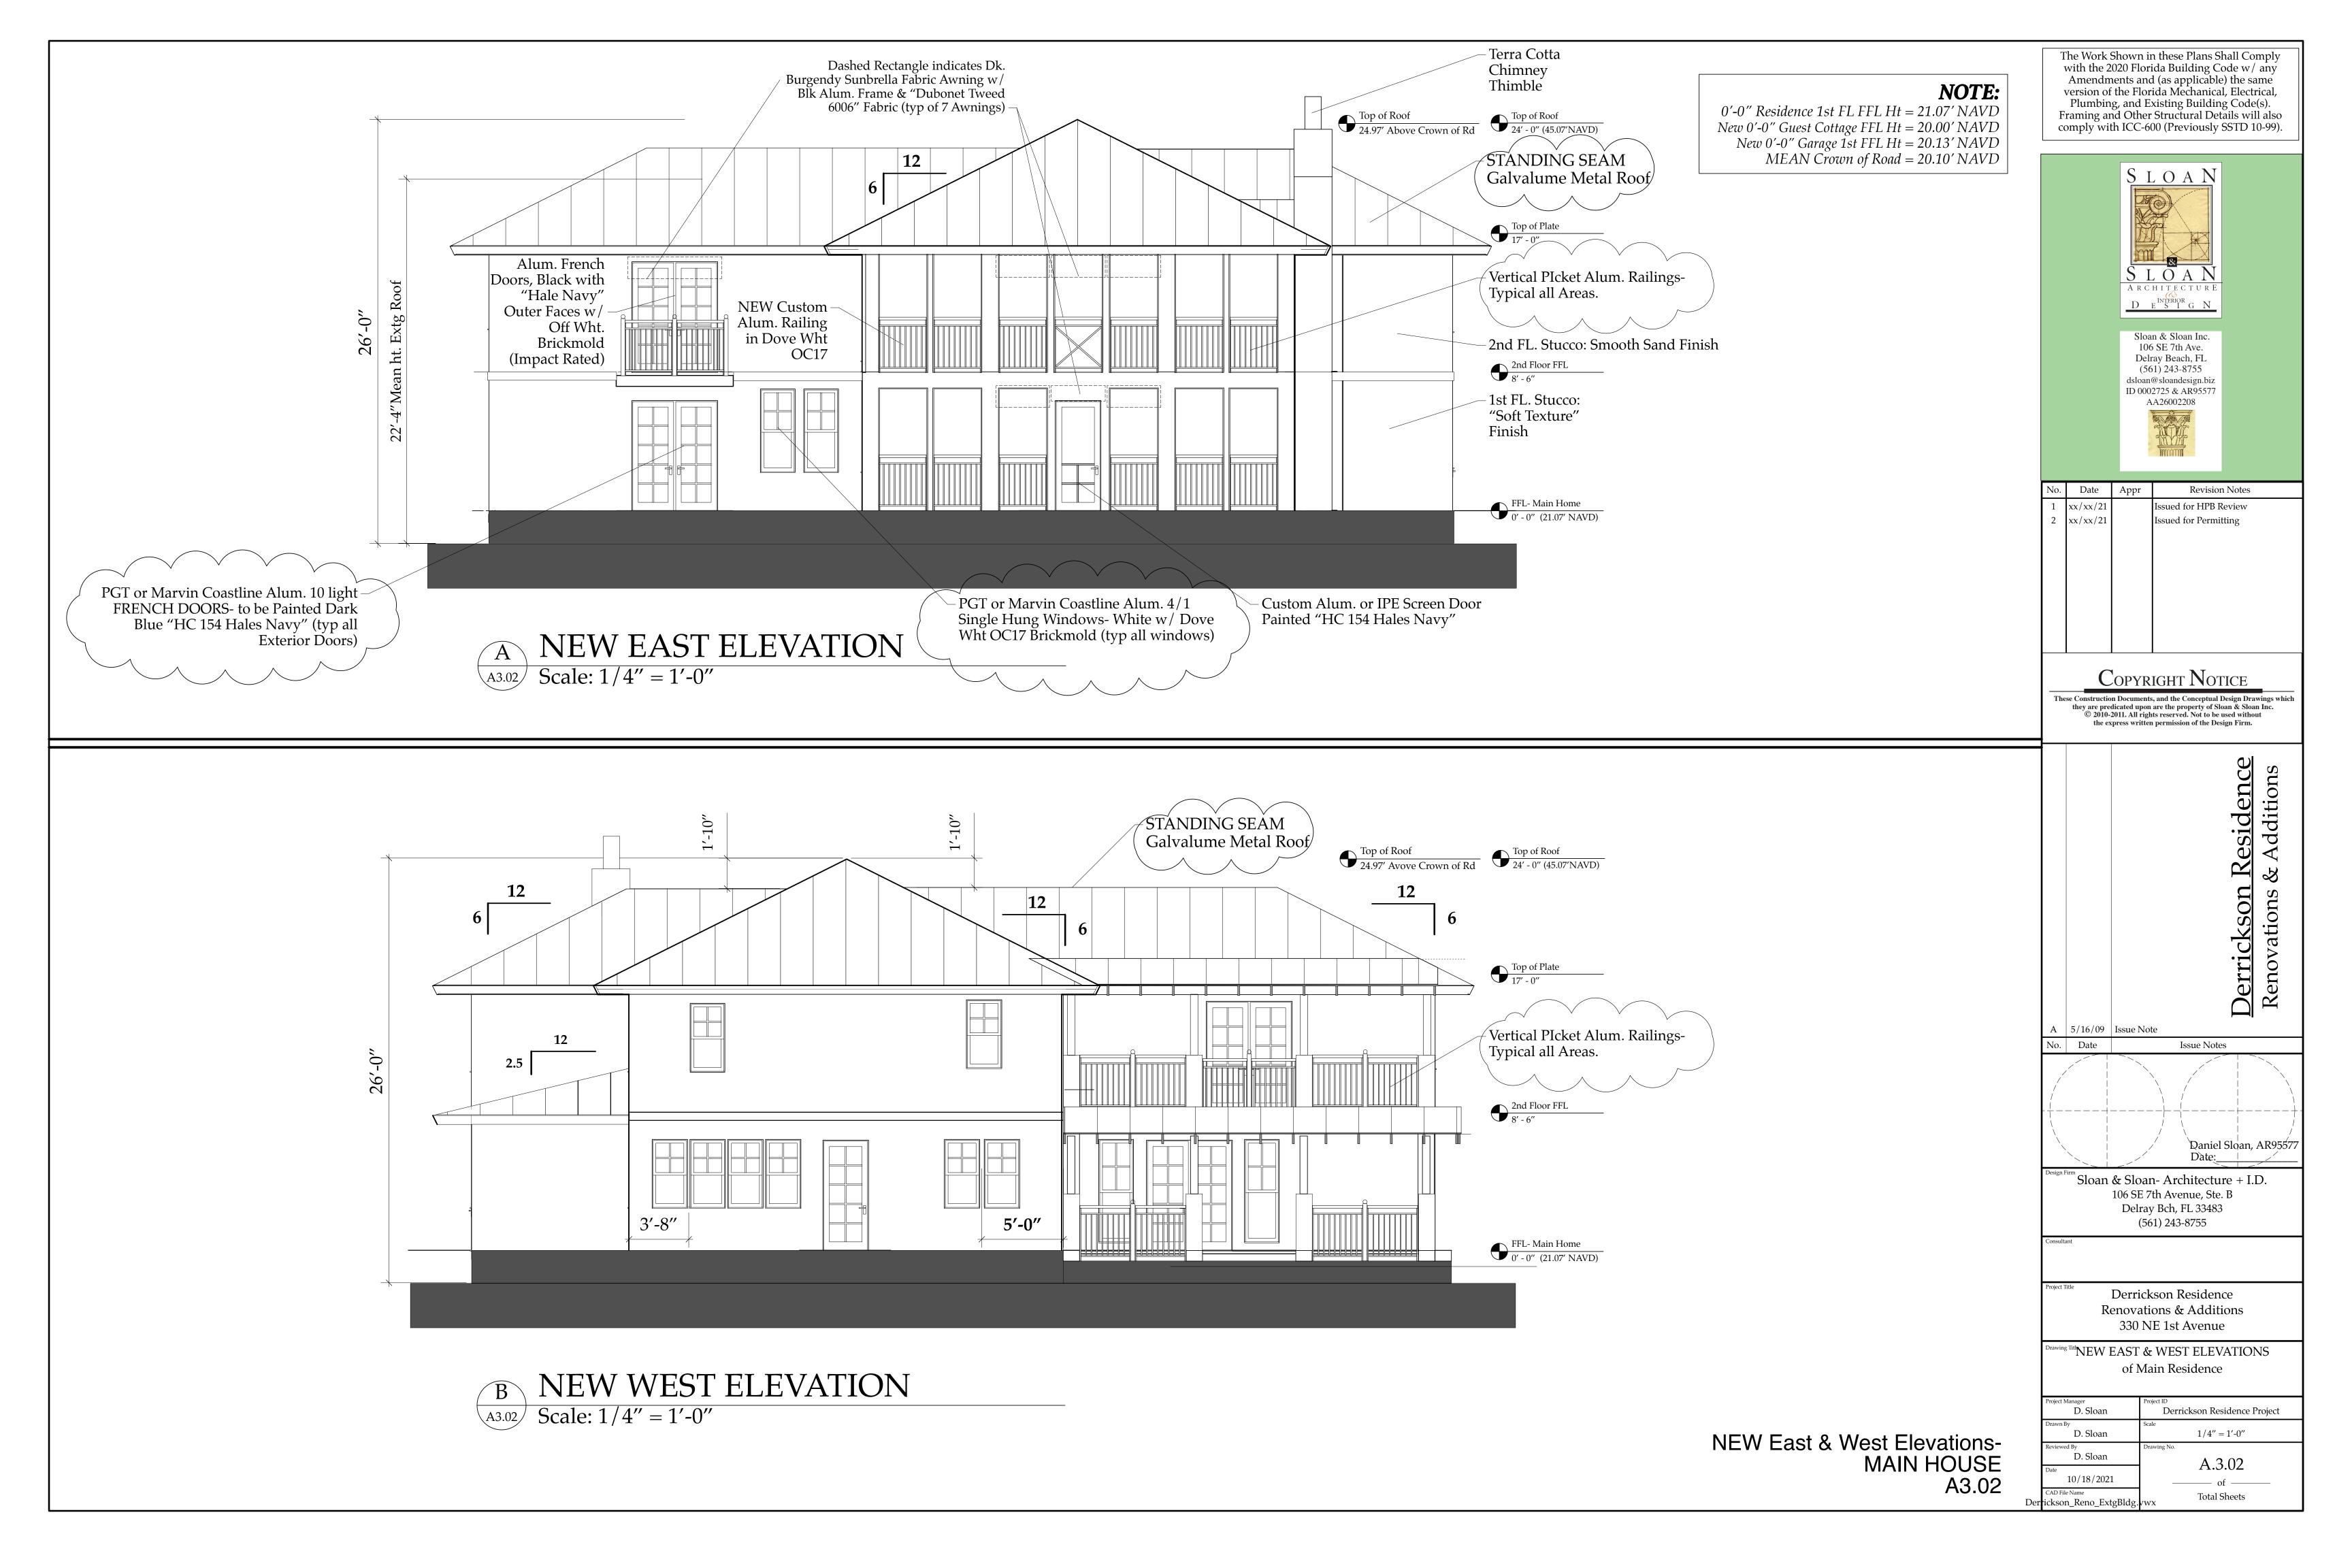


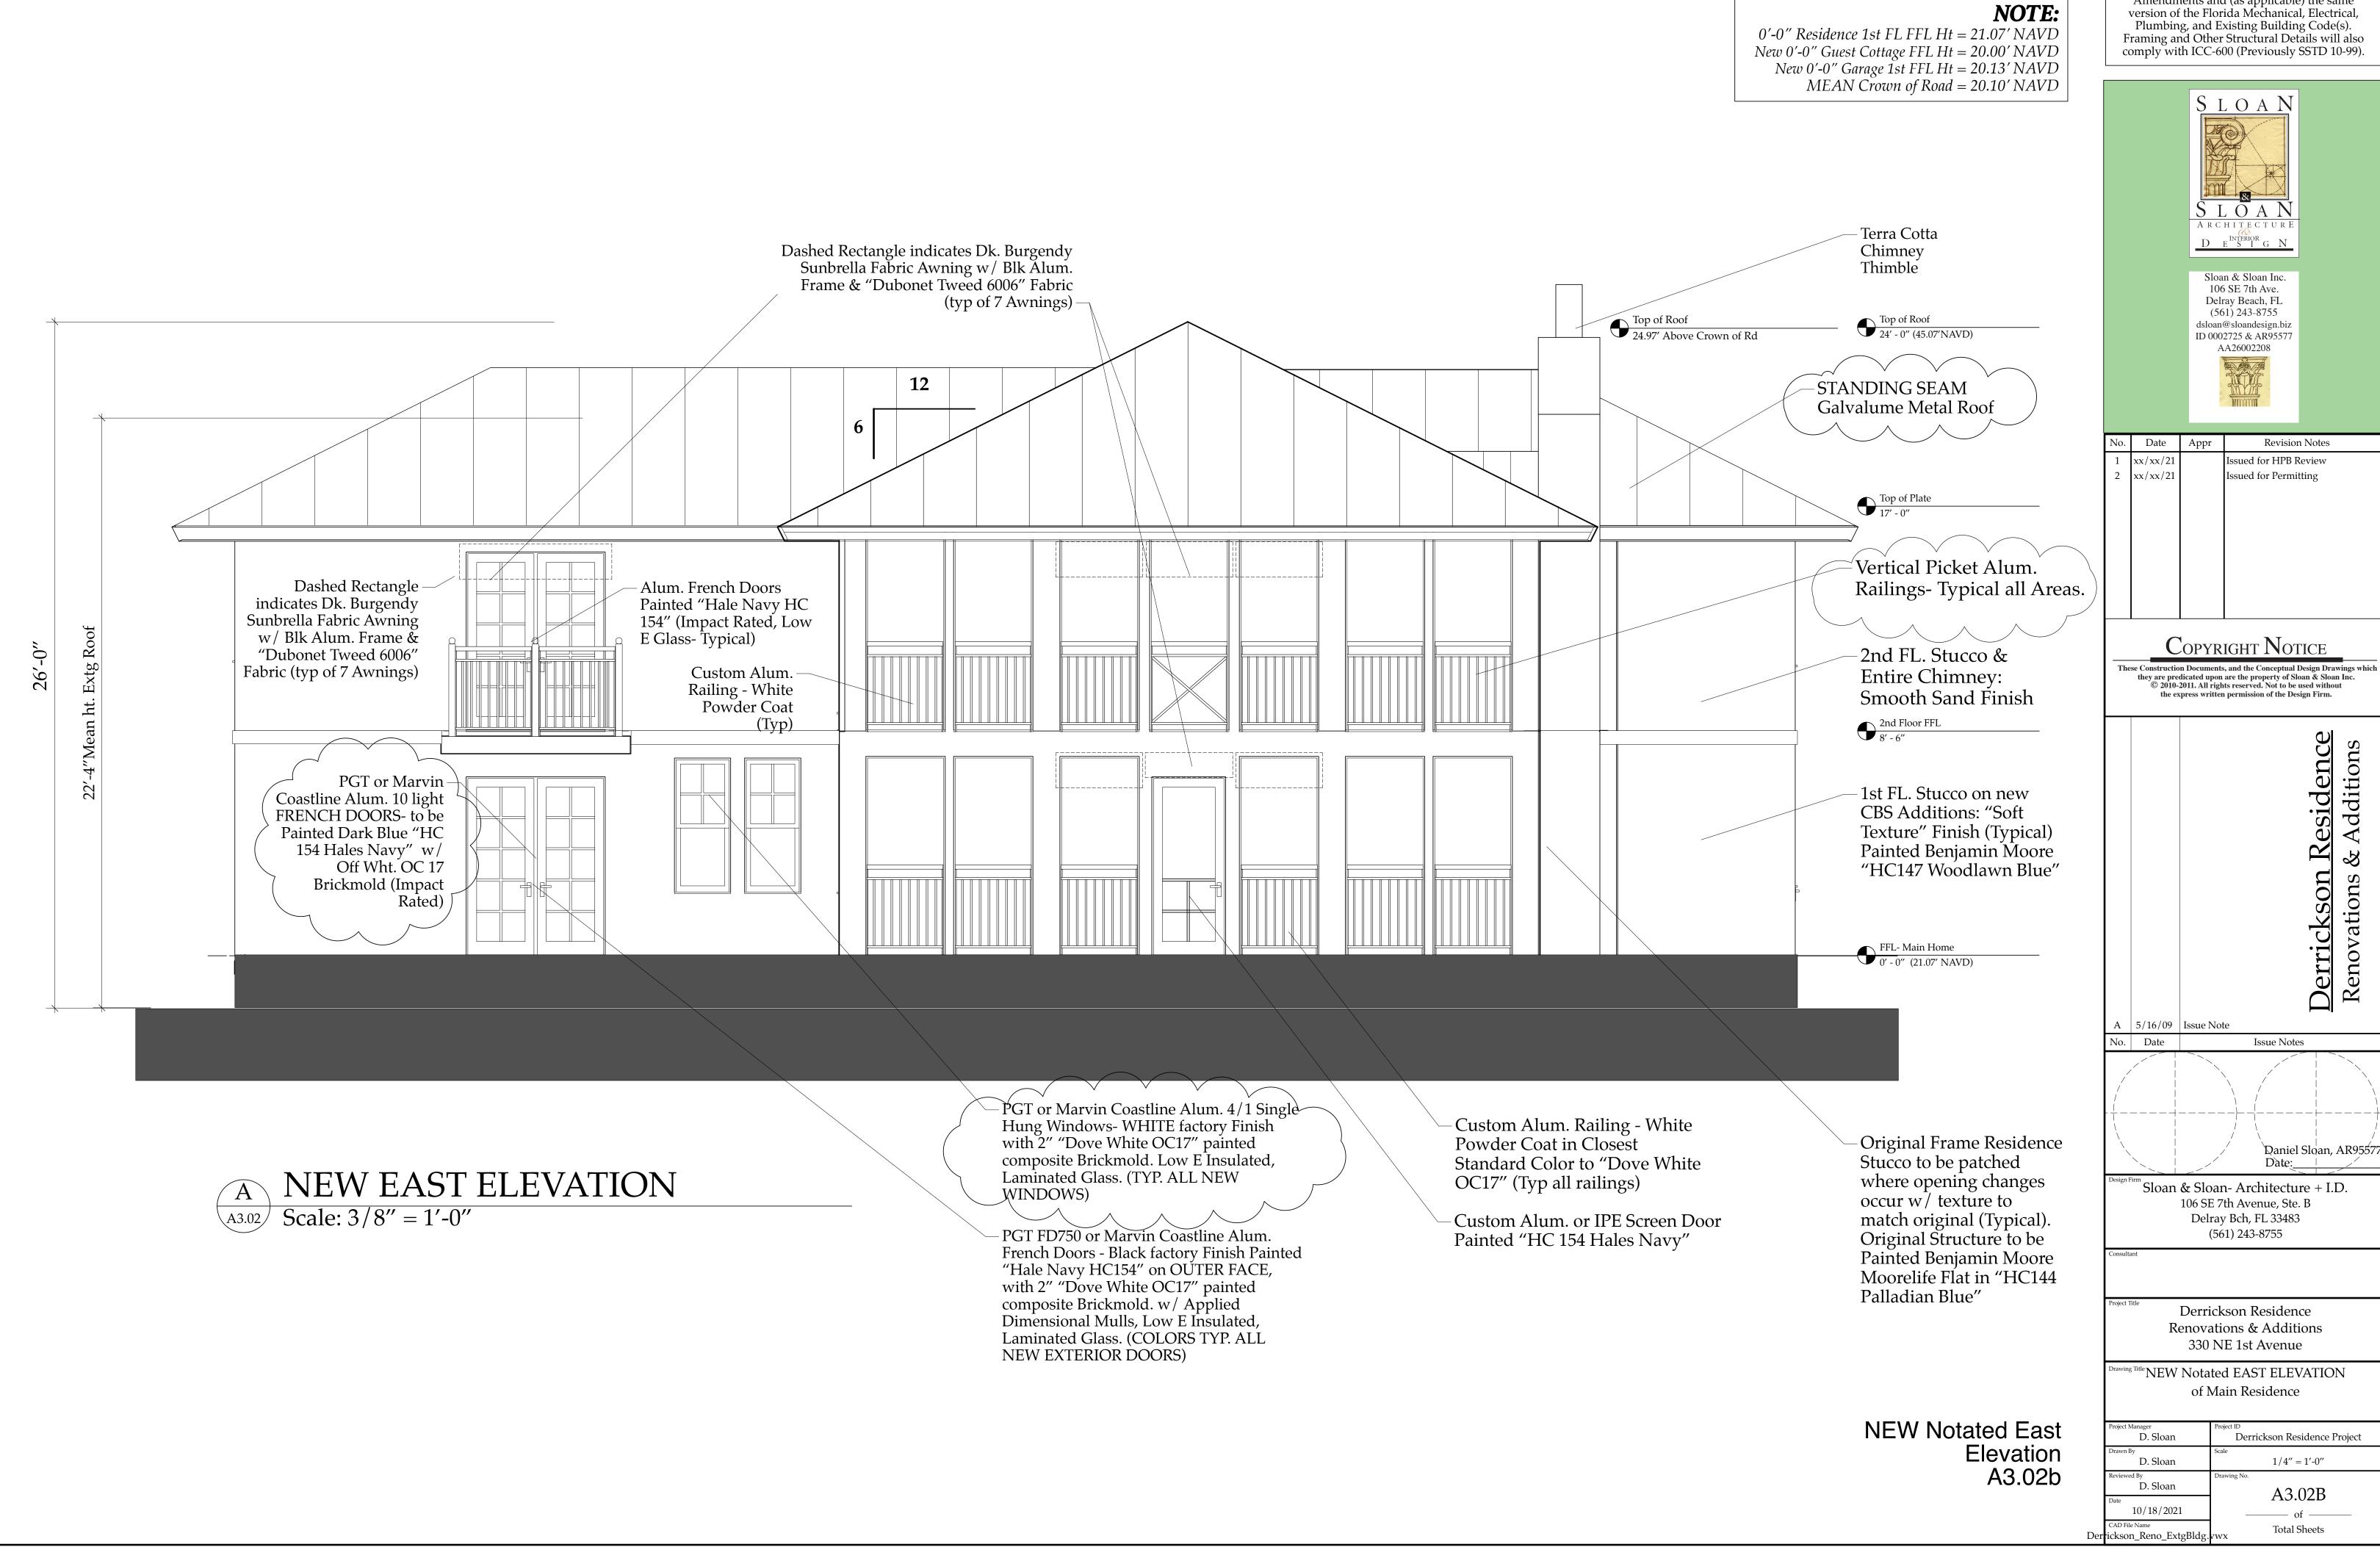

The Work Shown in these Plans Shall Comply with the 2020 Florida Building Code w/ any Amendments and (as applicable) the same version of the Florida Mechanical, Electrical, Plumbing, and Existing Building Code(s). Framing and Other Structural Details will also comply with ICC-600 (Previously SSTD 10-99).

	No.	Date	Appr	Revision Notes
	1	xx/xx/21		Issued for HPB Review
	2	xx/xx/21		Issued for Permitting
3.)				

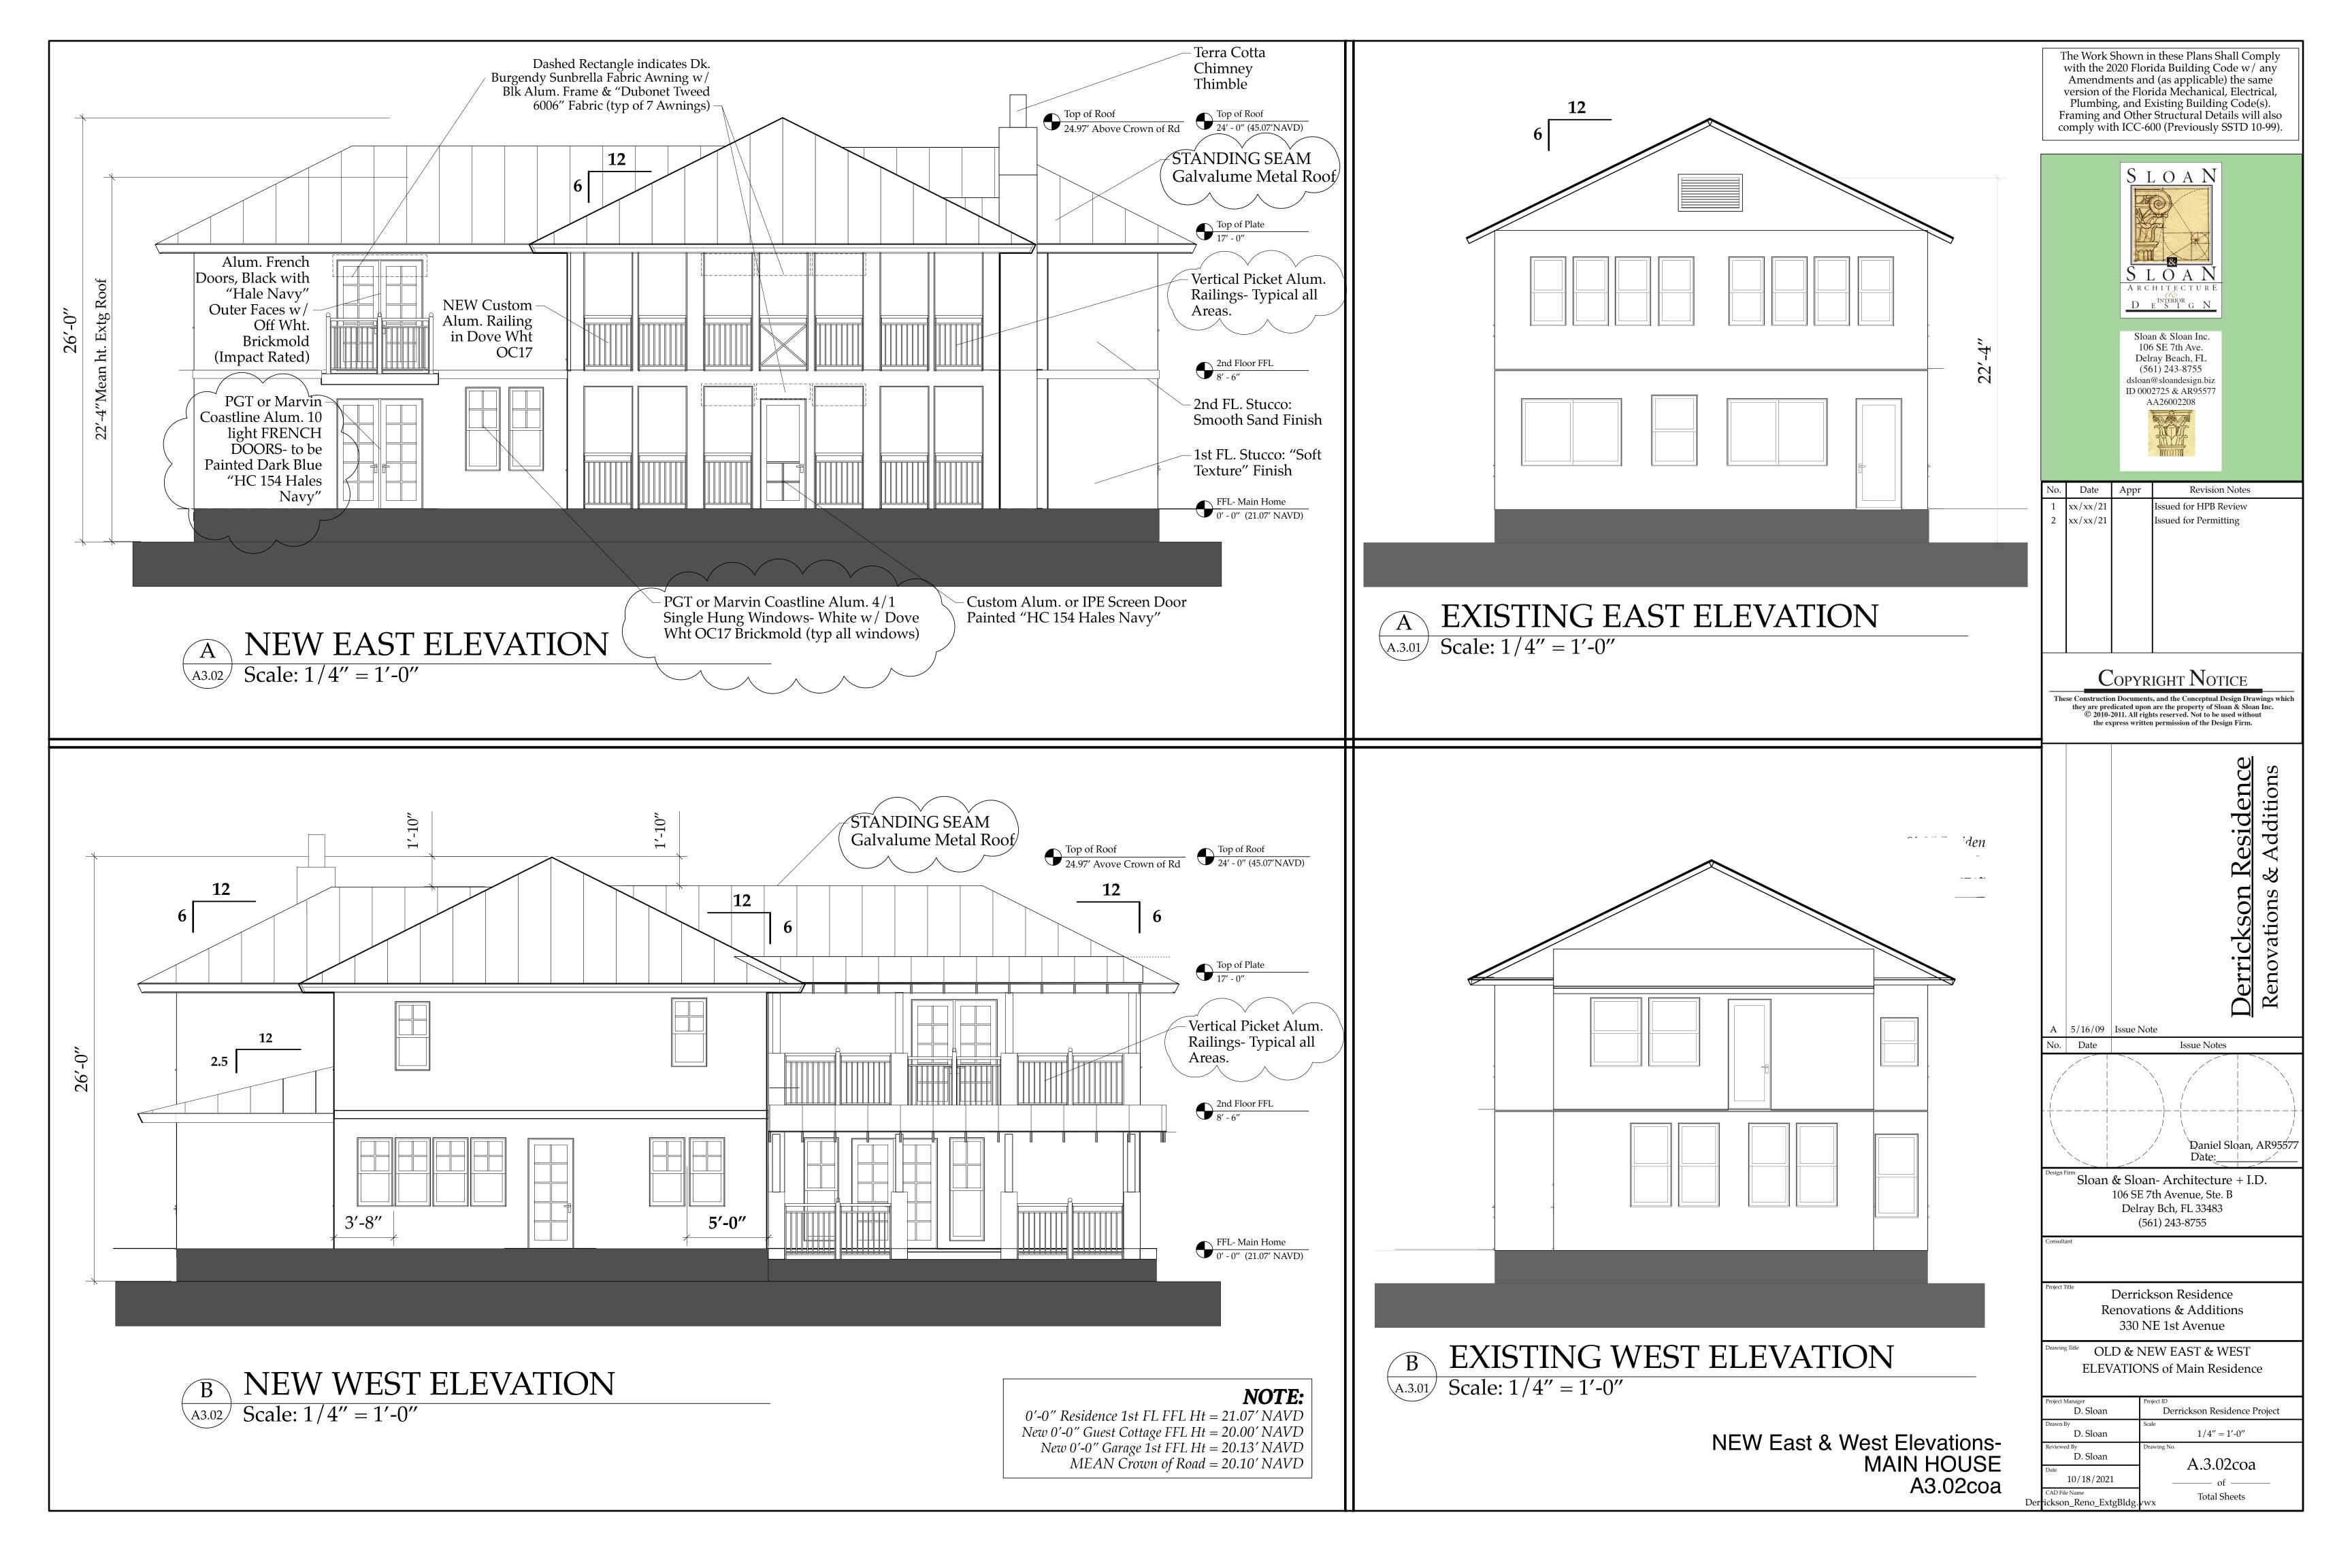

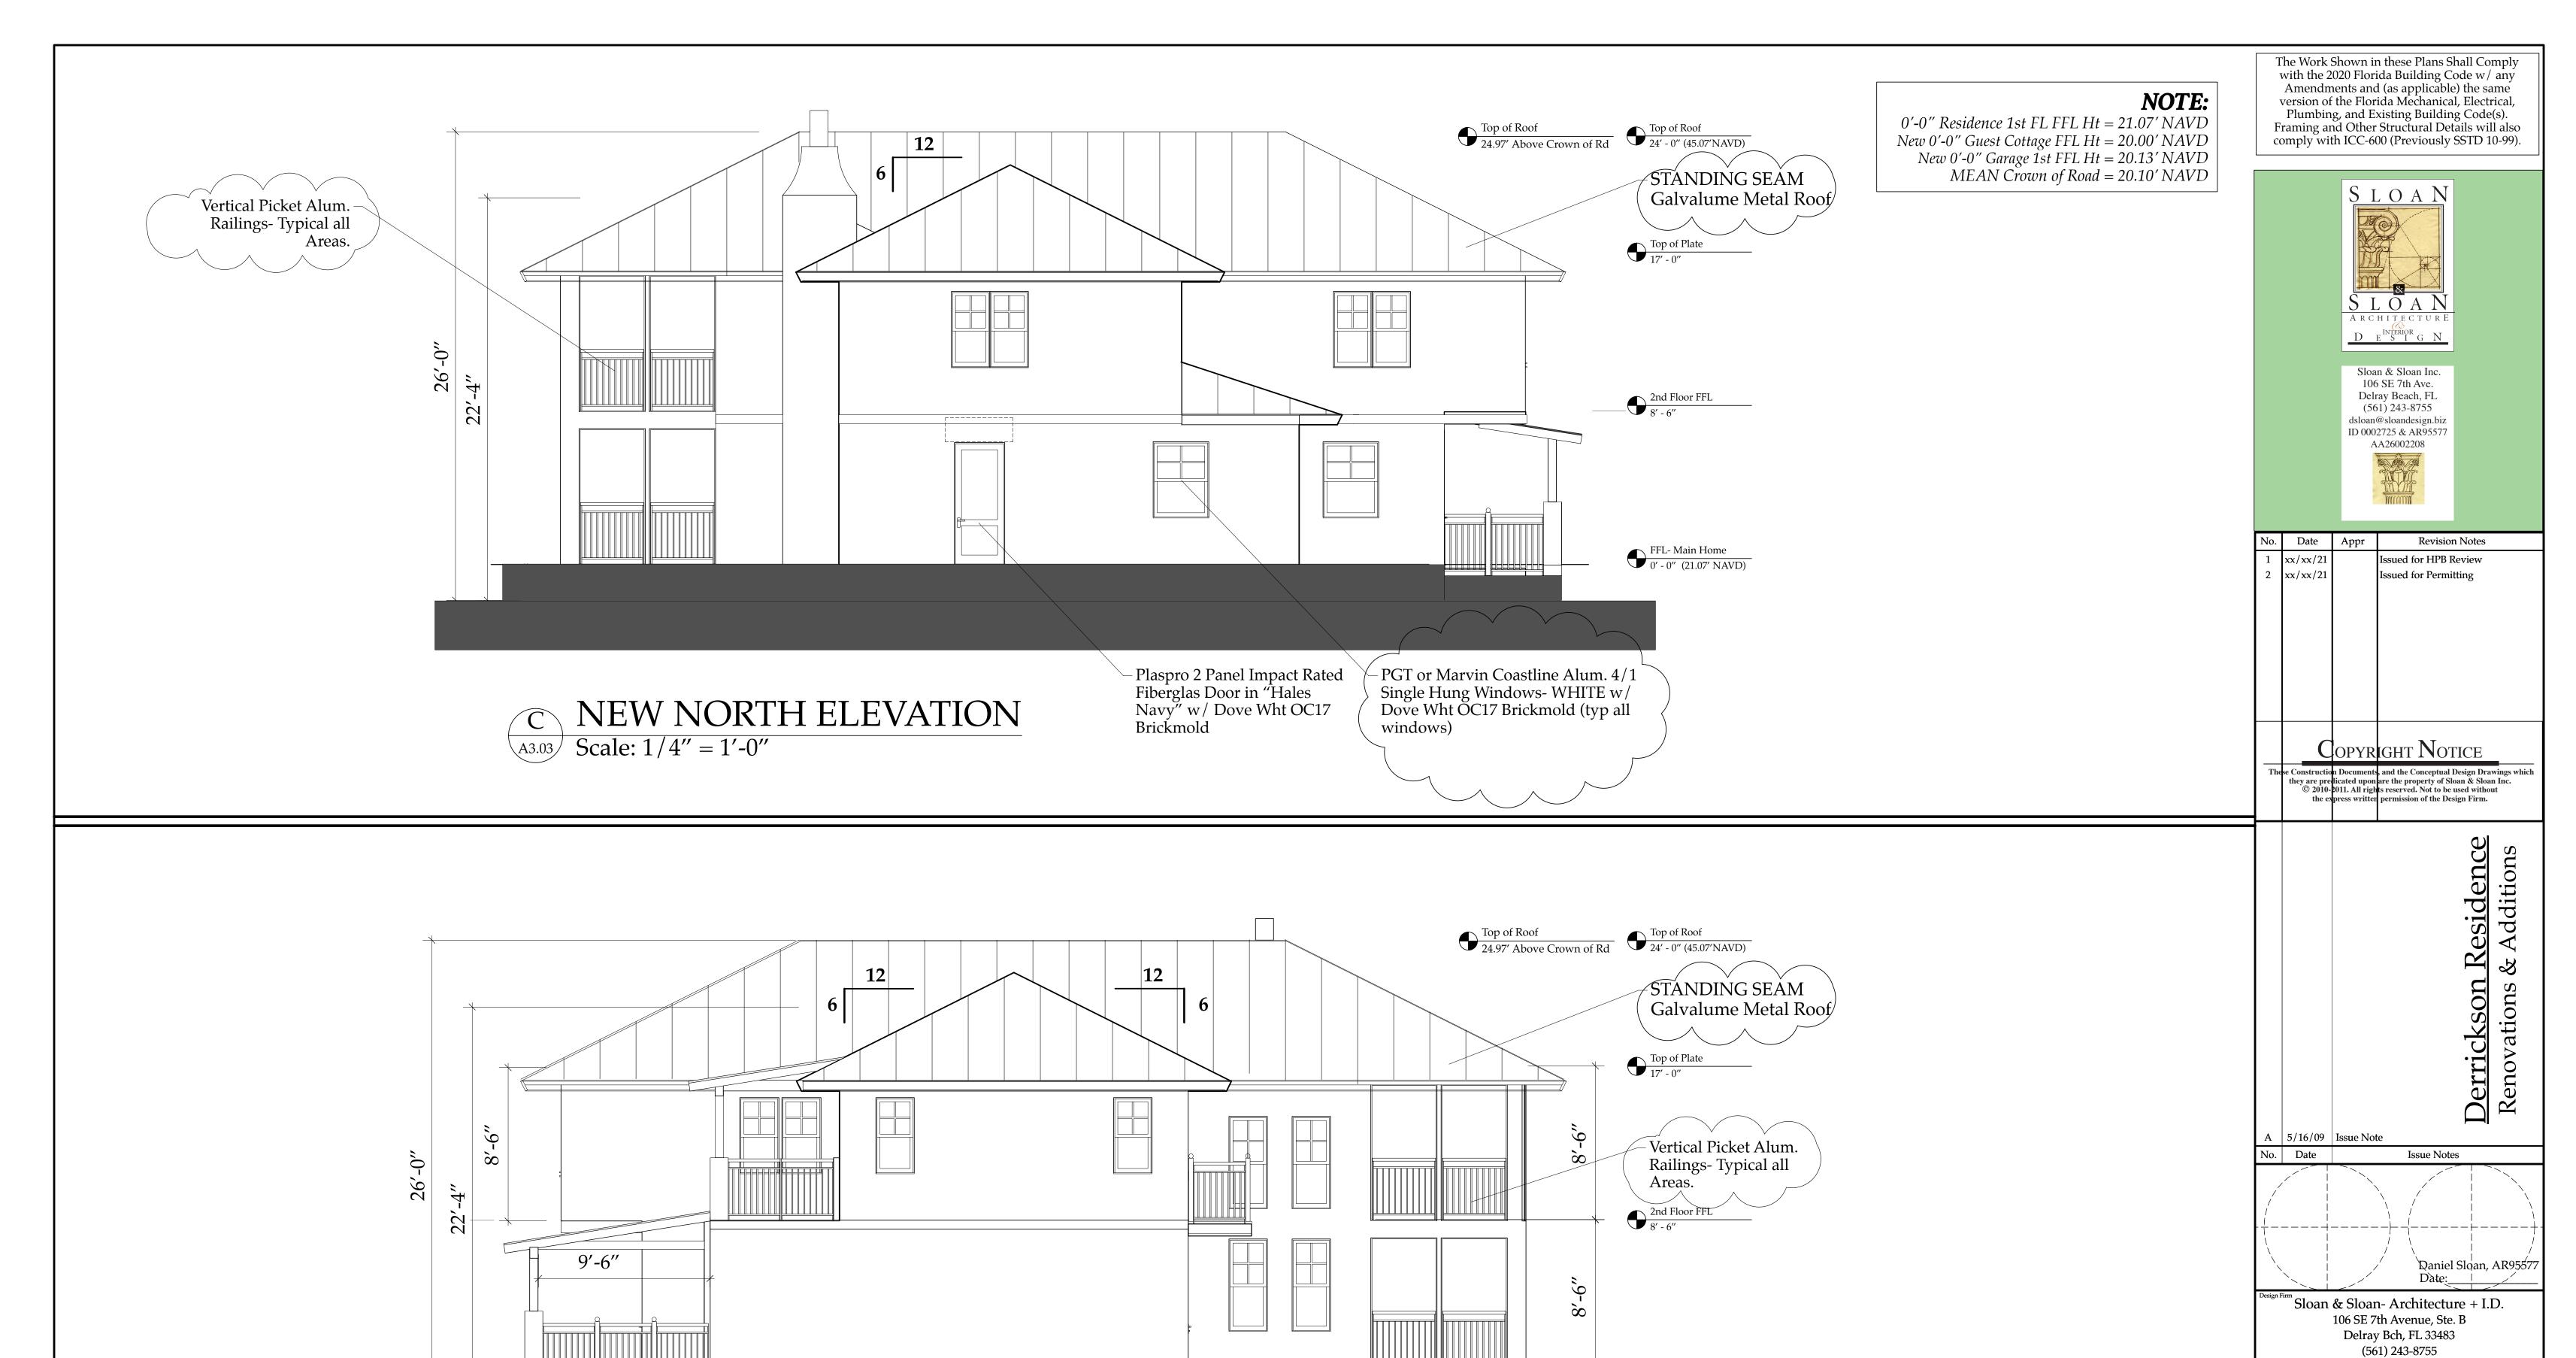

D NEW SOUTH ELEVATION

A3.03 Scale: 1/4" = 1'-0"

NEW North & South Elevations-MAIN HOUSE A3.03


FFL- Main Home
0' - 0" (21.07' NAVD)


Derrickson_Reno_ExtgBldg


Derrickson Residence Renovations & Additions 330 NE 1st Avenue


NEW NORTH & SOUTH

ELEVATIONS of Main Residence

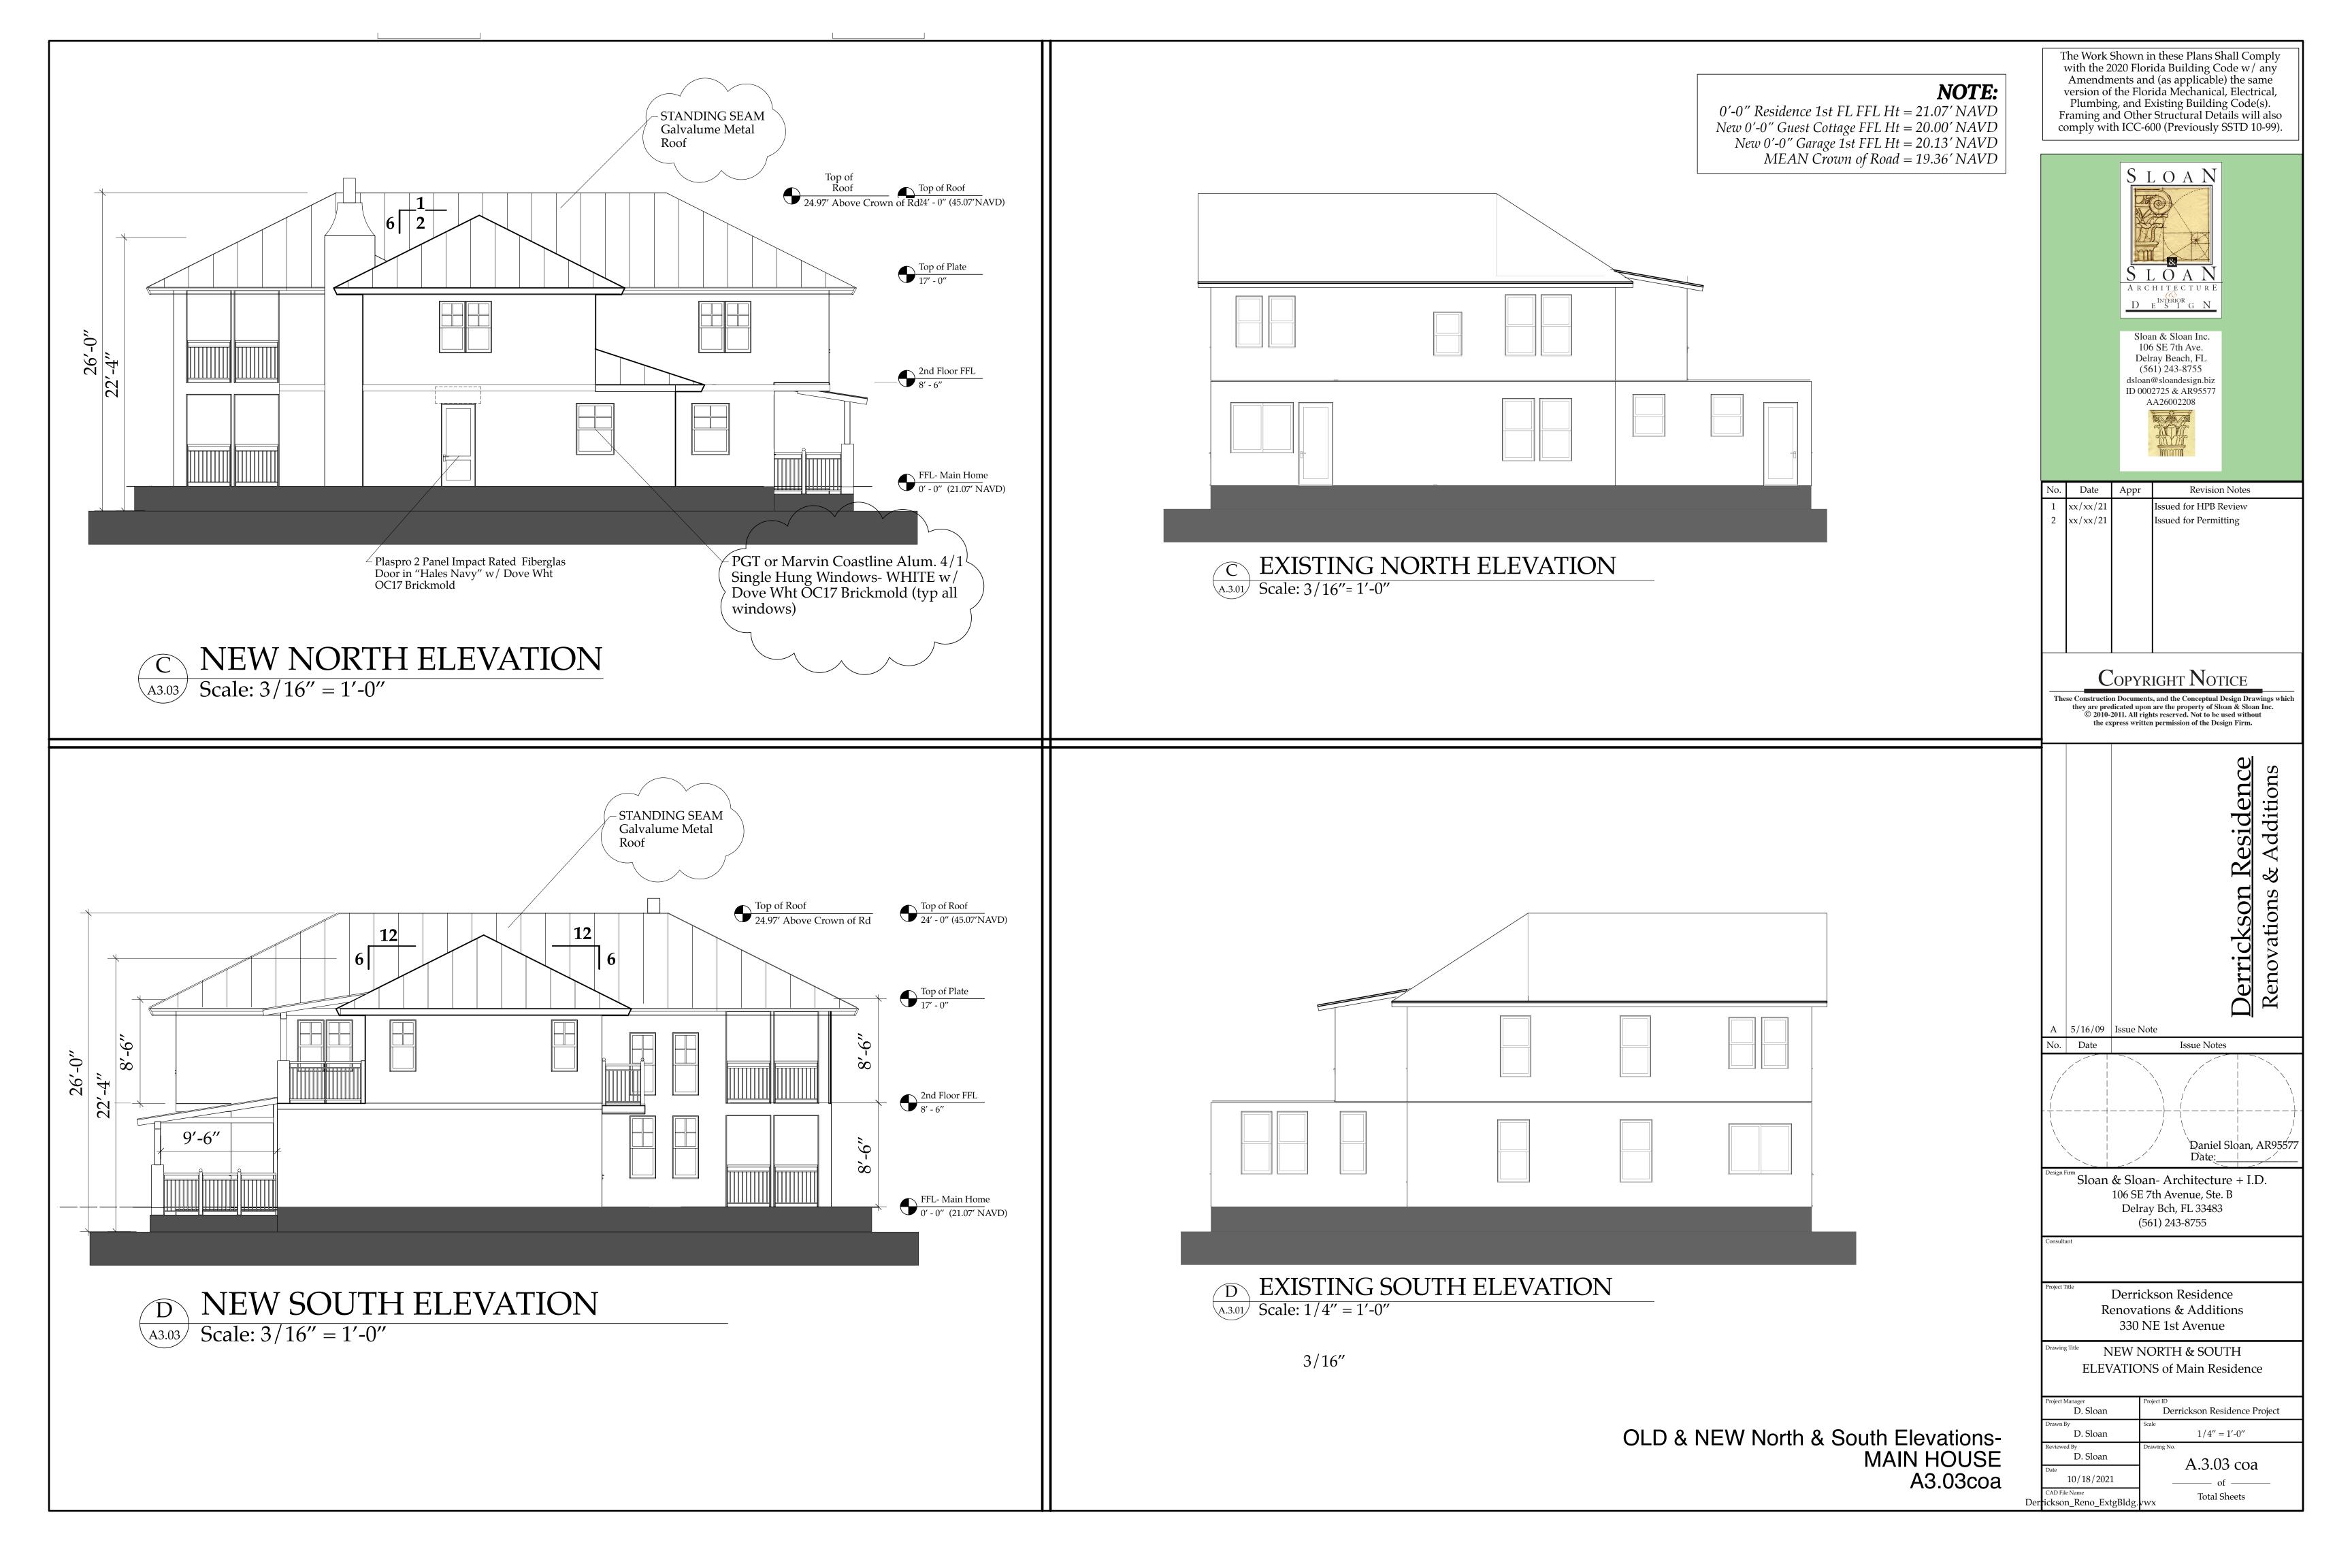

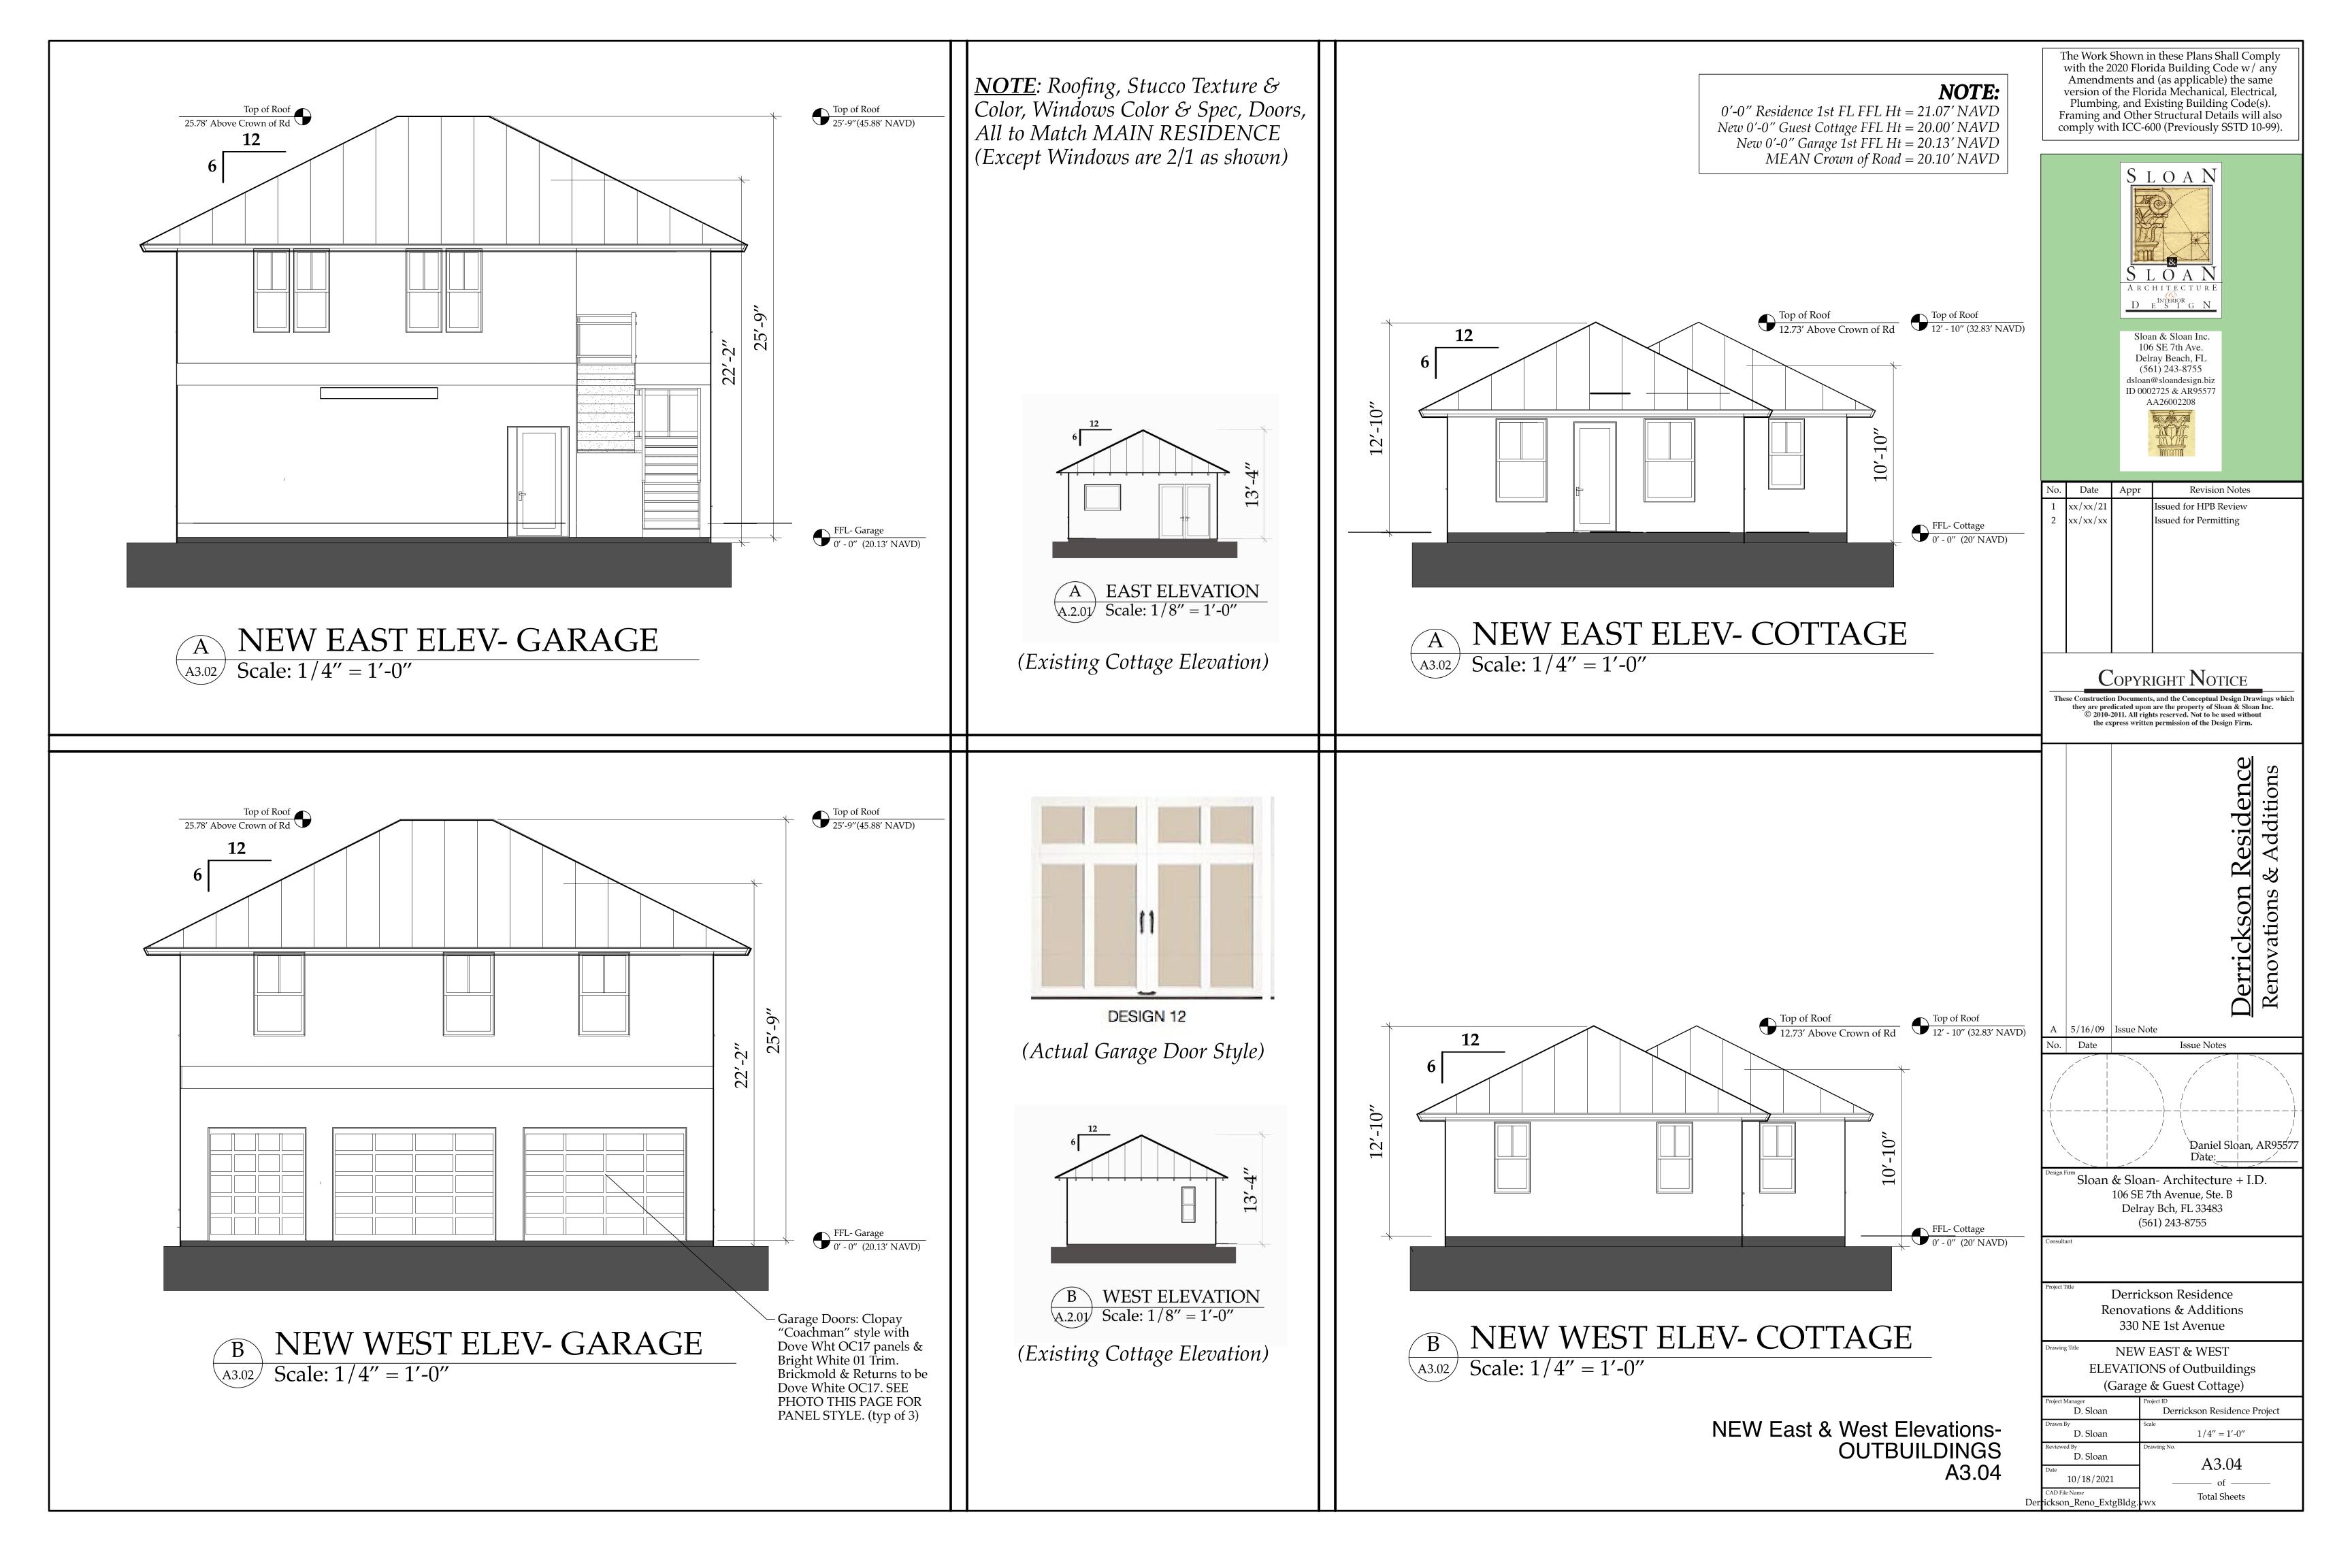

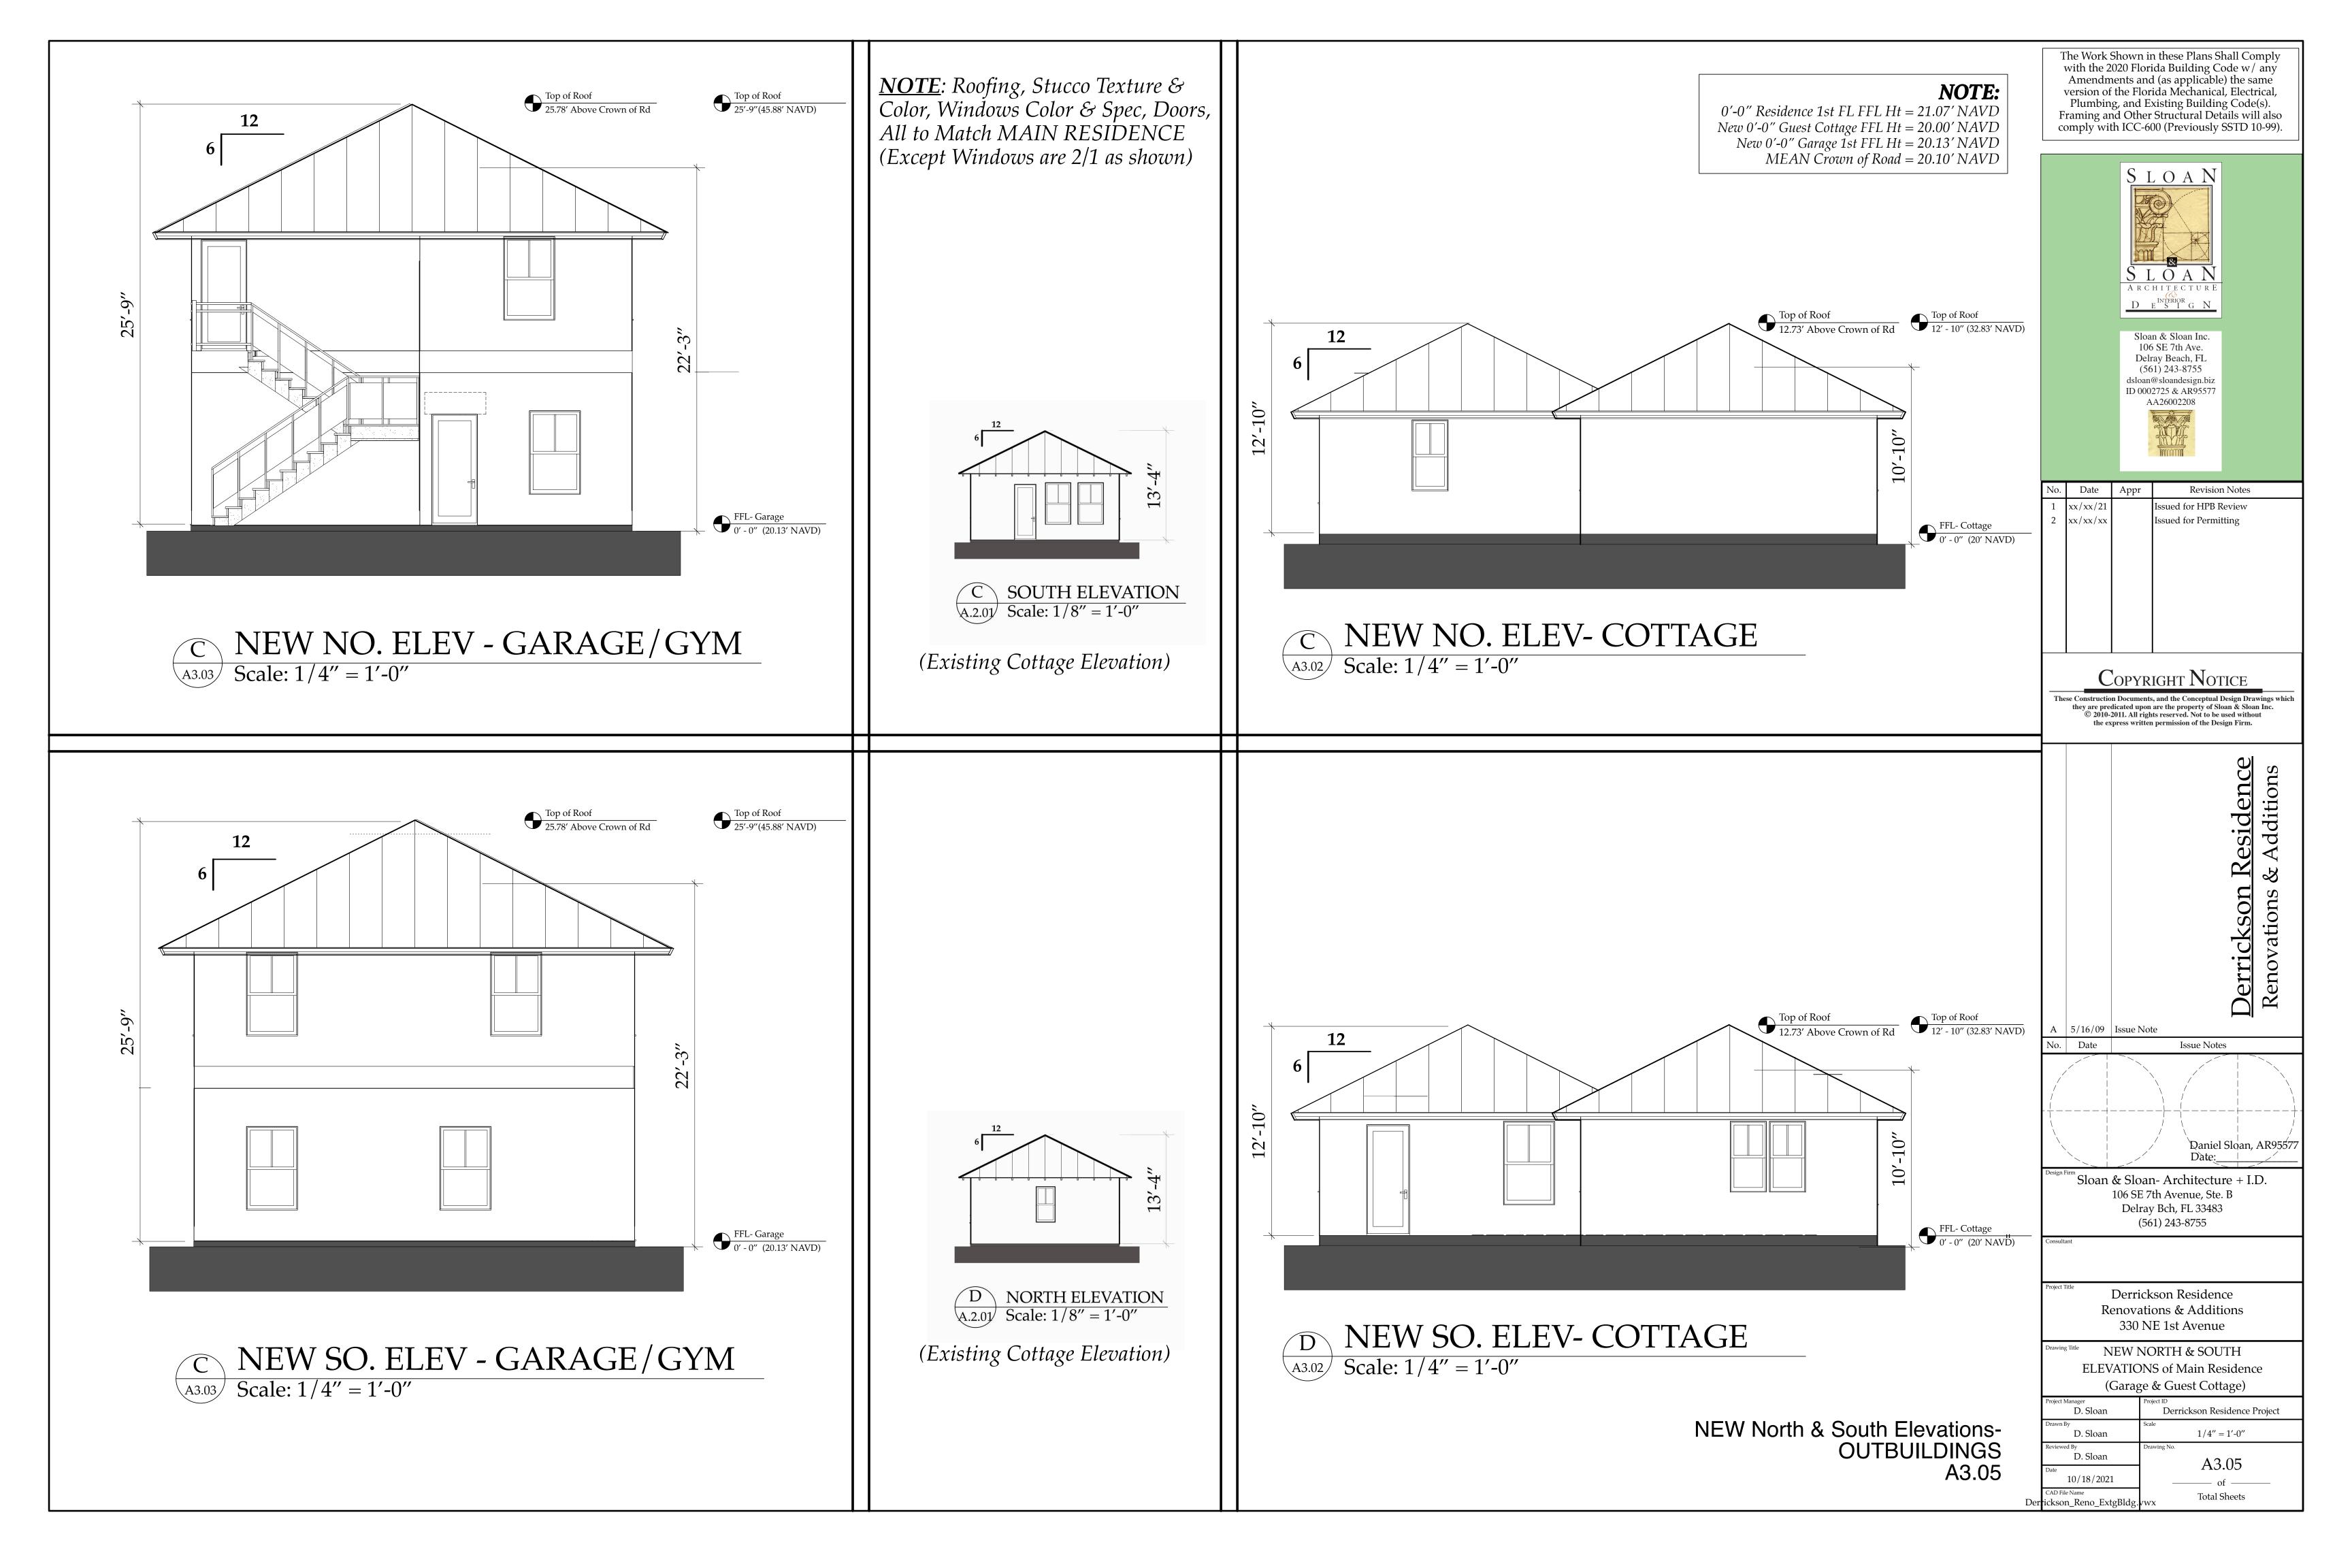


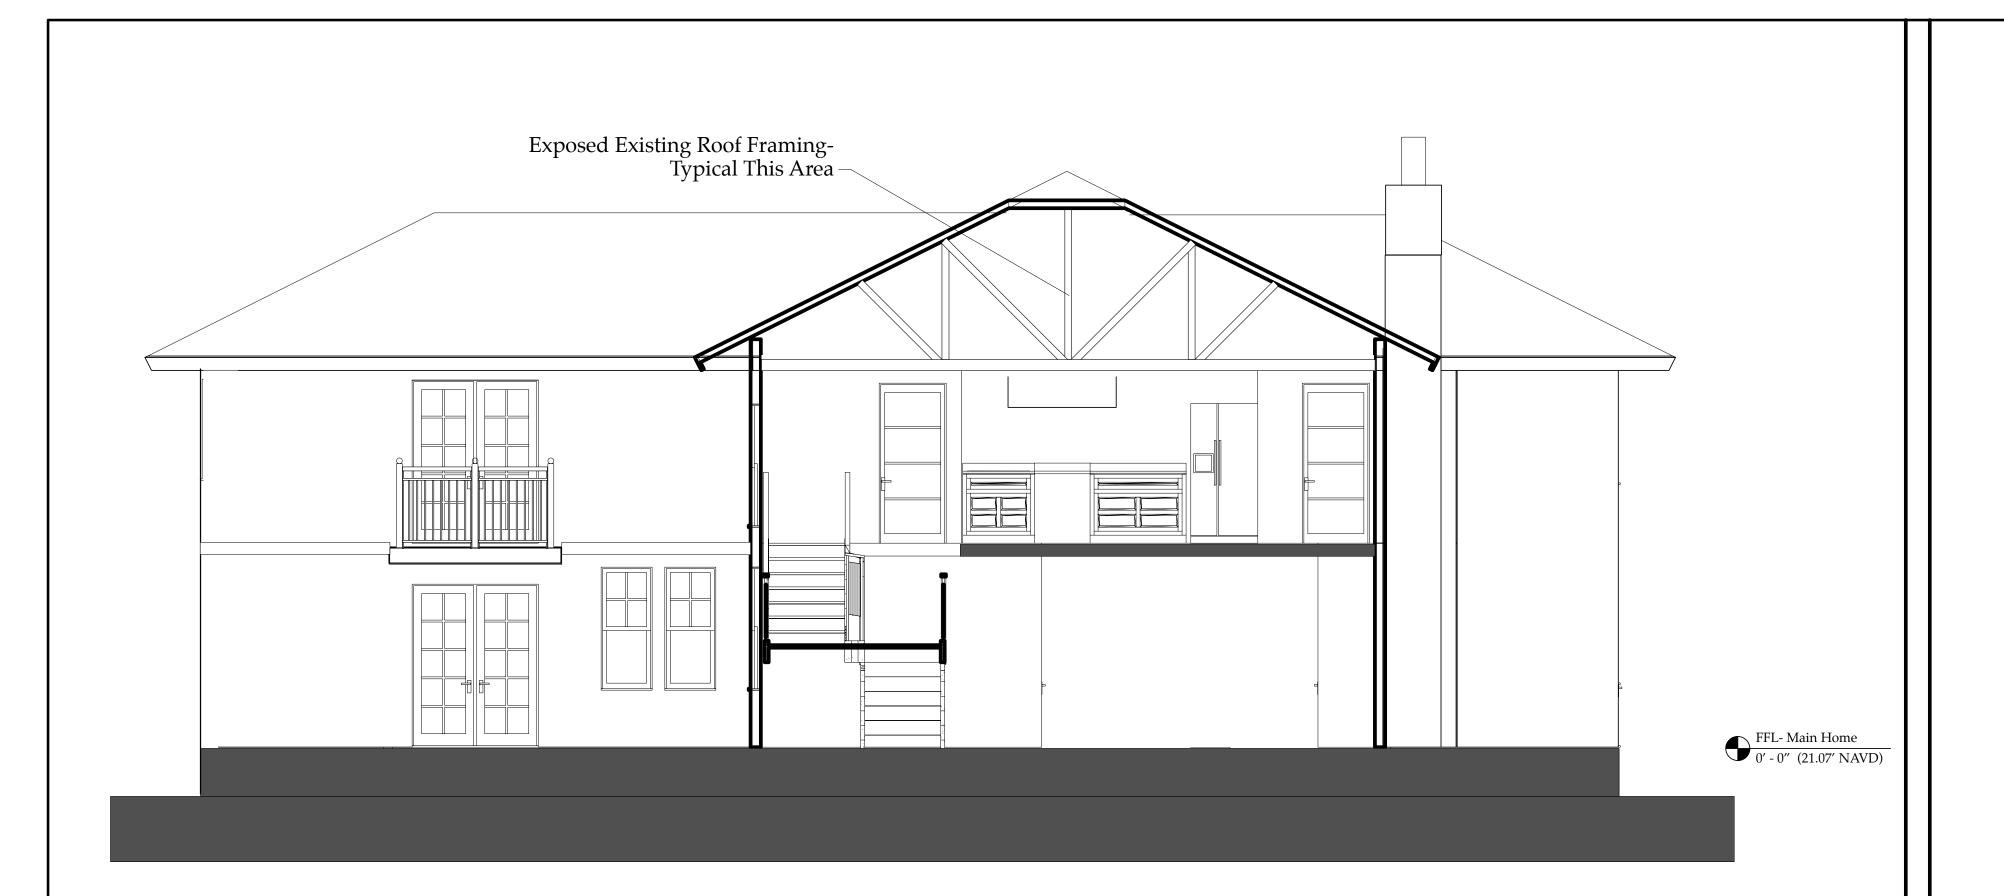

NEW LIVING RM SECTION- Looking West
Scale: 1/4" = 1'-0"


A4.02 Scale: 1/4'' = 1'-0''

NOTE: SEE IMPORTANT NOTES AND SPECIFICATIONS ON SHEET S8.01

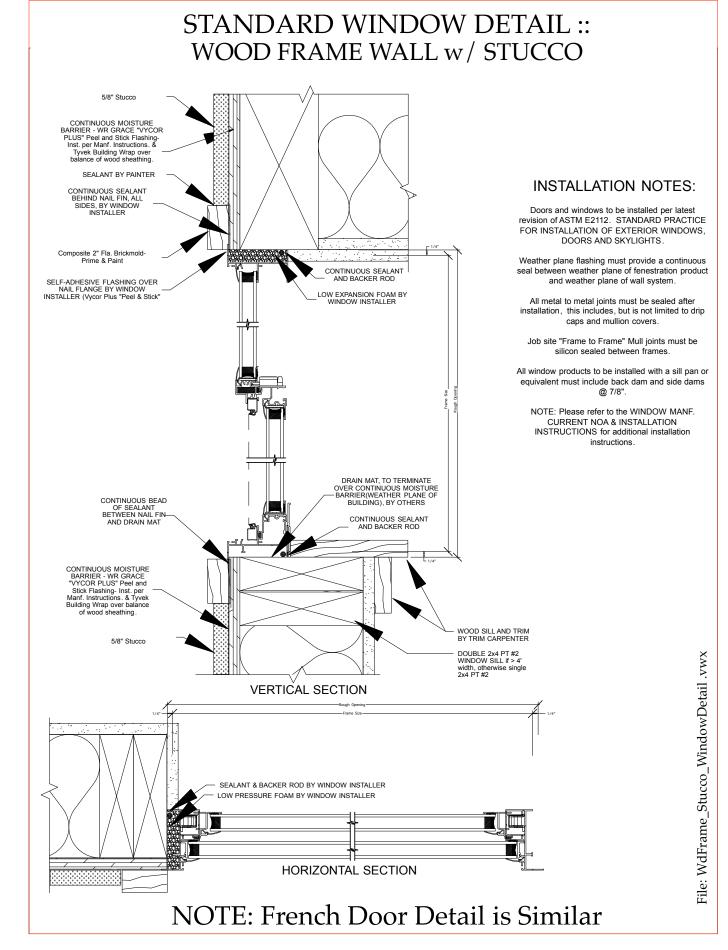

NOTE: Exterior Door Installation Similar- consult NOA & Manf. Installation Directions on Both Window & Door Installation Methods/Proceedures.

The Work Shown in these Plans Shall Comply with the 2020 Florida Building Code w/ any Amendments and (as applicable) the same version of the Florida Mechanical, Electrical, Plumbing, and Existing Building Code(s). Framing and Other Structural Details will also comply with ICC-600 (Previously SSTD 10-99).

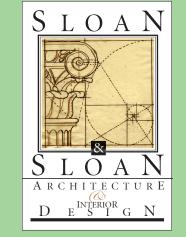

Sloan & Sloan Inc. 106 SE 7th Ave. Delray Beach, FL (561) 243-8755 dsloan@sloandesign.biz ID 0002725 & AR95577 AA26002208



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Derrickson Residence Renovations & Additions

A 5/16/09 Issue Note

No. Date Issue Notes

Robert Selinsky, PE

Date:

Sloan & Sloan- Architecture + I.D. 106 SE 7th Avenue, Ste. B Delray Bch, FL 33483 (561) 243-8755

PENNONI, INC., Structural Engineers 601 N. Congress Ave, Ste. 106a Delray Beach, FL. 33445

Derrickson Residence Renovations & Additions 330 NE 1st Avenue

At Front Porch & at Living Room

Derrickson_Reno_ExtgBldg

D. Sloan

Tawn By
D. Sloan

To perfick the project ID Derrickson Residence Project

Scale

As Noted

Drawing No.

As Noted

Drawing No.

A4.02

A1.02

A1.02

Total Sheets

Marvin Coastline Bifold French Door in Black 9068 Size w / Impact Rated Laminated, Insulated Glass PAINTED "HC 154 HALES NAVY" (NOTE WILL MATCH 2 SETS OF FRENCH DOORS IN APPEARANCE of Stiles & Rails, etc.) --PGT FD750 or Marvin Coastline Alum. French Door in Black Dbl 3068 Size w/ Impact Rated Laminated, Insulated Glass. PAINTED "HC154 HALES NAVY" (Typ of 4 sets of Doors at Porches) FFL- Main Home

0' - 0" (21.07' NAVD) NEW EAST FRONT PORCH SECTION / ELEVATION

Building Sections A4.02

NOTE: PT #2 = "Southern Yellow Pine #2 or Better"