


PROJECT TEAM & INDEX

# 524 W ATLANTIC AVE DELRAY BEACH, FLORIDA 33444

		SCOPE OF WORK	VICINITY MAP
BH3 MANAGEMENT 21500 BISCAYNE BLVD AVENTURA, FL 33180  AVRAM NEW T: 1.954.416.3140x227	SSUED FOR ZONING 10.02 2020 12.15.2020 12.15.2020	THE APPLICANT SEEKS TO: (1) CHANGE THE EXISTING USE OF THE PROPERTY FROM STANDALONE BAR TO A RESTAURANT (2) BUILD OUT A NEW KITCHEN AND ADA COMPATIBLE BATHROOM, AND (3) TO INCORPORATE 1336 SF OF THE OUTDOOR AREA AS OUTDOOR DINING SPACE, BOCCE COURT & BATHROOM. THE APPLICANT PREVIOUSLY INSTALLED PAVERS IN ITS OUTDOOR AREA AS WELL AS A WALK IN COOLER WITHOUT A PERMIT, WHICH THIS PLAN SET SEEKS TO RECTIFY IN ADDITION TO THE IMPROVEMENTS EXPRESSED ABOVE.	
F: avram@hh3llc.com	SPI SITE PLAN & DETAILS	PROJECT INFORMATION	
STEVEN E. MYOTT, ARCHITECT 639 EAST OCEAN AVENUE, SUITE 403 BOYNTON BEACH, FLORIDA 33435 T: 561.734.7034  MARK BORG  E: mborg@semarchitecture.com	All EXTERIOR ELEVATIONS  ALL DETAILS  A3 PHOTOMETRIC PLAN  CIVIL ENGINEERING  C-1 CIVIL PLANS-LOCATION MAP AND COVER SHEET  C-2 GRADING PLAN AND DRAINAGE CALCULATIONS  • • • • • • • • • • • • • • • • • • •	LEVEL OF ALTERATION LEVEL II PER FEBC SEC 504 HEIGHT OF BUILDING ISTORY (14 FT) SITE AREA 0.0043 ACRES EXISTING BUILDING AREA 1.380 SF. (INCLUDING EXISTING WALK-IN COOLER) PROPOSED NEW OUTDOOR USE AREA 1.336 SF. (INCLUDES BOCCE COURT, OUTDOOR SEATING & BATHROOM)	ILROAD  TABLE TO STATE  THE STATE OF THE STA
FLORIDA CONSULTING ENGINEERS, INC. 134 NW 16TH ST, SUITE 1 BOCA RATON, FLORIDA 33432 T: 561.353.1152	LANDSCAPE PLAN  LANDSCAPE PLAN	TOTAL SEATING COUNT	SW 10TH ST NORT
ZUHAIR JALLOUL, PE E: zjpe@flcengineers.com		PER 2017 PLUMBING CODE SEC 403.1.1 NUMBER OF OCCUPANTS OF EACH SEX. THE OCCUPANT LOAD SHALL BE COMPOSED OF 50 PERCENT OF EACH SEX: PER TABLE 403.1:  FIXTURE REQUIREMENTS: (PER FBC 403.1)	
968 DOGWOOD DR DELRAY BEACH, FL 33483 T: 561.279.4114		### FIXTURES PROVIDED:  WATER CLOSETS: 3 (2 TOILETS & I URINAL) LAVATORIES: 2  TOTAL BATHROOM CAPACITY: 150 PEOPLE (15 MEN & 15 WOMEN)	LOCATION MAP
		ADDITIONAL NOTES	
		SPRAB NOTES:  A TWO-FOOT DEDICATION WILL BE REQUIRED IF THE BUILDING IS MODIFIED IN THE FUTURE, AS THE EXISTING BUILDING ENCROACHES TWO FEET ONTO ATLANTIC AVENUE RIGHT OF WAY WHICH IS 55 FEET.  SPRAB COMMENT NOTE ADDED	NW 2ND ST  ATLANTIC AVE  SW 3RD ST  NORTH
	T: 1.954.416.3140x227 E: avram@bh3llc.com  STEVEN E. MYOTT, ARCHITECT 639 EAST OCEAN AVENUE, SUITE 403 BOYNTON BEACH, FLORIDA 33435 T: 561.734.7034  MARK BORG E: mborg@semarchitecture.com  FLORIDA CONSULTING ENGINEERS, INC. 134 NW 16TH ST, SUITE 1 BOCA RATON, FLORIDA 33432 T: 561.353.1152  ZUHAIR JALLOUL, PE E: zjpe@flcengineers.com  MAUREEN SMITH LANDSCAPE ARCHITECT 968 DOGWOOD DR DELRAY BEACH, FL 33483 T: 561.279.4114	E: avram@bh3lic.com    COR   COMER BLEET	ARAM NEW  T. 1 956 4173.1 40207 E. evranightistic.com  STEVEN E. MYOTT, ARCHITECT 30 54570 DEAN ARCHITECT 30 54570 DEAN ARCHITECT 30 54570 DEAN ARCHITECT 30 5770 SEACH COLOR SA3455  DOWNTON BEACH, FLORIDA SA3455  COLOR SAST DEAN ARCHITECT 30 5770 SEACH COLOR SA3456  DOWNTON BEACH, FLORIDA SA3456  COLOR SAST DEAN ARCHITECT 30 5770 SEACH COLOR SA3456  COLOR SAST DEAN ARCHITECT 30 5770 SEACH COLOR SA3456  COLOR SAST DEAN ARCHITECT 30 5770 SEACH COLOR SA3456  COLOR SAST DEAN ARCHITECT 30 5770 SEACH COLOR SA3456  COLOR SAST DEAN ARCHITECT 30 5770 SEACH COLOR SA3456  COLOR SAST DEAN ARCHITECT 30 5770 SEACH SA3457  COLOR SAST DEAN ARCHITECT 30 5770 SEAC

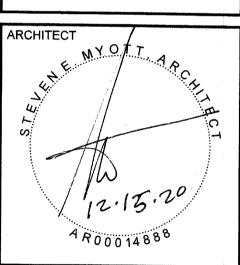


NO: DATE: ISSUED FOR:

1 08.20.2020 ZONING RESPONSES

2 08262020 1 ZONING COMMENTS

3 12.152020 SSPRAB COMMENTS

COVER SHEET

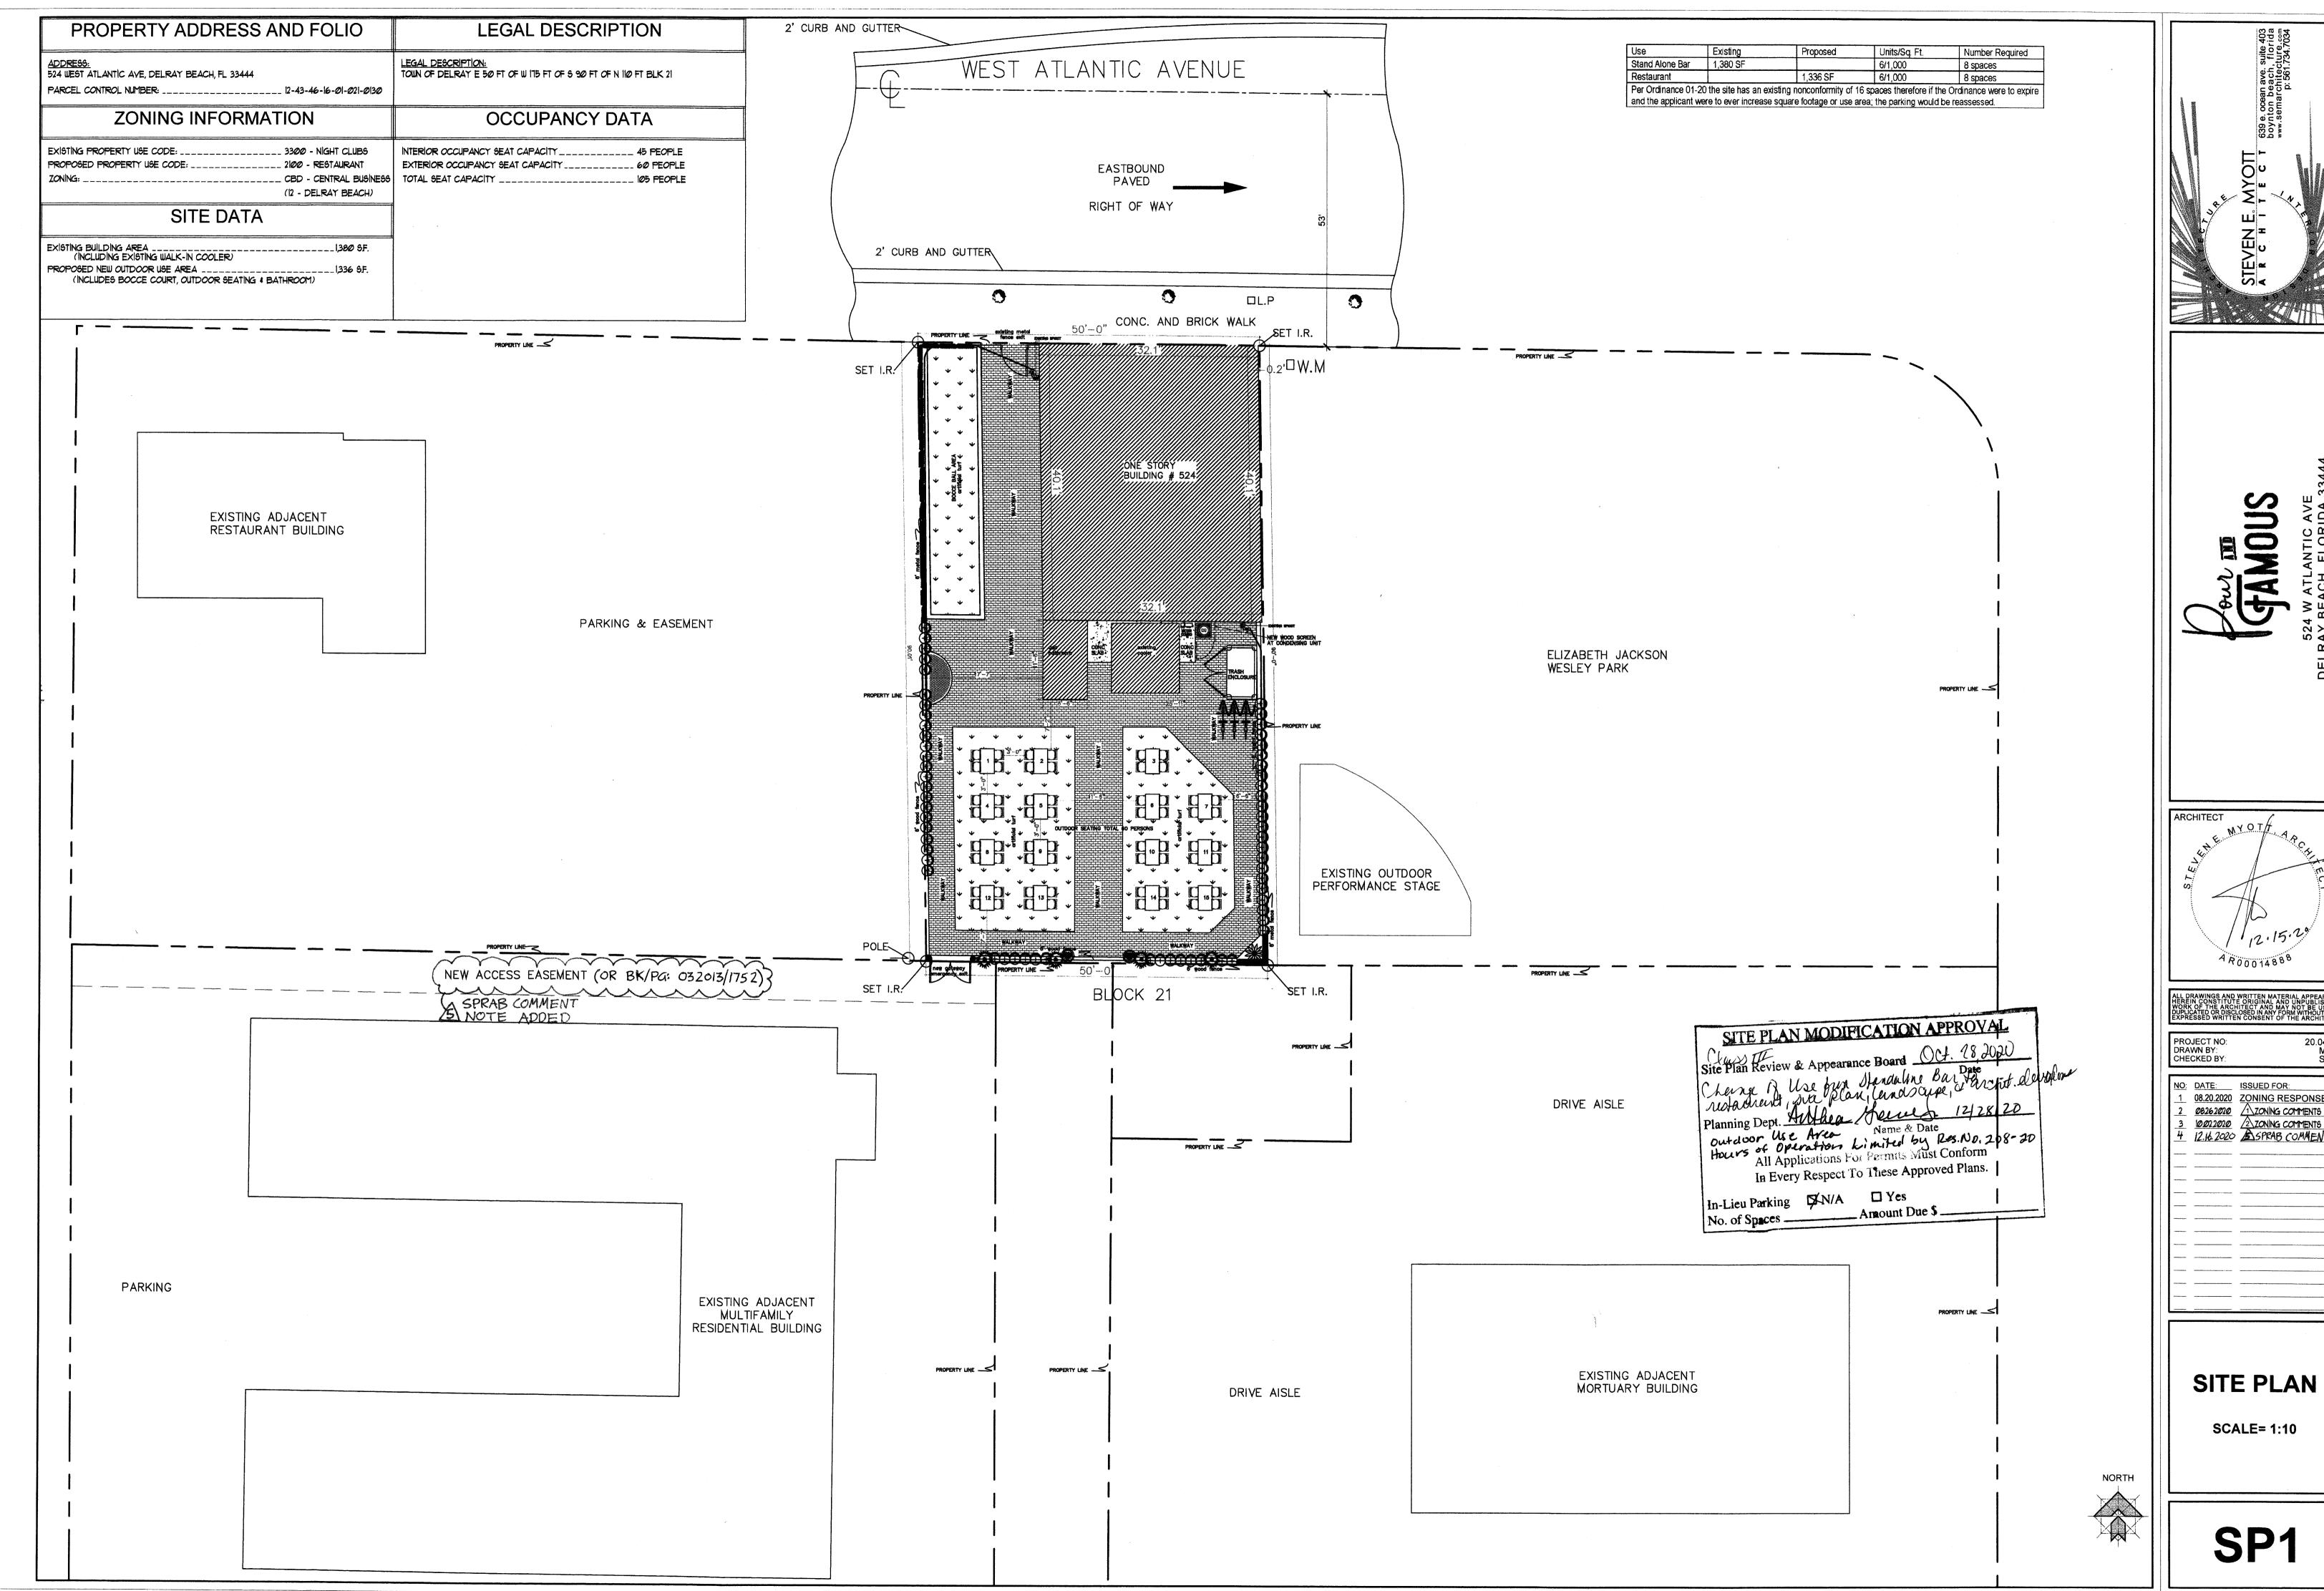

2 08.20.2020 ZONING RESPONSES
2 08262020 1 ZONING COMMENTS
3 10.0022020 2 ZONING COMMENTS
4 12.16.2020 ESPRAB COMMENT

2. TRAVEL DISTANCES

NUMBER OF EXITS PER FBC TABLE 10062.1:

MORE THAN 29 PERSONS - TWO EXITS REQUIRED

PER FBC 1010.12.1 DOOR MUST SWING WITH PATH OF EGRESS FOR OCCUPANT LOADS GREATER THAN 49

COMMON PATH OF TRAVEL PER NFPA 101 CH. 1325

AREA WITH 49 OR FEWER OCCUPANTS = 75"

AREA WITH 50 OR GREATER OCCUPANTS = 20'

MAXIMUM TRAVEL DISTANCE PER FBC TABLE 10172 & NFPA 101 CH. 1326

NON-SPRINKLERED = 200'

DEAD END CORRIDORS (WHERE MULTIPLE EXITS REQUIRED) PER NFPA (O) CH. 1325,13

NON-SPRINKLERED = 20'

3. EXIT WIDTH

FURNITURE LAYOUT TO BE DETERMINED BY TENANT. 3'-8" CLEAR MINIMUM WIDTHS TO ALL EXITS SHALL BE MAINTAINED.


EGRESS DOORS SHALL BE A MINIMIM OP 32" IN WIDTH


#### EGRESS PLAN LEGEND

DENOTES COMPLETE TRAVEL DISTANCE TO EXIT DENOTES COMMON PATH OF TRAVEL DENOTES STARTING POINT FOR PATH OF TRAVEL

EXIT 1

LOCATION OF FIRE EXIT

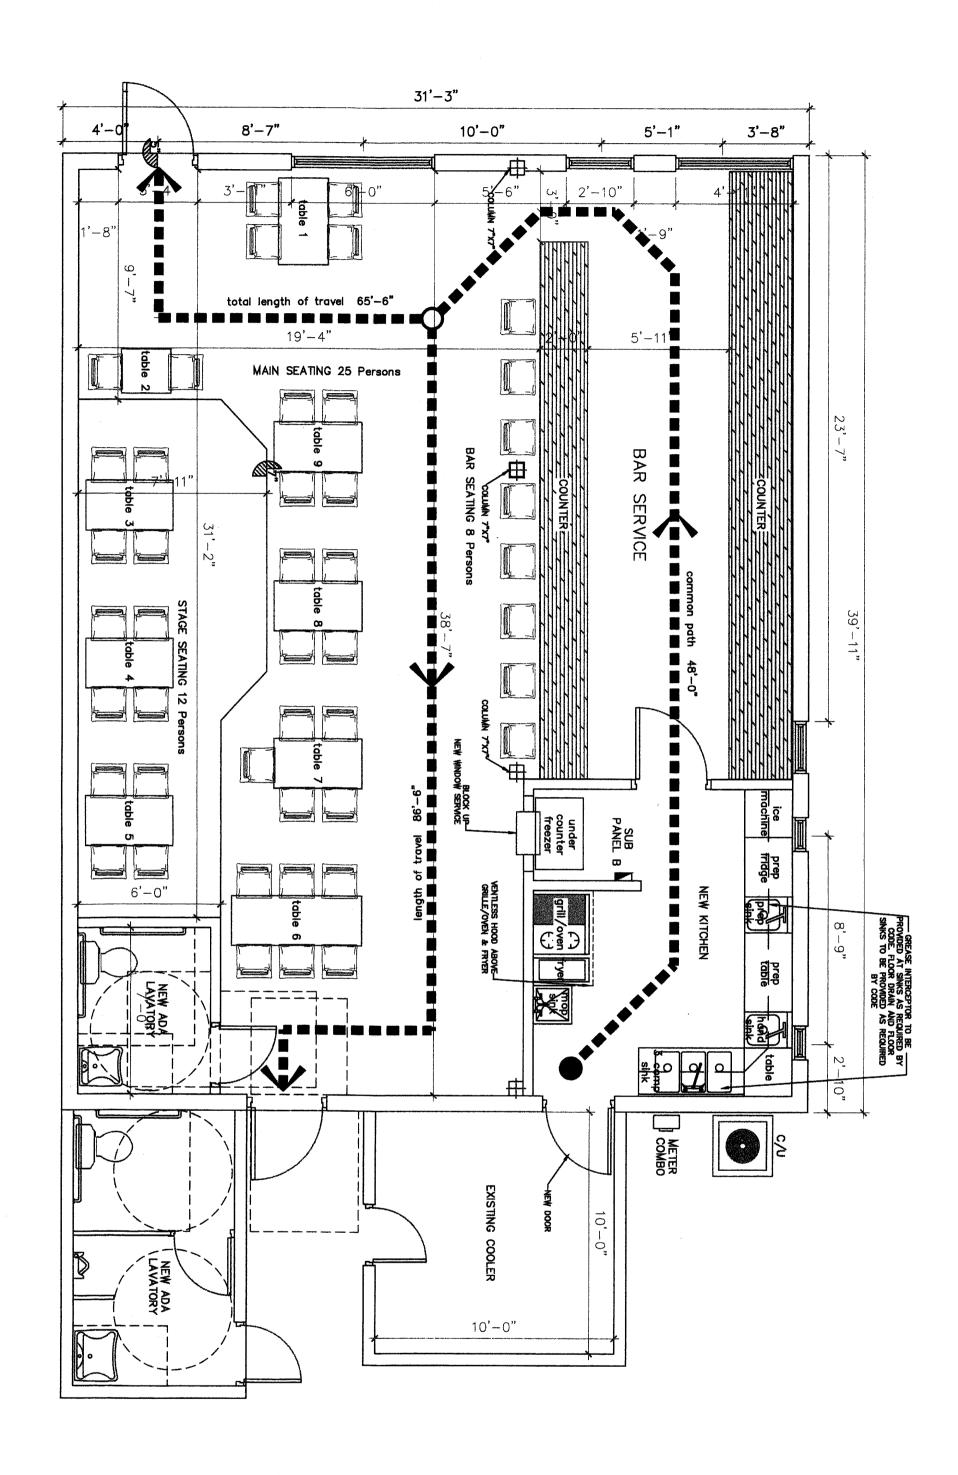

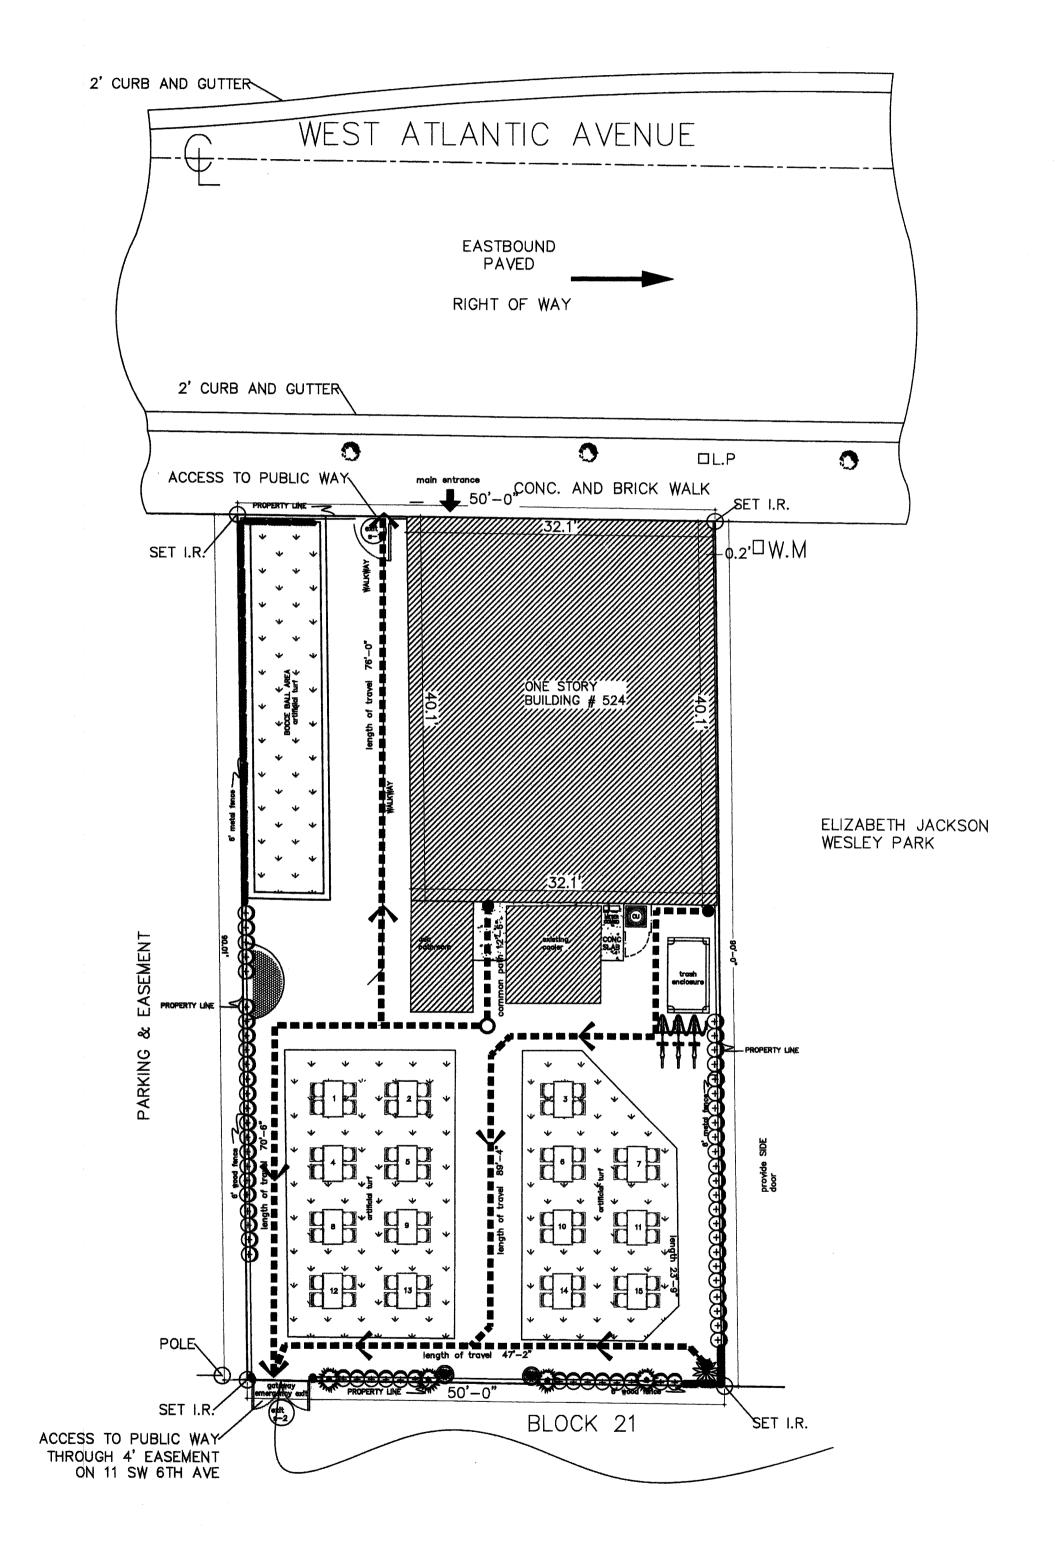


#### ACCESSIBLE ROUTE/EGRESS DOOR REQUIREMENTS:

- HANDLES, PULLS, LATCHES, LOCKS, AND OTHER OPERABLE PARTS ON DOORS AND GATES SHALL BE 34 INCHES MINIMUM AND 48 INCHES MAXIMUM ABOVE THE FINISH FLOOR OR GROUND
- HARDWARE SHALL BE OPERABLE WITH ONE HAND AND SHALL NOT REQUIRE TIGHT GRASPING, PINCHING, OR TWISTING OF THE WRIST. THE FORCE REQUIRED TO ACTIVATE OPERABLE PARTS SHALL BE 5 POUNDS MAXIMUM.
- THE FORCE FOR PUSHING OR PULLING OPEN A DOOR OR GATE SHALL BE AS FOLLOWS:


  1. INTERIOR HINGED DOORS AND GATES: 5 POUNDS (22.2 N) MAXIMUM.

2. SLIDING OR FOLDING DOORS: 5 POUNDS (222 N) MAXIMUM. 3. EXTERIOR HINGED DOORS SHALL BE DESIGNED SO THAT SUCH DOORS CAN BE PUSHED OR PULLED OPEN WITH A FORCE NOT EXCEEDING 85 POUNDS (37.8 N).

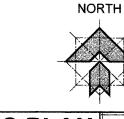

SCALE:


EXTERIOR EGRESS PLAN 2

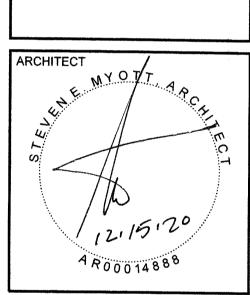


PROJECT NO: DRAWN BY: CHECKED BY:

NO: DATE: ISSUED FOR: 08.20.2020 ZONING RESPONSES 10232020 4 COORDINATION

EGRESS PLANS

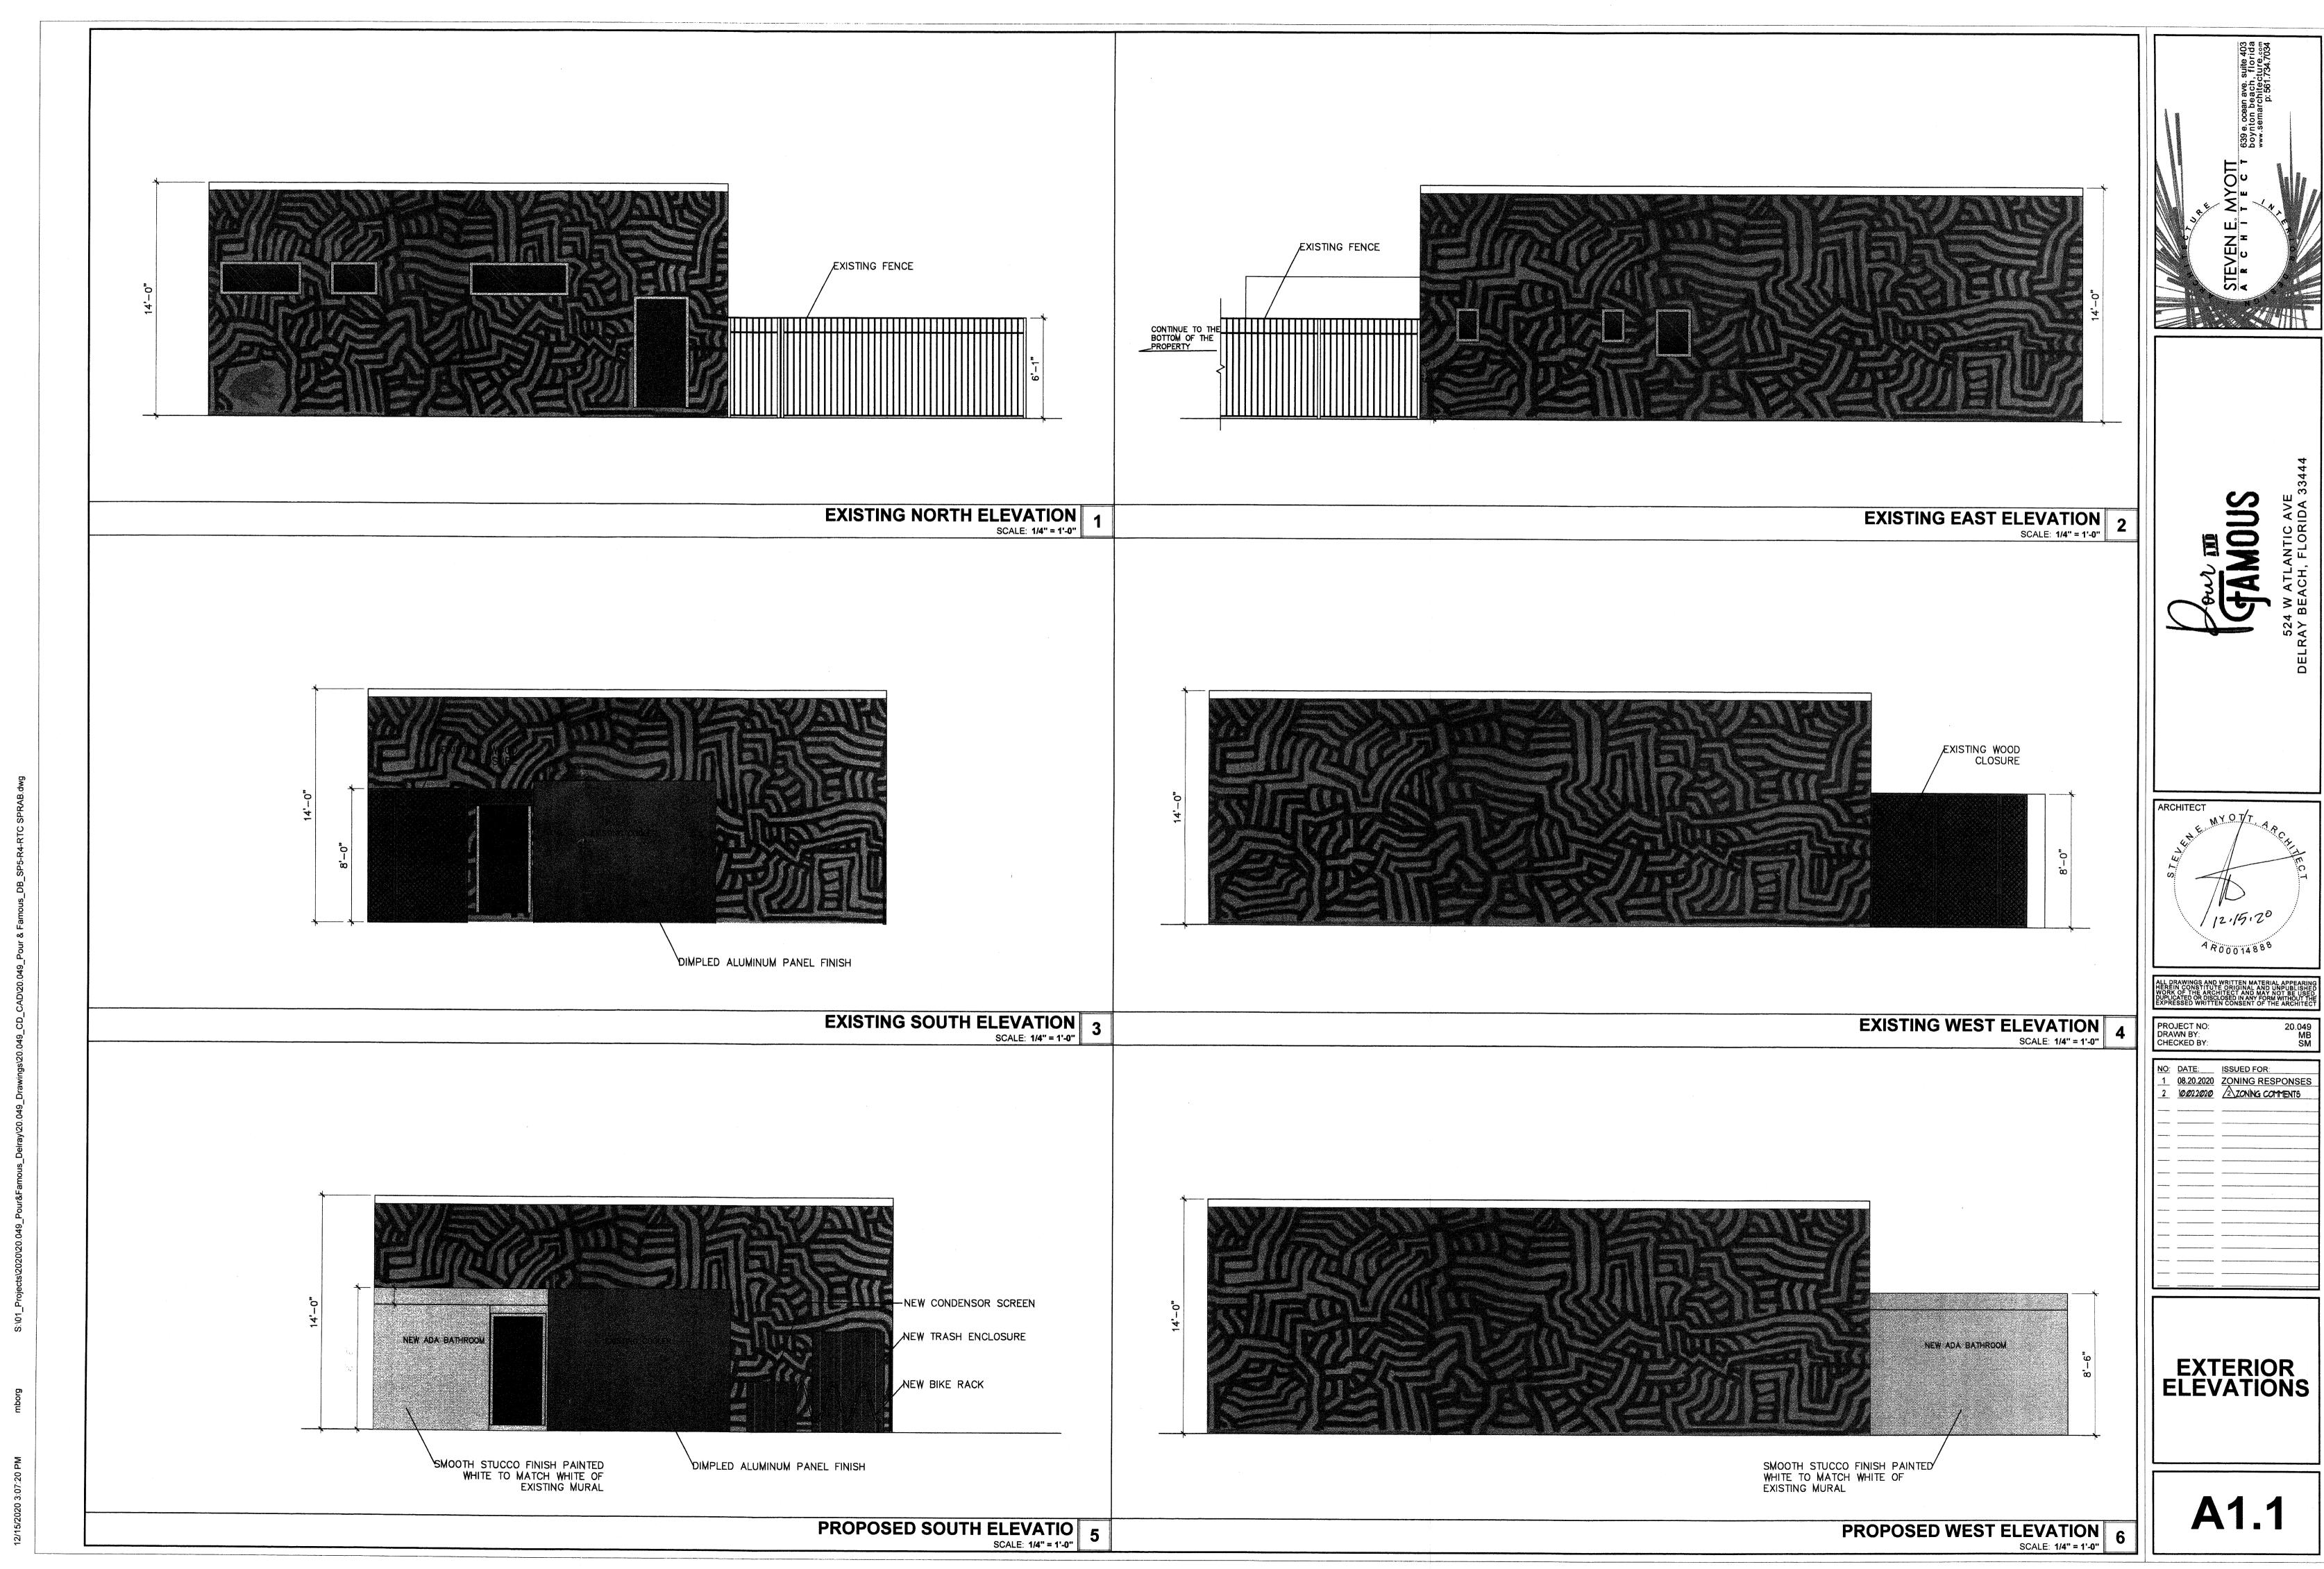

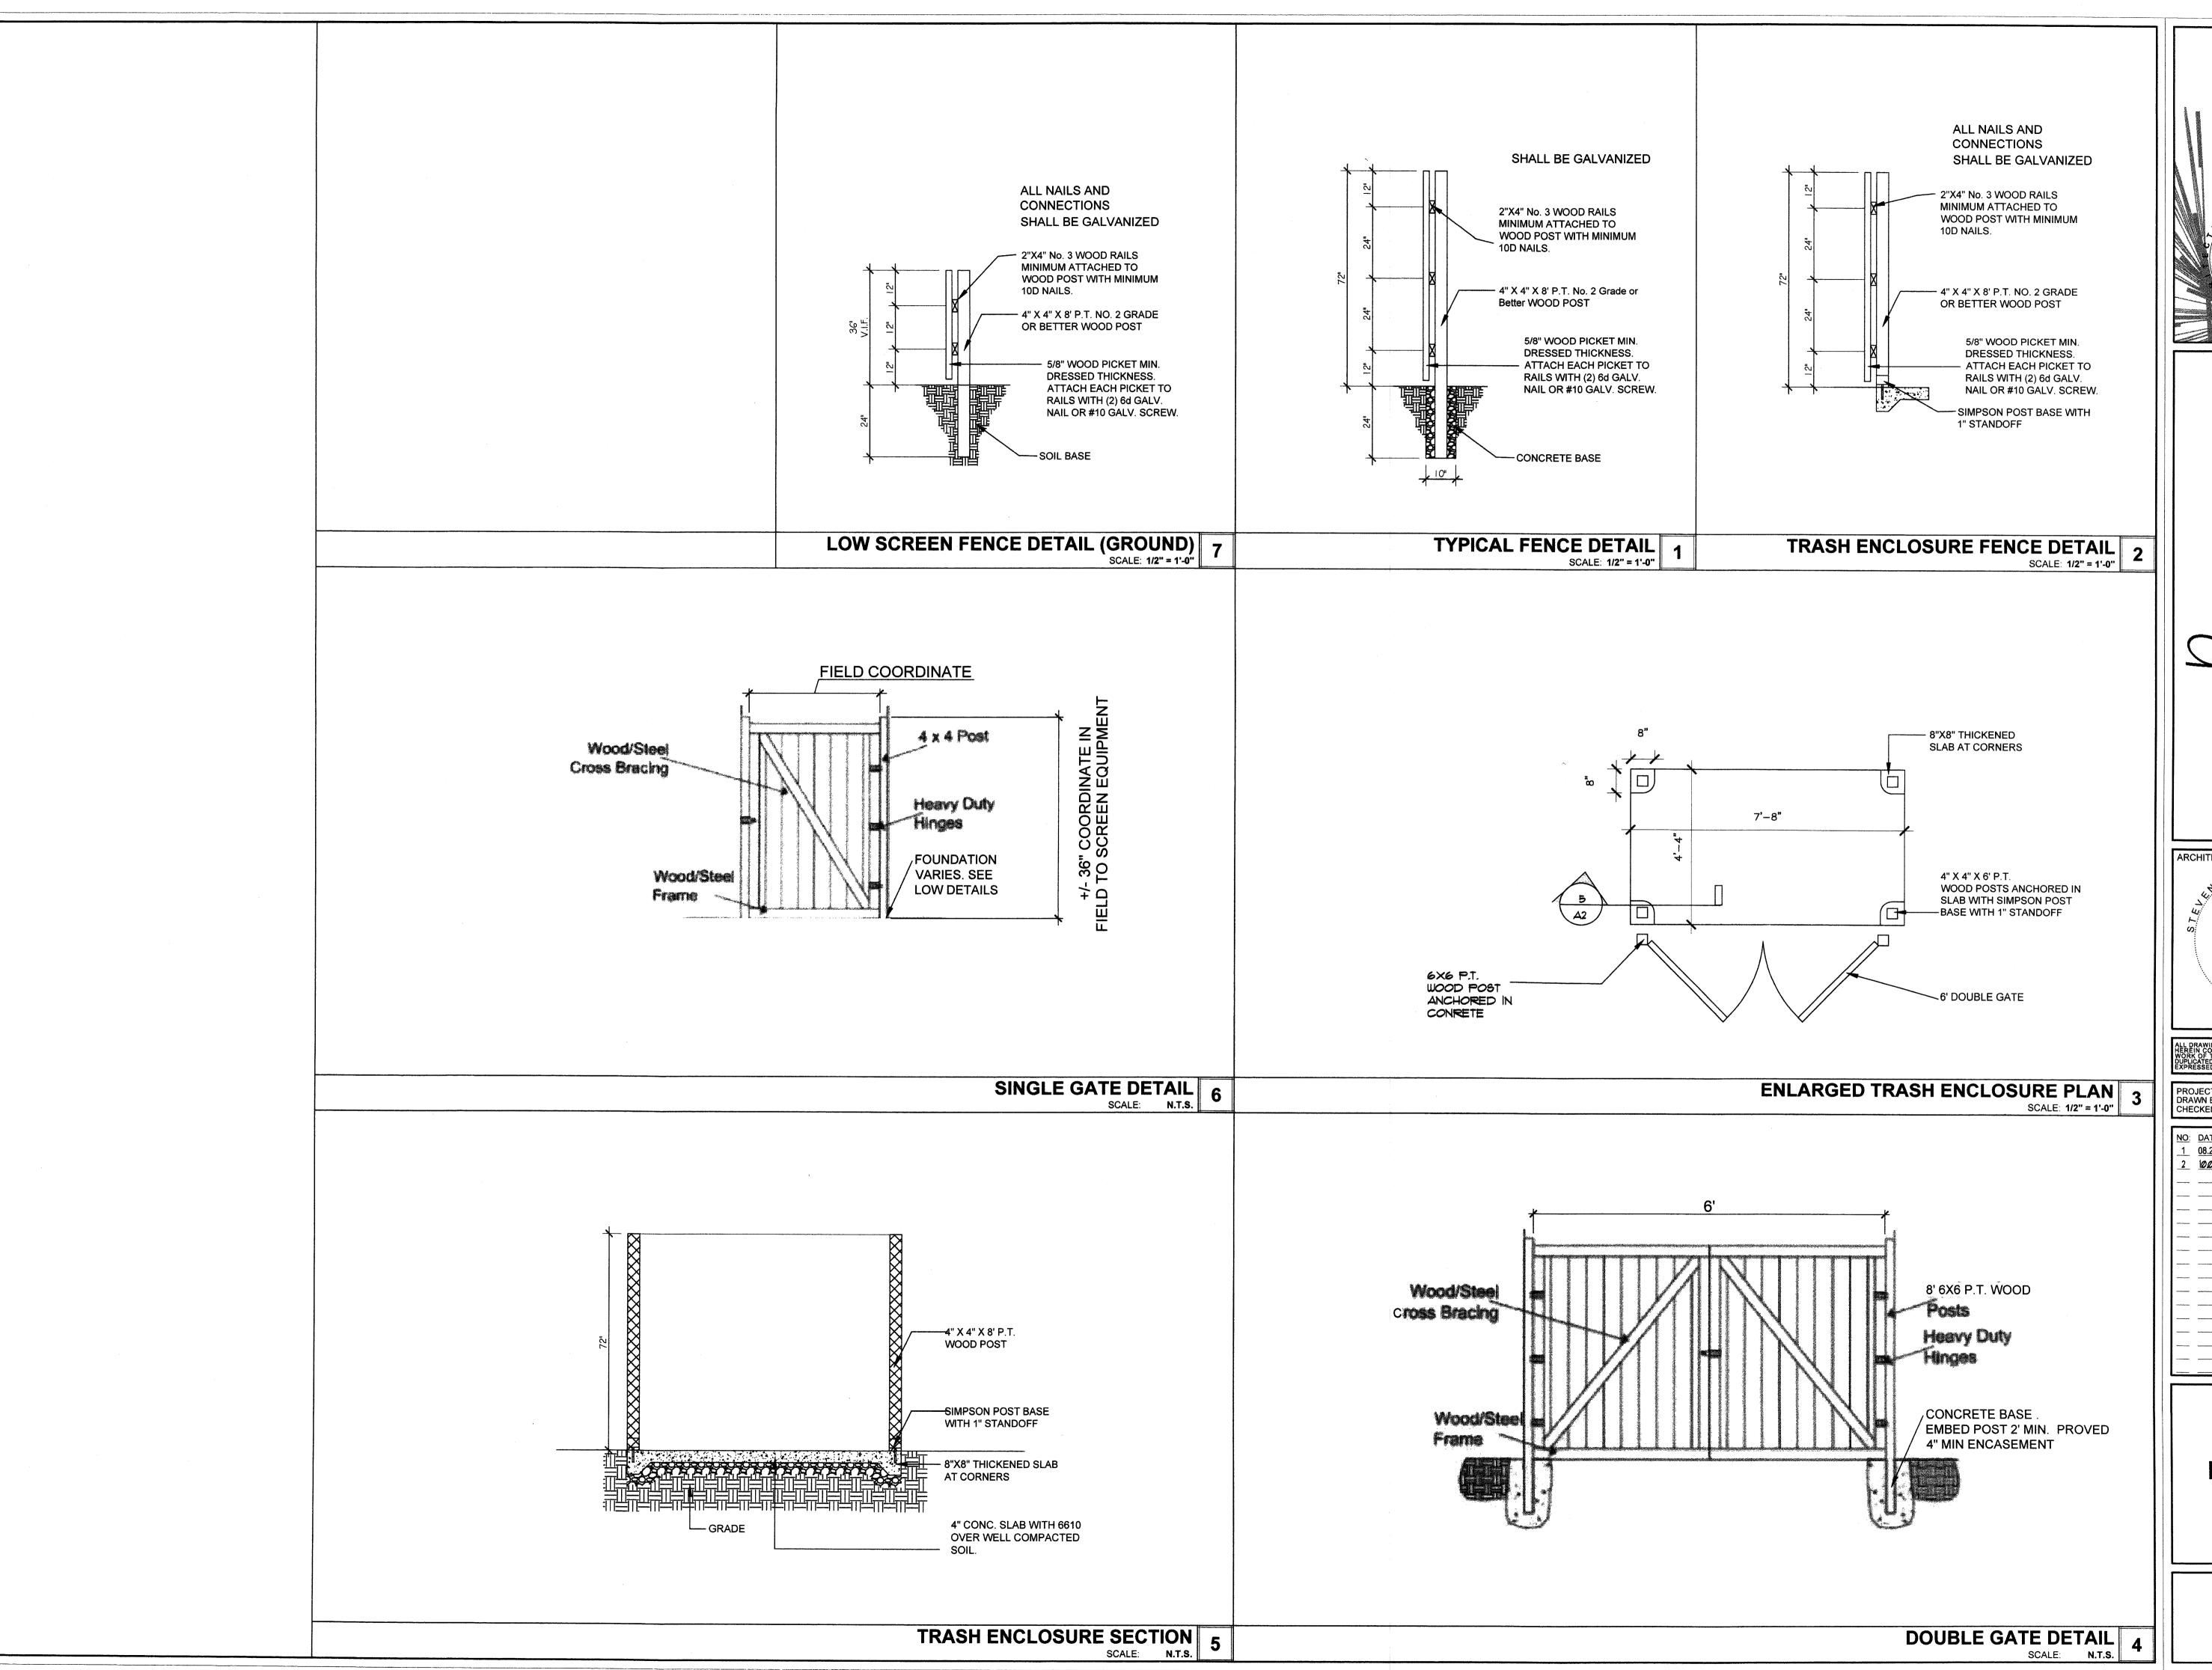

FAMOUS

ARCHITECT MYOIT AR00014888

PROJECT NO: DRAWN BY: CHECKED BY:

 NO:
 DATE:
 ISSUED FOR:


 1
 08.20.2020
 ZONING RESPONSES


 2
 10.002.2020
 2 ZONING COMMENTS


**DETAILS** 







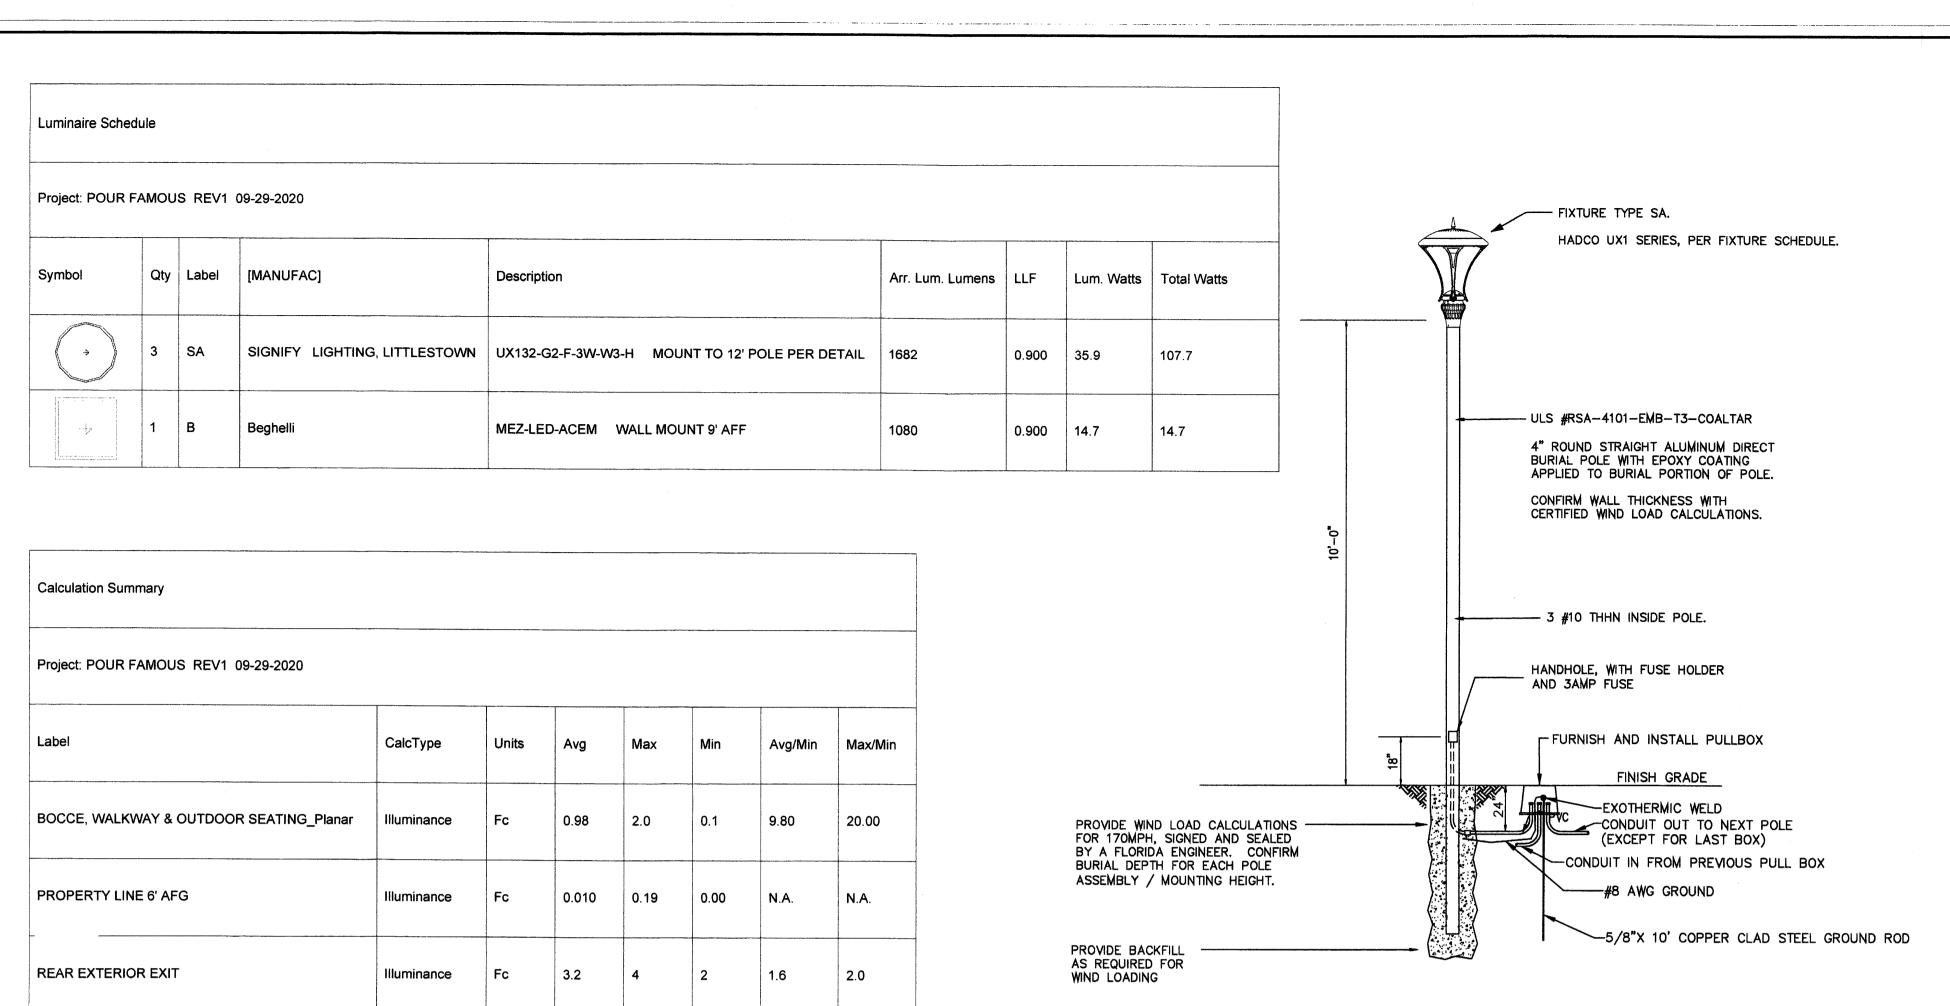

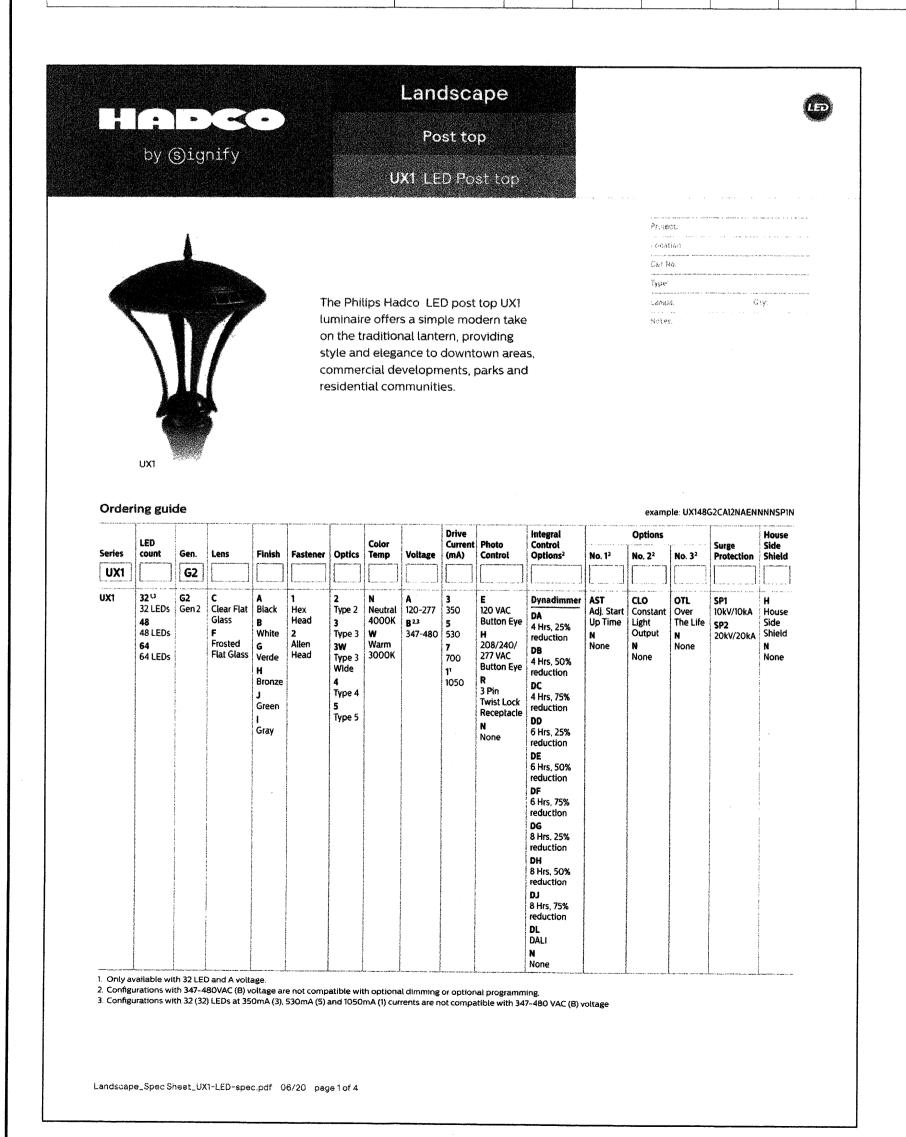

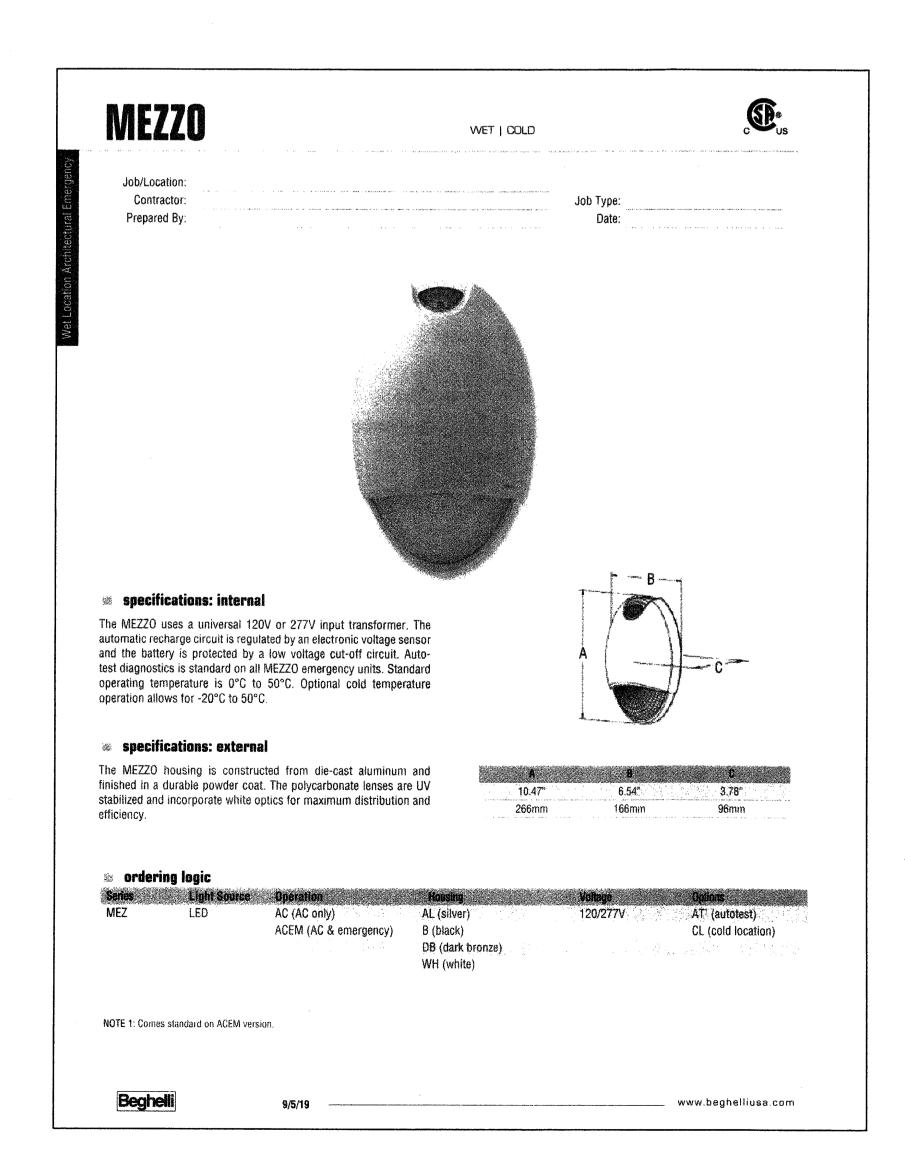

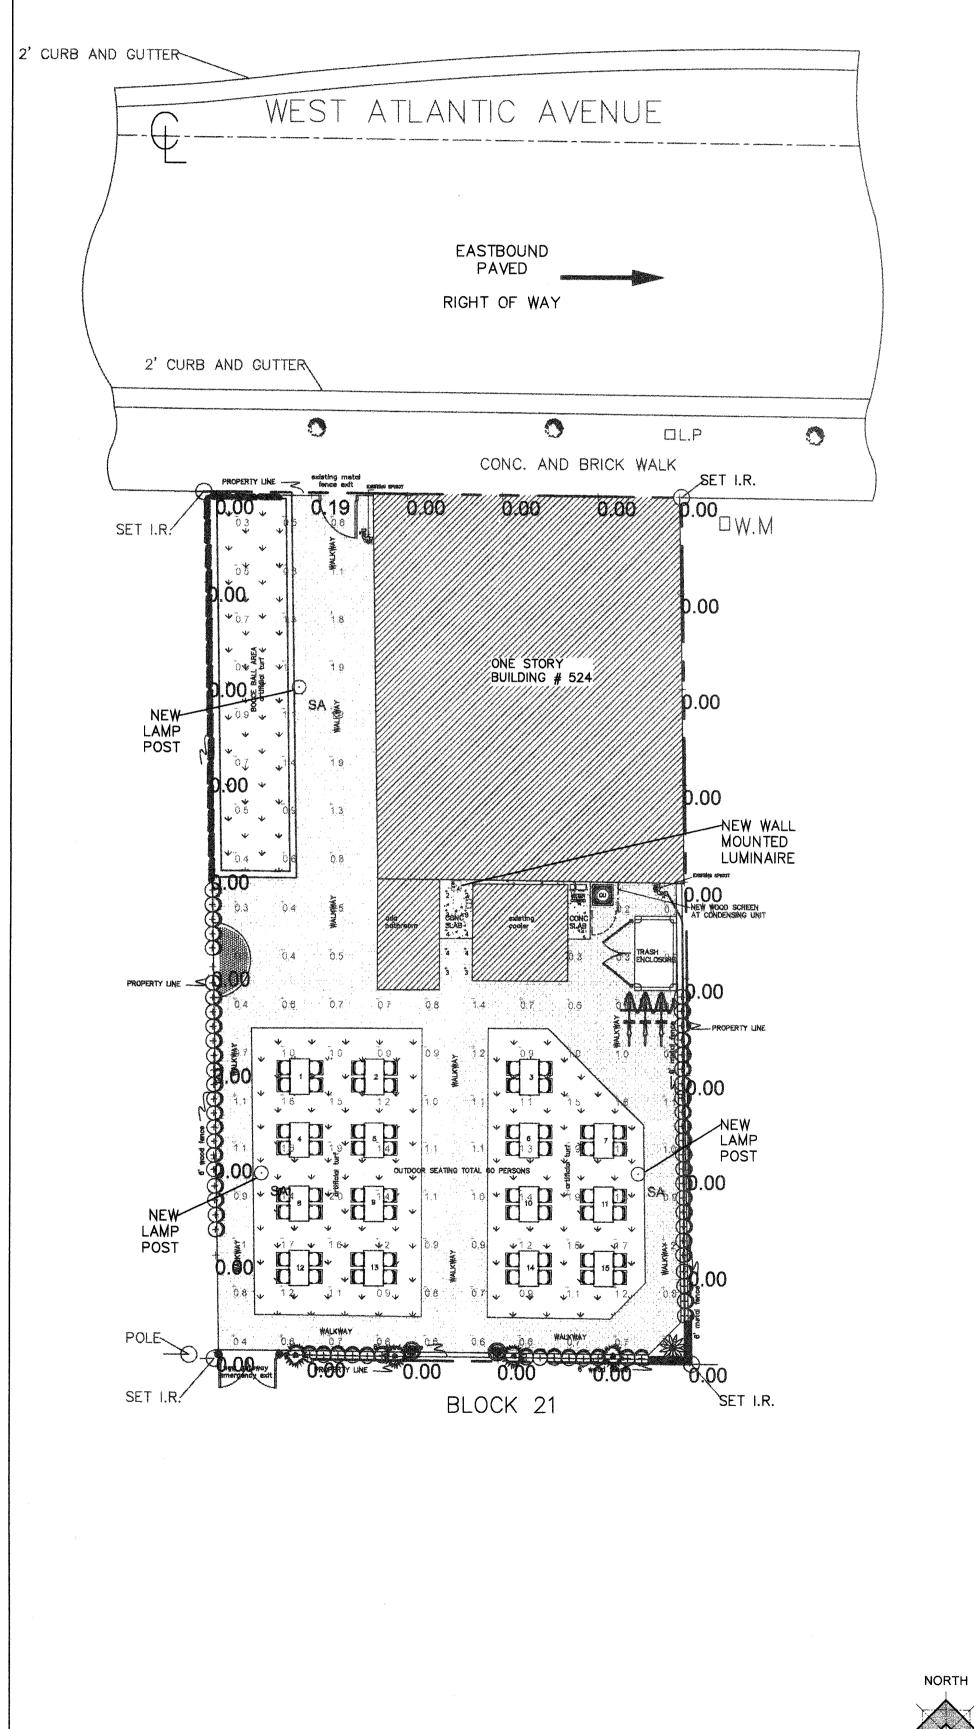

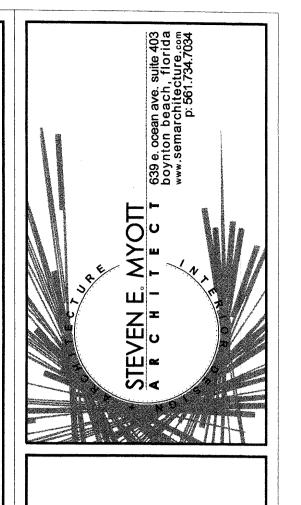

A A

A R00014888

PROJECT NO: DRAWN BY: CHECKED BY:

NO: DATE: ISSUED FOR: 08.20.2020 ZONING RESPONSES 10.002.2020 2 ZONING COMMENTS 3 10.12.2020 3 ZONING COMMENTS

EXTERIOR PHOTOMETRIC PLAN

LIGHTING

## POUR AND FAMOUS

524 W Atlantic Avenue, Delray Beach, FL 33444

Zuhair

Digitally signed by Zuhair

Jalloul, P.E.

Date:


E. 2020.10.06 09:07:28 -04'00'

> NOT TO SCALE

SUMMARY OF WORK INCLUDED IN THE CIVIL PLANS

1. POLLUTION PREVENTION

2. CONSTRUCT OUTSIDE SEATING AREA AND BOCCE
BALL AREA WITH ARTIFICIAL TURF

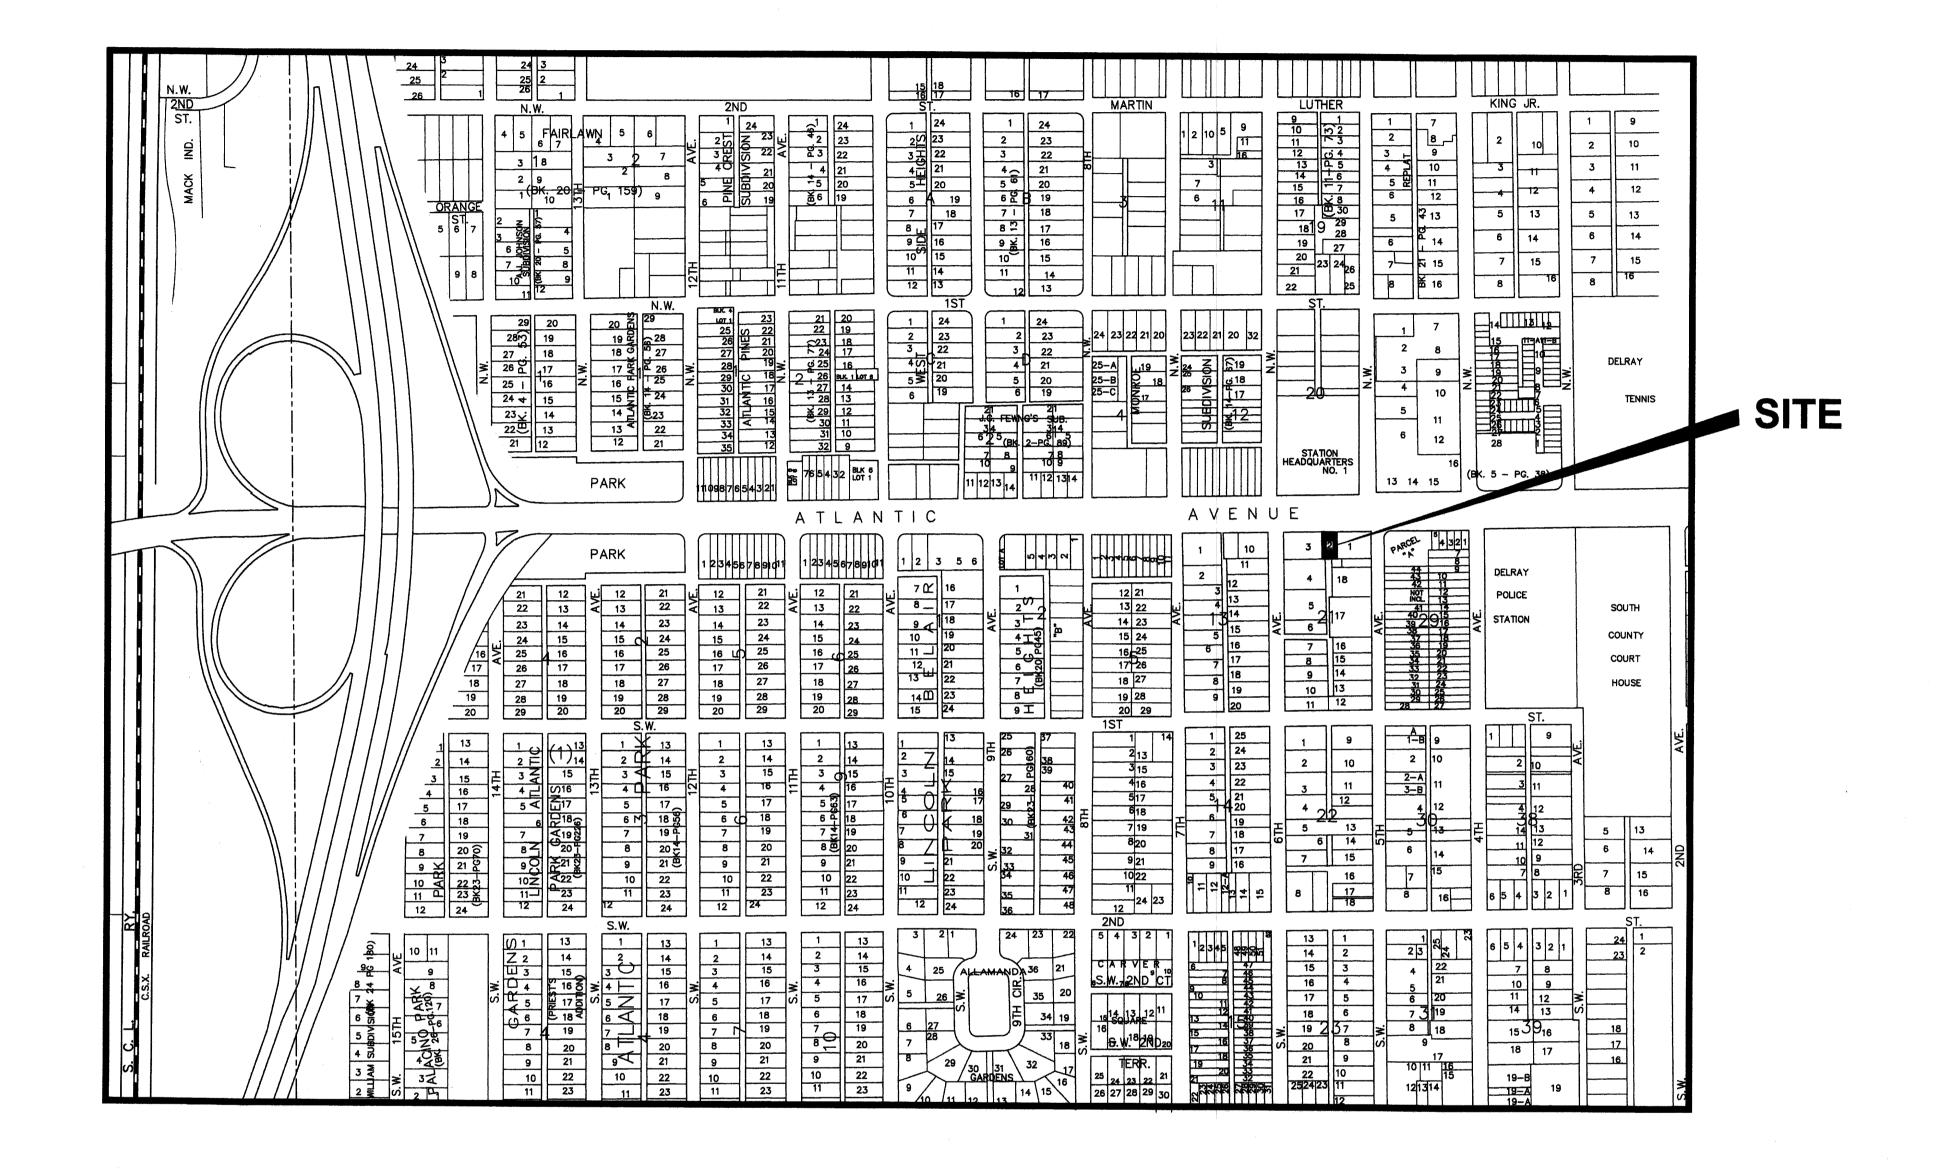

### PROJECT LOCATION MAP

SUNSHINE ONE CALL LOCATES (811) SHALL BE CALLED TO LOCATE ALL EXISTING SEWER, WATER, AND OTHER UTILITIES SHALL BE LOCATED PRIOR TO CONSTRUCTION STARTING

Always call 811 two full business days before you dig



PROPERTY ADDRESS AND FOLIO

524 WEST ATLANTIC AVE, DELRAY BEACH, FL 33444
Parcel Control Number: 12-43-46-16-01-021-0130

LEGAL DESCRIPTION

TOWN OF DELRAY E 50 FT OF W 175 FT
OF S 90 FT OF N 110 FT BLK 21

#### GENERAL NOTES

1. LOCATIONS, ELEVATIONS, AND DIMENSIONS OF EXISTING UTILITIES, STRUCTURES AND OTHER FEATURES ARE SHOWN ACCORDING TO THE BEST INFORMATION AVAILABLE AT THE TIME OF PREPARATION OF THESE DRAWINGS BUT ARE NOT PURPORTED TO BE ABSOLUTELY CORRECT. THE CONTRACTOR SHALL VERIFY LOCATIONS, ELEVATIONS AND DIMENSIONS OF ALL EXISTING UTILITIES, STRUCTURES AND OTHER FEATURES AFFECTING HIS WORK PRIOR TO CONSTRUCTION.

2. THE CONTRACTOR SHALL REPLACE PAVING, STABILIZED EARTH, DRIVEWAYS, ETC. WITH THE SAME TYPE OF MATERIAL THAT WAS REMOVED OR DAMAGED DURING THE CONSTRUCTION.

3. THE CONTRACTOR SHALL NOTIFY THE ENGINEER IMMEDIATELY WHEN A CONFLICT BETWEEN THE DRAWINGS AND ACTUAL CONDITIONS ARE DISCOVERED DURING THE COURSE OF CONSTRUCTION.

4. IT SHALL BE THE CONTRACTOR'S RESPONSIBILITY PRIOR TO THE CONSTRUCTION OF THE WORK TO PERFORM SUCH TESTS, STUDIES AND SURVEYS AS HE DEEMS NECESSARY TO SATISFY HIMSELF AS TO THE ACTUAL CONDITIONS EXISTING AT THE SITE.

5. THE CONTRACTOR SHALL PROVIDE AT LEAST 48 HOURS NOTICE TO THE VARIOUS UTILITY COMPANIES TO PERMIT THE LOCATIONS OF EXISTING UNDERGROUND UTILITIES IN ADVANCE FOR CONSTRUCTION BY CALLING SUNSHINE STATE ONE CALL AT 811

6. ALL CONCRETE SHALL BE 3,000 PSI UNLESS OTHERWISE INDICATED AND SHALL BE IN CONFORMANCE WITH THE LATEST A.C.I.

7. DURING ALL UNDERGROUND CONSTRUCTION, THE CONTRACTOR SHALL BE RESPONSIBLE FOR PROVIDING THE APPROPRIATE CLEARANCES FROM ANY PROPOSED OR EXISTING UTILITIES OR STRUCTURES, AS REQUIRED BY THE PLANS, SPECIFICATIONS, UTILITY AUTHORITY, AND ANY GOVERNING AGENCY. THE CONTRACTOR MUST NOTIFY THE ENGINEER IMMEDIATELY IF THE APPROPRIATE OF THE APPROPRIATE OF THE PROPERTY O

#### CONTENTS:

C-1 CIVIL PLANS LOCATION MAP
COVER SHEET AND NOTES
(LOCATION MAP)

C-2 GRADING PLAN AND DRAINAGE CALCULATIONS

C-3 POLLUTION PREVENTION PLAN AND DETAILS




Florida
Consulting
Engineers,
Inc.

Certificate of Authorization No. 5810

134 N.W. 16TH STREET, SUITE 1
BOCA RATON , FLORIDA 33432

PHONE: (561) 353-1152
E-MAIL:
ZJ@FLCENGINEERS.COM



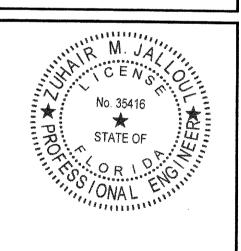

ALL DRAWINGS AND WRITTEN MATERIAL APPEARING HEREIN CONSTITUTE ORIGINAL AND UNPUBLISHED WORK OF THE ARCHITECT AND MAY NOT BE USED DUPLICATED OR DISCLOSED IN ANY FORM WITHOUT THE EXPRESSED WRITTEN CONSENT OF THE ARCHITECT


PROJECT NO: DRAWN BY: CHECKED BY:


NO: DATE: ISSUED FOR:
1 08.18.2020 ZONING RESPONSES

CIVIL PLANS LOCATION MAP COVER SHEET

C-1

OF 3

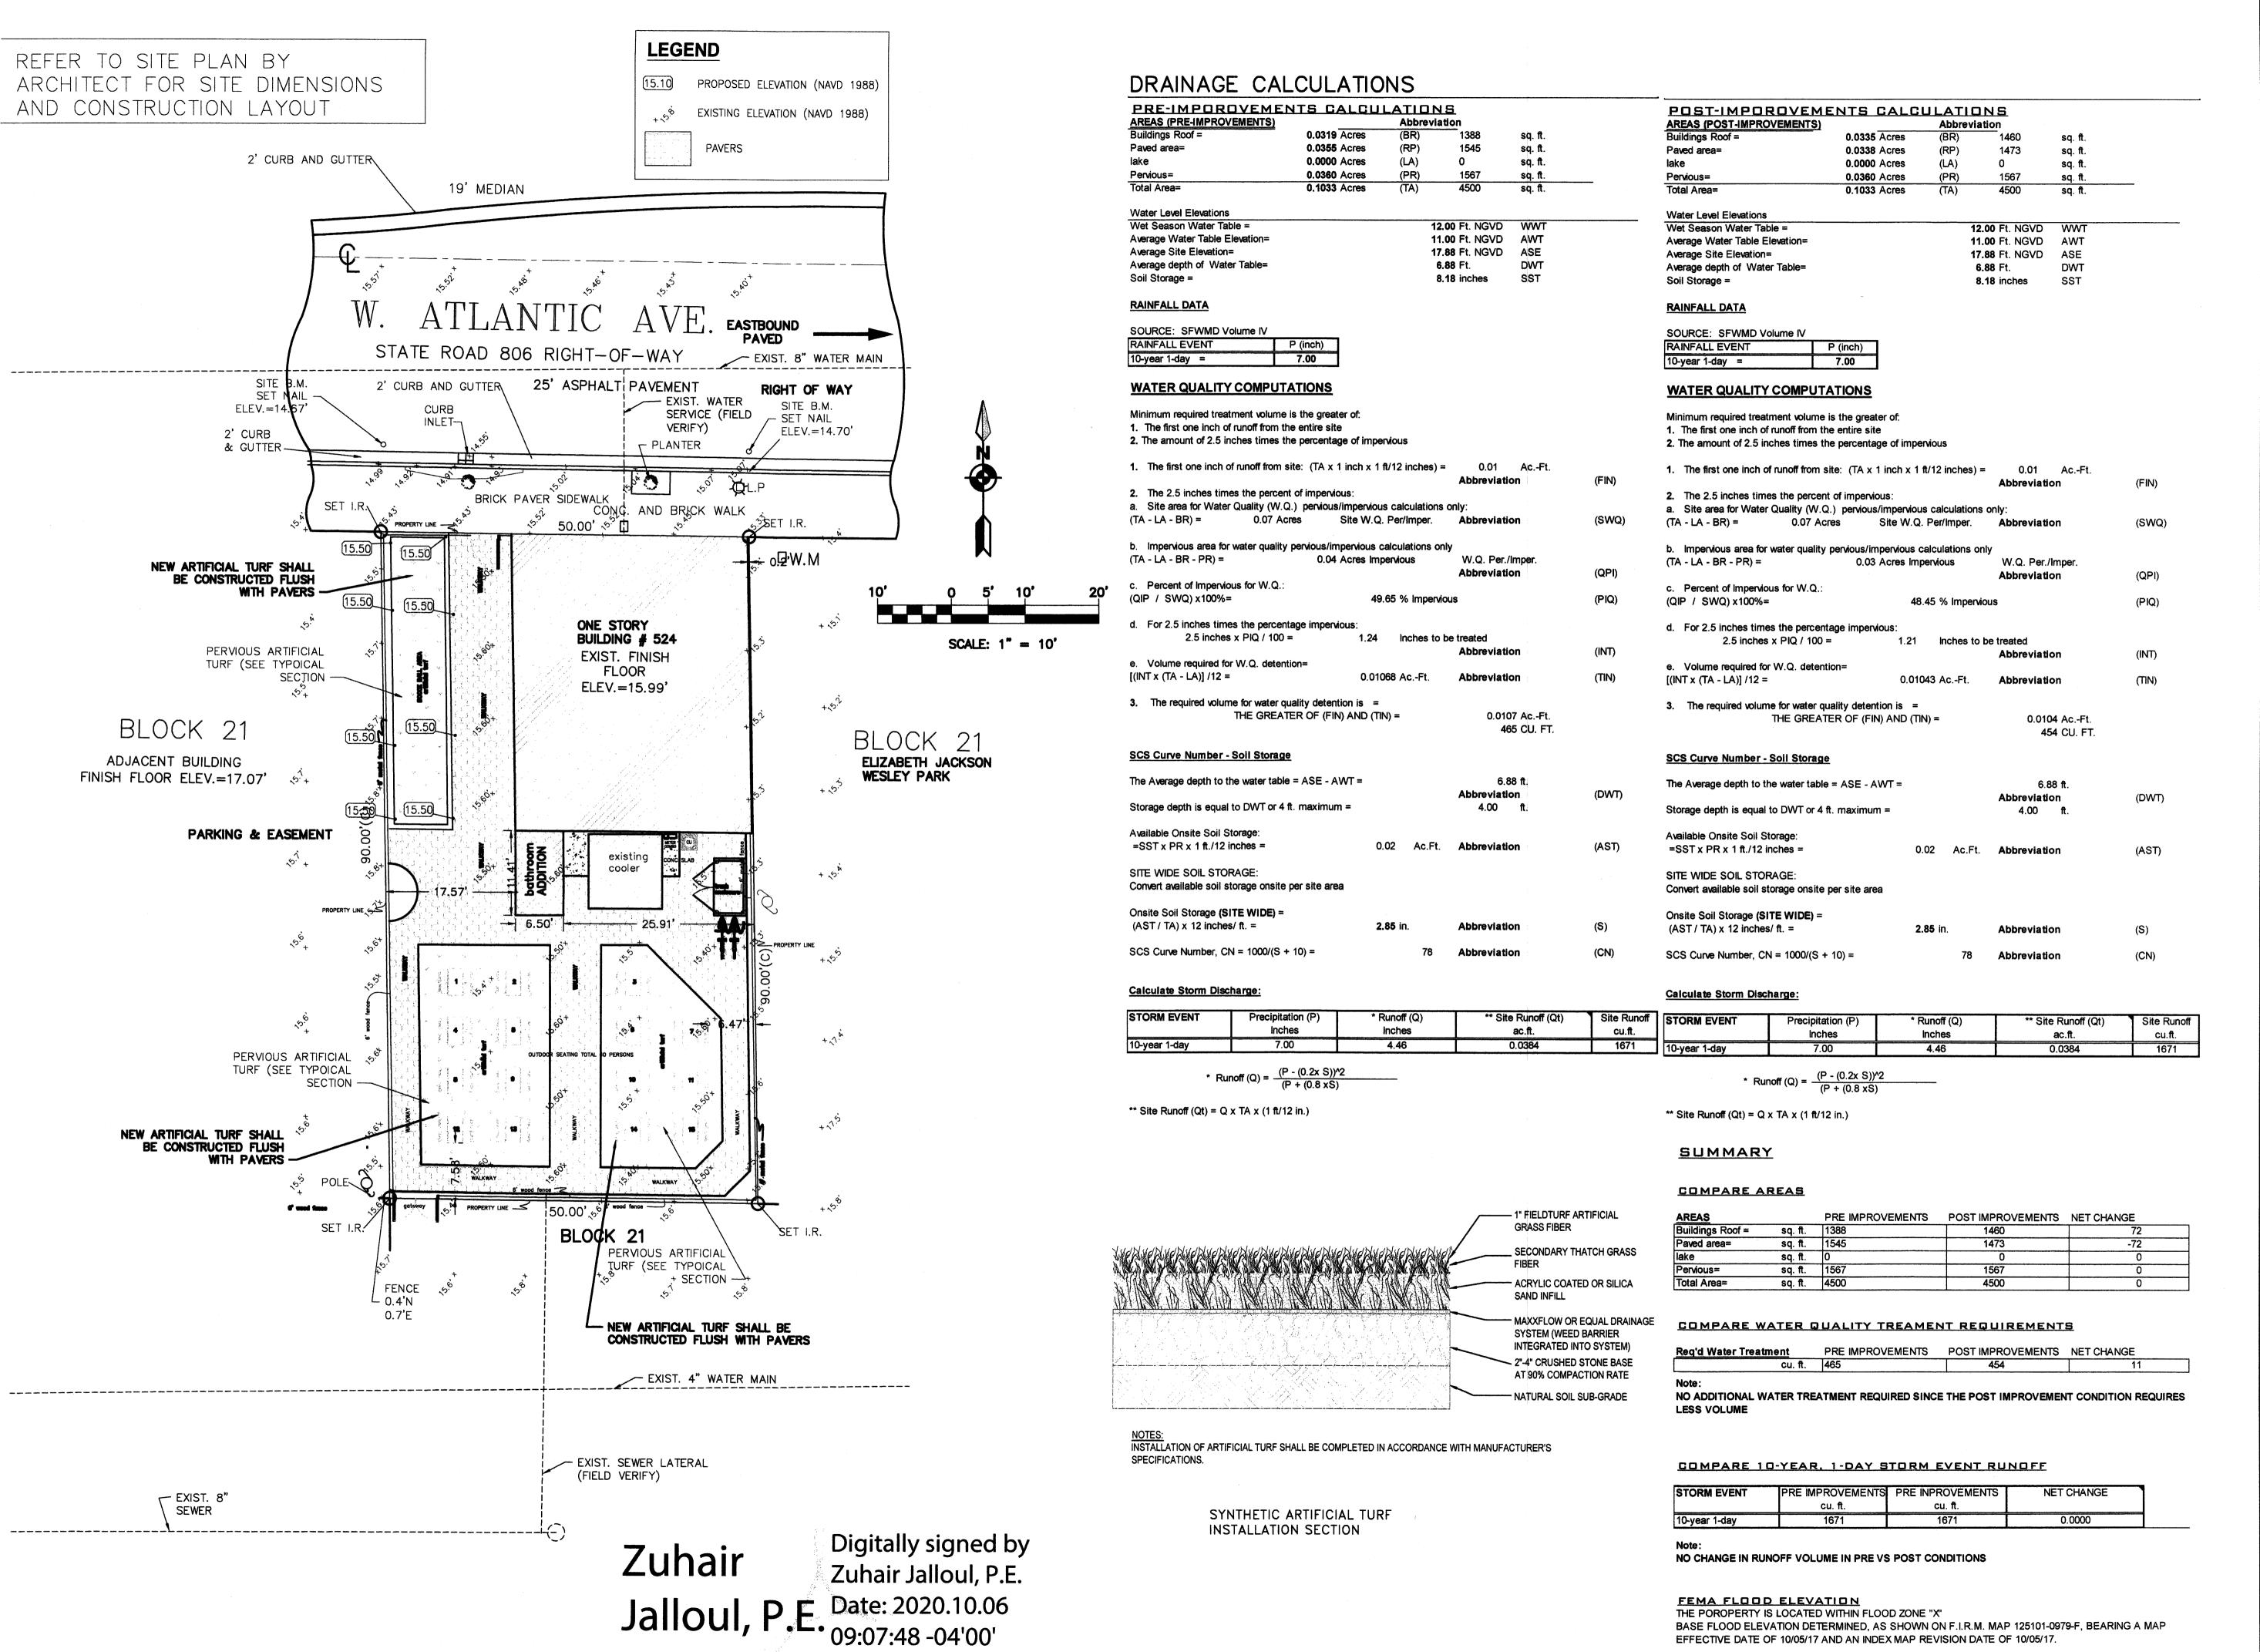

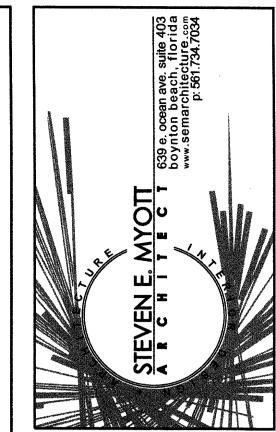


Florida Consulting Engineers,

Certificate of Authorization No. 5810 134 N.W. 16TH STREET, SUITE BOCA RATON, FLORIDA 33432 PHONE: (561) 353-1152

ZJ@FLCENGINEERS.COM

SOS SOS

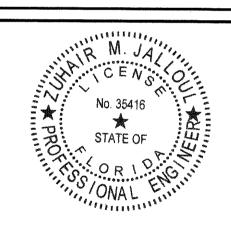

PROJECT NO: DRAWN BY: CHECKED BY:

NO: DATE: ISSUED FOR: 1 08.18.2020 ZONING RESPONSES

GRADING PLAN AND DRAINAGE CALULATIONS

C-2


FEMA FLOOD ELEVATION


THE POROPERTY IS LOCATED WITHIN FLOOD ZONE "X"

EFFECTIVE DATE OF 10/05/17 AND AN INDEX MAP REVISION DATE OF 10/05/17.

BASE FLOOD ELEVATION DETERMINED, AS SHOWN ON F.I.R.M. MAP 125101-0979-F, BEARING A MAP

OF 3

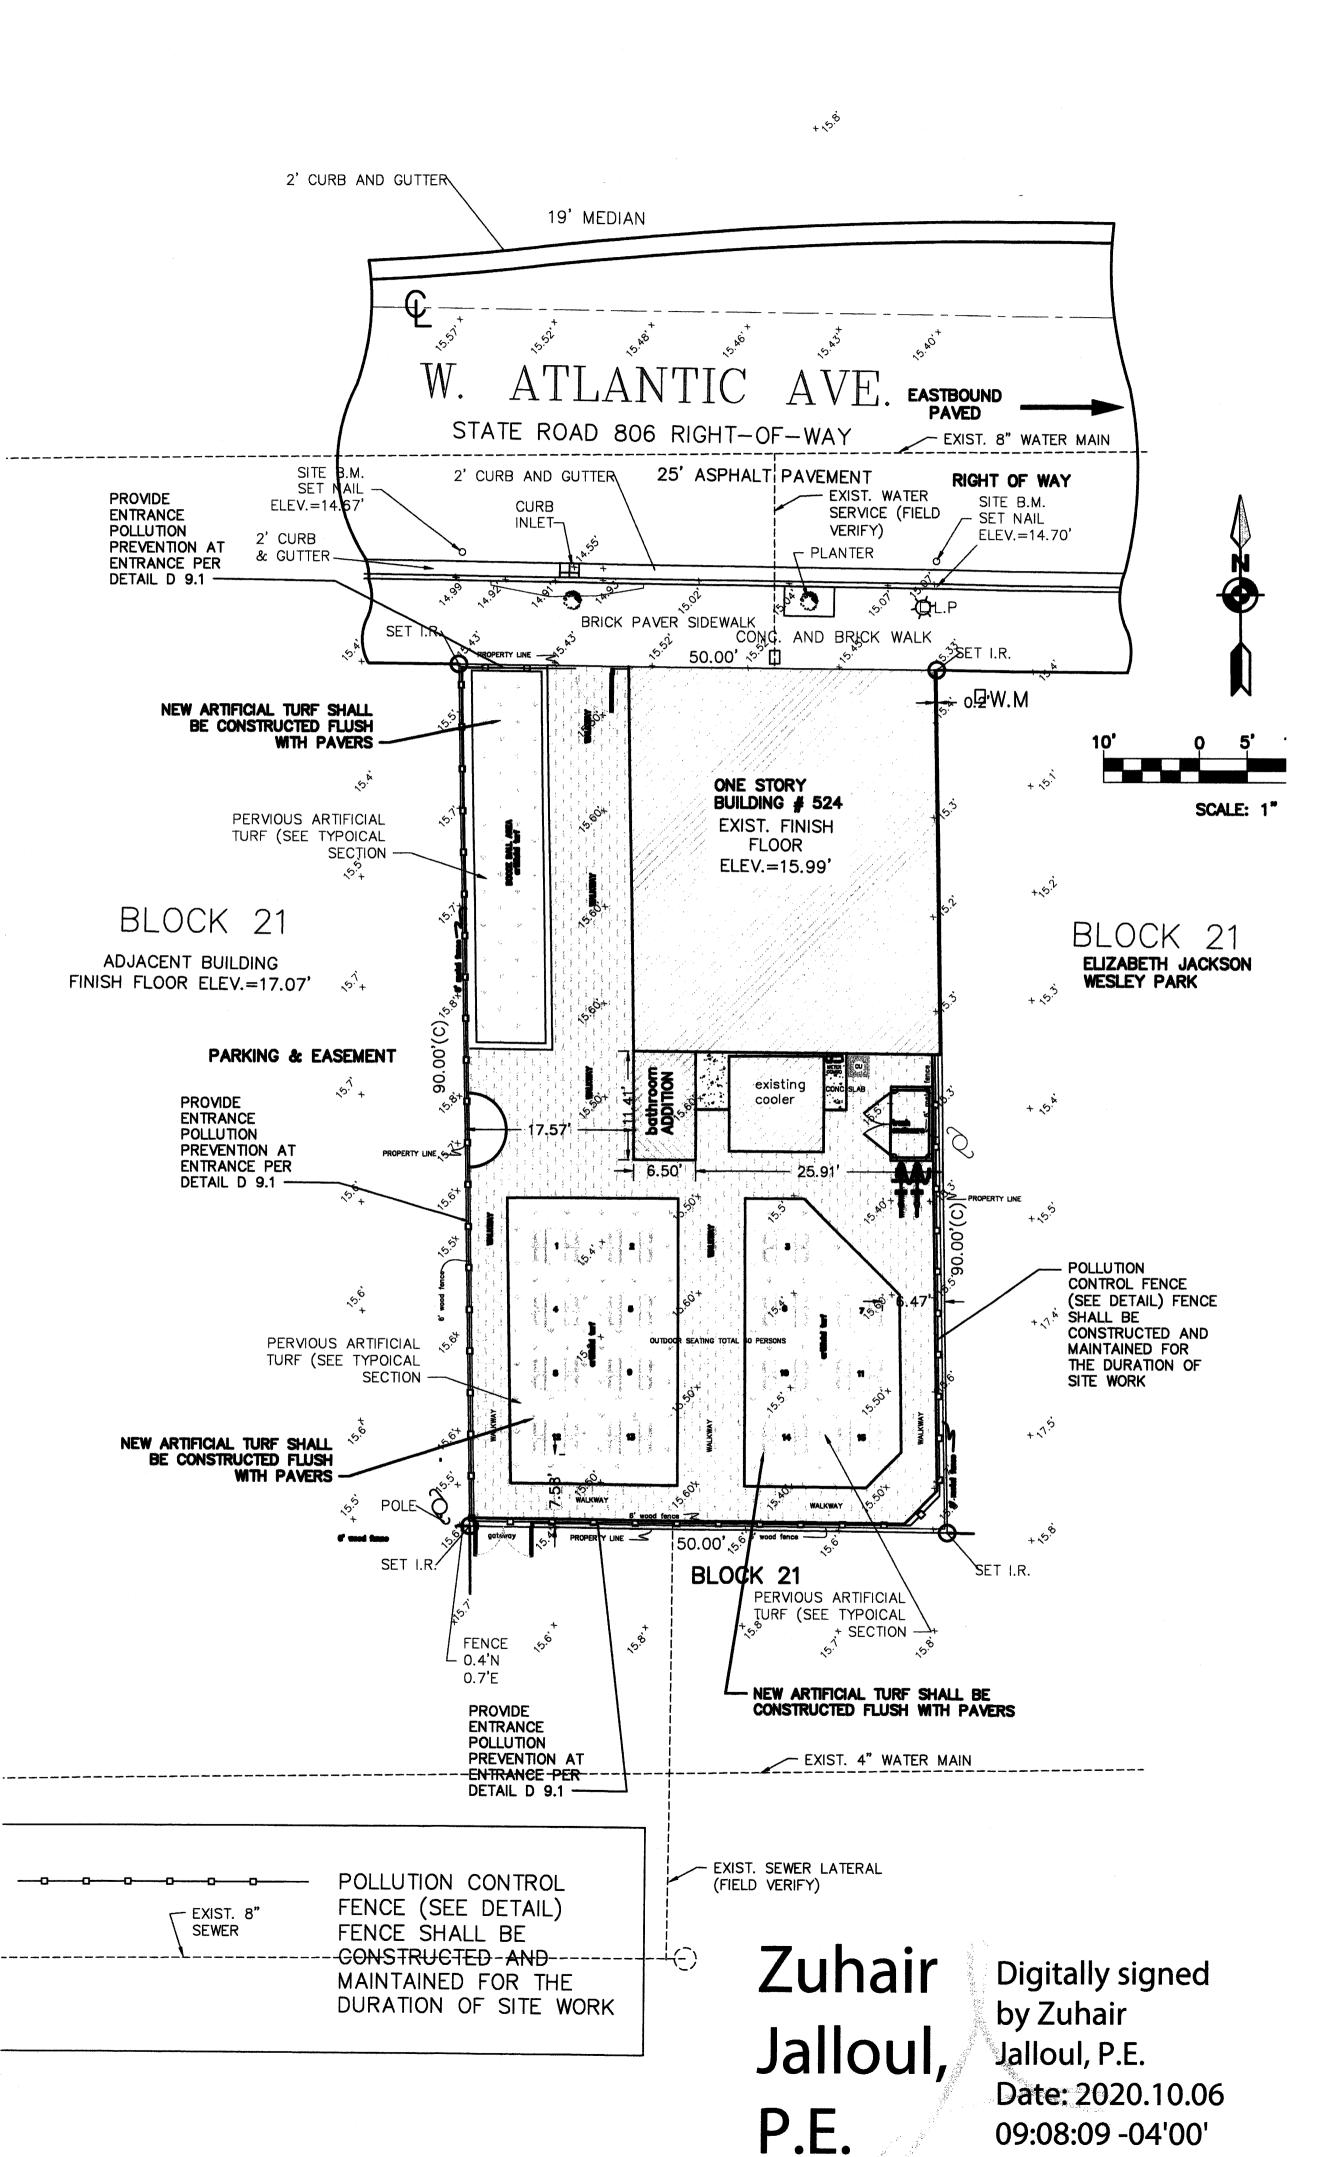

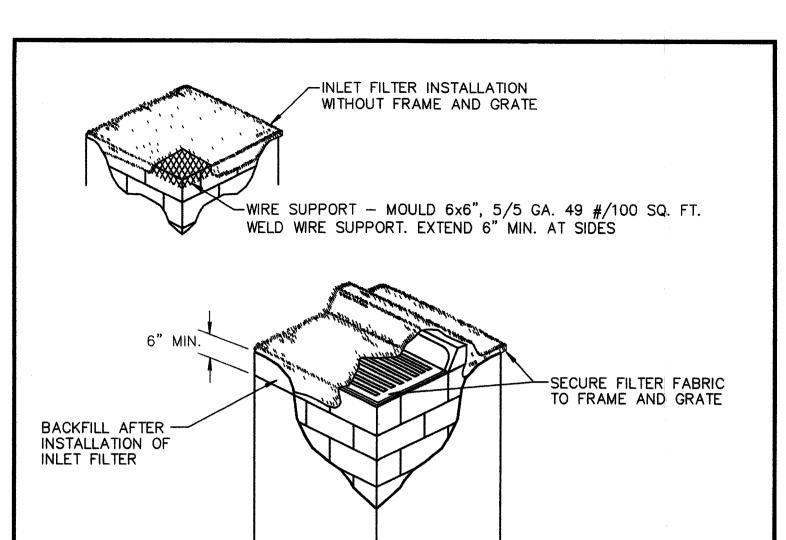


- 1. CONTRACTOR IS TO CLEAN INLET FILTER AFTER EVERY STORM.
- 2. CONTRACTOR TO REMOVE FABRIC JUST PRIOR TO PAVING.

CITY of DELRAY BEACH

A SEDIMENT TRAP WILL BE EXCAVATED BEHIND THE CURB AT THE INLET. THE BASIN SHALL BE AT LEAST 12 TO 14 INCHES IN DEPTH, APPROXIMATELY 36 INCHES IN WIDTH AND APPROXIMATELY 7 TO 10 FEET IN LENGTH PARALLEL TO THE CURB.

NOT TO SCALE

STORM WATER WILL REACH THE SEDIMENT TRAP VIA CURB CUTS ADJACENT TO EACH SIDE OF THE INLET STRUCTURE. THESE OPENINGS SHALL BE AT LEAST 12 INCHES IN LENGTH. STORM WATER MAY ALSO REACH THE BASIN VIA OVERLAND FLOW LAND AREA BEHIND THE CURB. THE CURB CUTS SHALL BE REPAIRED WHEN THE SEDIMENT TRAP IS REMOVED.

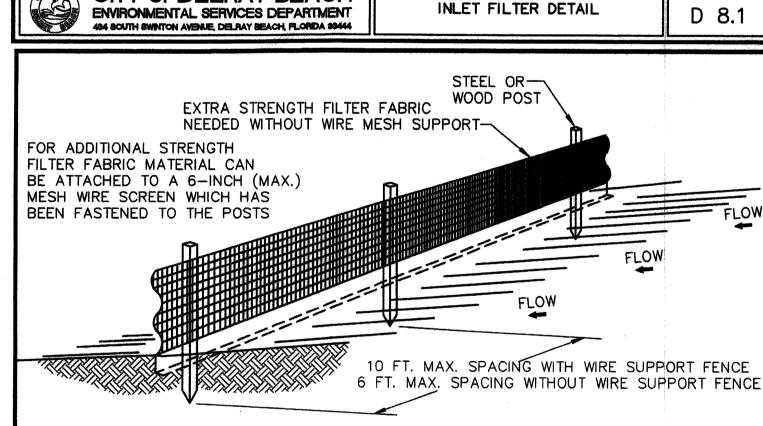

#### NOTES:


- . THE HEIGHT OF A SILT FENCE SHALL NOT EXCEED 36 INCHES (90 CM).
- 2. THE FILTER FABRIC SHALL BE PURCHASED IN A CONTINUOUS ROLL CUT TO THE LENGTH OF THE BARRIER TO AVOID THE USE OF JOINTS.
- . POSTS SHALL BE SPACED A MAXIMUM OF 10 FEET (3 M) APART AT THE BARRIER LOCATION AND DRIVEN SECURELY INTO THE GROUND A MINIMUM OF 12 INCHES (30 CM). WHEN EXTRA STRENGTH FABRIC IS USED WITHOUT THE WIRE SUPPORT FENCE, POST SPACING SHALL NOT EXCEED 6 FEET (1.8 M).
- . A TRENCH SHALL BE EXCAVATED APPROXIMATELY 4 INCHES (10 CM) WIDE AND 4 INCHES (10 CM) DEEP ALONG THE LINE OF POSTS AND UPSLOPE FROM THE BARRIER.
- WHEN STANDARD STRENGTH FILTER FABRIC IS USED, A WIRE MESH SUPPORT FENCE SHALL BE FASTENED SECURELY TO THE UPSLOPE SIDE OF THE POSTS USING HEAVY DUTY WIRE STAPLES AT LEAST 1 INCH (25 MM) LONG, TIE WIRES, OR HOG RINGS. THE WIRE SHALL EXTEND INTO THE TRENCH A MINIMUM OF 2 INCHES (5 CM) AND SHALL NOT EXTEND MORE THAN 36 INCHES (90 CM) ABOVE THE ORIGINAL GROUND SURFACE.
- . THE STANDARD STRENGTH FILTER FABRIC SHALL BE STAPLED OR WIRED TO THE FENCE. AND 8 INCHES (20 CM) OF THE FABRIC SHALL BE EXTENDED INTO THE TRENCH. THE FABRIC SHALL NOT EXTEND MORE THAN 36 INCHES (90 CM) ABOVE THE ORIGIONAL GROUND SURFACE.
- . THE TRENCH SHALL BE BACKFILLED AND THE SOIL COMPACTED OVER THE FILTER FABRIC.
- B. ALL PROJECTS REQUIRE SUBMITTAL OF POLLUTION PREVENTION PLAN (PPP).
- 9. ALL PROJECTS 1 AC. OR MORE MUST SUBMIT NOTICE OF INTENT (NOI) TO FDEP.

CITY of DELRAY BEACH ENVIRONMENTAL SERVICES DEPARTMENT


SILT FENCE INSTALLATION DETAIL (Sheet 1 of 2)

DATE: 01-02-01 D 9.1a

- 1. THE INTENT OF EROSION CONTROL MEASURES INDICATED GRAPHICALLY ON PLANS IS TO PROVIDE A BARRIER TO CONTAIN SILT AND SEDIMENT ON THE PROJECT SITE. THIS REPRESENTATION IS PROVIDED FOR THE CONVENIENCE OF THE CONTRACTOR. THE TEST OF EROSION CONTROL EFFECTIVENESS IS NOT TO BE DETERMINED BY ADHERENCE TO THE REPRESENT SET FORTH ON THE DRAWINGS AND SPECIFICATIONS, BUT BY MEETING THE REGULATIONS SET FORTH BY THE AUTHORITY HAVING JURSDICTION OVER WATER QUALITY CONTROL AND OTHER SEDIMENTATION RESTRICTION REQUIREMENTS IN THE REGION.
- 2. APPROVED EROSION AND SEDIMENT CONTROL MEASURES SHALL BE INSTALLED PRIOR TO ANY CLEARING GRADING, EXCAVATION, FILLING, OR OTHER LAND DISTURBANCE ACTIVITIES, EXCEPT THOSE OPERATIONS NEEDED TO INSTALL
- 3. INSPECTION OF ALL EROSION CONTROL MEASURES SHALL BE CONDUCTED WEEKLY, OR AFTER EACH RAINFALL EVENT. REPAIR, AND/OR REPLACEMENT OF SUCH MEASURES SHALL BE MADE PROMPTY, AS NEEDED.
- 4. KEEP DUST WITHIN TOLERABLE LIMITS BY SPRINKLING OR OTHER ACCEPTABLE
- 5. ADDITIONAL EROSION AND SEDIMENT CONTROL MEASURES MAY BE REQUIRED IF DEEMED NECESSARY BY ONSITE INSPECTION.
- 6. FAILURE TO PROPERLY INSTALL AND MAINTAIN EROSION CONTROL PRACTICES
- SHALL RESULT IN CONSTRUCTION BEING HALTED. 7. DRAINAGE INLETS SHALL BE PROTECTED BY FILTER AND GRADED ROCK AS PER INLET PROTECTION DETAIL.
- 8. ANY ACCESS ROUTES TO SITE SHALL BE BASED WITH CRUSHED STONE, WHERE
- 9. EROSION CONTROL MEASURES ARE TO BE MAINTAINED UNTIL PERMANENT GROUND COVER IS ESTABLISHED.
- 10. WHENEVER FEASIBLE, NATURAL VEGETATION SHALL BE RETAINED AND PROTECTED.
- 11. ALL WORK IS TO BE IN COMPLIANCE WITH THE RULES AND REGULATIONS SET FORTH BY THE STATE OF FLORIDA, DEPARTMENT OF ENVIRONMENTAL PROTECTION AND THE CITY OF DELRAY BEACH.
- 12. DISCHARGE FROM DEWATERING OPERATIONS SHALL BE RETAINED ONSITE IN A CONTAINMENT AREA.

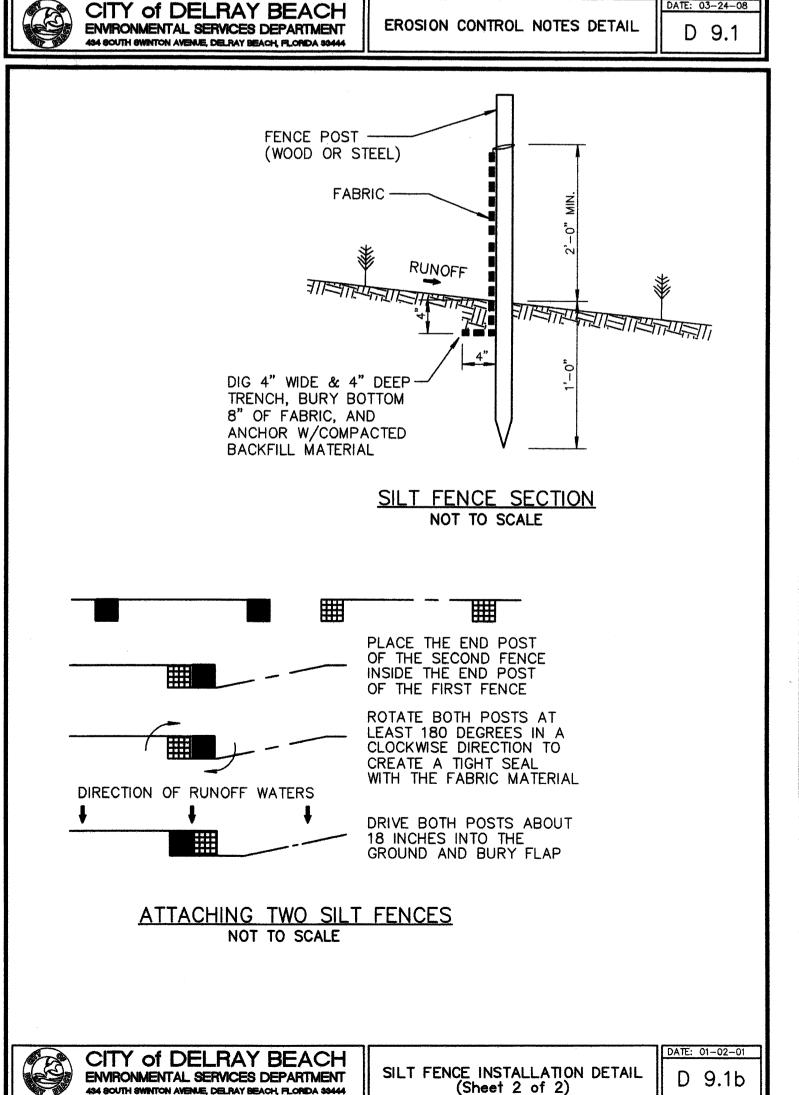

494 SOUTH SWINTON AVENUE, DELRAY BEACH, FLORIDA \$9444

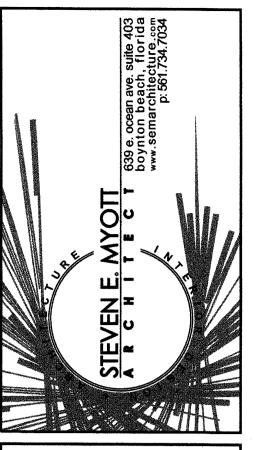


Florida Consulting Engineers,

Certificate of Authorization No. 5810 134 N.W. 16TH STREET, SUITE BOCA RATON , FLORIDA 33432

PHONE: (561) 353-1152

ZJ@FLCENGINEERS.COM

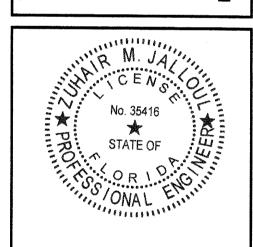

20.049

NO: DATE: ISSUED FOR:

08.18.2020 ZONING RESPONSES

CHECKED BY:

POLLUTION PREVENTION PLAN AND DETAILS

**C-3** 

OF 3

Queen Emma / Crinum augustum

Wart fern / Polypodium scolopendria

Podocarpus column / Podocarpus macrophyllus

NATIVE DROUGHT TOL. Annuals for seasonal color Bamboo textilis gracilis Green Bamboo 7 gal., 8'-10' o.a. Confederate jasmine dwarf 'Minima' /Trachelos. asiaticum 1 gal. Ficus Green Island / Ficus microcarpa 3 gal., 18" o.c. Podocarpus column / Podocarpus macrophyllus 3 gal., 24" ht. min., 18" o.c.

7 gal., 48" ht. min., 18" o.c., full

6" staggered

7 gal., 5' o.c.

NOTE:

1. SMALL NEEDLED, FULL & LUSH PLANT MATERIAL WAS USED TO AID IN CREATING A DENSE BUFFERING FOR NOISE ABATEMENT. BUFFERING BAMBOO AND PODICARPUS WAS USED

2. EVERY EFFORT MUST BE MADE TO PURCHASE THE LARGEST PODOCARPUS IN 3 GALLON CONTAINERS AS POSSIBLE.

2' CURB AND GUTTER

2' CURB AND GUTTER

#### DISCLAIMER


ALL IDEAS, DESIGNS, ARRANGEMENTS AND PLANS INDICATED OR REPRESENTED BY THIS DRAWING ARE THE PROPERTY OF MAUREEN SMITH, LANDSCAPE ARCHITECT AND WERE CREATED, AND DEVELOPED FOR SPECIFIED PROJECT, AND MAY NOT BE ALTERED, CHANGED, MODIFIED OR COPIED WITHOUT THE WRITTEN PERMISSION OF MAUREEN SMITH, LANDSCAPE

WRITTEN DIMENSIONS OF THESE DRAWINGS SHALL HAVE PRECEDENCE OVER SCALED DIMENSIONS, CONTRACTORS SHALL VERIFY, AND BE RESPONSIBLE FOR ALL JOB AND MAUREEN SMITH LANDSCAPE ARCHITECT MUST BE NOTIFIED OF ANY VARIATIONS FROM THE DIMENSIONS AND CONDITIONS SHOWN BY THESE DRAWINGS

SCALED SHOP DRAWINGS AND DETAILS MUST BE SUBMITTED TO MAUREEN SMITH LANDSCAPE ARCHITECT FOR REVIEW AND APPROVAL BEFORE PROCEEDING

ALL NEW PLANT MATERIAL MUST BE WATERED DAILY FOR TWO WEEDS MINIMUM A THOROUGH WATERING OF EACH PLANT MUST TAKE PLACE FOR PROPER ESTABLISHMENT. GRADUALLY REDUCING WATERING DAYS AS NEEDED.

# ANTIC AVE 4 W ATL.

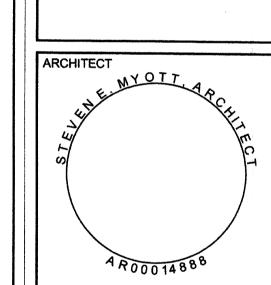

PROJECT NO: DRAWN BY: CHECKED BY: NO: DATE: ISSUED FOR: 08.18.2020 ZONING RESPONSES

**LANDSCAPE PLAN** 

LANDSCAPE SCHEDULE, **DETAILS & NOTES** 

# GENERAL NOTES

- 1. ALL PLANTS TO BE FLORIDA NO. 1 OR BETTER.
- 2. NO SUBSTITUTIONS WILL BE ACCEPTED WITHOUT PRIOR WRITTEN APPROVAL BY THE LANDSCAPE ARCHITECT.
- 3. A DRIP IRRIGATION SYSTEM OR SPRINKLER PIPE WITH EMITTERS. ATTACHED TO A HOSE BIB WITH A BATTERY-OPERATED TIMER.
- 4. QUANTITIES ON PLANT MATERIALS ARE FOR CONVENIENCE ONLY. LANDSCAPE CONTRACTOR IS RESPONSIBLE FOR ALL PLANTS SHOWN ON PLANTING PLANS. WHEN DISCREPANCIES OCCUR BETWEEN PLANT LIST AND PLANTING PLANS, THE PLANS ARE TO OVERRIDE THE PLANT LIST IN ALL CASES. SOD QUANTITY IS TO BE DETERMINED BY CONTRACTOR PRIOR TO BIDDING
- 5. CONTRACTOR IS RESPONSIBLE FOR LOCATING ALL UNDERGROUND UTILITIES TO AVOID DAMAGE.
- 6. CONTRACTOR IS RESPONSIBLE FOR FURNISHING ALL MATERIALS. TOOLS, EQUIPMENT, LABOR, AND PLANTS NECESSARY FOR THE PROPER PLANTING OF ALL TREES, SHRUBS GROUNDCOVERS, AND GRASS AS SHOWN ON LANDSCAPE ARCHITECT'S PLANTING PLANS.
- 7. ALL GROUNDCOVER BEDS TO ABUT PARKING, BUILDING, SIDEWALKS, ETC., IN A PERPENDICULAR LINE.
- 8. ALL TREES AND PALMS TO BE STAKED AND GUYED.
- 9. ALL PLANTED AREAS ARE TO BE MULCHED WITH EUCALYPTUS MULCH, GRADE B OR BETTER, TO A DEPTH OF 3" AND PULLED AWAY FROM DIRECT CONTACT WITH STEMS AND TRUNKS TO AVOID ROTTING.

10. ALL PLANT MATERIAL TO BE BACKFILLED WITH 50% CLEAN MUCK AND 50% SAND AND BE FERTILE, AND FRIABLE.

YES

YES

YES

YES

YES

- 11. GROUNDCOVER AND SHRUBS TO BE LAID OUT IN A UNIFORM AND CONSISTENT PATTERN.
- 12. THE CONTRACTOR SHALL LAY OUT ON THE GROUND THE LOCATIONS FOR THE PLANTS AND OUTLINES OF AREAS TO BE PLANTED. THE CONTRACTOR SHALL OBTAIN APPROVAL FROM THE LANDSCAPE ARCHITECT BEFORE EXCAVATION BEGINS. THE LANDSCAPE ARCHITECT MAY ADJUST THE LOCATION OF SPECIFIED PLANT MATERIALS PRIOR TO PLANTING.
- 13. TREES AND PALMS TO BE GUARANTEED FOR ONE (1) YEAR, SHRUBS AND GROUNDCOVERS TO BE GUARANTEED FOR NINETY (90) DAYS AFTER FINAL WRITTEN ACCEPTANCE IS GIVEN BY OWNER OR LANDSCAPE ARCHITECT. CONTRACTOR IS RESPONSIBLE FOR PLANT MAINTENANCE UNTIL THE TIME OF WRITTEN ACCEPTANCE.
- 14. ALL PROHIBITED PLANT SPECIES (AS IDENTIFIED BY THE CITY, COUNTY, STATE) SHALL BE ERADICATED FROM THE SITE, THIS INCLUDES BUT IS NOT LIMITED TO MELALEUCA, BRAZILIAN PEPPER AND AUSTRALIAN PINE.
- 15. ALL EXISTING AND NEWLY CREATED PLANTING BEDS TO BE CLEANED AND FREE OF WEEDS AND DEBRIS AND EXCAVATED AS REQUIRED TO FULFILL PLANTING SOIL REQUIREMENTS OF THE PLANTING DETAILS.
- 16. FILL HOLES WHERE EXISTING TREES OR PLANT MATERIAL HAVE BEEN REMOVED TO PROVIDE LEVEL SURFACE WITH SURROUNDING AREA AND SOD OVER IF NEW PLANT BEDS ARE NOT TO BE INSTALLED.

# CEMENT COLLAR TO EXTEND UNDER ONE FULL WIDTH OF -12" COMPACTED SUB-GRADE TO 98% PER AASHTO T-180

# NEW PAVER EDGE DETAIL

N.T.S.

1\" SAND BEDDING


RIGHT OF WAY. 6" LIMEROCK BASE

RIGHT OF WAY. 4"

FLOW-ABLE FILL (100

4" LIMEROCK BASE
COMPACTED TO 98% PER
AASHTO T-180 OUTSIDE


COMPACTED TO 98% PER

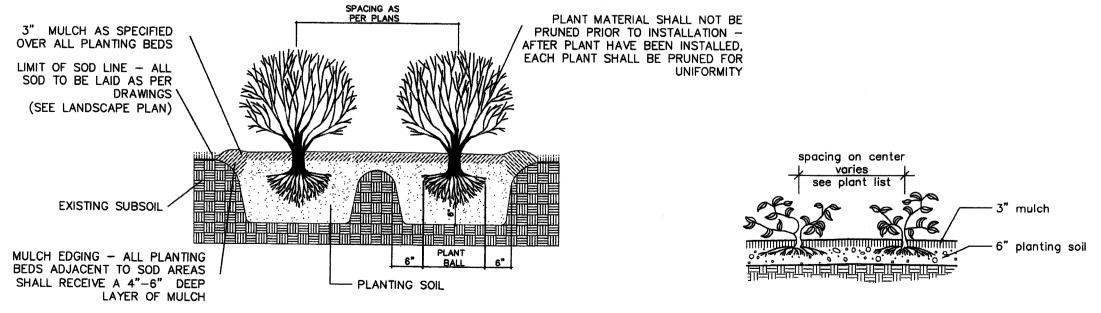

Typical Shrub Planting Detail

Groundcovers

# PLANTING DETAILS

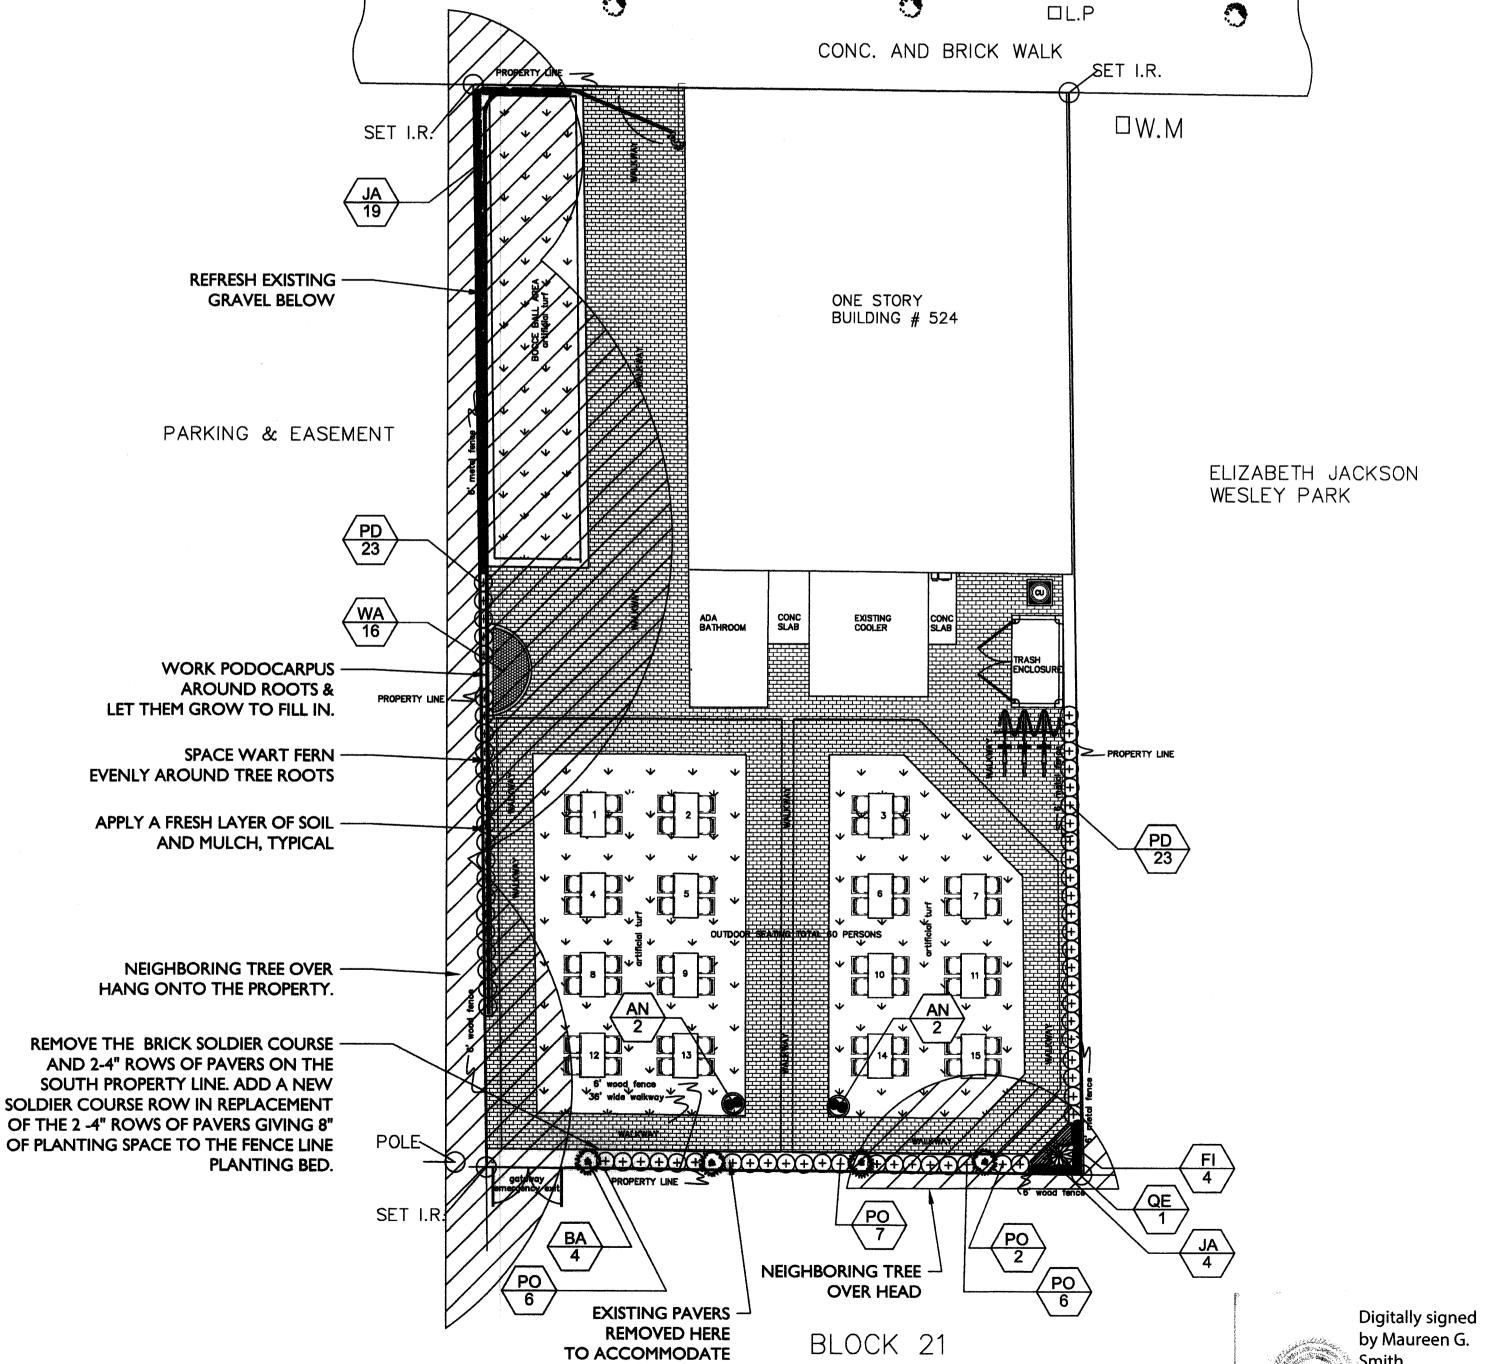

WEST ATLANTIC AVENUE

EASTBOUND

PAVED

RIGHT OF WAY

LANDSCAPE PLAN

SCALE: 1" = 20'

**CONTINUOUS HEDGE** 

DELRAY BEACH, FLORIDA 33483 CELL: 561.271.8933 ok: Maureen Smith, Landscape Architec

11:33:02 -05'00'