
N.E. 4TH STREET

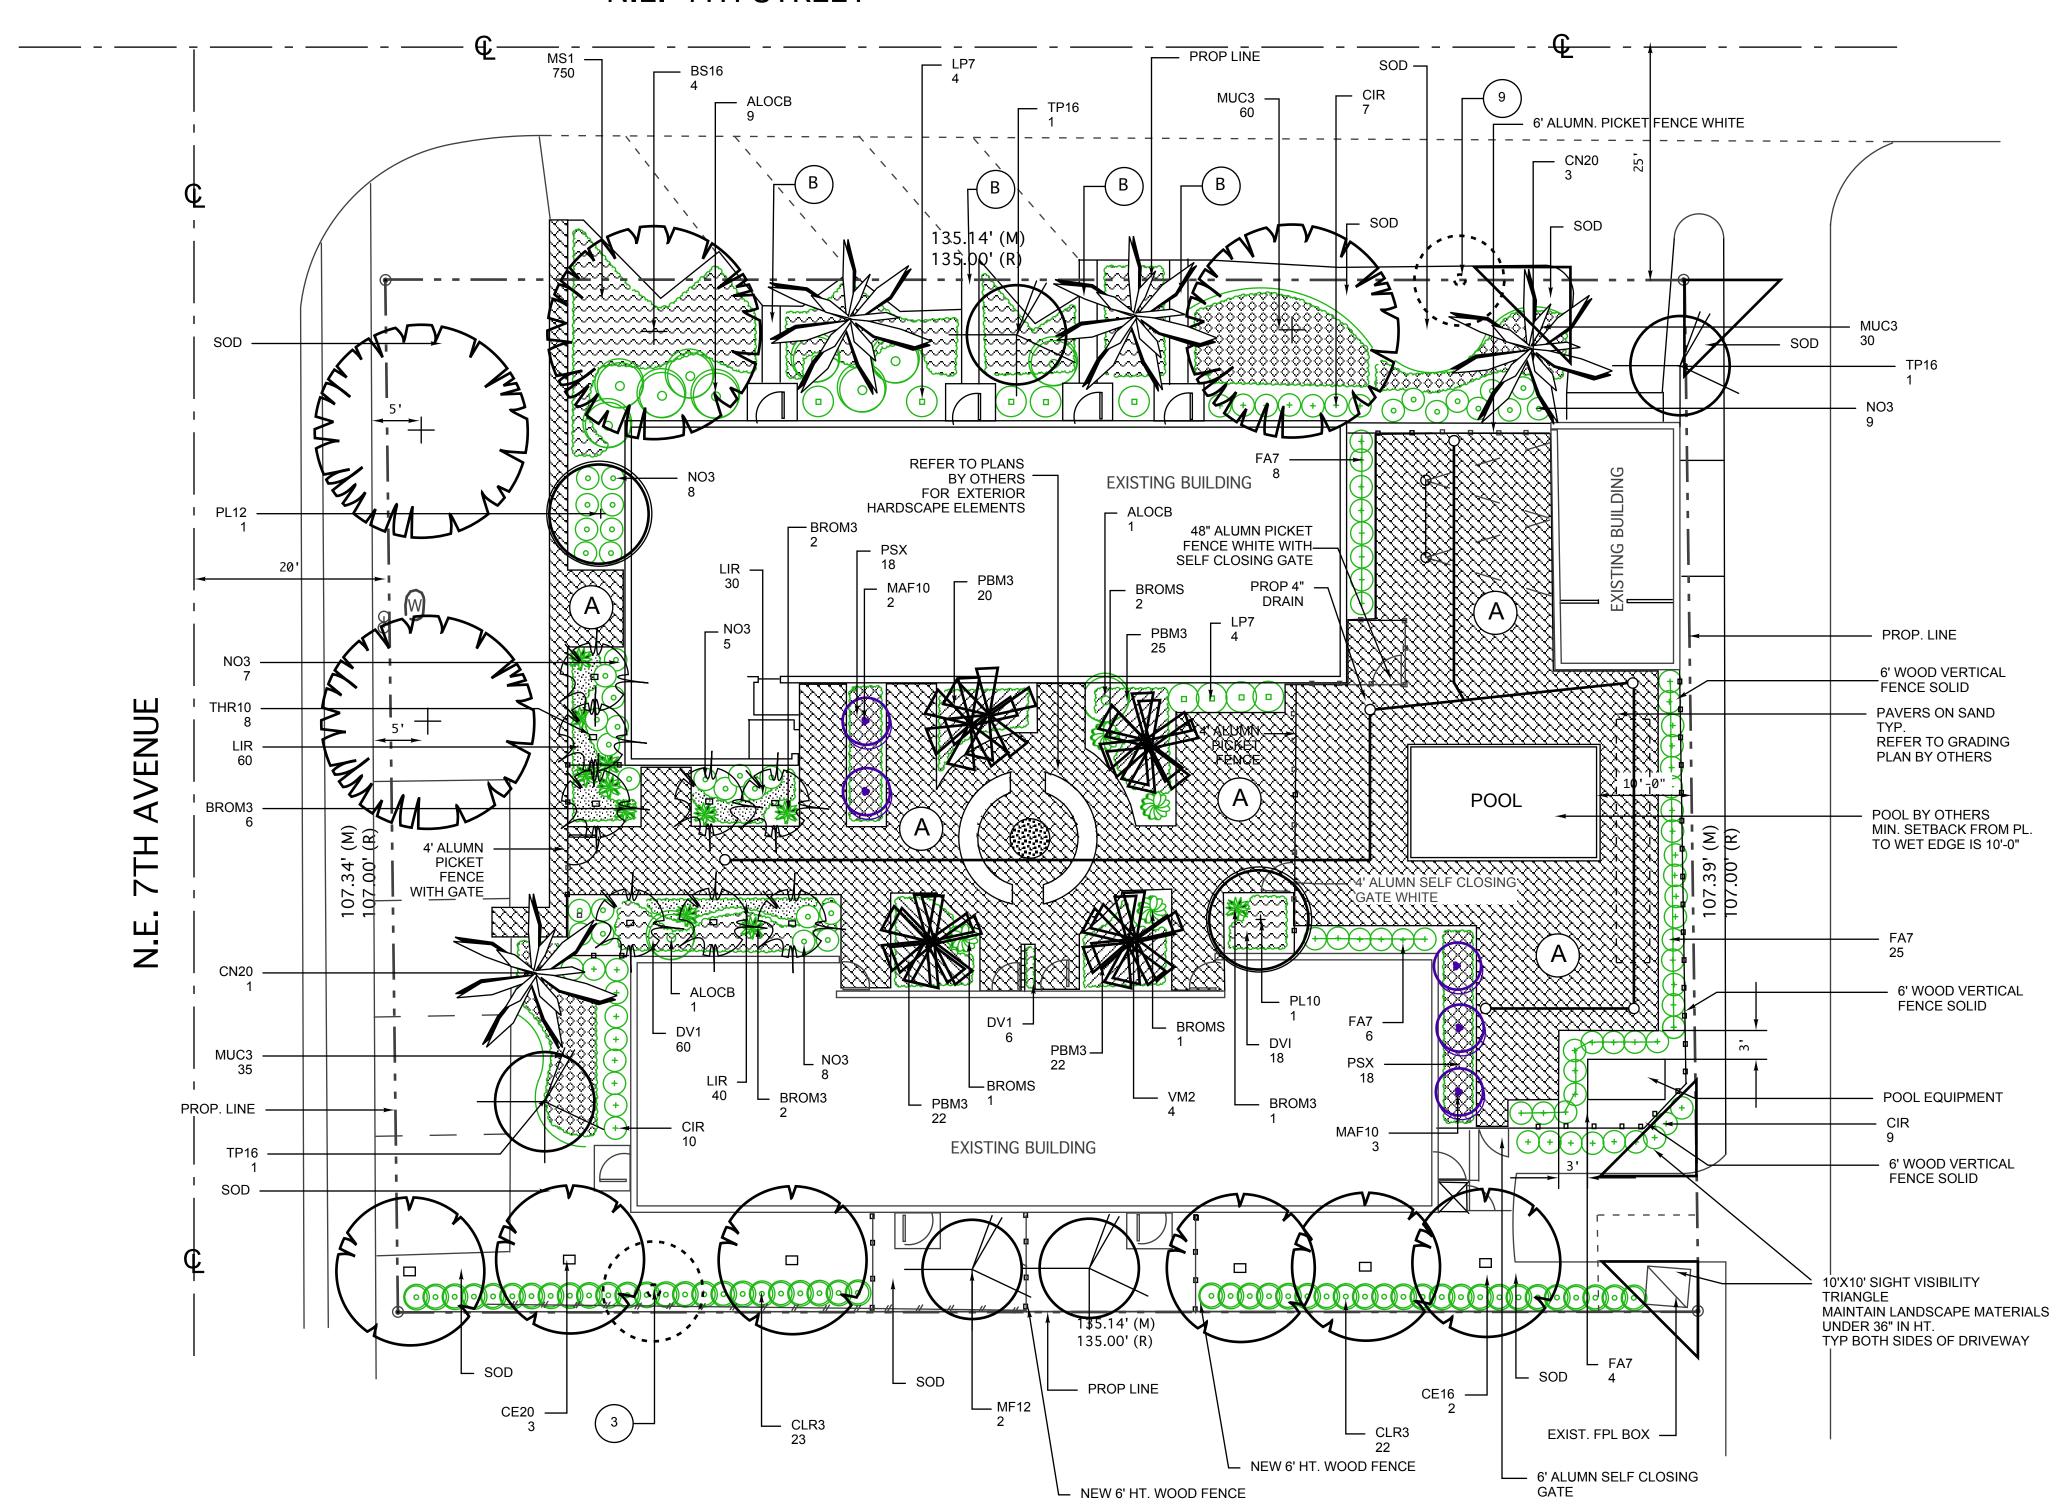

CITY OF DELRAY LANDCAPE REQUIREMENTS

SOUTH BUFFER REQUIREMENTS ADJ. TO RESIDENTIAL USE SEC. 4.4.6 (I)(1)(c) (1) TREE REQ. PER 30 LF. 25% SIZE INCREASE 135'/30 = 5 TREES REQUIRED PROVIDED = 5 (20'X10' 5" CAL.)

4.6.16(C)(1) LANDSCAPE PERMITS WILL BE APPLIED FOR

4.6.16 (H)(6) STREET TREES (1) TRÈE PÉR 40 LF. OF STREET FTONTAGE WITH A MIN. OF (1) TREE PER PROPERTY

NE 7TH AVE: 107 LF. /40 = 3 REQ. PROVIDED = 3

NE 4TH ST. 135 LF. / 40 = 4 REQ. PROVIDED = 4

4.4.16(E) DESIGN STANDARDS COMPLIED

NOTE: ANY TREES OR SHRUBS PLACED WITHIN WATER, SWEER OR DRAINAGE EASEMENTS SHALL CONFORM TO THE CITY OF DELRAY BEACH STANDARD DETAILSS LD.1 AND LD1.2

TREE MITIGATION DATA:

TREES REMOVED MITIGATION REQUIRE	D = DBH.
1. MANGO	19" DBH. 55%
2. STRANGLER FIG	26" DBH. 45% 1:1 REPLACEMEN
4. MANGO	17" DBH. 60%
6. AVACADO	14" DBH. 40% 1:1 REPLACEMEN
7. BANYAN	90" DBH. 45% 1:1 REPLACEMEN

TREES REQUIRED = 36" MITIGATION PROVIDED = 36" TREES REQUIRED ON 1:1 BASIS = 3 PROPOSED TREES = 3

PALMS REMOVED = 1 MITIGATION PROVIDED = 1 COCONUT PALM

- PAVERS ON SAND **COLOR AND PATTERN** BY OTHERS SEE DETAIL SHEET L-4
- 4" CONC. WALK SEE DETAIL SHEET L-4

REFER TO GRADING PLANS BY OTHERS

MASTER PLANT LIST

KEY	PLANT NAME	SPECIFICATION	QUANTITY	MITIGATION
BS16	BURSERA SIMARUBA GUMBO LIMBO	16' X 7' SPR. 6' CT MIN. 4" CAL. B&B FG NATIVE HIGH DROUGHT TOLERANCE	4	16"
CE20	CONOCARPUS ERECTUS GREEN BUTTONWOOD TREE	20' HT.X 10' SPR. MIN. 7.5'CT. 5" CAL. TREE STANDARDS, B&B NATIVE HIGH DROUGHT TOLERANCE	6	30"
TP16	TABEBUIA HETEROPHYLLA PINK TABEBUIA	16' HT. 7' SPR. 4" CAL . 6' CT. HIGH DROUGHT TOLERANCE	3	12"
PL12	PSIDIUM LITTORALE STRAWBERRY / CATTLEY GUAVA	12' X 6' SPR. 3'CT. MIN 2.5" CAL. MULTI-STEM, MATCHED SYMETRICALLY SHAPE"	2	5"
	-	•	TOTAL MITIGA	ATION 63"


MASTER PLANT LIST

KEY	PLANT NAME	SPECIFICATION	QUANTITY
<u>CN20</u>	COCOS NUCIFERA 'MALAYAN' GREEN MALAYAN COCONUT PALM	18' OA. 6' CT. MIN. MIXED CURVED TRUNKS HIGH DROUGHT TOLERANCE	4 1:1
THR10	THRINAX RADIATA KEY THATCH PALM ALT: SILVER PALM	8' CT. STAGGER HTS. SINGLE TRUNK NATIVE HIGH DROUGHT TOLERANCE	8 3:1
VM2	VEITCHIA MONTGOMERYANA MONTGOMERY PALM	8' -10' CT. 16' OA. DBL. TRUNKS HIGH DROUGHT TOLERANCE	4 3:1

TOTAL PALMS = 16 TREE EQUIVALENT = 8

MASTER PLANT LIST

KEY	PLANT NAME	SPECIFICATION	QUANTITY
ALOCB	ALOCASIA BLACK STEM	36"X 36" SPR. MIN. MEDIUM DROUGHT TOLERANCE	11
BROM3	BROMELIADS IMPERIALIS	MED SIZE VARIETY 7 GAL. SUN GROWN HIGH DROUGHT TOLERANCE	11
BROMS	BROMELIAD SPP. SILVER, SUN GROWN	18"X18" MATCHED HIGH DROUGHT TOLERANCE	3
CIR	CHRYSOBALANUS ICACO COCtOPLUM HEDGE	24" X 24" 24" O.C. NATIVE MEDIUM DROUGHT TOLERANCE	26
CLR3	CLUSIA ROSEA NANA SMALL LEAF PITCH APPLE	24 "X 24 " 24" O.C. NATIVE HIGH DROUGHT TOLERANCE	45
DV1	DIETES IRIDIOIDES AFRICAN IRIS	12" FULL TO POT 12" O.C. HIGH DROUGHT TOLERANCE	84
FA7	FICUS MACLELLANDII "ALII"	36" HT X 24" SPR. 24" O.C. HIGH DROUGHT TOLERANCE	39
LIR	LIRIOPE MUSCARI GREEN LIRIOPE	1GAL FULL 6-8 BIBS MIN 8" O.C. MED DROUGHT TOLERANCE	70
LP7	RHAPIS EXCELSA LADY PALM SHADE GROWN	36"' X 36" FULL TO BASE SUN/SHADE GROWN MEDIUM DROUGHT TOLERANCE	8
MAF10	POLYALTHIA LONGIFOLIA MAST TREE	8' OA. STRAIGHT TRUNK HIGH DROUGHT TOLERANCE	5
MS1	MIMOSA STRIGILLOSA SUNSHINE MIMOSA POWDERPUFF	4" X 6" 6"-8" O.C. NATIVE MEDIUM DROUGHT TOLERANCE	750
MUC3	MUHLENBERGIA CAPILLARIS MUHLY GRASS	18" X 15" SPR. 15"- 18" O.C. NATIVE HIGH DROUGHT TOLERANCE	125
NO3	NERIUM OLEANDER DWARF OLEANDER WHITE FLOWER	36 "X 24" 24" O.C HIGH DROUGHT TOLERANCE	25
PBM3	PHILODENDRON SELLOUM BURLE MARX	12" X 15" 18" O.C. MEDIUM DROUGHT TOLERANCE	89
PSX	PHILODENDREN XANADU 'XANADU'	18"X15" 18" O.C. MEDIUM DROUGHT TOLERANCE	36
SOD	ST. AUGUSTINE FLORITAMT	CONTRACTOR TO VERIFY QUANTITY FOR PROPOSED	
	l .		

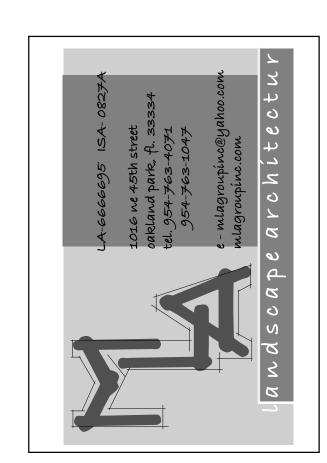


REVISIONS: SHEET TITLE: LANDSCAPE PLAN

DD

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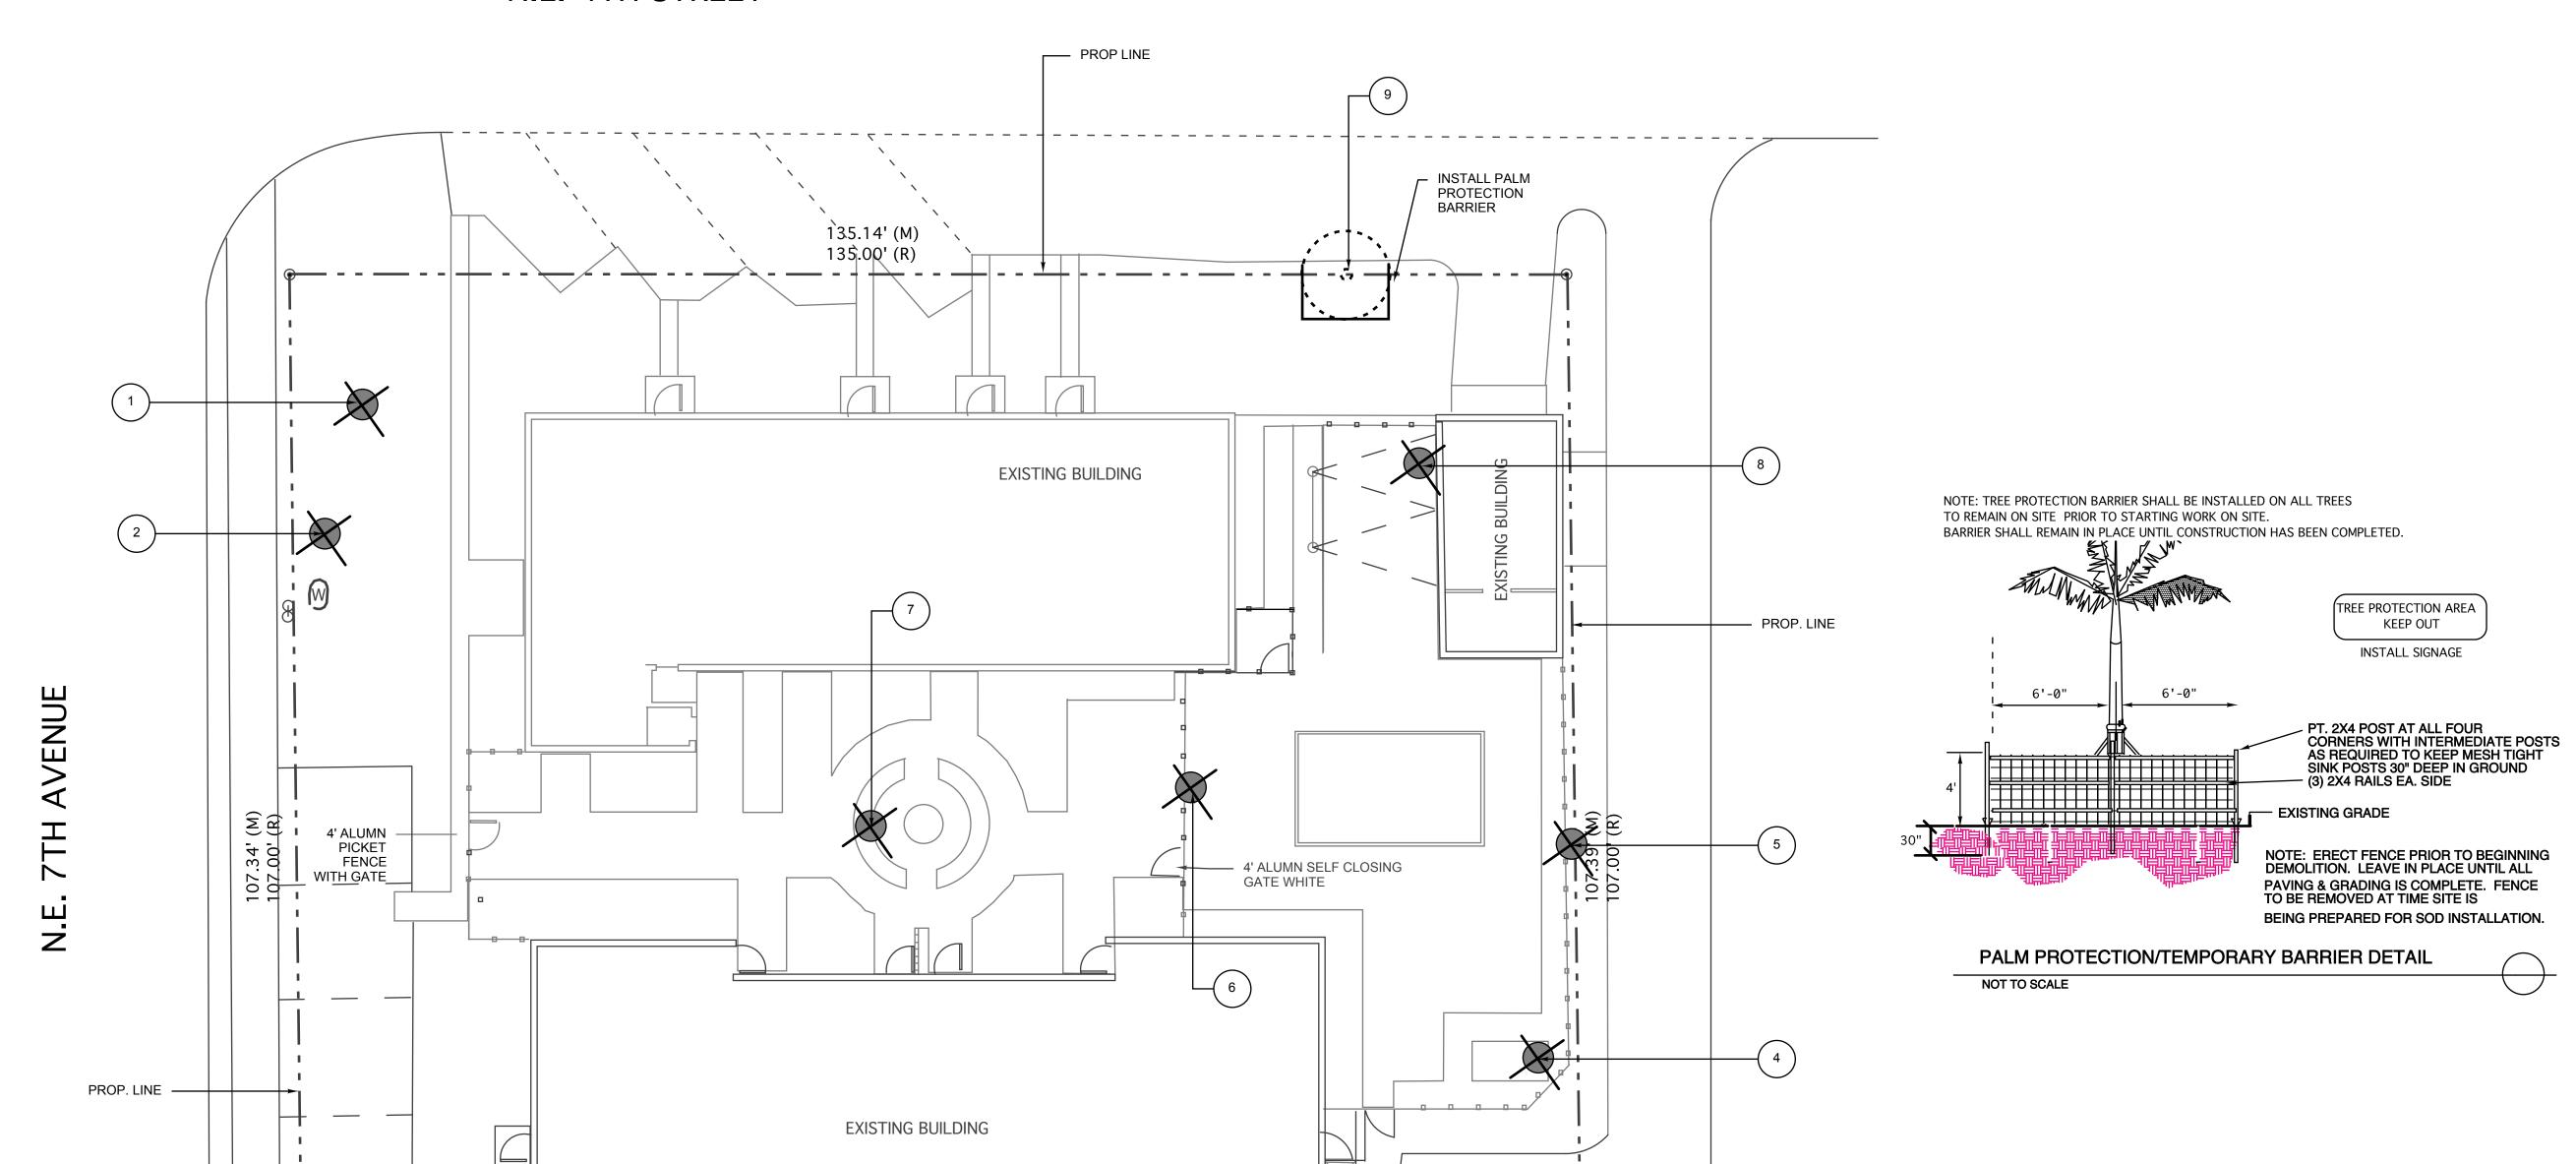
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SCALE: 1"=10' DATE DRAWN: 4/11/22

SHEET NO.

N.E. 4TH STREET

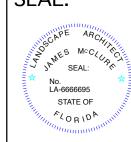

EXISTING TREE INVENTORY

INSTALL PALM PROTECTION

BARRIER

135.14' (M) 135.00' (R)


— PROP LINE

TREE NO. BOTANICAL NAME CO	DMMON NAME SIZE ((DBH. HT. X SPR., CT.)	CONDITION	DISPOSITION
 MANGO SPP. FICUS AUREA SYAGRUS ROMANZOFFIANA MANGO SPP. SABAL PALMETTO AVACADO SPP. FICUS BENGHALESIS SABAL PALMETTO SABAL PALMETTO 	MANGO STRANGLER FIG QUEEN PALM MANGO CABBAGE PALM AVACADO BANYAN CABBAGE PALM CABBAGE PALM	19" 40'X30' 11" +15" 35'X20' CO-DOM AT 9' CT. 17" 30'X30' 5' CT. 6" + 8" 20'X20' CO-DOM AT B. 90" 50' X 66' 3.5' CT. 10' CT.	70% 60% 80%	REMAIN REMOVE REMAIN REMOVE REMOVE REMOVE REMOVE REMOVE REMOVE REMOVE

NO TREES SHALL BE REMOVED WITHOUT A TREE REOVAL PERMIT ISSUED BY THE CITY OF DELRAY BEACH

TREE MITIGATION DATA:

TREES REMOVED MITIGATION REQUIRED 1. MANGO 2. STRANGLER FIG 4. MANGO 6. AVACADO 7. BANYAN	D = DBH. 19" DBH. 55% 26" DBH. 45% 1:1 REPLACEMENT 17" DBH. 60% 14" DBH. 40% 1:1 REPLACEMENT 90" DBH. 45% 1:1 REPLACEMENT	
TOTAL DBH. REMOVED = 36" DBH. TREES REQUIRED = 36" MITIGATION PROVIDED = 36" TREES REQUIRED ON 1:1 BASIS = 3 PROPOSED TREES = 3		
PALMS REMOVED = 1 MITIGATION PROVIDED	D = 1 COCONUT PALM	

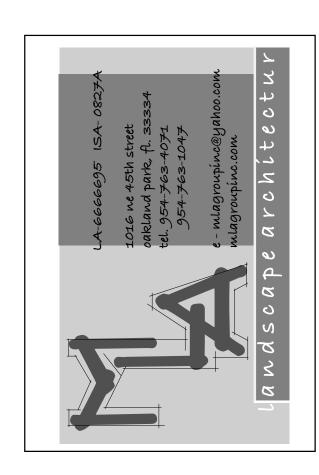

SHEET TITLE:
EXISTING TREE
DISPOSITION
PLAN

REVISIONS:


DELRAY MULTI FAMILY 351 NE 7TH AVE DELRAY BEACH, FL

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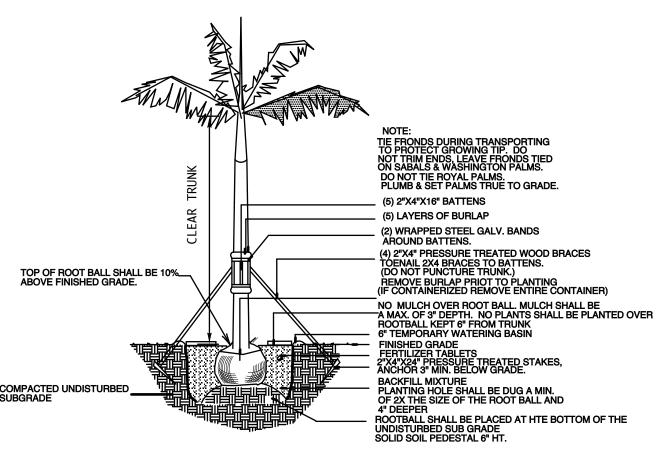
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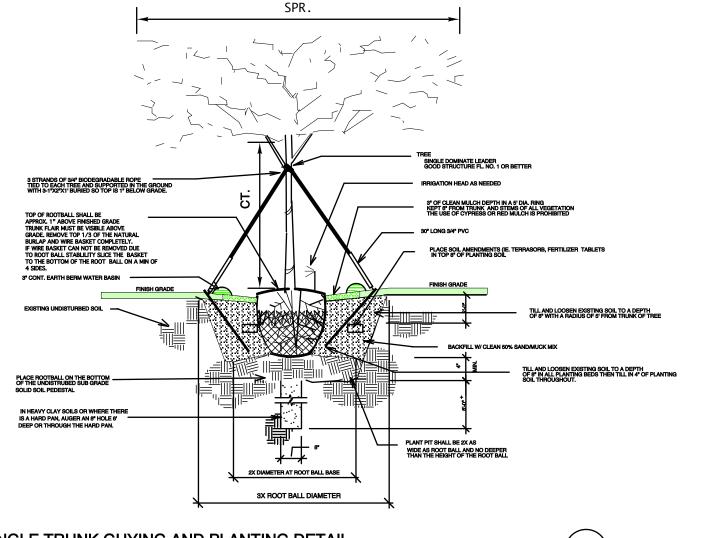
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L-2


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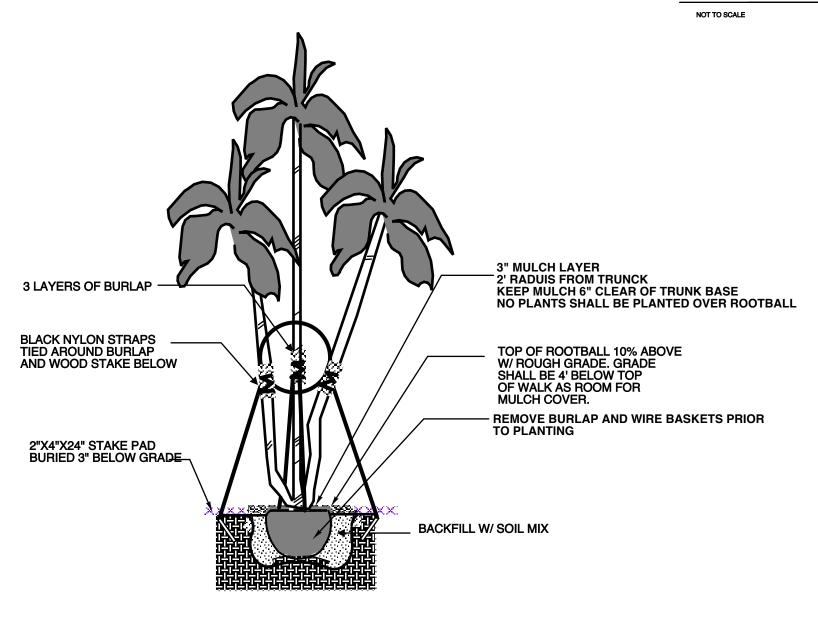


ROYAL PALM PLANTING DETAIL NOT TO SCALE

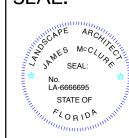


BLACK NYLON STRAPPING PLACE ROOTBALL ON THE BOTTOM-OF THE UNDISTRUBED SUB GRADE SOLID SOIL PEDESTAL IN HEAVY CLAY SOILS OR WHERE THERI IS A HARD PAN, AUGER AN 8" HOLE 6' 3X ROOT BALL DIAMETER **MULTI - TRUNK GUYING AND PLANTING DETAIL** SINGLE TRUNK GUYING AND PLANTING DETAIL



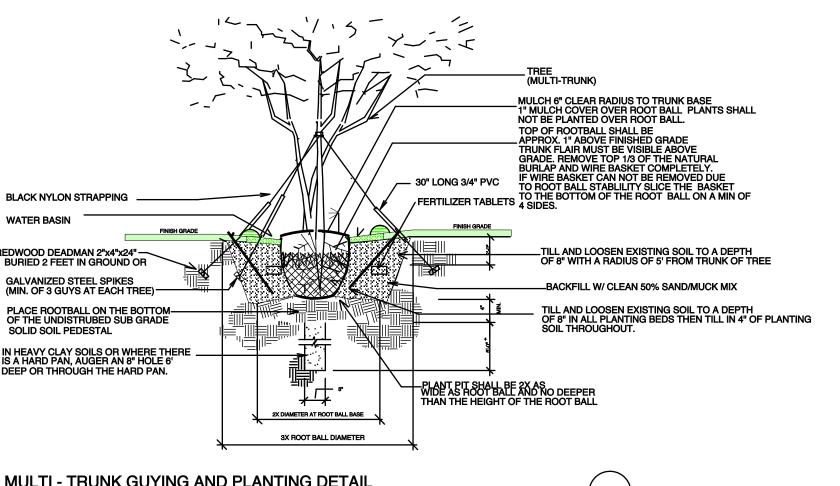

TOP OF ROOT BALL SHALL BE 10%_ ABOVE FINISHED GRADE. . MIN. 3" LAYER MULCH IN ENTIRE BED. MULCH SHALL BE KEPT 6" FROM PLANT BASE 3" MULCH RING. MULCH SHALL BE KEPT 6" FROM BASE OF PLANT - FINISHED GRADE 6" PLANTING SOIL-(PER SPECS) BACKFILL BETWEEN PLANTS 6" BEYOND EDGE OF ROOT MASS WITH PREPARED BACKFILL MIXTURE. PLANTING HOLE SHALL BE A MIN.OF 2X THE SIZE OF THE ROOT BALL. REMOVE ENTIRE CONTAINER BEFORE PLANTING EXISTING SUBSOIL

> GROUNDCOVER/ANNUALS PLANTING DETAIL NOT TO SCALE

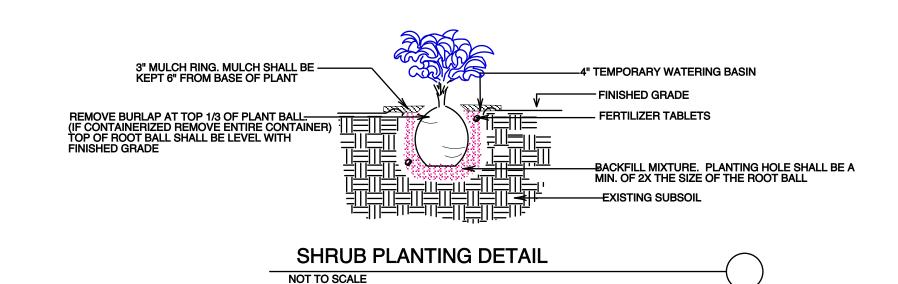


PLANTING NOTES:


NOT TO SCALE


MULTI TRUNK PALM PLANTING DETAIL

- 1. ALL SIZES SHOWN FOR PLANT MATERIAL ON PLAN ARE TO BE CONSIDERED AS MINIMUMS. ALL PLANT MATERIAL MUST MEET OR EXCEED THESE MINIMUM REQUIREMENTS FOR BOTH HEIGHT AND SPREAD. ANY OTHER REQUIREMENTS FOR SPECIFIC SHAPE OR EFFECT AS NOTED ON THE PLAN WILL ALSO BE REQUIRED FOR FINAL ACCEPTANCE.
- 2. ALL PLANT MATERIAL FURNISHED BY THE LANDSCAPE CONTRACTOR UNLESS OTHERWISE SPECIFIED SHALL BE FLORIDA NO.1 OR BETTER ACCORDING TO GRADES AND STANDARDS FOR NURSERY
 PLANTS LATEST EDITION 2001. ALL TREES DESIGNATED AS SINGLE TRUNK
 TREES SHALL HAVE SINGLE DOMINANT LEADER AND STRAIGHT TRUNK.
 THE PROPER STRUCTURE OF TREES IS MOST IMPORTANT. ALL TREES
- MULTI-TRUNK TREES SHALL HAVE AT LEAST THREE (3) TRUNKS WITH EQUAL ORIGINATING AT THE BASE OF THE TREES AND WITH ANGLES NO LESS THAN 45 DEGREES. TREES WITH BARK INCLUSION AND CODOMINANT TRUNKS AT ANY HEIGHT WILL NOT BE ACCEPTED. ALL TREES AND PALMS MUST BE GUYED WITH PROPER HORTICULTURAL AND ARBORICULTURAL TECHNIQUES. WE RECOMMEND THAT THE TREES BE STAKED WITH NATURAL HEMP IN LIEU OF WIRE OR OTHER SYNTHETIC MATERIAL. NAILING INTO TREES AND PALMS IS PROHIBITED. ALL STAKING SHALL BE REMOVED APPROX. SIX (6) MONTHS AFTER PLANTING OR AT TIME OF ESTABLISHMENT OF TREE. ALL PLANTING TO BE DONE IN ACCORDANCE WITH PROPER HORTICULTURAL
- 3. IN ADDITION TO THESE REQUIREMENTS ALL LOCAL LANDSCAPE CODES AND REQUIREMENTS SHALL BE MET IN ORDER TO SATISFY THE REVIEW AND APPROVAL OF THE GOVERNING MUNICIPALITY.
- 4. ALL LANDSCAPING SCHEDULED TO OCCUR IN VEHICULAR USE AREAS SHALL BE PROTECTED FROM VEHICULAR ENCROACHMENT BY CURBING OR OTHER DURABLE BARRIERS.
- 5. ALL PLANTING HOLES SHALL BE A MINIMUM OF 2 1/2 TIMES THE DIAMETER OF THE PLANT BALL. ALL PLANTING AREAS SHALL BE EXCAVATED TO REMOVE ALL OBJECTIONABLE MATERIALS, SUCH AS ASPHALT, SUB-BASE, CONCRETE, ROCK, CAUSTIC MATERIALS
 WITH AN EXCESSIVE SOIL Ph, OR SIMILAR MATERIALS NOT SUITED
 FOR LANDSCAPE PLANTING. ALL SYNTHETIC BURLAP, SYNTHETIC STRING
 OR CORDS OR WIRE BASKETS SHALL BE REMOVED BEFORE PLANTING. ALL SYNTHETIC TAPE SHALL BE REMOVED FROM TREES BEFORE INSPECTION.
 THE TOP 1/3 OF ANY NATURAL BURLAP SHALL BE REMOVED OR TUCKED INTO THE PLANTING HOLE BEFORE THE TREE IS BACK FILLED.
- 6. ALL PLANT MATERIALS SHALL BE PLANTED IN PLANTING SOIL THAT IS DELIVERED TO THE SITE IN A CLEAN, LOOSE AND FRIABLE CONDITION. ALL PLANTING BEDS SHALL HAVE A MINIMUM OF 6" OF PLANTING SOIL, AND ALL SODDED AREAS SHALL HAVE 2" OF PLANTING SOIL. THIS SOIL SHALL BE TILED INTO EXISTING SOIL ON SITE. ALL SOIL SHALL WELL DRAINED CHARACTERISTIC. SOIL MUST BE FREE OF ALL ROCKS, STICKS, OBJECTIONABLE DEBRIS INCLUDING WEEDS AND WEED SEED. RECYCLED COMPOST IS ENCOURAGED AS A SOIL AMENDMENT.
- 7. ALL PLANT MATERIALS SHALL BE THOROUGHLY WATERED IN AT THE TIME OF PLANTING. NO DRY PLANTING SHALL BE PERMITTED. ALL PLANT MATERIALS SHALL BE PLANTED SUCH THAT THE TOP OF THE PLANT ROOT BALL IS FLUSH WITH THE SURROUNDING GRADE OR PLANTED AT 10% ABOVE THE SURROUNDING GRADE PER SPECIFICATIONS ON THE PLANTING DETAILS.

- 8. ALL PLANT MATERIALS SHALL BE INSTALLED WITH FERTILIZER WHICH SHALL BE STATE APPROVED AS A COMPLETE FERTILIZER CONTAINING THE REQUIRED MINIMUM OF TRACE MINOR ELEMENTS IN ADDITION TO N-P-K, OF WHICH 50% OF THE NITROGEN SHALL BE DERIVED FROM AN ORGANIC SOURCE.
- 9. ALL LANDSCAPE AREAS NOT COVERED BY SHRUBS OR GROUND COVERED SHALL BE COVERED BY SOD AND ALL AREAS NOT COVERED BY SOD SHALL BE COVERED WITH NONCYPRESS ARSENIC FREE MULCH, TO A MINIMUM DEPTH OF THREE (3) INCHES OF COVER WHEN SETTLED ALL MULCH SHALL BE KEPT 2" FROM THE BASE OF ALL PLANT MATERIAL. THE WATER BASIN PARTICULARLY ON OAKS SHALL REMAIN FOR AT LEAST THREE (3) MONTHS.
- 10. SOD SHALL BE (AS NOTED) SOLID SOD , AND SHALL BE LAID ON A SMOOTH PLANTING BASE WHICH HAS BEEN GRADED TO MEET THE DRAINAGE CHARACTERISTICS OF THE SITE ALL SOD SHALL BE LAID WITH CLOSELY FITTED JOINTS, AND SHALL BE IN A GREEN AND HEALTHY GROWING CONDITION AT PLANTING.
- 11. ALL LANDSCAPE AREA SHALL BE IRRIGATED BY A FULLY AUTOMATIC SYSTEM ADJUSTED TO PROVIDE 100% COVERAGE OF ALL LANDSCAPE AREAS WITH RAIN SENSOR. ALL HEADS SHALL BE ADJUSTED TO MIN. 50% OVERLAP. IRRIGATION SYSTEM SHALL BE RUST FREE WITH NO OVERSPRAY ONTO PERVIOUS AREAS. PVC RISERS SHALL BE PAINTED FLAT BLACK.
- 12. ANY SUBSTITUTIONS TO PLANT MATERIALS FOR AREAS AND ITEMS ADDRESSED BY LOCAL CODES SHALL BE APPROVED BY THE GOVERNING MUNICIPALITY PRIOR TO WORK PERFORMED.
- 13. ALL LANDSCAPE AREAS SHALL BE FINISH GRADED SUCH THAT THEY ARE 3.5" BELOW SURROUNDING PAVED SURFACES AS NOT TO IMPEDE THE FLOW OF DRAINAGE INTO LANDSCAPE AREAS AND TO ALLOW FOR A 3" MULCH LAYER.
- 14. ALL NEW LANDSCAPED AREAS SHALL BE EXCAVATED OF ALL ROCK AND DEPRIS DOWN TO A DEPTH 30" AND BACK FILLED WITH CLEAN DEPRIS FREE 50/50 MIX SOIL.
- 15. CONTRACTOR SHALL PROVIDE SOD AND IRRIGATION TO EDGES OF OF RIGHT OF WAYS AND ALL PROPERTY LINES.
- 16. ALL FREE STANDING UTILITIES AND SITE EQUIPEMENT MUST BE SCREENED ON THREE (3) SIDES WITH SHRUB MATERIAL 36" IN HEIGHT AT TIME OF PLANTING.
- 17. PLANTING PLAN TAKES PRECEDENT OVER PLANT LIST.
- 18. SOIL: WHERE LANDSCAPE PLANS ARE REQUIRED APPLICANTS AS DETERMINED BY ZONING ADMINISTRATOR OR DESIGNEE SEEK A SOIL TEST AND ANALYSIS PERFORMED BY A
 REPUTABLE SOIL TESTING LAB TO DETERMINE SOIL TETURE, PERCENTAGE OF ORGANIC MATTER
 MEASUER OF PH. TOTAL SOLUBLE SALTS, AND ESTIMATED SOIL INFILTRATION RATE
 EXISTING HORTICULTURALLY SUITABLE TOP SOIL SHALL BE STOCK PILED AND RE SPREAD DURING FINAL SITE GRADING. ANY NEW SOIL REQUIRED SHALL BE SIMILAR TO THE EXISTING SOIL IN PH, TEXTURE, PERMEABILITY AND OTHER CHARACTERISTICS UNLESS DEMOSTRATED TO THE CITY THAT A DIFFERENT TYP OF SOIL AMENDMENT APPROACH IS JUSTIFIED. THE USE OF SOLID WASTE COMPOST AS A SOIL AMENDMENT IS ENCOURAGED WHERE APPROPRIATE.

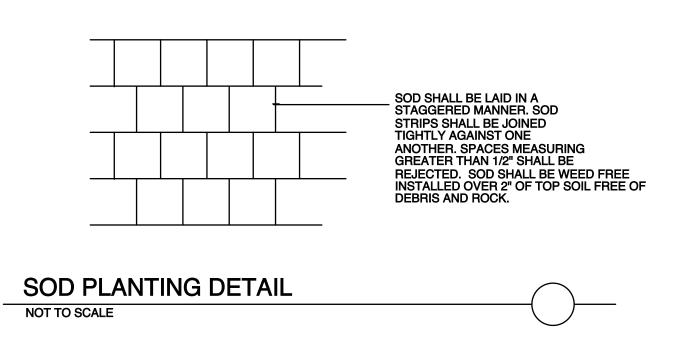

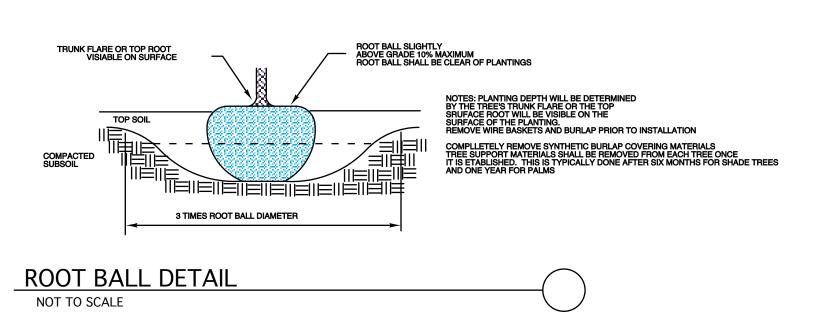

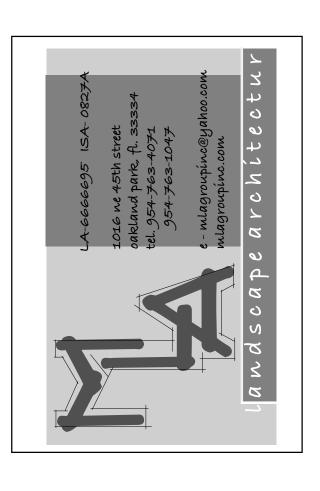

SHEET TITLE: LANDSCAPE **DETAILS AND SPECIFICATIONS**

REVISIONS:

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DATE DRAWN: 4/11/22

SHEET NO.

of-4

GENERAL STRUCTURAL NOTES:

CONCRETE:

ALL CONCRETE SHALL ATTAIN 3000 P.S.I. MIN. COMPRESSIVE STRENGTH AT 28 DAYS.

AGGREGATES TO BE CLEAN AND WELL GRADED, MAXIMUM SIZE TO BE 1". CONCRETE

SLUMP 3" MIN. TO 5" MAX. ALL SLEEVES, CONDUITS, INSERTS, BLOCK-OUT, BOLTS,

PLUMBING AND OR PLUMBING SHALL BE SECURED IN PLACE BEFORE POURING CONCRETE.

CONCRETE SHALL BE READY MIX. ALL CONCRETE WORK SHALL COMPLY

WITH THE REQUIREMENTS OF THE ACI BUILDING CODE, THE ACI DETIALING MANUAL

AND THE SPECIFICATIONS FOR STRUCTURAL CONCRETE FOR BUILDINGS LATEST EDITION.

CONCRETE COVER FOR REINFORCING STEEL SHALL BE AS REQUIRED BY THE LATEST

ACI SPECIFICATIONS. WELDED WIRE FABRIC SHALL COMPLY WITH ASTM A-185, UNLESS

OTHERWISE SPECIFIED. ALL REINFORCING STEEL SHALL BE MANUFACTURED FROM

HIGH STRENGTH BILLET STEEL CONFORMING TO ASTM DESIGNATION A-615.

MASONRY UNITS SHALL BE ASTM C 90-90 GRADE NI OR NII w/MIN COMPRESSIVE STRENGTH OF 1500 P.S.I. ON NET AREA OF INDIVIDUAL UNITS. ALL CMU SHALL BE LAID IN A FULL BED OF MORTAR.

ALL MORTAR SHALL BE TYPE M IN ACCORDANCE w/ ASTM SPECIFICATION C476-83 OR EQUAL. ALL GROUT SHALL BE AS FLUID AS POSSIBLE FOR PURING WITHOUT SEGRETION OF THE CONSTITUENT PARTS.

FILL AND BACKFILL TO BE COMPACTED TO 98% OF THE MAXIMUM DENSITY.

COMPACTED FILL SHALL BE FREE OF ORGANIC MATTER MAXIMUM SIZE OF ANY ROCKS

WITHIN 12" BELOW THE FLOOR SLAB SHALL BE A MAXIMUM OF 3" IN DIAMETER.

FORMWORK AND SHORING:

STRUCTURAL CONCRETE SHALL NOT BE STRIPPED UNTIL IT REACHED A MIN. OF TWO THIRDS OF THE 28 DAYS DESIGN STRENGTH. DESIGN, ERECTION AND REMOVAL OF ALL FORMWORK, SHORES AND RESHORES SHALL MEET THE REQUIREMENTS AS SET FORTH IN THE CURRENT ACI 347 AND ACI 301 SPECIFICATION.

SAFETY

THE CONTRACTOR SHALLCOMPLY WITH THE SAFETY REQUIREMENTS OF ALL LOCAL, STATE AND FEDERAL LAWS.

PROVIDE ALL SHORING REACTING AND SHEATHING AS DECUIDED FOR SAFETY AND F

PROVIDE ALL SHORING, BRACING AND SHEATHING AS REQUIRED FOR SAFETY AND FOR THE PROPER EXECUTION OF THE WORK, REMOVE WHEN WORK IS COMPLETED.

GENERAL:

DISCREPENCIES SHALL BE BROUGHT TO THE ATTENTION OF THE ARCHITECT/ENGINEER BEFORE PROCEEDING WITH THE WORK. CONTRACTOR TO VERIFY ALL DIMENSIONS AND CONDITIONS AT JOB SITE BEFORE STARTING WORK. CONTRACTOR IS RESPONSIBLE TO ADHEAR TO ALL LOCAL CODES AS WELL AS THE LATEST FLORIDA BUILDING CODE 2001 EDITION.

ALL STRUCTURAL LUMBER TO BE SOUTHERN PINE No. 2 OR BETTER. MIN. BENDING STRESS. Fb = 1,200 PSI. = SHEAR STRESS = 90 PSI. E=1500 KSI.

ALL SPECIFIED CONNECTORS CAN BE SUBSTITUTED WITH EQUAL OR BETTER WITH THE APPROVAL OF THE LANDSCAPE ARCHITECT OF RECORD.

THE USE OF A SCALE TO OBTAIN DIMENSIONS NOT SHOWN ON THE PLAN IS STRICTLY FOREBIDDEN. THE LANDSCAPE ARCHITECT WILL NOT BE RESPONIBLE FOR ERRORS RESULTING FROM SUCH ACTIONS

CONTRACTOR SHALL LOCATE ALL EXISTING UTILITIES PRIOR TO EXCAVATION/GRADING. CONTRACTOR SHALL ADHEAR TO ALL LOCAL AND STATE CODE REQUIREMENTS.

GENERAL NOTES

HORIZONTAL AND VERTICAL CONTROL SHALL BE PROVIDED BY THE OWNER'S

SURVEYOR. LAYOUT IS THE RESPONSIBILITY OF THE CONTRACTOR.

IT IS THE INTENT OF THESE DRAWINGS TO BE IN ACCORDANCE WITH APPLICABLE CODES AND AUTHORITIES HAVING JURISDICTION. ANY DISCREPANCIES BETWEEN THESE DRAWINGS AND APPLICABLE CODES SHALL BE IMMEDIATELY BROUGHT TO THE LANDSCAPE ARCHITECT

IT SHALL BE THE RESPONSIBILITY OF THE CONTRACTOR TO HAVE ALL UNDERGROUND UTILITIES LOCATED PRIOR TO THE START OF CONSTRUCTION. ALL TRENCH EXISTING UTILITIES ARE DAMAGED, IT SHALL BE THE RESPONSIBILITY OF THE


EXCAVATION SHALL PROCEED WITH EXTREME CAUTION. IN THE EVENT


THAT
CONTRACTOR TO REPAIR OR REPLACE SUCH DAMAGES.

CONTRACTOR SHALL BE RESPONSIBLE FOR RESETTING ANY DISTURBED EXISTING MANHOLES, METERS, VALVE BOXES, BLOW- OFF RISERS, ETC., TO NEW ELEVATIONS, AS

REQUIRED, WHETHER SPECIFICALLY SHOWN ON THE DRAWINGS OR NOT.

ALL STRUCTRUAL ELEMENTS SHALL MEET THE LATEST EDITION OF THE FBC

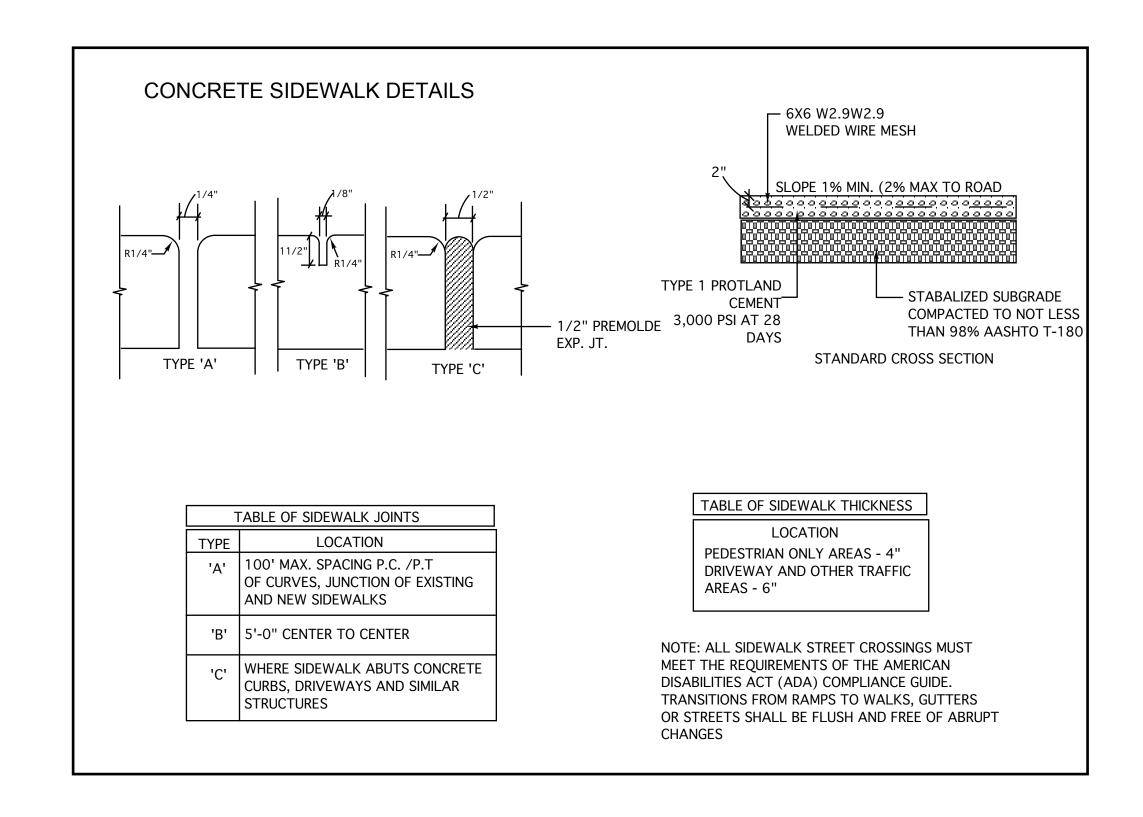

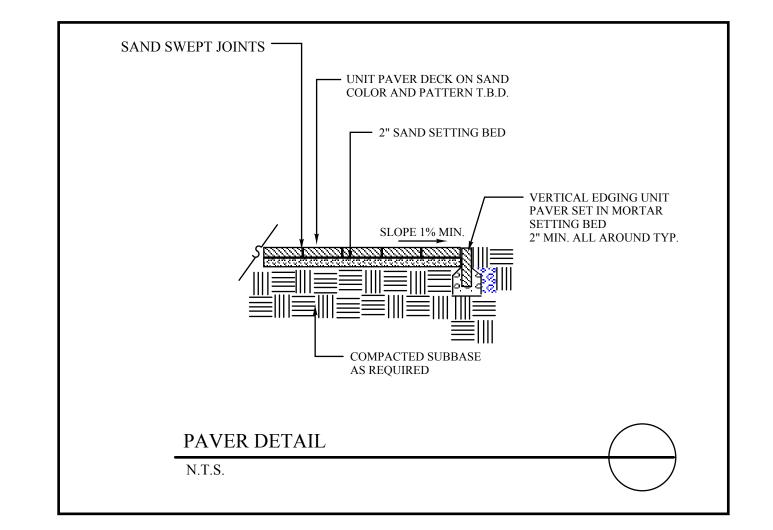



SHEET TITLE:
HARDSCAPE
DETAILS AND
SPECIFICATIONS

REVISIONS:

DELRAY MULTI FAMIL 351 NE 7TH AVE DELRAY BEACH, FL

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SHEET NO.

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