

THE NEW IRRIGATION FOR THIS SYSTEM HAS BEEN DESIGNED AND SHALL BE INSTALLED IN ACCORDANCE WITH ALL THE REQUIREMENTS OF APPENDIX F, CONSTRUCTION AND BUILDING CODES FOR TURF AND LANDSCAPE IRRIGATION SYSTEMS, OF THE FLORIDA BUILDING CODE. THE EXISTING IRRIGATION SHOWN THAT IS TO REMAIN SHALL BE MODIFIED UNDER SEPARATE CONTRACT TO COMPLY WITH THE REQUIREMENTS OF APPENDIX F.

IT IS THE CONTRACTORS RESPONSIBILITY TO MODIFY OR REPAIR THE EXISTING IRRIGATION DURING THE NEW CONSTRUCTION PERIOD TO PROVIDE FULL COVERAGE OF THE UNAFFECTED LANDSCAPE AREAS.

SITE PLAN

TH AVENUE

5


IRRIGATION PLAN


DATE: 10-12-22
PROJECT #: 2102
DRAWN BY: HP
CHECKED BY: JH
SCALE: INDICATED


REVISIONS: 5 REV 3/2/23

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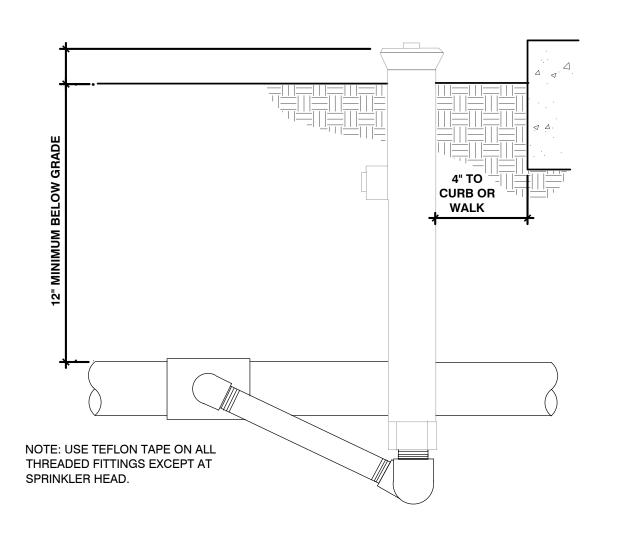
SHEET NUMBER:




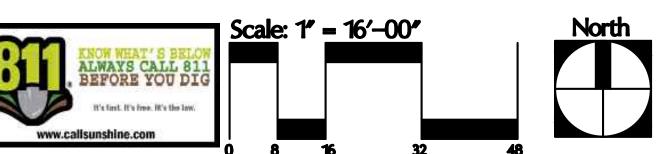

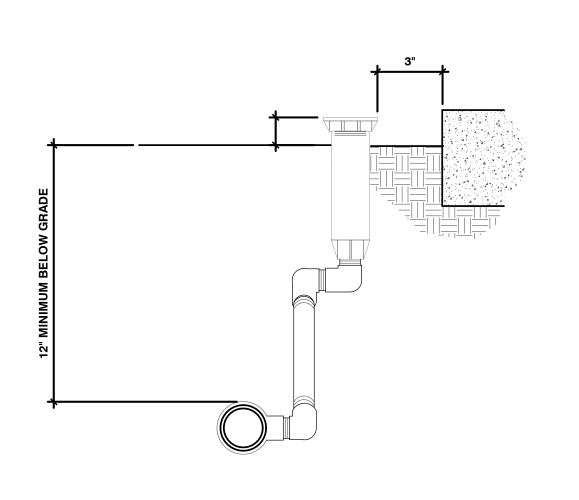

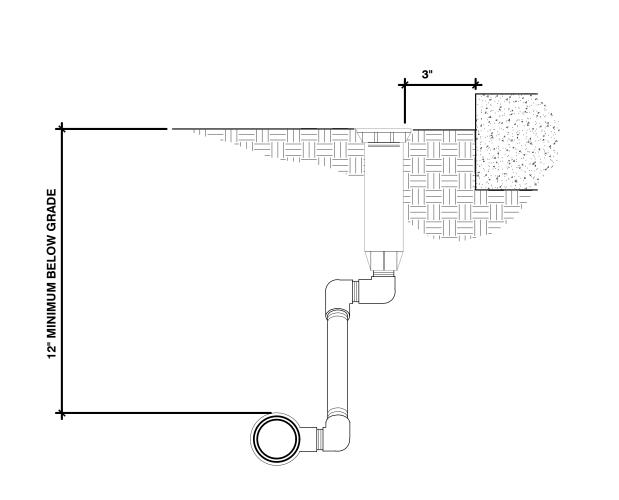Finished grade.



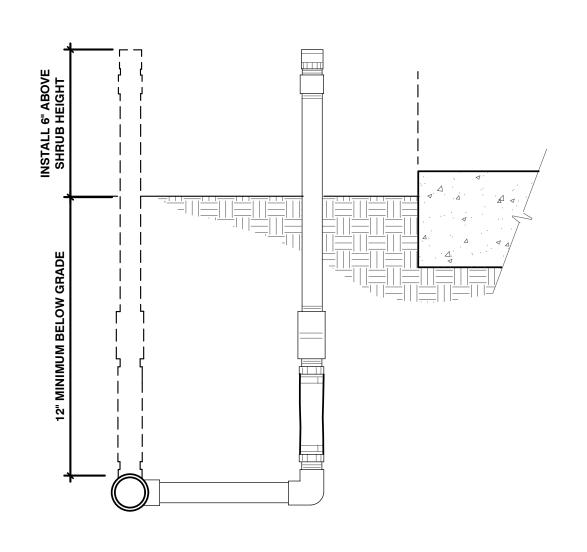

**GROUNDCOVER SPRAY 6" POPUP W/MARLEX** FX-IR-FX-HEAD-07 TURF SPRAY MARLEX ASSEMBLY

SHRUB SPRAY HIGHPOP MARLEX ASSEMBLY

SHRUB SPRAY FIXED RISER

1) PAVEMENT

(2) BASE ROCK

(3) CLEAN BACKFILL, 95% RELATIVE COMPACTION

UNDER PAVING OR PER CIVIL ENGINEER'S PLANS

(4) CONTROL WIRES, SLEEVE UNDER PAVING. INSTALL ADJACENT TO

> PRESSURIZED MAINLINE. BUNDLE SHALL BE NO

MORE THAN 50% OF PIPE

DIAMETER

FX-IR-FX-HEAD-06


Irrigation nozzle. Finished grade. Sch. 40 PVC street elbow. Sch. 80 PVC nipple. Sch. 40 PVC 90° elbow. **SECTION** Lateral line. -Sch. 40 PVC street elbow. Sch. 40 PVC 90° elbow. Sch. 80 PVC nipple. Sch. 40 PVC street elbow. **PLAN** - Sch. 80 PVC nipple.

1- All threaded connections from Sch. 40 PVC to Sch. 80 PVC shall be made using teflon tape.

2- Hunter swing joints or approved equal shall be used per approval by the Owner's Representative.

**SWING JOINT** 

URBAN TREE FOUNDATION © 2014 OPEN SOURCE FREE TO USE FX-IR-FX-AUXEQ-06

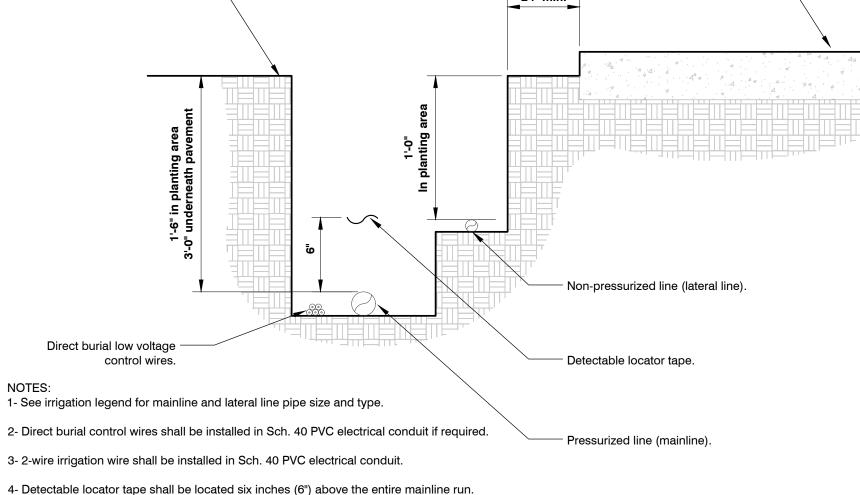

FX-IR-FX-HEAD-03

NOTES:

FX-IR-FX-HEAD-09

1. SEE IRRIGATION LEGEND FOR MAINLINE SIZE AND TYPE.

2. ALL SLEEVES SHALL BE SCH. 40 PVC PIPE.

3. ALL SLEEVES SHALL EXTEND 12" BEYOND THE EDGE OF PAVEMENT.

4. END OF SLEEVES SHALL BE LOCATED WITH A WOODEN STAKE OR PVC PIPE. LOCATORS SHALL RUN CONTINUOUSLY FROM THE END OF THE SLEEVE TO FINISHED GRADE.


(5) MAINLINE, SLEEVE UNDER PAVING TO BE TWO TIMES THE DIAMETER OF THE PRESSURIZED MAINLINE PIPE

> (6) NON-PRESSURIZED LINE, SLEEVE UNDER PAVING TO BE BE TWO TIMES THE DIAMETER OF THE LATERAL LINE

PIPE BENEATH PAVEMENT

FX-IR-FX-AUXEQ-05

45 DEG. ELBOW **PLAN VIEWS** 

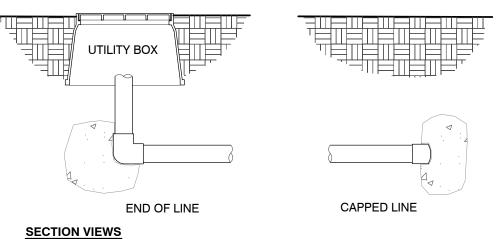

2 FINISHED GRADE

3/4" = 1'-0"

THRUST BLOCKING

1) POURED IN-PLACE CONCRETE, 120 LBS. MINIMUM, TYPICAL

FX-IR-FX-AUXEQ-11

90 DEG. ELBOW

#### **GENERAL IRRIGATION NOTES**

1. This design is diagrammatic. All piping, valves, etc., shown within paved areas or outside property lines is for design clarification only and shall be installed in landscaped areas within the property boundaries where possible. No irrigation equipment may be installed outside property lines unless otherwise directed.

IRRIGATION TRENCHING

2. This system has been designed to conform with the requirements of the applicable codes. Should any conflict exist, the requirements of the codes shall prevail.

3. All sprinkler equipment not otherwise detailed or specified shall be installed as per the manufacturer's recommendations and specifications.

from the site at the time of said rejection. Smallest pipe size shall be 1/2".

4. Pipe sizes shall conform to those shown on the drawings. No substitutions of smaller pipe sizes shall be permitted, but substitutions of the larger sizes may be approved. All damaged and rejected pipe shall be removed

5. It is the responsibility of the Irrigation Contractor to familiarize himself with all grade differences, location of walls, retaining walls, structures and utilities. The Irrigation Contractor shall repair or replace all items damaged by his work. He shall coordinate his work with other contractors for the location and installation of pipe sleeves and laterals through walls, under roadways and paving, etc. The Irrigation Contractor shall also familiarize himself with the

landscape plan and coordinate the installation with the Landscape Contractor. 6. Do not willfully install the sprinkler system as shown on the drawings when it is obvious in the field that unknown obstructions, grade differences or differences in the area dimensions exist that might not have been considered in the engineering. Such obstructions or differences should be brought to the attention of the owner's authorized representative. In the event this notification is not performed, the Irrigation Contractor shall assume full responsibility for any changes necessary.

7. The Irrigation Contractor shall flush and adjust all sprinkler heads and valves for optimum coverage with no overspray on to walks, streets, walls, etc. To eliminate overspray, low angle and variable arc nozzles may be substituted for standard spray nozzles.

8. All pipe and wire installed beneath paving shall be sleeved in Schedule 40 PVC pipe.

FX-IR-FX-AUXEQ-08

9. All threaded PVC joints shall be made using Schedule 80 PVC nipple stubs and solvent weld couplings. No threaded adapters will be allowed. All other PVC joints shall be of the same type as the specified pipe, i.e., 'O' ring or solvent weld.

10. All above ground piping shall be schedule 40PVC, unless other wise specified.

11. All sprinkler heads with flow rates of 7 GPM or less shall be mounted on flex type swing joints. Flex type pipe shall be used for swing joints only and not lateral lines. All sprinkler heads with flow rates greater than 7 GPM shall be mounted on PVC swing joints of the same size as the sprinkler head inlet.

12. All sprinkler heads shown as solid symbols may be mounted on schedule 40 PVC risers. Unless otherwise specified shrub type heads may be substituted for 4" (or less) pop-up heads. Riser height to be determined by plant material. Riser extenders may be used on pop-up heads. All shrub risers shall be Schedule 40 PVC and painted flat or satin black. Risers shall be supported with rebar or angle iron secured by stainless steel clamps. All sprinkler heads shown on risers adjacent to public thoroughfares shall be installed 12" (min) from edge of pavement.

13. This system has been designed to provide a 100% coverage with 100% overlap. All water used for irrigation shall be rust free. If a chemical injection system is used in a well water system, the well shall be protected in accordance with Florida state law.

14. Proposed improvements shall be integrated with existing central system. Adjust type and brand of remote control valves as required to work with existing system. It is the contractor's responsibility to coordinate with the Client's Superintendent to provide operable improvements that work with the existing system.

**5TH IRRIGATION** DETAILS

SITE PLAN


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DATE: 10-12-22 PROJECT #: 2102 DRAWN BY: HP

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REVISIONS: 3/2/23 5 REV

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1 REMOTE CONTROL VALVE AS SPECIFIED, ONE PER BOX.

(2) 10X15 RECTANGULAR VALVE BOX.

3 PLASTIC I.D. TAG AT EACH VALVE.

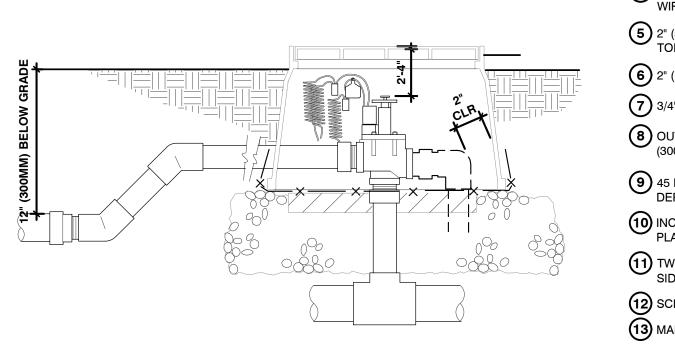WATER PROOF WIRE CONNECTORS ON 30" LOOPED WIRES.

5 2" (50MM) MINIMUM, 4" (100MM) MAXIMUM BELOW TOP OF BOX.

6 2" (100MM) ABOVE FINISH GRADE AT SHRUBS.

(7) 3/4" (19MM) ABOVE FINISH GRADE AT LAWN.

8 OUTLET PIPE SAME SIZE AS VALVE, 24" MINIMUM (300MM) TO FIRST FITTING.

9 45 DEGREE DOWN AS REQUIRED TO LATERAL PIPE DEPTH. 10 INCREASE LATERAL LINE SIZE AS PER IRRIGATION PLAN.


TWO 6X2X16 CONCRETE BLOCK CAPS, ONE EACH SIDE OF THE BOX.

(12) SCHEDULE 80 RISER.

(13) MAIN LINE AS OCCURS.

(150MM) THICK LAYER OF PEA GRAVEL BASE.

NOTES:

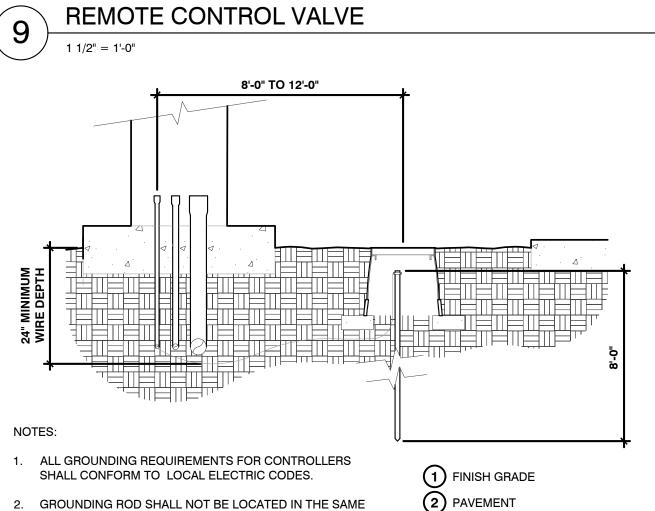

TRENCH AS IRRIGATION MAINLINES OR LATERAL LINES.

3. VALVE BOX SHALL BE WRAPPED WITH A MINIMUM 3 MIL THICK PLASTIC AND SECURED TO THE VALVE BOX USING DUCT TAPE OR ELECTRICAL TAPE.

4. INSTALL GROUNDING ROD PER THE CONTROLLER MANUFACTURER'S SPECIFICATIONS AND RECOMMENDATIONS.

**GROUNDING ROD** 

(3) THREE (3) 4" x 8" BRICKS 5/8" x 8'-0" COPPER GROUNDING ROD

(5) GROUNDING ROD CLAMP 6 #6 AWG BARE COPPER WIRE

7) 1/2" PVC ELECTRICAL CONDUIT AND SWEEP FOR EARTH GROUND

FX-IR-FX-AUXEQ-01

BALL VALVE 3" AND SMALLER

1- LOCATE VALVE BOXES IN PLANTING AREAS.

2- WRAP VALVE BOX WITH A MINIMUM OF 3 MIL THICK PLASTIC AND SECURE IT USING DUCT TAPE OR ELECTRICAL TAPE.

3- ALL THREADED CONNECTION TO BE MADE USING TEFLON TAPE.

4- ALL CHANGES IN ELEVATION SHALL BE MADE USING SCH. 40 PVC 45° ELBOWS.

FX-IR-FX-RCV-01

FX-IR-FX-SHUT-01

J BOX

VALVE BOX LID, HEAD BRAND "J BOX" ON LID WITH 2" HIGH LETTERS

2 10" X 15" BOX

LOOP, BUNDLE, AND LABEL SPARE WIRES THAT ARE TO CONTINUE, AS OCCURS

1/2" WIRE CLOTH GOPHER PROTECTION SCREEN, WRAP 6" UP SIDES

TWO 6" X 2" X 16" CONCRETE BLOCK CPAS, ONE ON EACH SIDE OF BOX

6 SET BOX FLUSH TO GRADE AT LAWN

(7) SET BOX 2" ABOVE GRADE AT SHRUBS 8 SPARE WIRES THAT ARE TO TERMINATE AT THIS BOX: COIL 30" LENGTH AND I.D. TAG

(9) WIRES TO CONTROLLER 10 MAINLINE AS OCCURS

WIRE BUNDLE JUNCTION BOX

FX-IR-FX-AUXEQ-16

SITE PLAN

AVENUE 5TH

**IRRIGATION** 

DATE: 10-12-22 PROJECT #: 2102

DETAILS

CHECKED BY: JH

DRAWN BY: HP

REVISIONS: 3/2/23 5 REV

SHEET NUMBER: LAIR-3



EX SD EX SD EX SD EX SD OAS	EX SD	3x3	GAS OF THE PROPERTY OF THE PRO	Tree # Palm # 15 16 Relocation Tree # Palm # Removal Tree # 6
OFF. S.				12 13 14 14 2 3 4 5 10 11
04		SD —		Palm # 7
22 (104		SD S		
PERVIOUS CONC (TO REMAIN)  EX. CONC				
20 (104 × )	# # # # # # # # # # # # # # # # # # # #	#2 #2 #2		
EX. CONC HEADER CURB (TO REMAIN) (TYP).		SD SD		

#### **Tree Disposition and Mitigation**

	Project Address:		Parcel ID (f	or multiple ID:	s, use one for	the common area):	area):			
- Preserve										
Tree #	Common Name	Scientific Name	Height	Spread	DBH	Condition Rating	Comments			
Palm #	Common Name	Scientific Name	Height	Spread	Clear Trunk	<b>Condition Rating</b>	Comments			
15	Solitaire Palm	Ptychosperma elegans	16	8	10	60%				
16	Solitaire Palm	Ptychosperma elegans	16	8	10	60%				
Relocation	า									
Tree #	Common Name	Scientific Name	Height	Spread	DBH	Condition Rating	Comments			
Palm #	Common Name	Scientific Name	Height	Spread	Clear Trunk	Condition Rating	Comments			
Removal										
Tree #	Common Name	Scientific Name	Height	Spread	DBH	Condition Rating < 50%	Comments			
6	Live Oak	Quercus virginiana	30	20	12	45%	Growing abut fence, under powerline, and near asphalt parking lot. Leaning, vine intrusion, asymmetrical canopy			
8	Gumbo Limbo	Bursera simaruba	20	10	8	40%	Growing abut fence, under powerlint, moderate trunk damage, vine intrusion			
9	Black Olive	Terminalia buceras	30	25	16	30%	Growing through fence near parking lot, under powerline, leaning, asymmetrical canopy, vine intrusion, severe canopy reduction			
12	Yellow Tabebuia	Tababuia aurea	12	10	6	40%	Severe trunk and branch damage and canopy reduction, dead and dying limbs, severe insect intrusion, sparse foliage			
13	Mahogany	Swietenia mahogani	30	70	29	45%	Growing abut fence, near parking lot and building. Severe main branch damage and decay, vine intrusion, dead / dying secondary branches			
14	Weeping Fig	Ficus benjamina	15	15	12	30%	Growing near and on building, severe overall canopy reduction and sparse foliage, decay present			
						Condition Rating ≥ 50%				
1	Mango	Mangifera indica	15	20	11	75%	Codominant, included bark, growing abut fence, close to building, under powerline			
2	Mahogany	Swietenia mahogani	25	16	12	60%	Growing about fence, close to building, under powerline, sparse canopy, overall crown reduction			
3	Mahogany	Swietenia mahogani	20	20	10	70%	Growing about fence, close to building, under powerline, sparse canopy, overall crown reduction			
4	Live Oak	Quercus virginiana	30	50	25	75%	Minor branch damage			
5	Mango	Mangifera indica	8	15	4	60%	Growing abut fence, under powerline, shaded and competing for space, dead and discolored foliage			
10	Yellow Tabebuia	Tababuia aurea	10	15	5	50%	Growing abut fence near parking lot, umbrella tree intrusion, shaded, discolored foliage, severe canopy reduction			
11	Yellow Tabebuia	Tababuia aurea	12	15	9	60%	Growing abut fence near parking lot, codominant, poor overall growth structure			
			Tre	es with Condition	on Rating < 50%	to be Removed:	<u>6 Trees</u>			

76 DBH / 7 Trees

Comments

1 Palm

	New Trees	Caliper (CAL)	Calipers Provided
	16 Oak Trees	16 X 5 inch CAL	80
	6 Japanese Blueberry	2 x 4 inch CAL (3 per tree)	8
·	•	ondition Rating ≥ 50%): at for Tree-for-Tree basis:	60" CAL (12 QV 6 (2 trees(= 6 ED) + 4 QV
·			
·	Replacemen	t for Tree-for-Tree basis:	6 (2 trees(= 6 ED) + 4 QV


Tree #	<b>Common Name</b>	Cost to Replace	Replace 1:1	Replace CAL "	Pay Fee
6	Live Oak	450x8 + 650x4 = 6200 x 50%=3100	х		
8	Gumbo Limbo	450x8 = 3600 x 50%=1800	х		
9	Black Olive	450x8 + 650x4 + 850x4= 9600 x 50% = 4800	х		
12	Yellow Tabebuia	450x6 = 2700 x 50%=1350	х		
13	Mahogany	450x8 + 650x4 + 850x6 + 11x1000 = 22300 x 50%=11150	х		
14	Weeping Fig	450x8 + 650x4 = 6200 x 50%=3100	Х		
1	Mango	450x8 + 650x3 = 5550		11"	
2	Mahogany	450x8 + 650x4 = 6200			\$6,200.00
3	Mahogany	450x8 + 650x2 =4900		10"	
4	Live Oak	450x8 + 650x4 + 850x6 + 7x1000 = 18300		25"	
5	Mango	450x4 =1800			\$1,800.00
10	Yellow Tabebuia	450x5 = 2250		5"	
11	Yellow Tabebuia	450x8 + 650x1 = 4250		9"	
		Total Replacement Trees:	6		
		Total Replacement Trees:		60"	
		Total Fee to Pay:			\$8,000.00

Total DBHs of Trees with Condition Rating ≥ 50% to be Removed:

Total Numbers of Palms with Condition Rating < 50% to be Removed:

Total Heights of Palms with Condition Rating ≥ 50% to be Removed:

ANY TREES NOT MITIGATED FOR BY REPLACEMENT TREES OR CALIPER INCHES WILL BE OFFSET BY A DEPOSIT INTO THE TREE FUND.

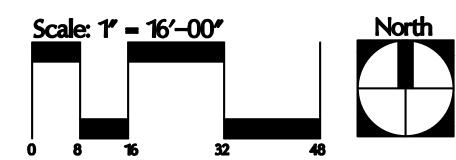

EPARED BY:

ECOLOGICAL / BN/ROWB/TAL LAND FLANNIC
LAND USE ANALYSS LANDSCAFE ARCHITECTURE
310 SOUTHEAST 18TH STREET
FT. LAUDRODALE, FLORDA 33316
954524372 www.ecoplan-inc.com

SITE PLAN

8 SE 51H AVENUE

TREE DISPOSITION PLAN

DATE: 09/29/2021
PROJECT #: 2102
DRAWN BY: HT
CHECKED BY: JH
SCALE: INDICATED

/ISIONS:
REV 4/1/22
REV 7/1/22
REV 8/30/22
REV 10/12/22
REV 3/2/23

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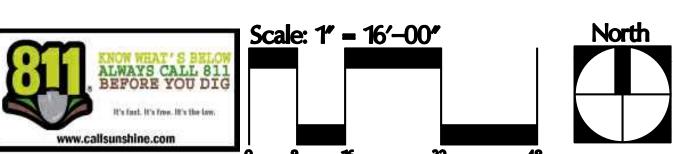


PLANT SCHEI	DULE G	ROUN	ND FLOOR					
TREES	CODE	QTY	BOTANICAL NAME	COMMON NAME	CONTAINER	SIZE	CALIPER	
	ED	7	Elaeocarpus decipiens	Japanese Blueberry Tree	FG/B&B	16` HT x 7` SPR, 8` CT	4" CAL, STANDARD	
•	EPE	2	Existing Tree	Existing Tree- Alexander Palm				
*	QH2	16	Quercus virginiana `QVTIA`	Highrise Live Oak	FG, Relocated	18` HT x 9` SPR, 8`CT	5"	
PALM TREES	CODE	<u>QTY</u>	BOTANICAL NAME	COMMON NAME	CONTAINER	SIZE	CALIPER	
	PE	30	Ptychosperma elegans	Alexander Palm	FG/B&B	25`-30` OA, Single Trunk		
Wall of the state	PE3	5	Ptychosperma elegans	Alexander Palm	FG/B&B	25`-30` OA, TRIPLE		
SHRUB AREAS	CODE	<u>QTY</u>	BOTANICAL NAME	COMMON NAME	CONTAINER	<u>SIZE</u>	<u>SPACING</u>	SPACING
	DE	108	Duranta erecta `Gold Mound`	Gold Mound Duranta		24" HT x 24" SPR	24" O.C.	24" o.c.
	FM	847	Ficus microcarpa `Green Island`	Green Island Ficus		18" X 18"	18" O.C.	18" o.c.
	PM2	43	Podocarpus macrophyllus	Yew Pine		60" HT. x 24" W	24" O.C.	24" o.c.
	SL	213	Schefflera arboricola	Green Schefflera		24" X 24"	24" O.C.	24" o.c.
	SL2	70	Schefflera arboricola `trinette`	Variegated Schefflera		24" HT x 24" SPR	30" O.C.	30" o.c.
GROUND COVERS	CODE	QTY	BOTANICAL NAME	COMMON NAME	CONTAINER	SIZE		SPACING
	DT	591	Dianella tasmanica	Blueberry Flax Lily	16" HT, 16" SPR	16"H X 16"W		16" o.c.
	LM	434	Liriope muscari `Emerald Goddess`	`Emerald Goddess` Lily Turf	1 Gal.	12"x12"		18" o.c.

NOTE: Pursuant to Sec. 4.6.16(E)(7) Shrubs and hedges, hedges must be allowed to attain height of 36 inches except where providing adequate and safe sight distance requires them to be maintained at a 30-inch height.

<u>LEGEND</u>
STREET TREE
MITIGATION TREE
STREET TREE AND MITIGATION TREE
CIVIC SPACE AND MITIGATION TREE
INTERIOR TREE

	Required	Provided
	4,308.5 sq.ft. of parking & accessways areas	431 sq.ft.
	X 10% =431 sq.ft.	431/125 = 4 (3.44)
		# (numbers) & List of Trees/Palms:
erior Landscaping		6 Japanese Blueberry, 2 Alexander Palms
		# (numbers) & List of shrubs/ground covers:
		63 Green Island Ficus, 130 Liriope, 9 Schefflera
		4321.f. / 30
		15 Trees/Palms Required:
eet Trees	432 linear feet (l.f.)	10 Live Oak, 15 Alexander Palms
		# (numbers) & List of shrubs/ground covers:
		798 Green Island Ficus, 99 Green Schefflera, 445
		Golden Dewdrop, 114 Liriope, 66 Flax Lily
	1 she do troo non 20 lf novins star	117 If / 20 = 6 trees required
ric Open Space	1 shade tree per 20 lf perimeter 116.8 lf (852 sf, 30'x28.4')	6 Live Oak trees provided
ndscape Barrier	All Parking Under Building	
undation Landscaping	CBD - 4.4.13E	55 Green Schefflera
ndscape Buffer	N/A	



SITE PLAN


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CODE COMPLIANCE TREE PLAN


DATE: 09/29/2021 PROJECT #: 2102 DRAWN BY: HT CHECKED BY: JH
SCALE: INDICATED


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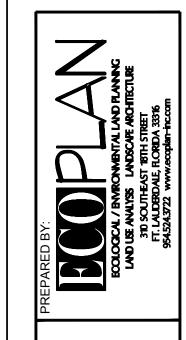
SHEET NUMBER:



- LIGHT POLE

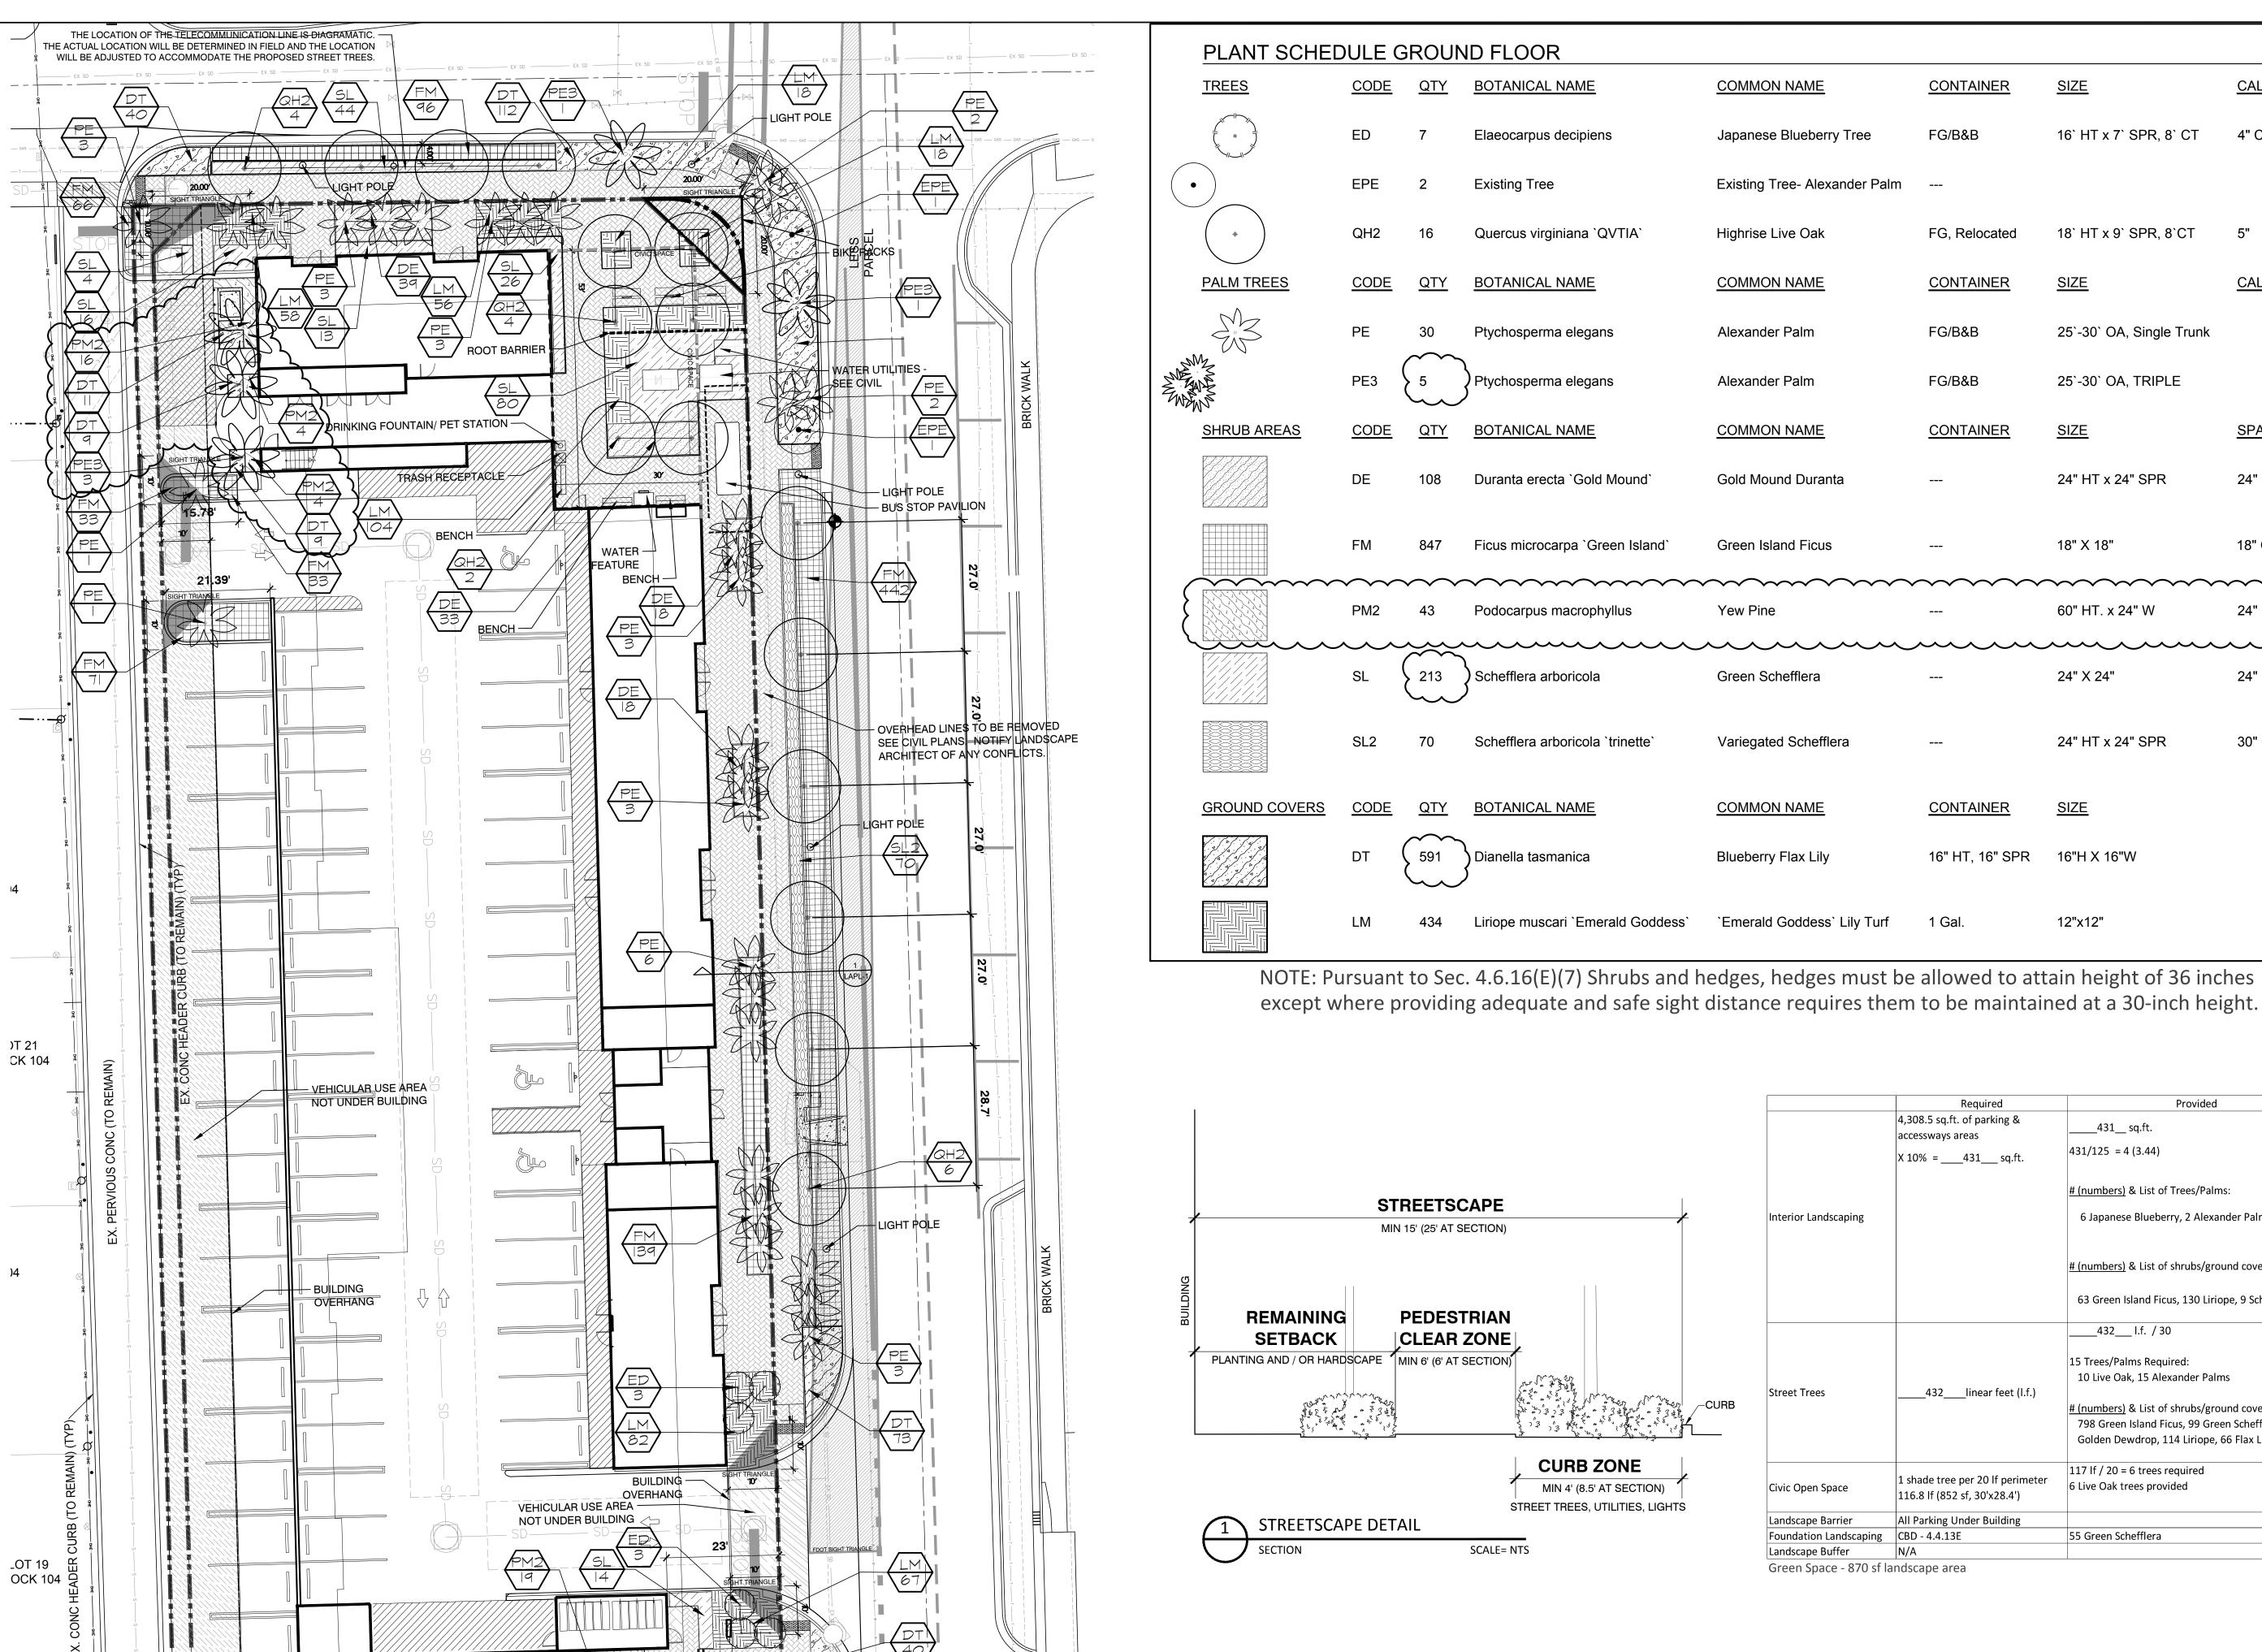

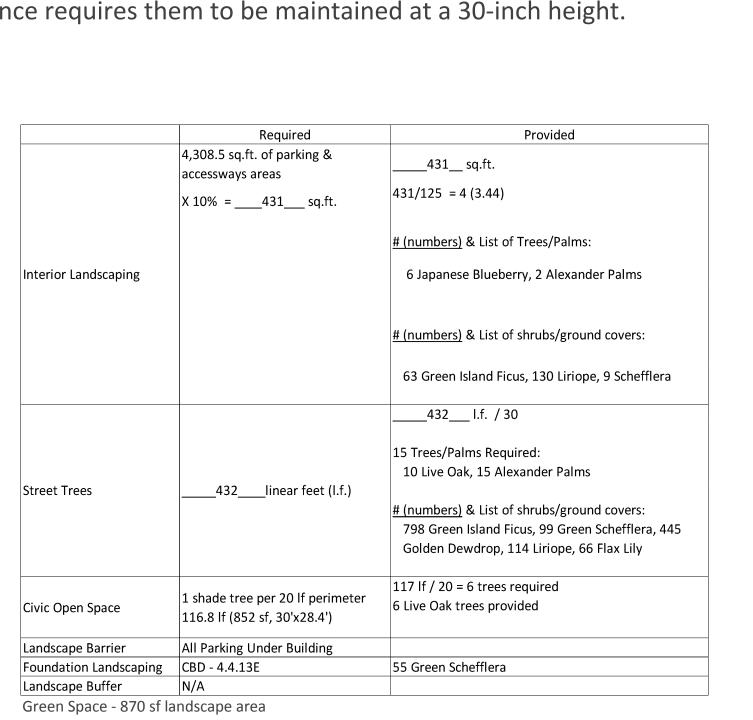

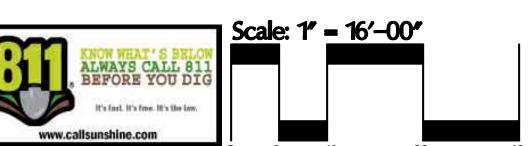

<u>CALIPER</u>

**CALIPER** 

**SPACING** 

24" O.C.

18" O.C.

24" O.C.

24" O.C.

30" O.C.

<u>SPACING</u>

24" o.c.

18" o.c.

24" o.c.

24" o.c.

30" o.c.

**SPACING** 

16" o.c.

18" o.c.

4" CAL, STANDARD

SITE PLAN

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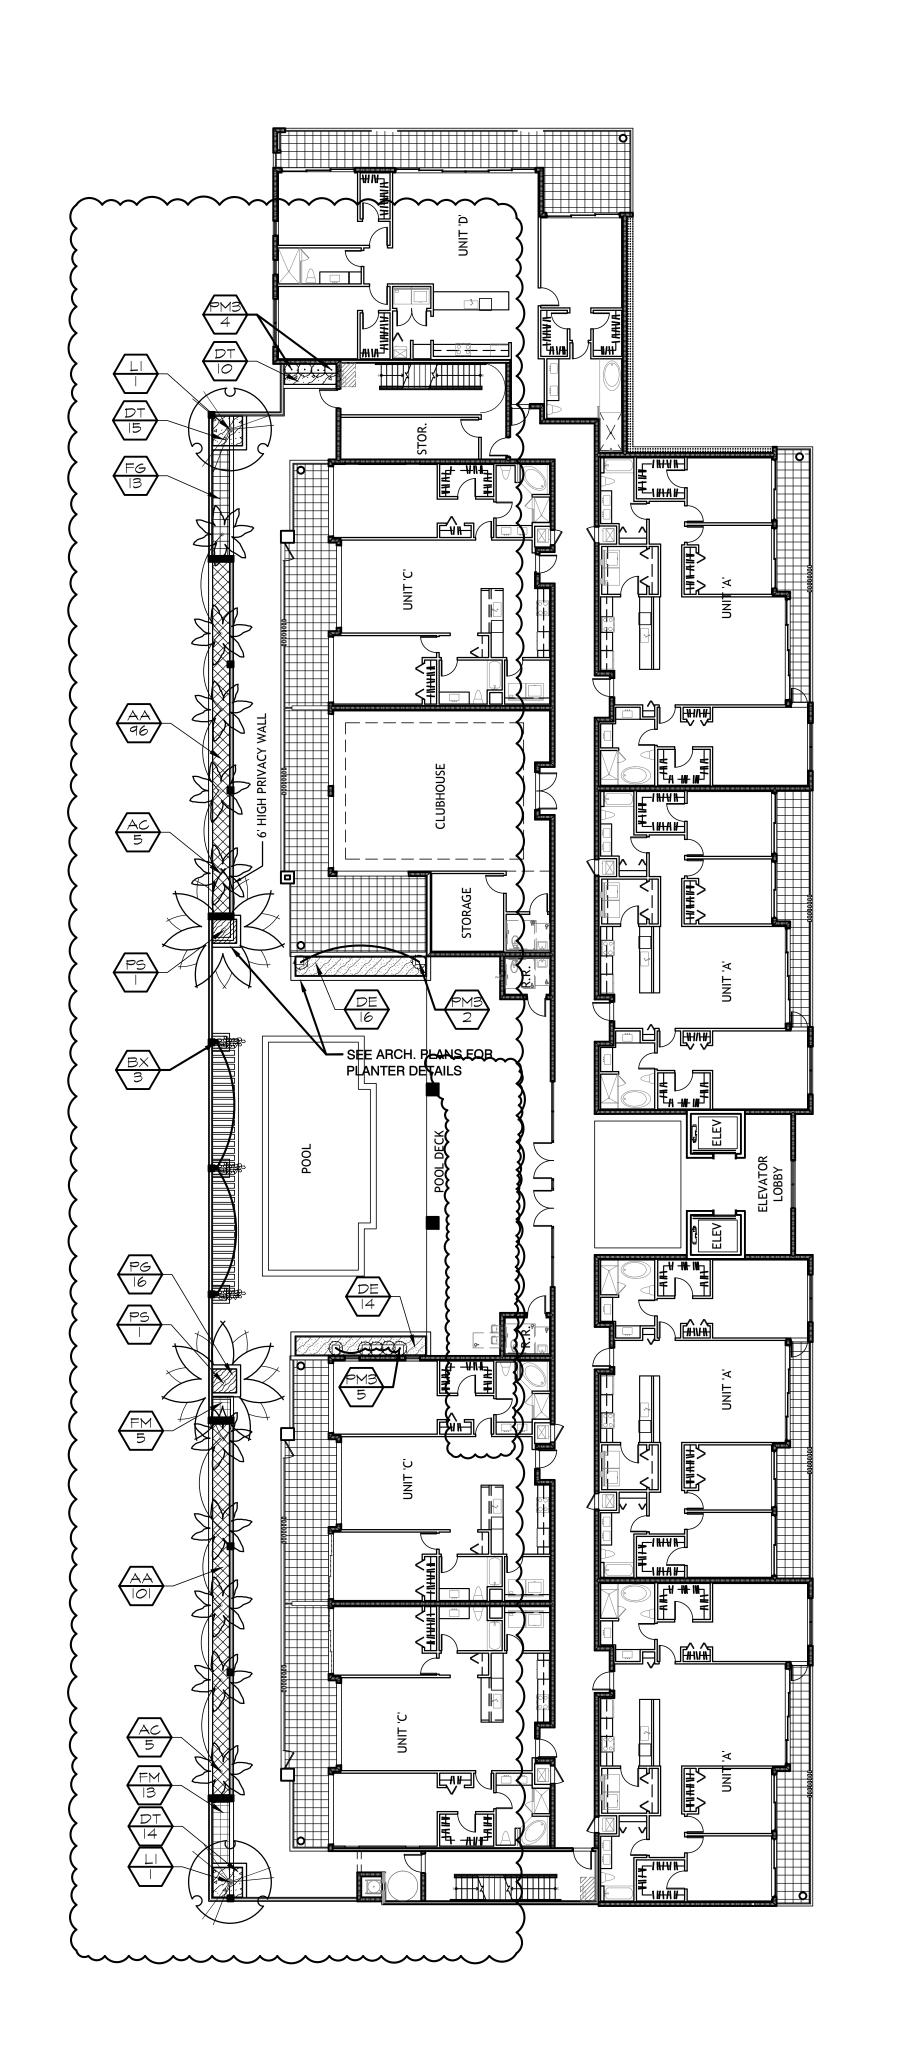
**PLANTING** PLAN


DATE: 09/29/2021 PROJECT #: 2102 DRAWN BY: HT CHECKED BY: JH SCALE: INDICATED

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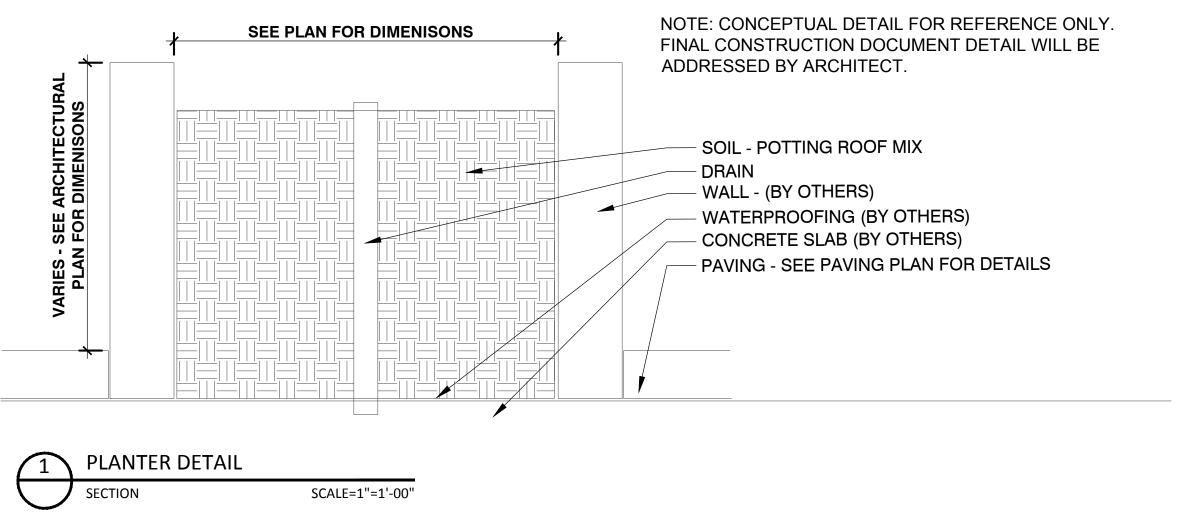
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**North** 






DECK AREA - 5,007 SF LANDSCAPE REQUIRED - 10% OF 5,007 SF = 501 SF LANDSCAPE AREA PROVIDED - 567 SF

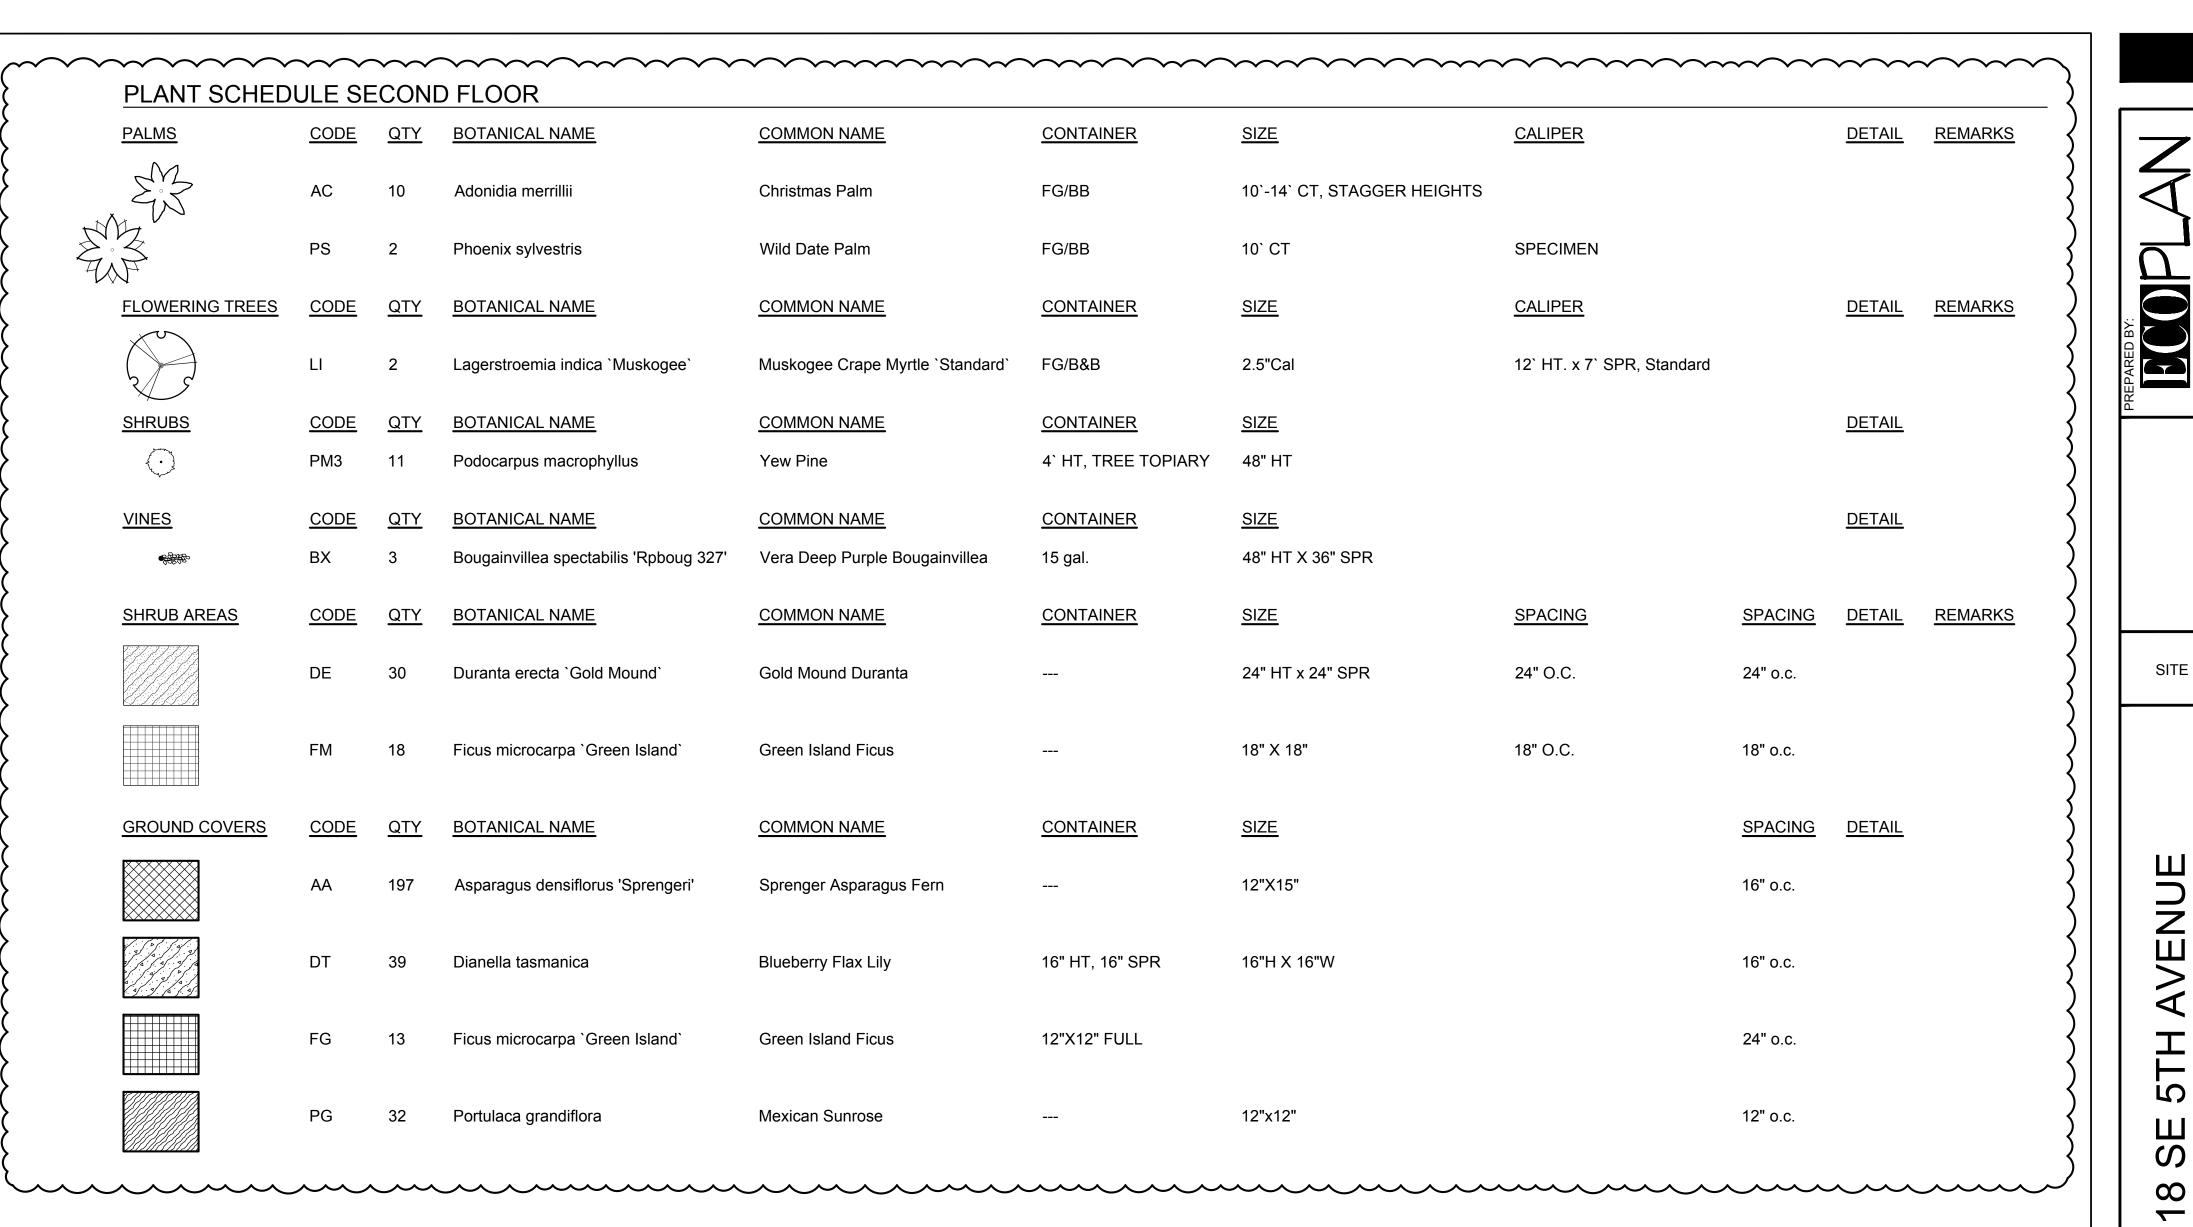



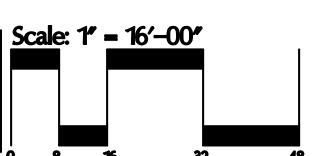



VEN

SITE PLAN

PLANTING PLAN 2ND FLOOR

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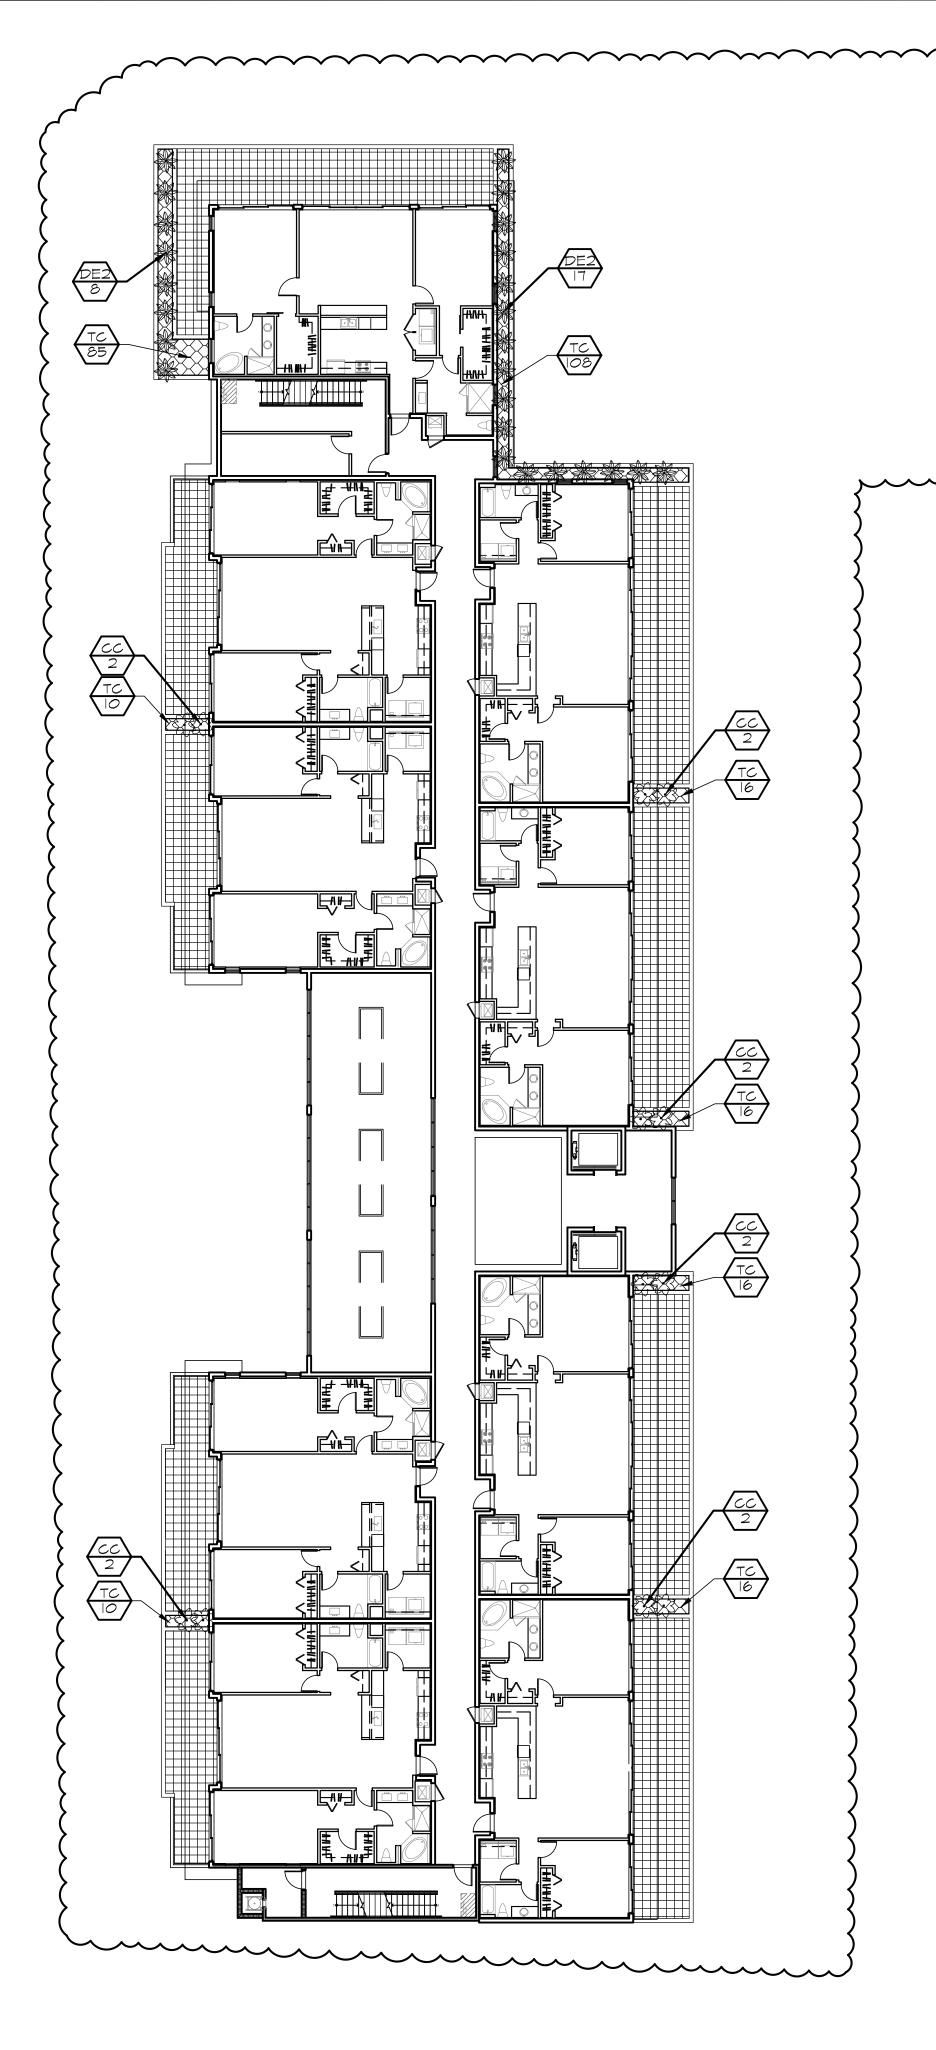
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DATE: 07/21/2022 PROJECT #: 2102 DRAWN BY: HT CHECKED BY: JH SCALE: INDICATED

REVISIONS: 3 REV 8/30/22

5 REV

SHEET NUMBER: LAPL-2



#### PLANT SCHEDULE 4TH FLOOR

RUBS	CODE	QTY	BOTANICAL NAME	COMMON NAME	CONTAINER	SIZE	
£3	CC	12	Chamaedorea cataractarum	Cascade Palm		48" HT X 36" SPR	
	DE2	25	Dioon edule	Mexican Cycad		36" HT x 30" SPR	
OUND COVERS	CODE	<u>QTY</u>	BOTANICAL NAME	COMMON NAME	CONTAINER	SIZE	SPACING
	TC	277	Trachelospermum jasminoides 'Confederate'	Confederate Jasmine		12"X15"	15" o.c.

PREPARED BY:

FOCIOCICAL / BANRONWBATAL LAND FLANN
LAND USE ANALYSS LANDSCAPE ARCHIBCTUR
310 SOUTHEAST 18TH STREET
FIT. LANDSROALE, FLORIDA 33316
954.524.3722 www.ecoplan-inc.com

SITE PLAN

8 SE 5TH AVENUE

3

PLANTING PLAN 4TH FLOOR

DATE: 07/21/2022
PROJECT #: 2102
DRAWN BY: HT
CHECKED BY: JH
SCALE: INDICATED

 REVISIONS:

 3 REV
 8/30/22


 4 REV
 10/12/22


 5 REV
 3/2/23

EAL:

SHEET MUMBER: LAPL-3



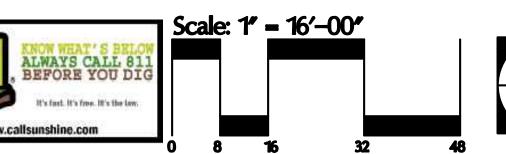

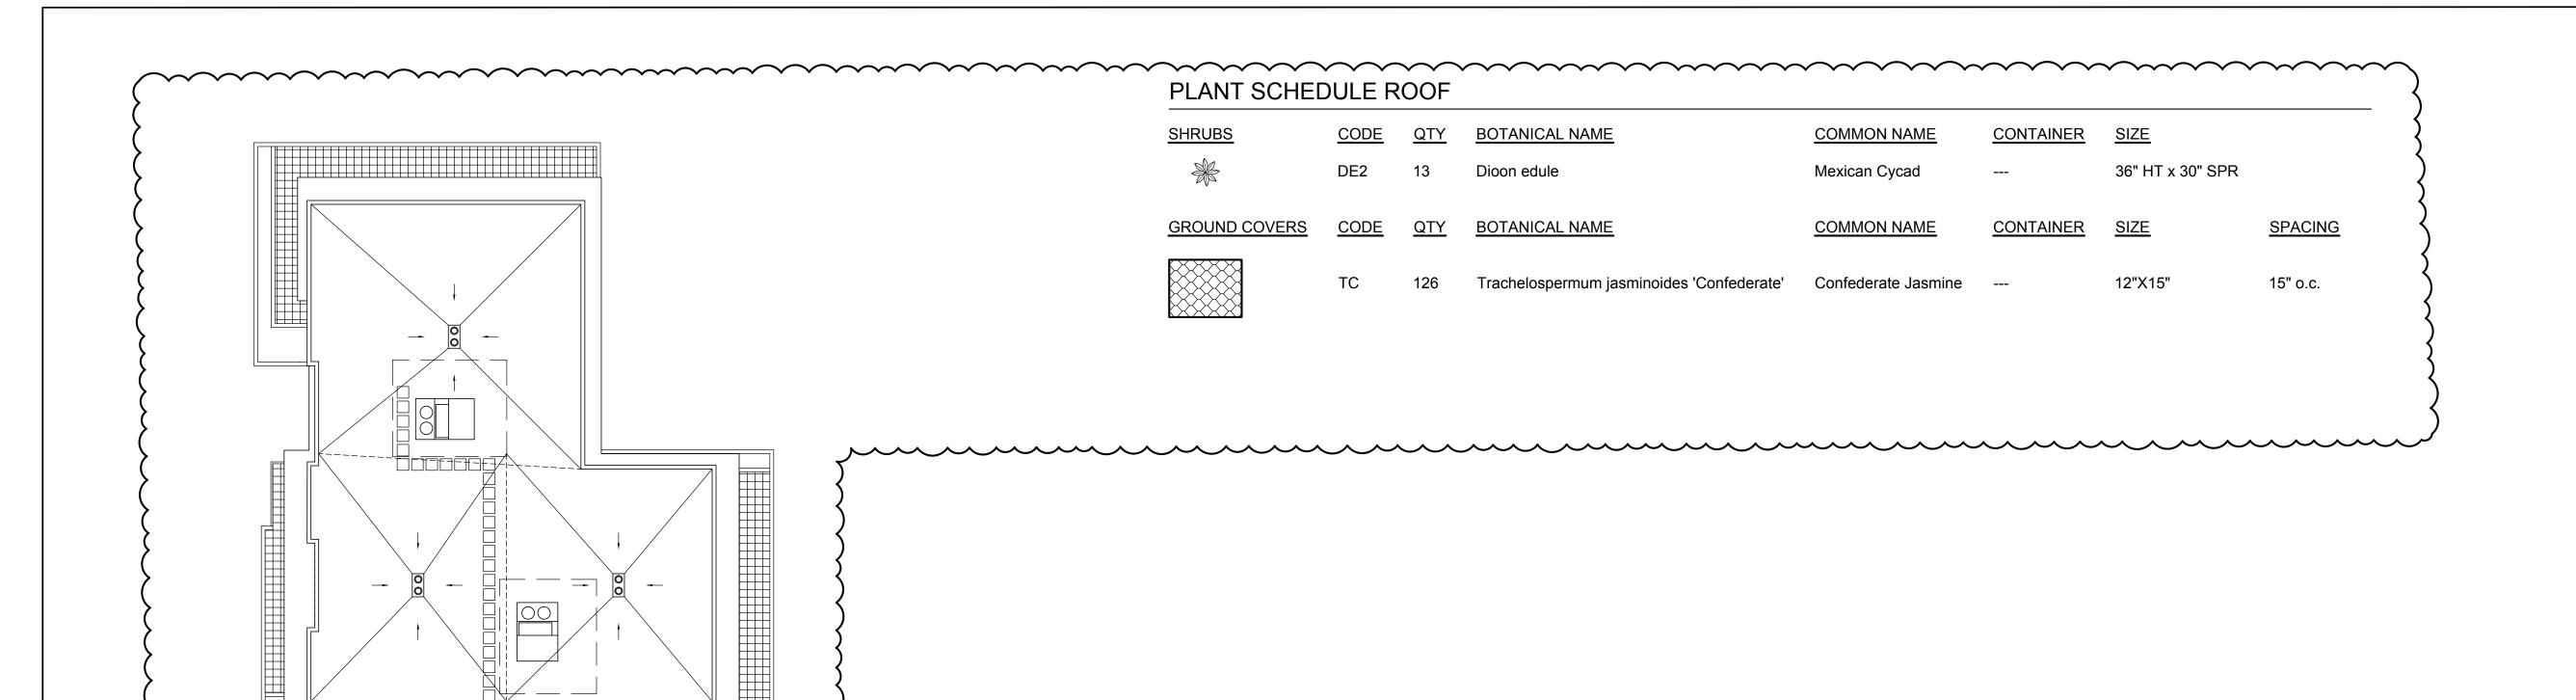

ECOLOGICAL / BIVIRGI
LAND LIER ANALYSS 1

SITE PLAN

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3


PLANTING PLAN ROOF LEVEL

DATE: 07/21/2022 PROJECT #: 2102 DRAWN BY: HT CHECKED BY: JH SCALE: INDICATED


REVISIONS: 3 REV 8/30/22 5 REV


SHEET NUMBER LAPL-4

North

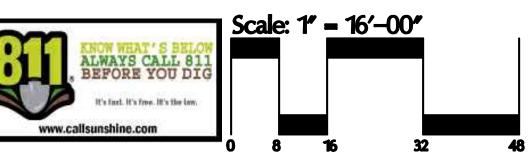




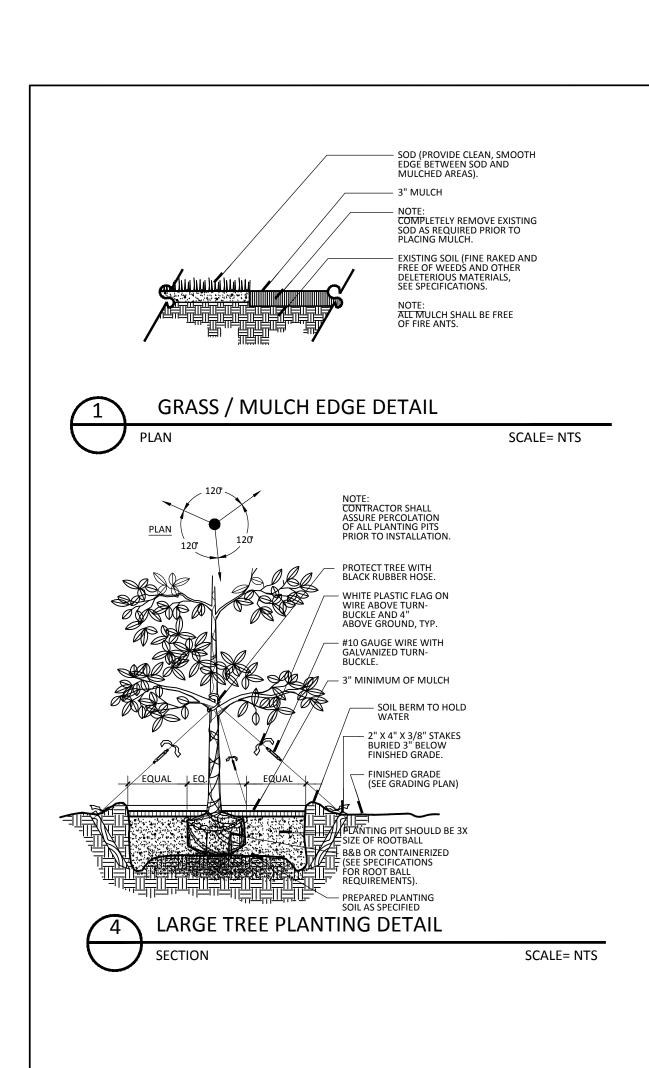

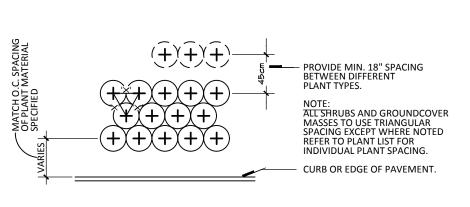

5 SHRUB AND GROUNDCOVER LAYOUT

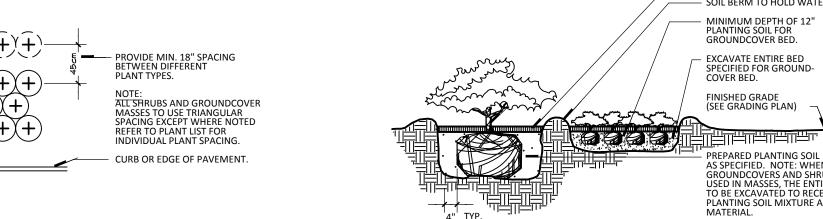

SCALE= NTS

SCALE= NTS

.. FINAL TREE STAKING DETAILS

PITS PRIOR TO INSTALLATION.

ROTECT TREE TRUNK WITH

#10 GAUGE WIRE (GUY TO STRONGEST TRUNK AT CENTER)

HREE-2" X 4" X 6'-6" STAKES

BLACK RUBBER HOSE

DO NOT PENETRATE ROOT BALL.

3" MINIMUM OF MULCH

B&B OR CONTAINERIZE SPECIFICATIONS FOR

SIZE OF ROOTBALL


ROOT BALL REQUIREMENT


PREPARED PLANTING SOIL AS SPECIFIED


PLANTING PIT SHOULD BE 3X

- SOIL BERM TO HOLD WATER

AND PLACEMENT TO BE APPROVED BY THE OWNER

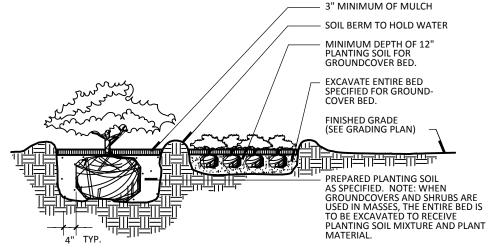

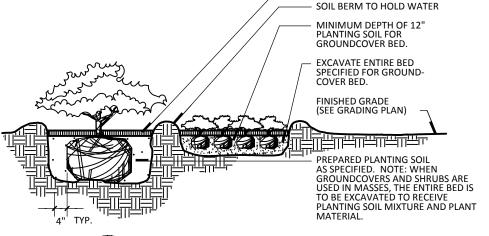

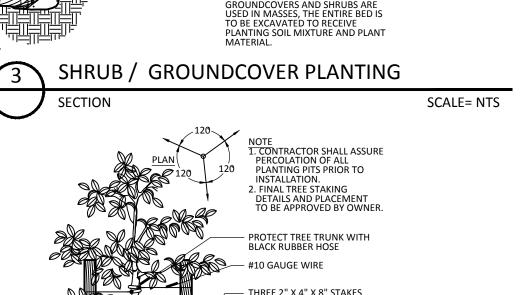

SPACE EVENLY AROUND TRE

PENETRATE ROOT BALL.

— 3" MINIMUM OF MULCH

(SEE GRADING PLAN)


**B&B OR CONTAINERIZE** 

(SEE SPECIFICATIONS FOR ROOT BALL REQUIREMENTS)

- PREPARED PLANTING SOIL

SMALL TREE PLANTING DETAIL

SOIL BERM TO HOLD WATER

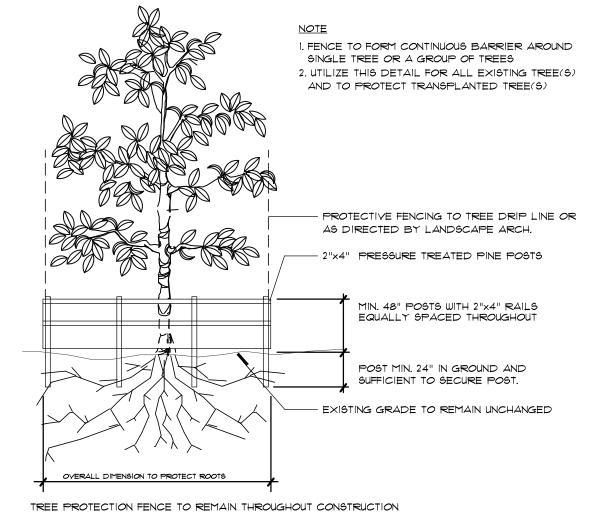

CITY OF DELRAY BEACH REQUIRED NOTES:

- ALL PROHIBITED PLANT SPECIES SHALL BE ERADICATED FROM THE SITE

- MULCH SHALL BE APPLIED TO A MINIMUM DEPTH OF THREE (3) INCHES IN ALL PLANTING BEDS

- ALL LANDSCAPE AREAS SHALL BE PROVIDED WITH AN IRRIGATION SYSTEM, AUTOMATICALLY OPERATED, TO PROVIDE COMPLETE COVERAGE TO ALL PLANT


- REINFORCED CONCRETE CURBING AT LEAST SIX (6) INCHES IN HEIGHT SHALL BE PROVIDED AROUND ALL LANDSCAPE ISLANDS AND AS A SEPARATOR BETWEEN ALL

- SOD AND IRRIGATION SHALL BE PROVIDED WITHIN THE UNPAVED PORTION OF THE RIGHT-OF-WAY ADJACENT TO THE PROPERTY LINE

LANDSCAPED AREAS THAT ARE ADJACENT TO VEHICULAR USE AREAS UNLESS SUCH CURBING WILL INTERFERE WITH THE DRAINAGE

- ALL PLANT MATERIAL SHALL BE FLORIDA #1 GRADE OR BETTER

MATERIALS AND GRASS TO BE MAINTAINED

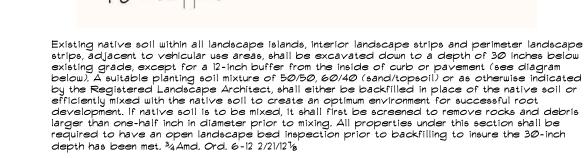

-BACK OF CURB (TYP)


EXCAVATION AREA (30" DEPTH)


- COMPACTED SOIL (12" WIDE)




LANDSCAPE STRIP SOIL BACKFILL SCALE= NTS

TREE PROTECTION FENCE SCALE= NTS

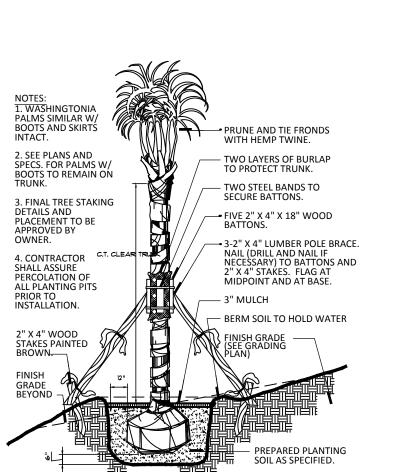

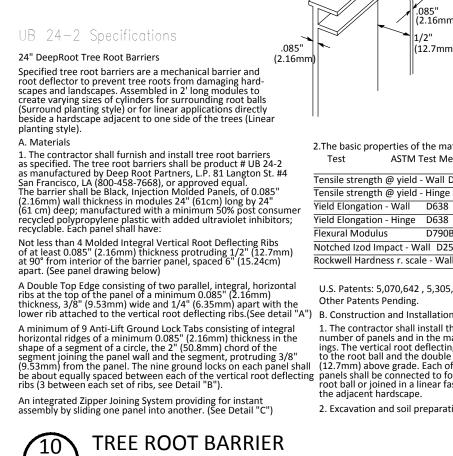


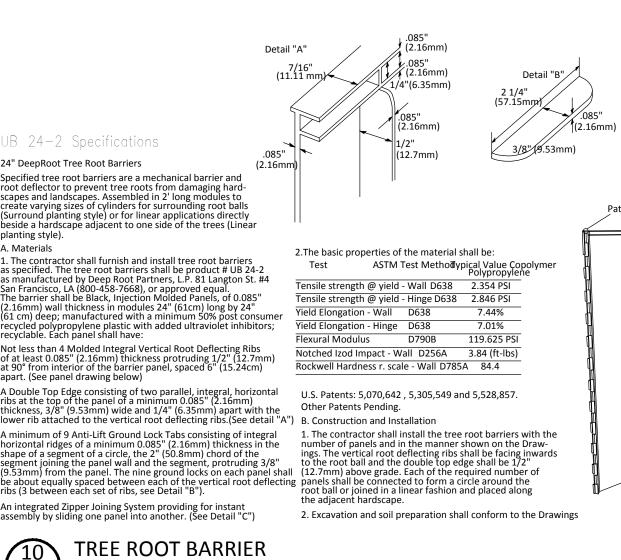


SCALE= NTS


SMALL ORNAMENTAL TREE DETAIL

SECTION

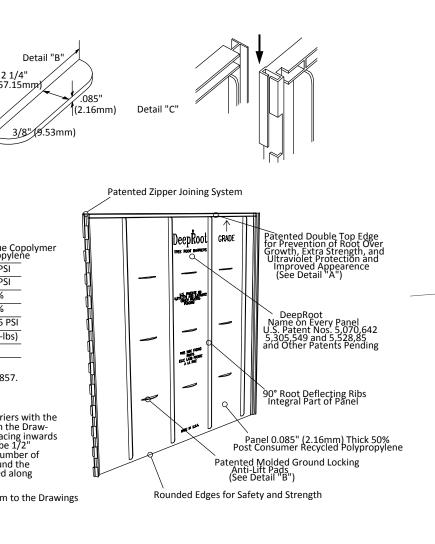

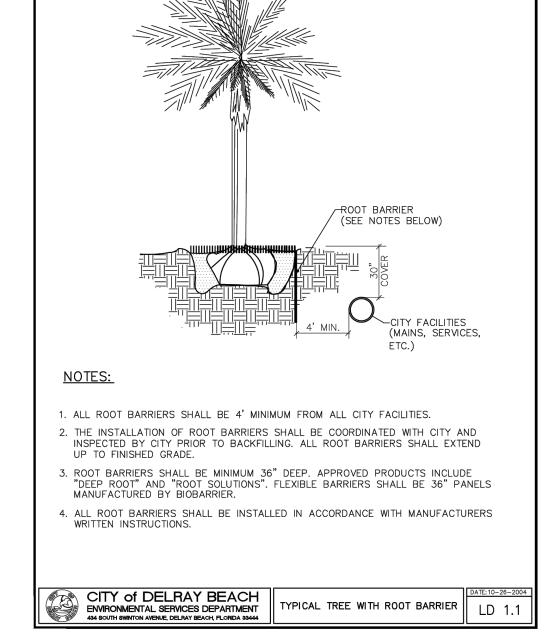

SCALE= NTS

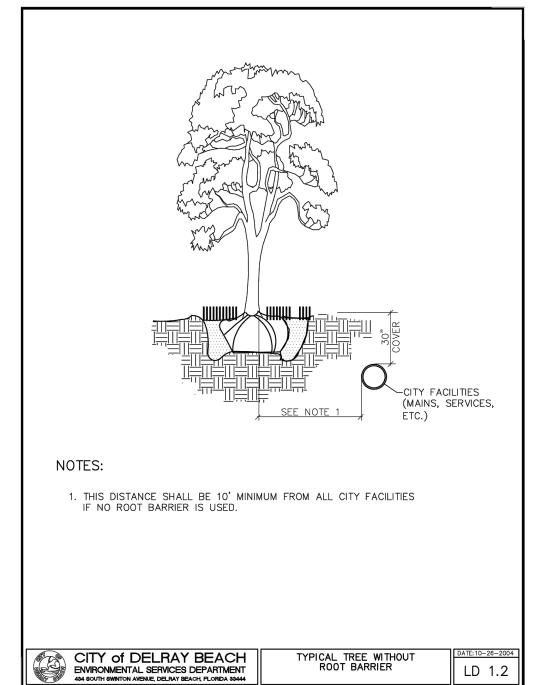



CIVIC FOUNTAIN INSPIRATION

#### LANDSCAPE NOTES

PALM DETAIL

1. THE WORK CONSISTS OF THE COMPLETE PLANT MATERIAL INSTALLATION ON THE DRAWINGS AND AS HEREIN SPECIFIED. THIS WORK SHALL INCLUDE, BUT IS NOT LIMITED TO, THE SUPPLYING OF ALL PLANT MATERIAL SPECIFIED, THE FURNISHING OF LABOR, EQUIPMENT, APPLIANCES AND ALL MATERIALS CALLED FOR, AND IN PERFORMING ALL OPERATIONS IN CONNECTION WITH THE LANDSCAPE INSTALLATION ON THESE PLANS. FURTHER, THE WORK SHALL INCLUDE THE MAINTAINING OF ALL PLANTS AND PLANTING AREAS UNTIL ACCEPTANCE BY THE OWNER, AND THE FULFILLING OF ALL GUARANTEE PROVISIONS AS HEREIN SPECIFIED.

2. NO SUBSTITUTIONS SHALL BE MADE WITHOUT WRITTEN PERMISSION OF THE LANDSCAPE ARCHITECT.

SCALE= NTS

- 3. IN THE EVENT OF VARIATION BETWEEN THE PLANT LIST AND THE ACTUAL NUMBER OF PLANTS SHOWN ON THE PLANS, THE PLANS SHALL CONTROL
- 4. PLANT MATERIALS WILL BE INSPECTED BY THE OWNER'S REPRESENTATIVE AT THE JOB SITE PRIOR TO INSTALLATION. WHEN INSPECTION WORK DOES NOT COMPLY WITH THE REQUIREMENTS, REPLACE REJECTED WORK AND CONTINUE SPECIFIED MAINTENANCE UNTIL REINSPECTED AND FOUND TO BE ACCEPTABLE. REMOVE REJECTED PLANTS AND MATERIALS FROM THE PLANTING SITE WITHIN 48 HOURS AND REPLACE WITH ACCEPTABLE MATERIALS.
- 5. ALL MATERIALS AND EQUIPMENT SHALL BE INSTALLED IN A NEAT AND WORKMANLIKE MANNER. THE OWNER OR HIS REPRESENTATIVE RESERVES THE RIGHT TO DIRECT THE REMOVAL AND REPLACEMENT OF ANY ITEMS WHICH, IN HIS OPINION, DO NOT PRESENT AN ORDERLY AND REASONABLE NEAT OR WORKMANLIKE APPEARANCE, PROVIDED SUCH ITEMS CAN BE PROPERLY INSTALLED IN AN ORDERLY WAY BY TYPICAL INSTALLATION METHODS.
- 6. ALL PLANTING BEDS WITHIN FDOT RIGHT OF WAYS SHALL BE MULCHED WITH 3" OF RECYCLED MULCH CERTIFIED BY THE MULCH AND SOIL COUNCIL (MSC). SUBMIT PROOF OF CERTIFICATION TO THE FDOT DISTRICT OPERATIONS PERMIT LANDSCAPE INSPECTOR UPON INSPECTION. ALL ON SITE PLANTING BEDS SHALL BE MULCHED WITH 3" OF RECYCLED MULCH. NO RED COLORED MULCH WILL BE ACCEPTED.

- 7. ALL TREES 6' TALL OR LARGER SHALL BE STAKED AND GUYED WITH VERTICAL 2" X 2" PINE STAKES OR 4" DIAMETER POST IN DETAILS. NO DEVIATIONS UNLESS APPROVED IN WRITING.
- 8. PLANTING SOIL FOR ALL PLANT MATERIALS SHALL CONSIST OF TWO (2) PARTS OF TOPSOIL WITH ONE (1) PART PEAT MOSS AND .9 kg FERTILIZER PER CUBIC METER, WELL MIXED.
- 9. ALL PLANT MATERIALS SHALL BE WATERED BY THE CONTRACTOR THOROUGHLY WHEN PLANTED AND DURING THE PLANTING TIME PERIOD UP TO FINAL ACCEPTANCE BY OWNER.

10. PROVIDE NEW TOPSOIL FOR TURF IN ALL SODDED AND SEEDED AREAS. TOPSOIL SHALL BE FERTILE, BLACK IN COLOR, FRIABLE, NATURAL LOAM, SURFACE SOIL, REASONABLY FREE OF SUBSOIL, CLAY LUMPS, BRUSH, WEEDS AND OTHER LITTER, AND FREE OF ROOTS, STUMPS, STONES LARGER THAN 3 cm IN ANY DIMENSION, AND OTHER EXTRANEOUS OR TOXIC MATTER HARMFUL TO SOD GROWTH. OBTAIN TOPSOIL ONLY FROM NATURALLY, WELL DRAINED SITES WHERE TOPSOIL OCCURS IN A DEPTH OF NOT LESS THAN 10 cm . DO NOT OBTAIN FROM BOGS OR MARSHES. THE CONTRACTOR SHALL PROVIDE A SOILS TEST REPORT SHOWING pH AND NUTRIENTS; - pH SHALL BE 5.5 TO 6.0. IF NOT THEN USE THE APPROPRIATE SOIL AMENDMENTS TO REACH 5.5 TO 6.0.

- 11. CONTRACTOR TO VERIFY ALL EXISTING UNDERGROUND UTILITIES PRIOR TO ANY DIGGING
- 12. THE CONTRACTOR SHALL NOTIFY THE LANDSCAPE ARCHITECT OF ANY CONFLICT OR DISCREPANCY IN PLANS PRIOR TO PERFORMING ANY WORK IN THE AFFECTED AREA.
- 13. CONTRACTOR SHALL CLEAN UP AND REMOVE FROM THE PREMISES ALL SURPLUS AND DISCARDED MATERIALS AND RUBBISH FROM HIS CONSTRUCTION.
- 14. ALL SHRUBS, GROUNDCOVERS, AND SOD SHALL BE GUARANTEED FROM NINETY (90) DAYS AFTER FINAL ACCEPTANCE BY OWNER. ALL TREES SHALL BE GUARANTEED FOR ONE (1) YEAR AFTER FINAL ACCEPTANCE BY OWNER.

15. FINAL INSPECTION WILL NOT TAKE PLACE UNTIL ALL MATERIALS ARE PLANTED/INSTALLED CORRECTLY. CONTRACTOR WILL REQUEST A FINAL INSPECTION BY WRITTEN LETTER TO OWNER.

16. UPON NOTICE OF FINAL ACCEPTANCE, THE OWNER WILL ASSUME MAINTENANCE AND THE GUARANTEE/ WARRANTY PERIOD BEGINS.

- 17. ALL SODDED AREAS SHALL BE HAND WATERED UNTIL TURF IS ESTABLISHED.
- 18. CONTRACTOR TO NOTIFY/VERIFY WITH LANDSCAPE ARCHITECT, THE AVAILABILITY (QUANTITY & QUALITY PRESCRIBED IN THE DRAWINGS) OF ALL PLANT MATERIAL SPECIFIED AT THE TIME OF THE BID.

19. CONTRACTOR INSTALLING THE PLANT MATERIAL AT THE SITE WILL BE RESPONSIBLE FOR MAINTAINING THE CONDITION AND HEALTH OF THE MATERIAL (AS DOCUMENTED IN THE PHOTOGRAPHS AT THE TIME OF INSPECTION) FROM THE TIME OF INSTALLATION TO THE TIME OF TURNING OVER THE PROJECT TO THE OWNER OR OPERATOR. IF THE CONTRACTOR FAILS TO MAINTAIN THE MATERIAL AS SPECIFIED, THAT PLANT MATERIAL WILL BE REJECTED.

- 20. REPLACE EXISTING SOD WHERE DAMAGED BY CONSTRUCTION ACTIVITIES
- 21. ALL PLANT MATERIAL SHALL BE FLORIDA #1 GRADE OR BETTER.
- 22. ALL PROHIBITED PLANT SPECIES SHALL BE ERADICATED FROM THE SITE.
- 23. SOD AND IRRIGATION SHALL BE PROVIDED WITHIN THE UNPAVED PORTION OF THE RIGHT-OF-WAY ADJACENT TO THE PROPERTY LINE.

24. REINFORCED CONCRETE CURBING AT LEAST SIX (6) INCHES IN HEIGHT SHALL BE PROVIDED AROUND ALL LANDSCAPE ISLANDS AND AS A SEPARATOR BETWEEN ALL LANDSCAPED AREAS THAT ARE ADJACENT TO VEHICULAR USE AREAS UNLESS SUCH CURBING WILL INTERFERE WITH THE DRAINAGE.



SITE PLAN

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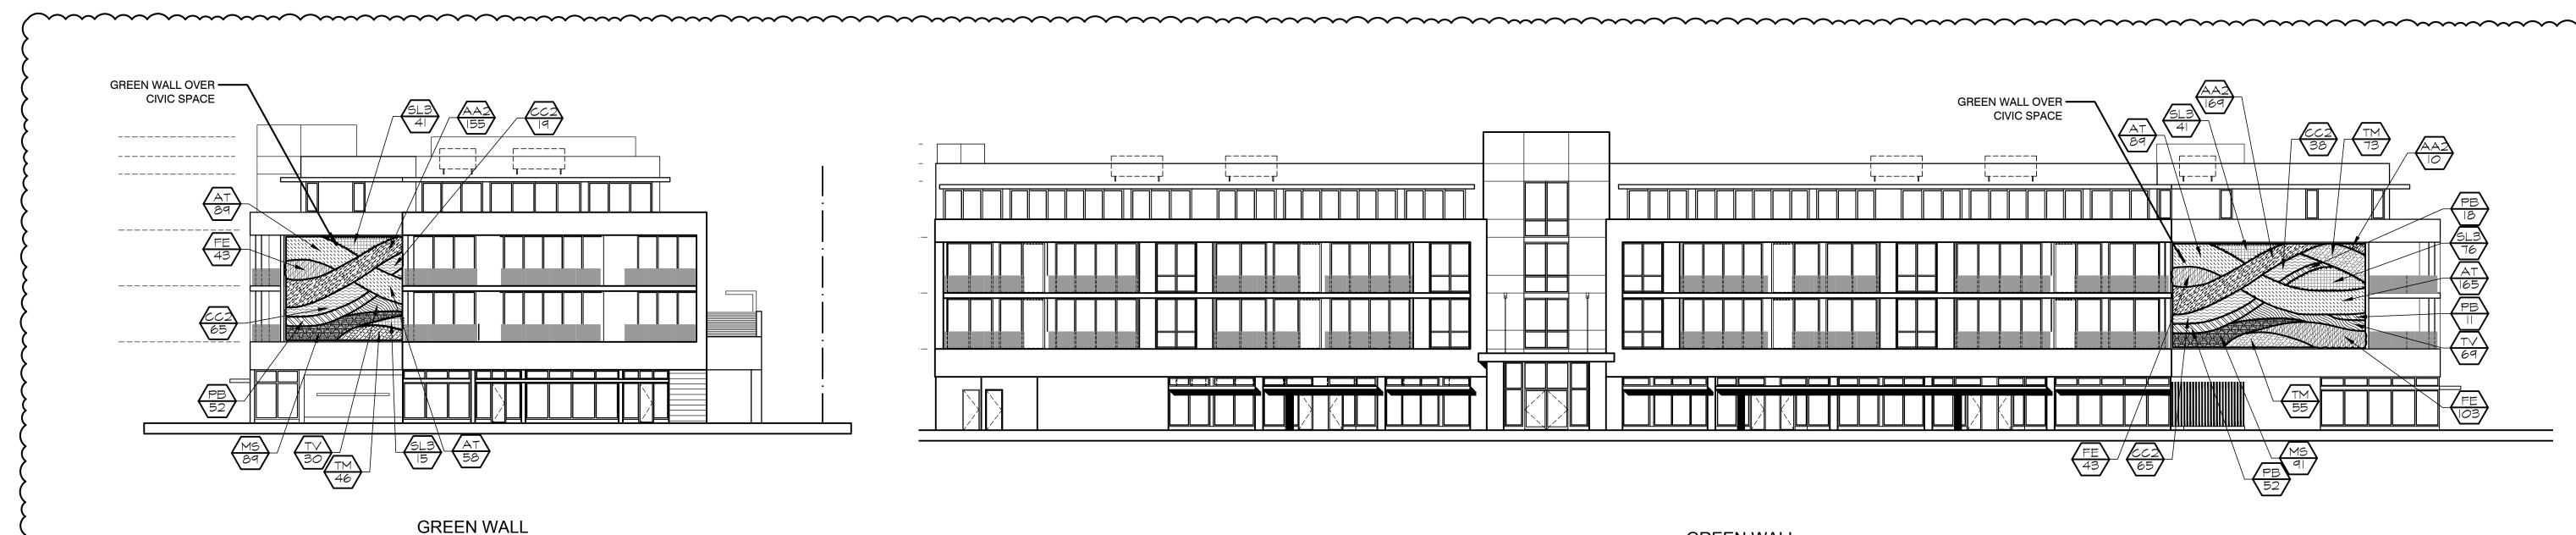
(C)

PLANTING **DETAILS** 

DATE: 09/29/2021 <u> PROJECT #: 2102</u> DRAWN BY: HT CHECKED BY: J

<u>REVISIONS:</u> REV 4/1/22 7/1/22 8/30/2

1 REV 10/12/2




NORTH ELEVATIONS

GREEN WALL
WEST ELEVATIONS

#### PLANT SCHEDULE ELEVATIONS

GREEN WALL	CODE	QTY	BOTANICAL NAME	COMMON NAME	CONTAINER	SIZE	SPACING	SPACING
	CC2	187	Codiaeum variegatum 'Red Corkscrew'	Corkscrew Croton	1 gal.	10"x10"	10" O.C.	10" o.c.
	FE	189	Ficus elastica	Rubber Tree	1 gal.	10"x10"	10" O.C.	10" o.c.
	SL3	173	Schefflera arboricola 'Emerald Green'	Emerald Green Schefflera	1 gal.	10"x10"	10" O.C.	10" o.c.
GREEN WALL	CODE	QTY	BOTANICAL NAME	COMMON NAME	CONTAINER	SIZE		
	АТ	401	Alternanthera bettzickiana 'True Yellow'	True Yellow Calico Plant	1 gal.	10"x10"		10" o.c.
	AA2	334	Asparagus densiflorus 'Sprengeri'	Sprenger Asparagus Fern	1 gal.	10"x10"		10" o.c.
	MS	180	Microsorum scolopendria	Wart Fern	1 Gal.	10"x10"		10" o.c.
	РВ	133	Philodendron x 'Burle Marx'	Burle Marx Philodendron	1 gal.	10"x10"		10" o.c.
	TM	178	Trachelospermum asiaticum 'Minima - Black'	Minima Asiatic Jasmine	1 gal.	10"x10"		10" o.c.
	TV	99	Trachelospermum asiaticum 'Variegata'	Variegated Asiatic Jasmine	1 gal.	10"x10"		10" o.c.



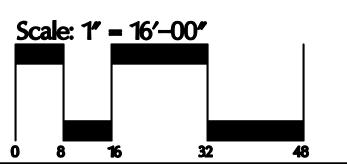



SITE PLAN

SE 5TH AVENUE

GREEN WALL ELEVATIONS

DATE: 07/21/2022
PROJECT #: 2102
DRAWN BY: HT
CHECKED BY: JH
SCALE: INDICATED

REVISIONS:

3 REV 8/30/2

4 REV 10/12/2

5 REV 3/2/2

6 REV 3/10/2

SEAL:

LAPL-6

SINGLE IRRIGATION STUB-OUT

MAX 36 PANELS IN SINGLE ROW

AND CONDUIT

SCALE= NTS

1" IRRIGATION MAIN LINE

INLET (SIZE MAY VARY) PRESSURE REGULATION

MASTER VALVE ¬

FLOW SENSOR REQUIRES MIN. 1' STRAIGHT PIPE BEFORE AND AFTER THE SENSOR

— FERTILIZER INJECTOR

— FERTILIZER TANK

\*GREEN WALLS SMALLER THAN 1080 SQFT (INTERIOR OR EXTERIOR) \*EXTERIOR WALLS IN USDA PLANT ZONE 9 OR HIGHER (NON-FREEZING

**Z**-**Z** 

GREEN WALL GRID WITH IRRIGATION

IRRIGATION CONTROL UNIT FOR:

ICU-600

CLIMATES)

CONTROLLER / TIMER \_\_\_\_\_\_\_ 1'-3"

DEDICATED IRRIGATION ZONE SUPPLY LINES FROM ICU TO GREEN WALL BY OTHERS

3/4" FIPT STUB-OUTS ARE REQUIRED; 1" SUPPLY LINE MAY BE USED TO KEEP FLOW TO STUB-OUT

\*REQUIREMENTS:

\*ICU - 48"h x 36"w x 48"d (INCLUDING DOOR SWING)


\*CONTROLLER - 13"h x 15"w x 20"d (INCLUDING DOOR SWING)

HARD WIRE CONNECTION 120 VAC / 2 AMP IN CONDUIT — BY ELECTRICIAN

DEDICATED TELEPHONE LINE
WITH RJ 11 CONNECTION BY
ELECTRICIAN

1" CONDUIT BY G-SKY

PANELS

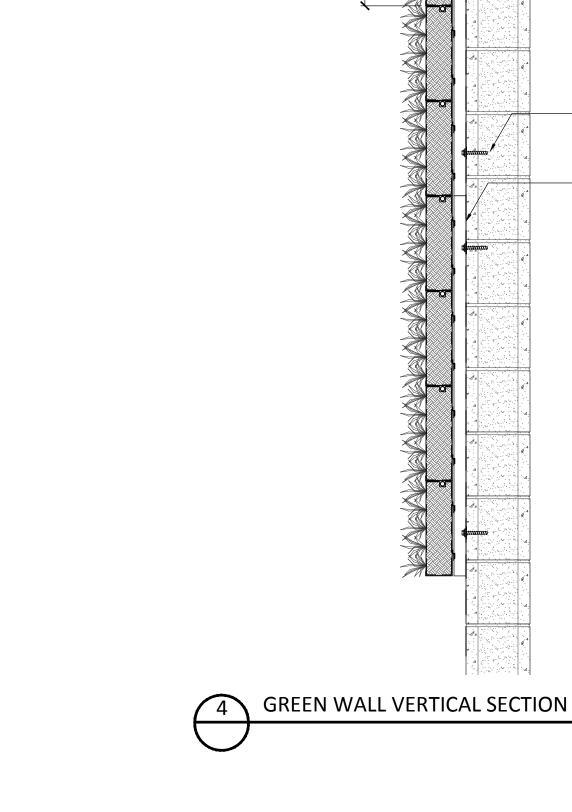

STAINLESS OR ALUMINUM

GSKY TOP TRIM SECURE -INTO TRIM MOUNTING ANGLE

> GSKY STANDARD GREEN WALL PANEL

LOCATE ZONE VALVES WITH IN

SPACE IS REQUIRED

TOP TRIM SPACE; MIN 8" TOP TRIM —

LOCATE DRAIN VALVES AT

GSKY TRIM MOUNTING

CMU WALL (VOID

MUST BE FILLED)

**GSKY IRRIGATION** 

GSKY SS FRAME

3/8" DIA CONCRETE

- WATERPROOFING


SCALE= NTS

ANCHOR


DRIP LINE


**BOTTOM OF EACH ZONE** 




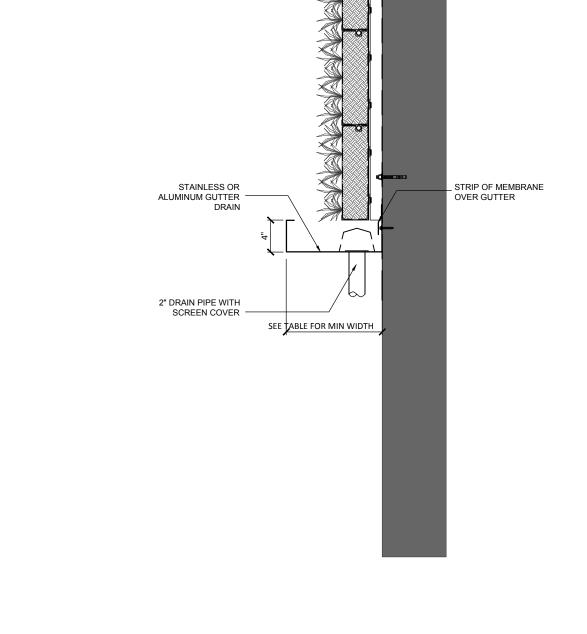

**GREEN WALL - HORIZONTAL SECTION** SCALE= NTS

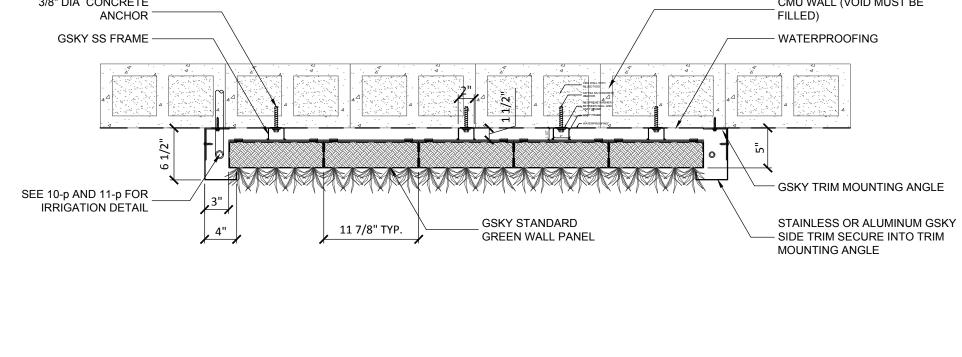

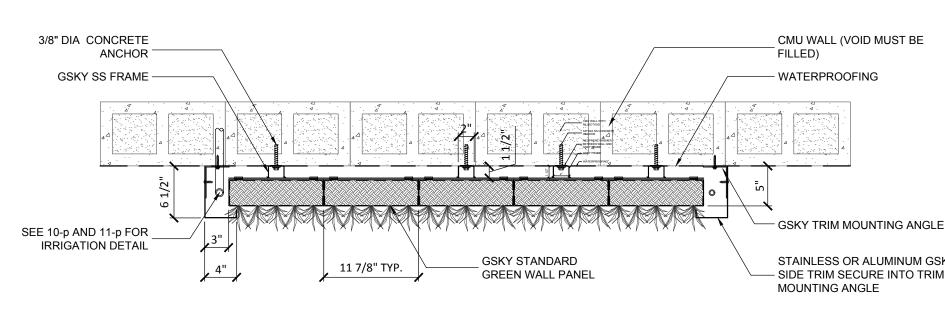

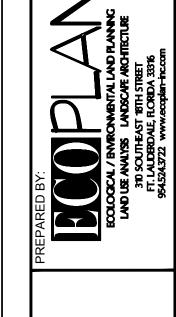

SITE PLAN

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~~~~ **GREEN WALL DETAILS** 

DATE: 07/21/2022 PROJECT #: 2102 DRAWN BY: HT CHECKED BY: JH SCALE: INDICATED

REVISIONS: 8/30/22

3/10/2

SHEET NUMBER:

It's fast. It's fees. It's the law.

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April 4, 2022

Rebekah Dasari Senior Planner City of Delray Beach 100 NW First Avenue Delray Beach, FL 33444

Re: 318 SE 5<sup>th</sup> Avenue Arborist Report

Dear Ms. Dasari,

Please accept the following as an arborist review of the trees located on the above referenced project. WGI has completed a tree inventory of all the protected trees within the proposed project area at 318 SE 5<sup>th</sup> Avenue.

There are 7 trees with a condition rating greater than 50% proposed for removal. These trees include two *Tabebuia aurea*, two *Swietenia mahogani*, two *Mangifera indica*, and one *Quercus virginiana*. These trees exhibited signs of stress and/or damage such as limb damage, discolored foliage, and sparse canopy. Notes and details for each of these trees is provided in the Tree Inventory Plan and included photo documentation.

There are 6 trees with a condition rating less than 50% proposed for removal. These trees include one *Terminalia buceras*, one *Ficus benjamina*, one *Bursera simaruba*, one *Tabebuia aurea*, one *Quercus virginiana*, and one *Swietenia mahogani*. As indicated by the condition ratings, these trees were of poor condition and exhibited extensive damage and/or signs of severe stress. Notes and details for each of these trees is provided in the Tree Inventory Plan and included photo documentation.

In total, 159 DBH inches are proposed to be removed and a total of 50 replacement DBH inches are proposed. The total proposed in-lieu fee is \$26,300.00 to provide mitigation for removed trees that are in excess of the proposed 50 replacement trees.

There is one palm, a *Pytchosperma elegans*, proposed for removal. This palm exhibited damage and signs of stress.

In total, one palm is proposed for removal and two 15-foot clear trunk replacement palms are proposed to be provided to fully offset this loss. Additionally, this plan proposes 22 replacement palms of varying heights (10 to 15-foot clear trunk) to provide surplus replacement material.

Please let me know if you have any questions or require additional information and I will be happy to provide it to you.

Thank you,

Rick Harman, CEP, PWS

ISA Certified Arborist FL-5646A

| Tag# | Common Name     | Scientific Name      | Size<br>(DBH inches for<br>Trees or Feet to<br>Clear Trunk for<br>Palms) | Spread<br>(sq-ft) | Condition<br>Rating | Disposition | Notes                                                                                                                                   |
|------|-----------------|----------------------|--------------------------------------------------------------------------|-------------------|---------------------|-------------|-----------------------------------------------------------------------------------------------------------------------------------------|
| 1    | Mango           | Mangifera indica     | 11                                                                       | 400               | 75                  | Remove      | Codominant, included bark, growing abut fence, close to building, under powerline                                                       |
| 2    | Mahogany        | Swietenia mahogani   | 12                                                                       | 225               | 60                  | Remove      | Growing about fence, close to building, under powerline, sparse canopy, overall crown reduction                                         |
| 3    | Mahogany        | Swietenia mahogani   | 10                                                                       | 300               | 70                  | Remove      | Growing split around fence, under powerline, codominant, minor branch damage                                                            |
| 4    | Live Oak        | Quercus virginiana   | 25                                                                       | 2000              | 75                  | Remove      | Minor branch damage                                                                                                                     |
| 5    | Mango           | Mangifera indica     | 4                                                                        | 150               | 60                  | Remove      | Growing abut fence, under powerline, shaded and competing for space, dead and discolored foliage                                        |
| 6    | Live Oak        | Quercus virginiana   | 12                                                                       | 300               | 45                  | Remove      | Growing abut fence, under powerline, and near asphalt parking lot. Leaning, vine intrusion, asymmetrical canopy                         |
| 7    | Solitaire Palm  | Ptychosperma elegans | 14'                                                                      | 64                | 45                  | Remove      | Growing abut fence, under powerline, moderate trunk damage, vine intrusion                                                              |
| 8    | Gumbo Limbo     | Bursera simaruba     | 8                                                                        | 64                | 40                  | Remove      | Growing through fence near parking lot, under powerline, leaning, asymmetrical canopy, vine intrusion, severe canopy reduction          |
| 9    | Black Olive     | Terminalia buceras   | 16                                                                       | 400               | 30                  | Remove      | Severe trunk and branch damage and canopy reduction, dead and dying limbs, severe insect intrusion, sparse foliage                      |
| 10   | Yellow Tabebuia | Tabebuia aurea       | 5                                                                        | 150               | 50                  | Remove      | Growing abut fence near parking lot, umbrella tree intrusion, shaded, discolored foliage, severe canopy reduction                       |
| 11   | Yellow Tabebuia | Tabebuia aurea       | 9                                                                        | 150               | 60                  | Remove      | Growing abut fence near parking lot, codominant, poor overall growth structure                                                          |
| 12   | Yellow Tabebuia | Tabebuia aurea       | 6                                                                        | 64                | 40                  | Remove      | Growing abut fence near parking lot, competing for space, discolored foliage, severe canopy reduction                                   |
| 13   | Mahogany        | Swietenia mahogani   | 29                                                                       | 3600              | 45                  | Remove      | Growing abut fence, near parking lot and building. Severe main branch damage and decay, vine intrusion, dead / dying secondary branches |
| 14   | Weeping Fig     | Ficus benjamina      | 12                                                                       | 100               | 30                  | Remove      | Growing near and on building, severe overall canopy reduction and sparse foliage, decay present                                         |



## Arborist Report - Tree # 1, Mango



Note: Codominant, included bark, confined root space



# Arborist Report - Tree # 2, Mahogany



Note: Sparse canopy, overall crown reduction, confined root space



# Arborist Report - Tree # 3, Mahogany





Note: Codominant, branch damage, growing split around fence



## Arborist Report - Tree # 4, Live Oak



Note: Minor branch damage



## Arborist Report - Tree # 5, Mango





Note: Dead and discolored foliage, shaded and competing for space, confined root space



# Arborist Report - Tree # 6, Live Oak






Note: Leaning, confined root space, asymmetrical canopy



### Arborist Report - Palm # 7, Solitaire Palm



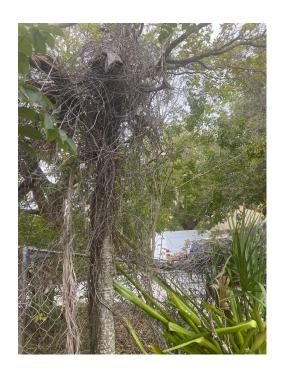

Note: Growing abut fence, trunk damage, vine intrusion



# Arborist Report - Tree # 8, Gumbo Limbo




Note: Confined root space, severe canopy reduction, asymmetrical canopy, leaning



### Arborist Report - Tree # 9, Black Olive



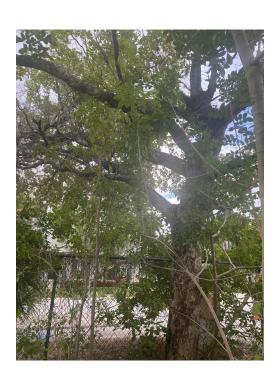



Note: Severe trunk & branch damage, severe canopy reduction, dead and dying limbs, severe insect intrusion, sparse foliage



## Arborist Report - Tree # 10, Yellow Tabebuia





Note: Confined root space, discolored and sparse foliage



# Arborist Report - Tree # 11, Yellow Tabebuia





Note: Codominant, confined root space, poor overall growth structure



## Arborist Report - Tree # 12, Yellow Tabebuia





Note: Confined root space, discolored and sparse foliage



# Arborist Report - Tree # 13, Mahogany







Note: Confined root space, severe branch damage and decay, dead and dying limbs



### Arborist Report — Tree # 14, Weeping Fig





Note: Confined root space, decay present, very sparse canopy