



Planning, Zoning and Building Department

BOARD ACTION REPORT – APPEALABLE ITEM

Project Name: Hood Distribution
Project Location: 1860 Dr. Andre's Way
Request: Class I Site Plan Modification and Architectural Elevations
Board: Site Plan Review and Appearance Board
Meeting Date: February 22, 2017

Board Action:

Approved (5-0, Jim Chard and Fred Kaub absent) for architectural elevation changes associated with a Class I site plan modification.

Project Description:

The subject property is located on the eastside of Dr. Andre's Way and north of Atlantic Avenue in the MROC (Mixed Residential Office and Commercial) zoning district and contains 2.99 acres there is a 28,992 sq. ft. warehouse that is used for a lumber company and 1,008 sq. ft. of office space. The site was constructed in 1980.

The elevation change includes the installation of a steel canopy in the rear of the building which faces the north elevation. The canopy will extend 150 ft. of the building length and project 45 ft and will be enclosed on east and west elevations.

Staff Recommendation:

Approve

Board Comments:

none

Public Comments:

None

Next Action:

The SPRAB action is final unless appealed by the City Commission.

SITE PLAN REVIEW AND APPEARANCE BOARD

CITY OF DELRAY BEACH

---STAFF REPORT---

MEETING DATE: February 22, 2017

ITEM: **Hood Distribution (2017-083)** Approval of a Class I Site Plan Modification for Hood Distribution associated with the installation of an aluminum awning pursuant to Land Development Regulations (LDR) Section 2.4.5(G)(1)(a) at 1860 Dr. Andre's Way.

RECOMMENDATION: Approval

GENERAL DATA:

Owner..... Darrin Martin

Applicant..... Kyle Sawchuk, RA Architect

Location..... On the East Side of Dr. Andre's Way
North of Atlantic Avenue.

Existing land Use..... Lumber Company

Property Size..... 2.99 Acres

Future Land Use Map..... CMR (Commerce)

Current Zoning..... MROC (Mixed Residential Office & Commercial)

Adjacent Zoning.....North: MROC (Mixed Residential Office & Commercial)

East: Cd (Construction District)

South: MROC

West: MROC



SITE PLAN REVIEW AND APPEARANCE BOARD STAFF REPORT

Applicant: Kyle Sawchuck, RA
Project Name: Hood Distribution
Project Location: 1860 Dr. Andre's Way

ITEM BEFORE THE BOARD

The action before the Board is approval of a Class I Site Plan Modification for Hood Distribution associated with the installation of a steel awning in the rear of the building pursuant to Land Development Regulations (LDR) Section 2.4.5(G)(1)(a).

BACKGROUND

The subject property is located on the eastside of Dr. Andre's Way and north of Atlantic Avenue in the MROC (Mixed Residential Office and Commercial) zoning district and contains 2.99 acres there is a 28,992 sq. ft. warehouse that is used for a lumber company and 1,008 sq. ft. of office space. The site was constructed in 1980.

Now before the Board is a Class I Site Plan Modification associated with the installation a steel awning on the north elevation.

ARCHITECTURAL ELEVATION ANALYSIS

Pursuant to **LDR Section 4.6.18(E)**, the following criteria shall be considered by the Site Plan Review and Appearance Board in the review of plans for building permits. If the following criteria are not met, the application shall be disapproved.

- (1) The plan or the proposed structure is in conformity with good taste, good design, and in general, contributes to the image of the City as a place of beauty, spaciousness, harmony, taste, fitness, broad vistas, and high quality.
- (2) The proposed structure, or project, is in its exterior design and appearance of quality such as not to cause the nature of the local environment or evolving environment to materially depreciate in appearance and value.
- (3) The proposed structure, or project, is in harmony with the proposed developments in the general area, with the Comprehensive Plan, and with the supplemental criteria which may be set forth for the Board from time to time.

The proposed elevation change includes the installation of a steel canopy in the rear of the building which faces the north elevation. The canopy will extend 150 ft. of the building length and project 45 ft and will be enclosed on east and west elevations. The canopy will provide a protected space to cross dock (load and unload) inbound as well as outbound materials.

The proposed architectural elevation change will not adversely affect the surrounding area and will not materially depreciate the neighboring areas. Based on the above, positive findings can be made with respect to LDR Section 4.6.18(E).

ALTERNATIVE ACTIONS

- A. Continue with direction.
- B. Approve the Class I site plan modification for Hood Distribution located at **1860 Dr. Andre's Way**, by adopting the findings of fact and law contained in the staff report, and finding that the request is consistent with the Comprehensive Plan and meets criteria set forth in Section 4.6.18(E).
- C. Deny the Class I site plan modification for Hood Distribution located at **1860 Dr. Andre's Way**, by adopting the findings of fact and law contained in the staff report, and finding that the request is inconsistent with the Comprehensive Plan and does not meet criteria set forth in Section 4.6.18(E).

RECOMMENDATION

Approve the Class I site plan modification for Hood Distribution located at **1860 Dr. Andre's Way**, by adopting the findings of fact and law contained in the staff report, and finding that the request is consistent with the Comprehensive Plan and meets criteria set forth in Section 4.6.18(E).

Report Prepared By: Jennifer Buce, Assistant Planner

Attachments: Survey; Site Plan; Location Map



November 17, 2016

City of Delray Beach
Planning, Zoning and Building Department
100 NW 1st Avenue, Delray Beach, Florida 33444
(561) 243-7000

To Whom It May Concern:

This letter is to clarify the intended use of the canopy project that we are proposing for our distribution unit located at 1860 Dr. Andre's Way, Delray Beach, FL 33445. Our business there is the distribution of both cabinet and architectural grade hardwood lumber, panels & related accessory items. The nature and quality of these wood products do not allow exposure to the elements, especially rain water.


The intended use of this canopy is to allow us covered, protected space to cross dock (load & un-load) inbound as well as outbound materials. Inbound loads will be unloaded and staged there until they are checked-in, tagged and moved to their permanent storage locations inside the warehouse structure. Our outbound orders will be staged there until our trucks return from their daily runs and are reloaded in the afternoons for the next day runs.

The canopy project will enable our operation to increase its efficiencies by having a space to load and unload our valuable products in an area much more protected from the elements. The regular rains in South Florida hinder the efficiencies of the operation often as we currently do not have the space within the warehouse to perform this function. The warehouse footage is completely taken up by our small office and the stocking locations of the materials that we distribute in the marketplace; leaving little to no remaining space for the much needed covered cross docking function to take place.


Your attention to this matter is much appreciated as we look forward to continuing our long standing business in the community. This canopy will greatly improve our efficiencies allowing our operation more growth opportunities.

Regards,

Darrin Martin
Vice President, Hood Industries – Distribution Division

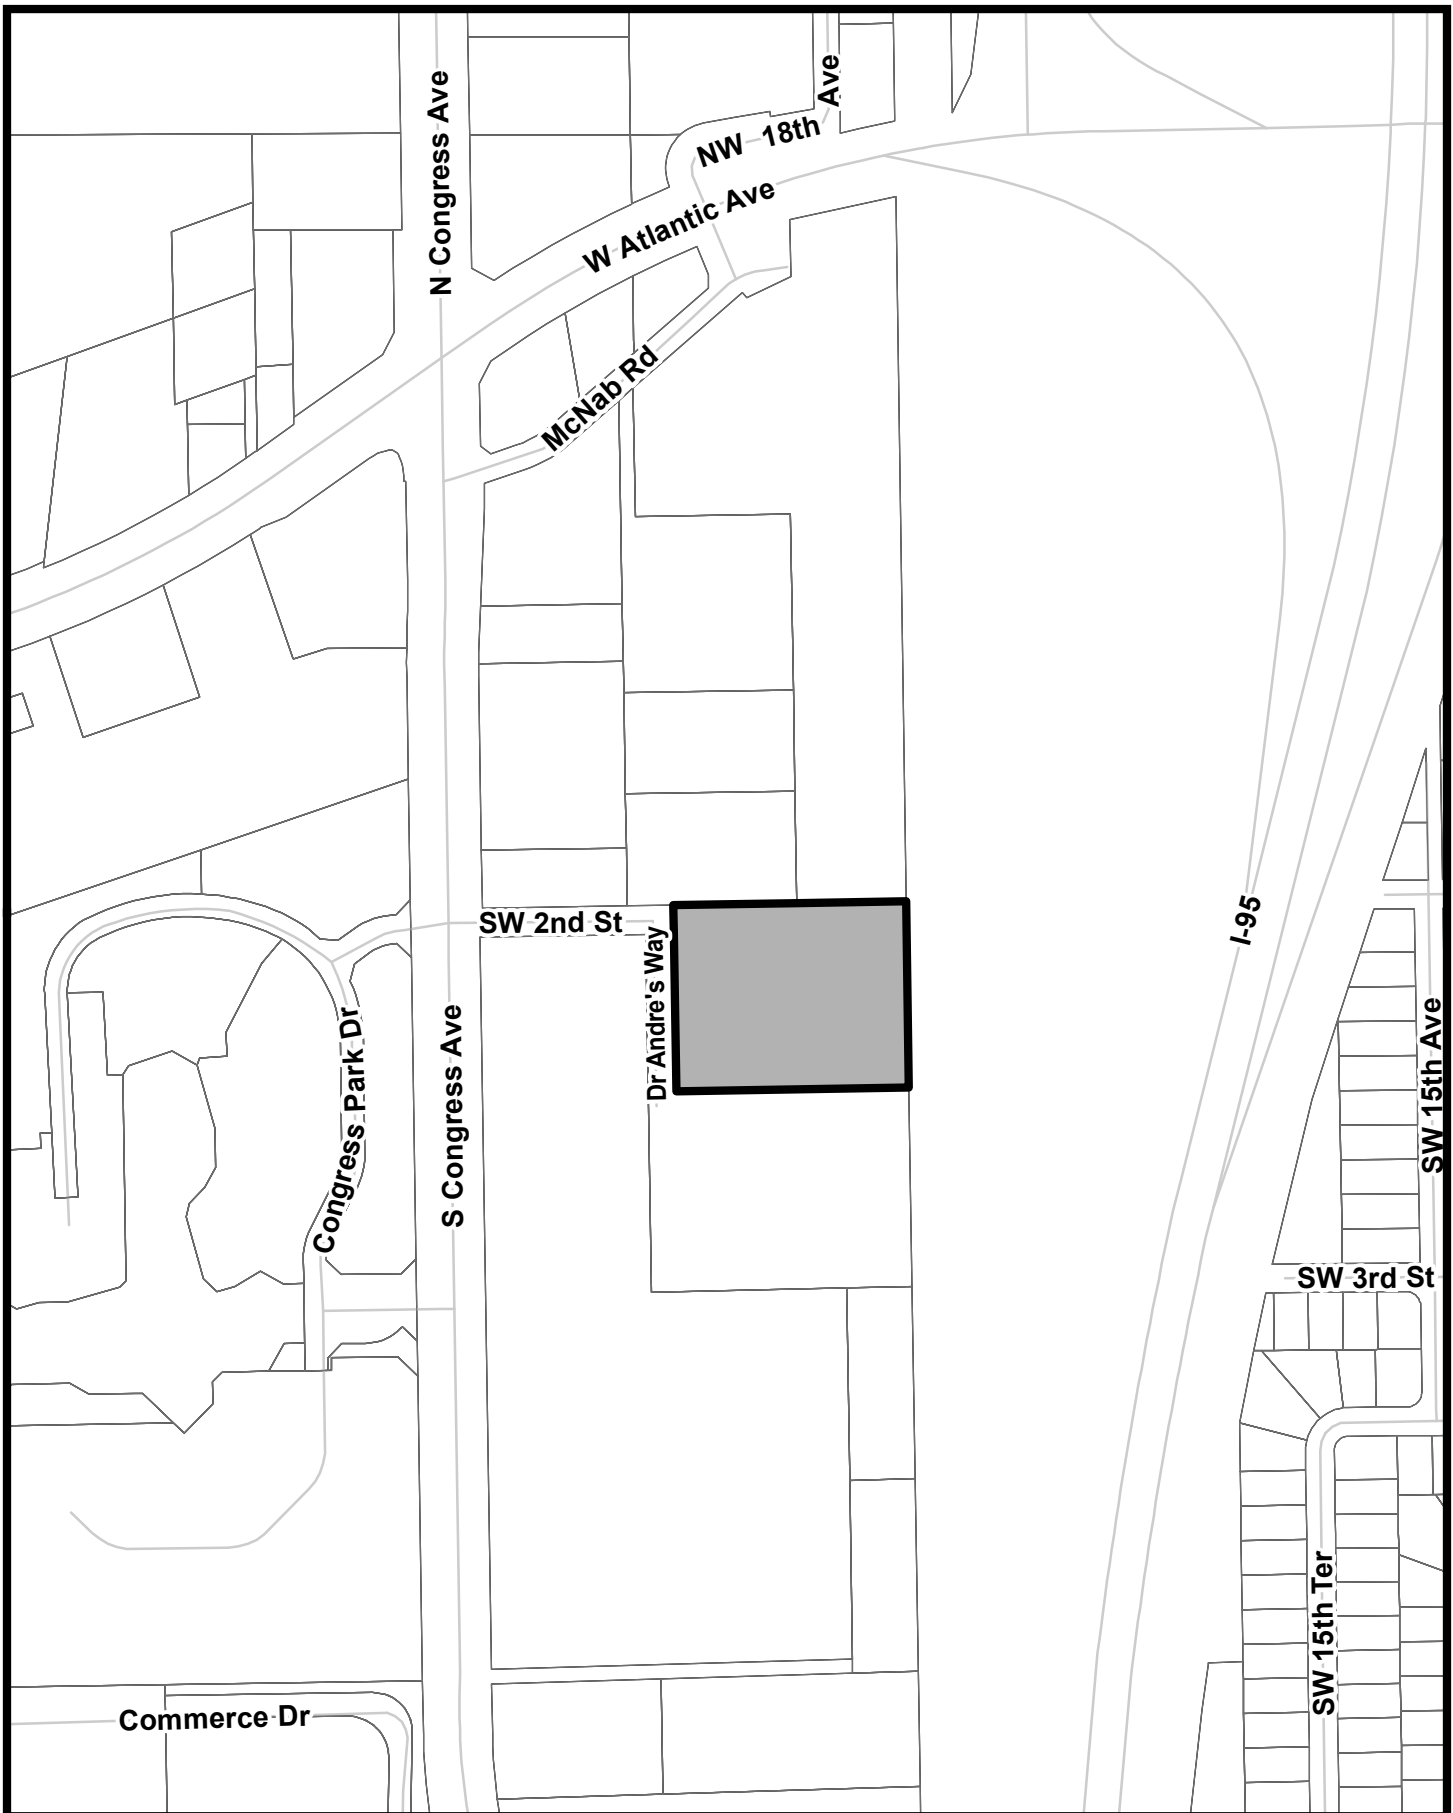

Hood Distribution 1860 Dr. Andre's Way LOCATION MAP

 Subject Property

HOOD DISTRIBUTION-EXTERIOR CANOPY

1860 DR. ANDRE'S WAY


DELRAY BEACH, FL

33445

Commission No. 16-007

01.16.2017

SITE PLAN APPLICATION LEVEL I

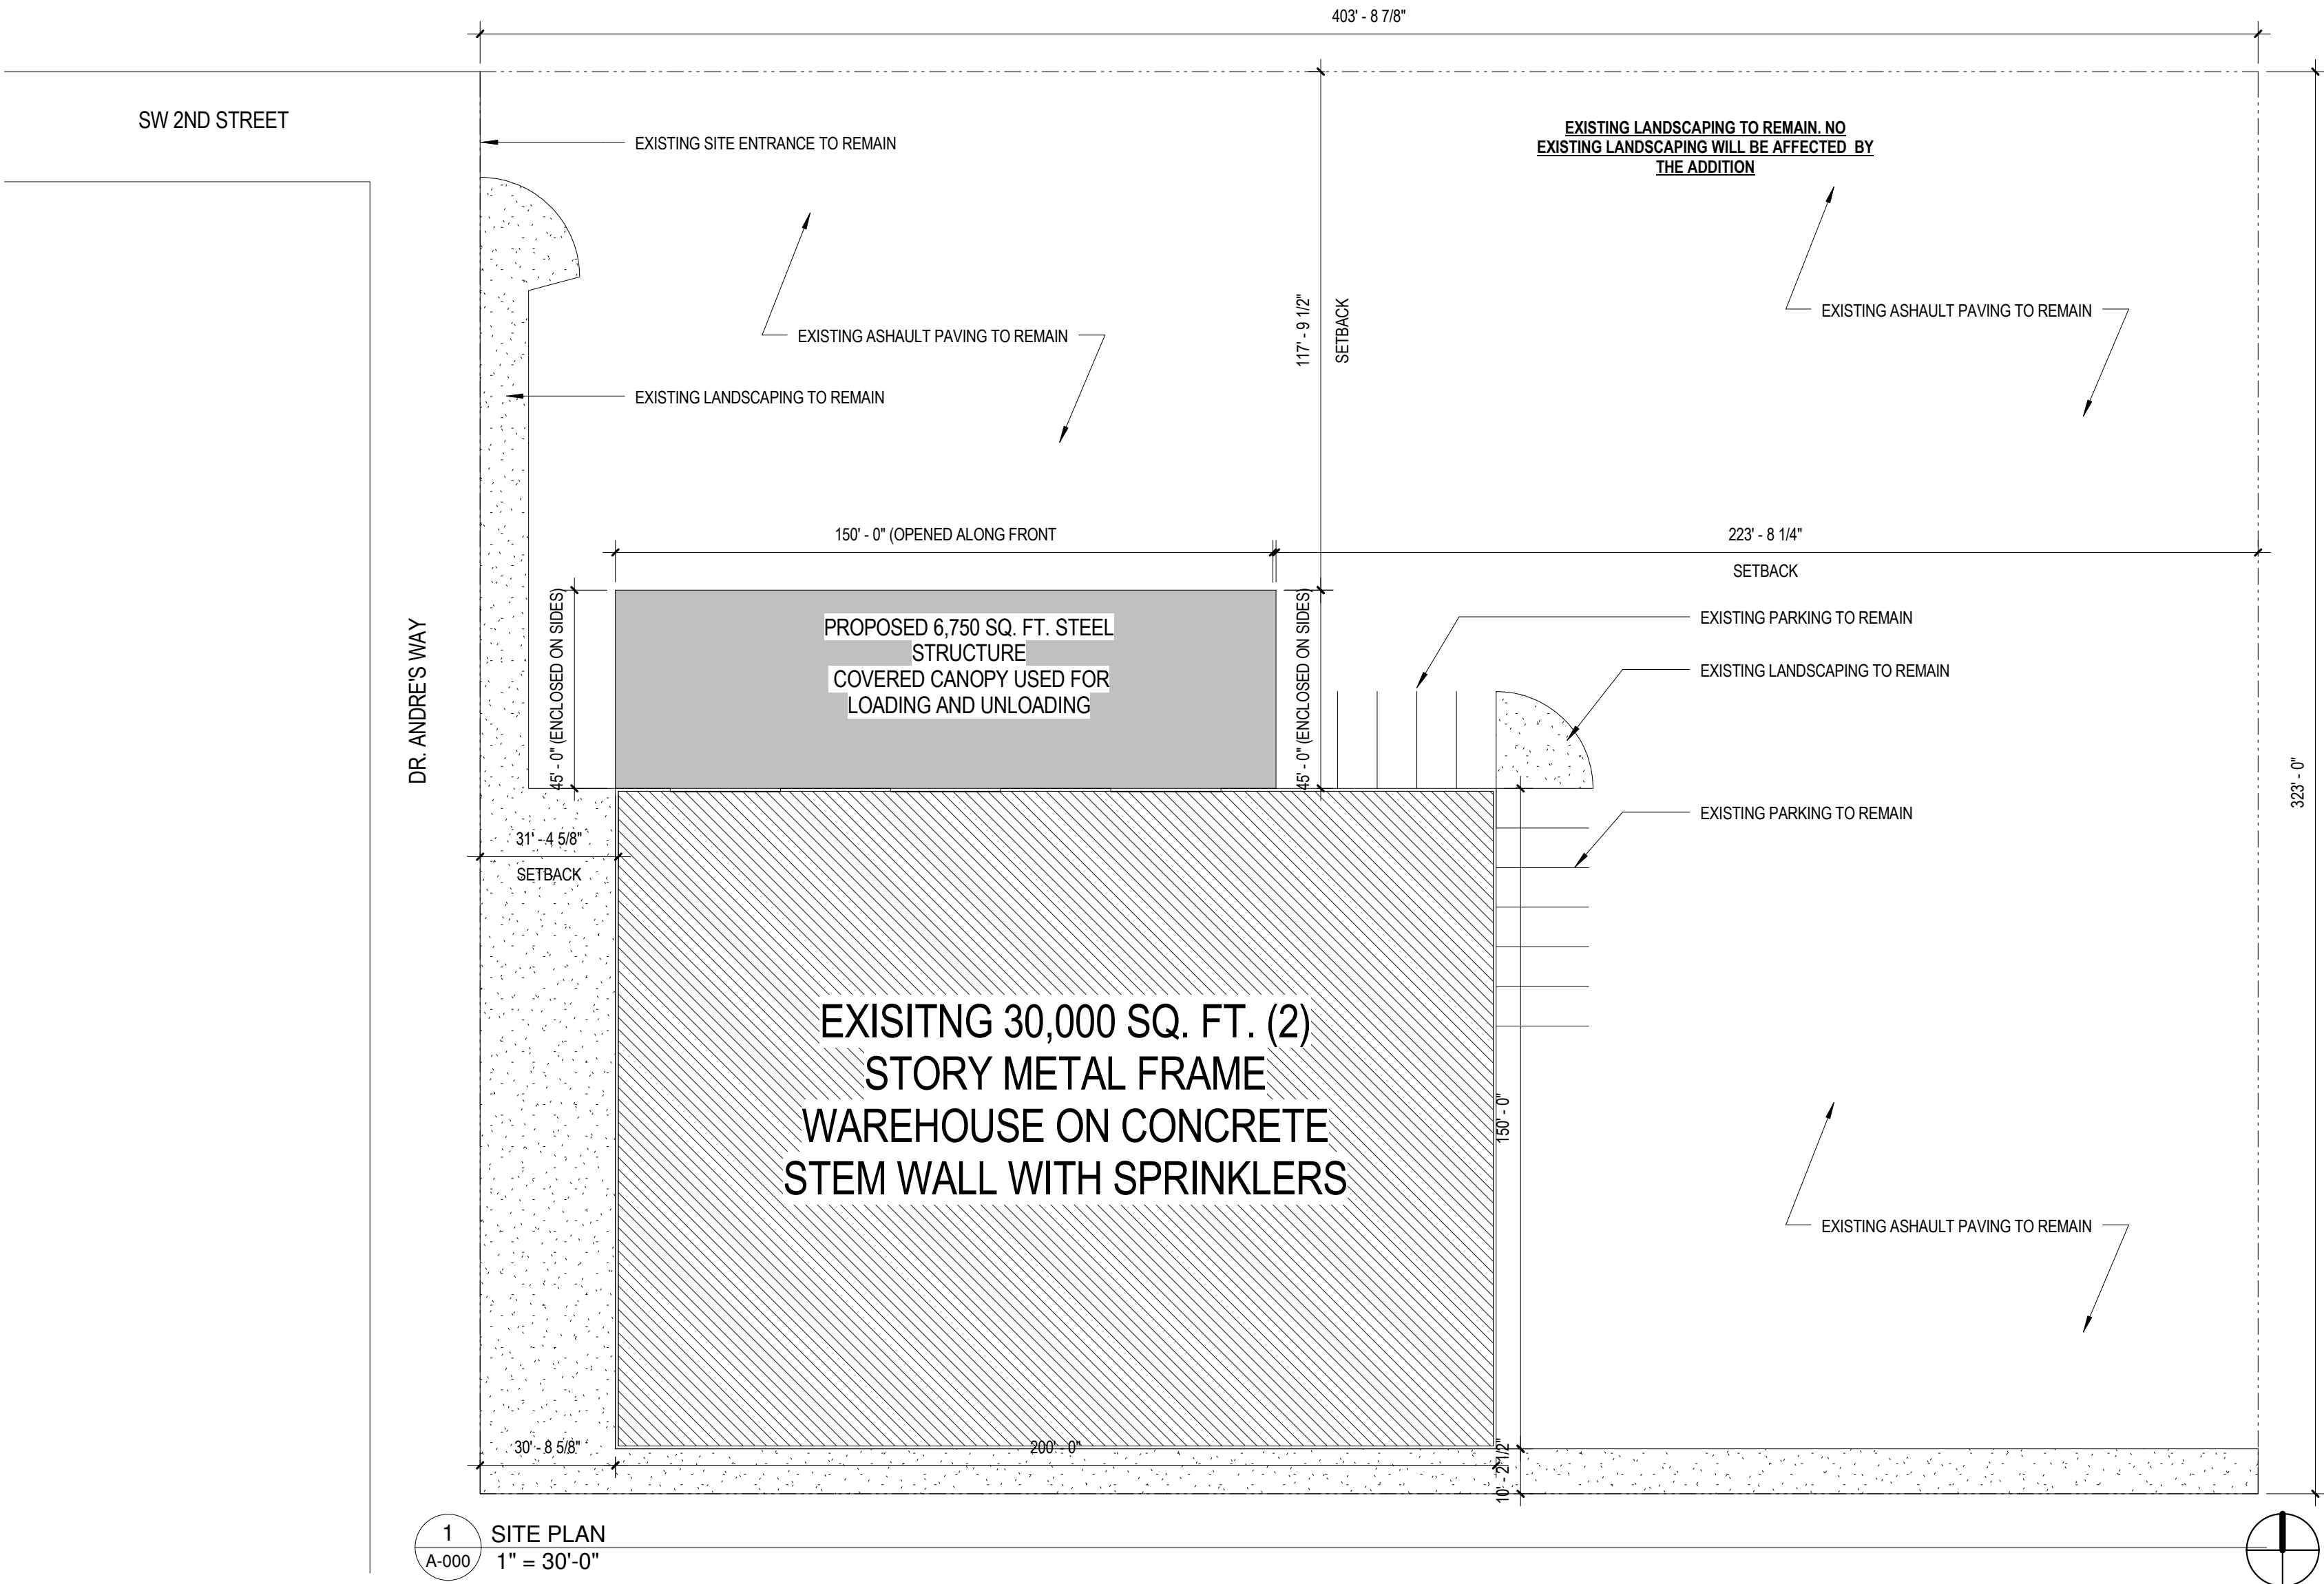

PROJECT REPRESENTATIVES

ARCHITECT OF RECORD

Kyle Sawchuk Architect, PA
The Office of Architecture
2657 Middle River Drive, Suite #1
Fort Lauderdale, FL
33306

Contact: Kyle Sawchuk, RA
Ph. 954.801.1709
email: kpsarchitect@gmail.com

STRUCTURAL ENGINEER

Conemco Consultants
8250 Flager St. Suite 114
Miami, FL 33144

Contact: Jose A. Compres P.E
Ph. 786.888.2002
email: info@conemco.com

CONTRACTOR:

Kyle Sawchuk Architect, PA
The Office of Architecture
2657 Middle River Drive, Suite #1
Fort Lauderdale, FL
33306

Contact: Kyle Sawchuk, RA
Ph. 954.801.1709
email: kpsarchitect@gmail.com

SHEET INDEX

A-000	COVER SHEET & SITE PLAN
S-0	SURVEY
S-1	STRUCTURAL SITE PLAN
A-100	PLANS AND ELEVATIONS
A-101	PHOTOS

PROJECT SCOPE & DATA:

EXTERIOR OPENED AIR 150'-0" X 45'-0" METAL CANOPY ADDITION TO AN EXISTING WAREHOUSE

NO MECHANICAL WORK
NO PLUMBING WORK
NO ELECTRICAL WORK
NO LANDSCAPING WORK

LEGAL DESCRIPTION:

MC EWEN LUMBER SUBD LOT 1

BUILDING DATA:

GOVERNING CODE: INCLUDING BUT NOT LIMITED TO 2014 (5TH ADDITION) FLORIDA BUILDING CODE, 2014 (5TH ADDITION) FLORIDA BUILDING CODE EXISTING BUILDING, AND/OR APPLICABLE LOCAL, STATE, AND FEDERAL CODES HAVING JURISDICTION


OCCUPANCY TYPE: Moderate-hazard storage, Group S-1-LUMBER (**NO CHANGE OF OCCUPANCY USE**)

CLASSIFICATION OF WORK: ADDITION

CONSTRUCTION TYPE: TYPE II-B

COMPLIANCE METHOD OF CONSTRUCTION: WORK AREA
THE BUILDING WILL NOT BE ALTERED OR REPAIRED IN A MANNER THAT RESULTS IN THE BUILDING BEING LESS SAFE THAN SUCH BEING CURRENTLY.

LOCATION MAP: NTS

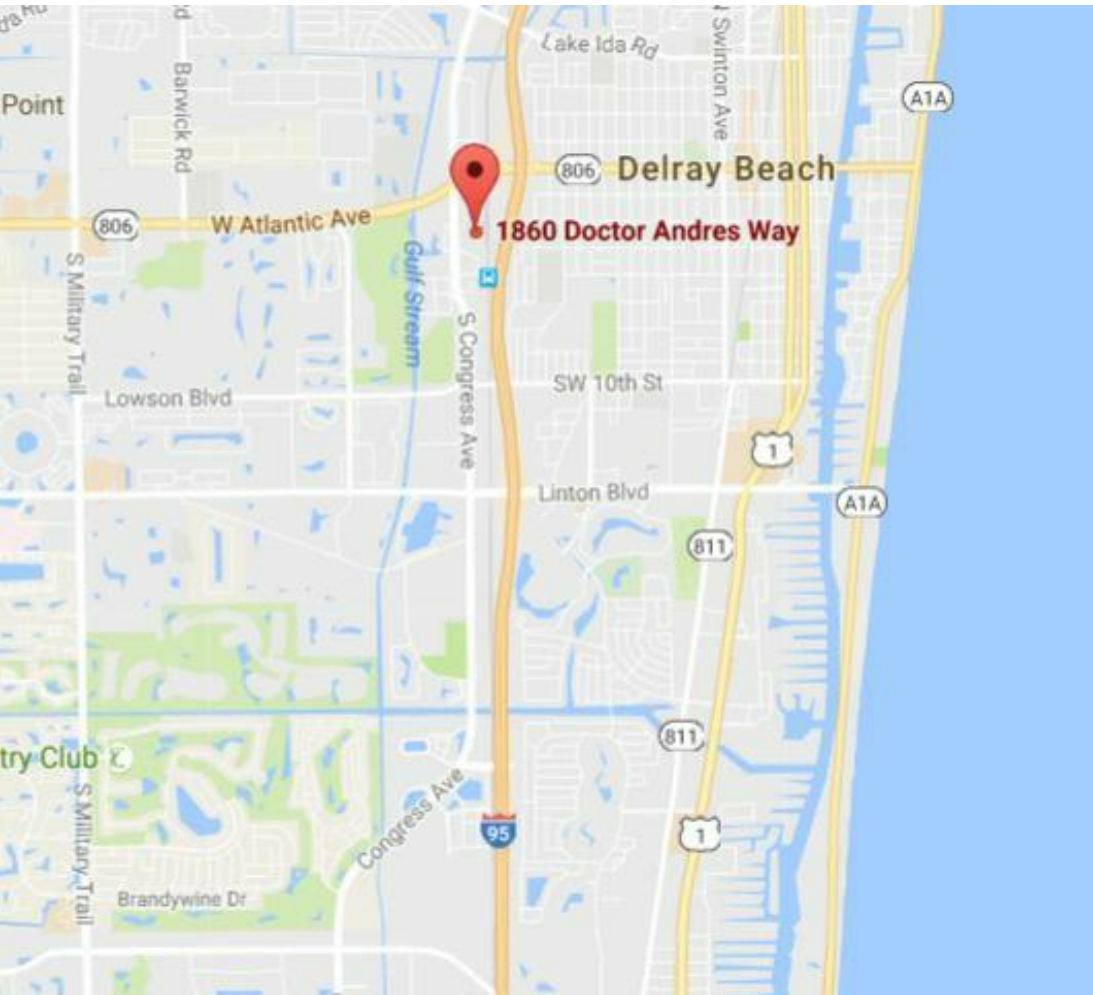

ANNOTATION SYMBOLS

ROOM TAG	BATH	ROOM NAME	DOOR TAG	100
	100	ROOM NUMBER		
PARTITION TAG	1	LEADER TO PARTITION	WINDOW TAG	W1
SPOT ELEVATION	8' - 0"	HEIGHT OFF OF FINISH FLOOR	GRID LINE	Y1
				X1
NORTH ARROW		DIRECTION OF NORTH	ELEVATION CHANGE	
BUILDING SECTIONS	4	A3.20		

KYLE P. SAWCHUK
AR 96356

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2657 MIDDLE RIVER DRIVE
SUITE 1
FORT LAUDERDALE, FL 33306
954.801.1709
AA26002650



RENOVATION FOR:
HOOD DISTRIBUTION

1860 DR. ANDRE'S WAY
DELRAY BEACH, FL
33445

DATE: 01.16.17
NUMBER: 15-033
REVIEWED: KPS
MANAGED: KPS
DRAWN: KPS

REVISION:

COVER SHEET & SITE
PLAN

A-000

BOUNDARY & TOPOGRAPHIC SURVEY

LEGEND OF ABBREVIATIONS:

Δ	=	CENTRAL ANGLE	SQ. FT.	=	ELEVATIONS BASED ON N.G.V.D.
A	=	ARC LENGTH	SQ. FT.	=	SQUARE FEET
CB	=	CHORD BEARING	P.C.P.	=	PERMANENT CONTROL POINT
R	=	RADIUS	P.B.C.R.	=	PALM BEACH COUNTY RECORD:
R/W	=	RIGHT OF WAY	P	=	PLAT
P.C.	=	POINT OF CURVATURE	N&D	=	NAIL & DISC
P.T.	=	POINT OF TANGENCY	P.O.C.	=	POINT OF COMMENCEMENT
WM	=	WATER METER	P.O.B.	=	POINT OF BEGINNING
OH	=	OVERHANG	A/C	=	AIR CONDITIONER
N	=	NORTH	FND.	=	FOUND
S	=	SOUTH	CHATT.	=	CHATTahoochee
E	=	EAST	F.P.L.	=	FLORIDA POWER & LIGHT
W	=	WEST	N.T.S.	=	NOT TO SCALE
CONC.	=	CONCRETE	B.C.R.	=	BROWARD COUNTY RECORDS
D.B.	=	DEED BOOK	D.C.R.	=	DADE COUNTY RECORDS
CLF	=	CHAIN LINK FENCE	P.B.	=	PLAT BOOK
BLVD.	=	BOULEVARD	O.R.B.	=	OFFICIAL RECORDS BOOK
ENCH.	=	ENCH.	F.F.	=	FINISHED FLOOR
I.P.	=	IRON PIPE	CAR.	=	CARAGE
I.R.	=	IRON ROD	CL.	=	CENTERLINE
P.R.M.	=	PERMANENT REFERENCE MONUMENT	MH	=	MANHOLE
N.G.V.D.	=	NATIONAL GEODETIC VERTICAL DATUM	(M)	=	MEASURED
U.E.	=	UTILITY EASEMENT	LP	=	LIGHT POLE
D.E.	=	DRAINAGE EASEMENT	LP	=	CHAIN LINK FENCE
A.E.	=	ANCHOR EASEMENT	W.F.	=	WOOD FENCE
MAINT.	=	MAINTENANCE	M.F.	=	METAL FENCE
ESMT.	=	EASEMENT	P.V.C.	=	PVC FENCE
ELEV.	=	ELEVATION	C.F.	=	CONCRETE FENCE
B.M.	=	BENCHMARK	C.W.	=	CONCRETE WALL
			W.F.	=	WIRE FENCE

STREET ADDRESS:

1860 Dr. Andres Way
Delray Beach, Florida

LEGAL DESCRIPTION:

Lot 1, PLAT OF MCEWEN LUMBER SUBDIVISION, according to the Plat thereof, as recorded in Plat Book 38, Page 143, of the Public Records of Palm Beach County, Florida.

NOTES:

1. Unless otherwise noted field measurements are in agreement with record measurements.
2. Bearings shown hereon are based on a bearing of South 89°15'15" East along the North line of Lot 1, Plat Book 38, Page 143, of the Public Records of Palm Beach County, Florida.
3. The lands shown hereon were not abstracted for ownership, rights of way, easements, or other matters of records by Accurate Land Surveyors, Inc.
4. Ownership of fences and walls if any are not determined.
5. This survey is the property of Accurate Land Surveyors, Inc. and shall not be used or reproduced in whole or in part without written authorization.
6. This survey is made for the exclusive use of the certified hereon, to be valid one year from the date of survey as shown hereon.

FLOOD INFORMATION:

Community name and number: Delray Beach 125102
Map and panel number: 125102-0004-D
Panel date: 01-05-1989
Index date: 01-05-1989
Flood zone: "X"
Base flood elevation: N/A

BENCHMARK INFORMATION:

Palm Beach County Benchmark "GUELIG"
Elevation = 20.226' NGVD1929


CERTIFY TO:

Hood Industries, Inc.

DATE OF FIELD SURVEY: 12-16-16	DRAWN BY: MLW
FIELD BOOK: 16-4230	CHECKED BY: MLW
REVISIONS	DATE BY

CERTIFICATION:
This is to certify that this sketch of boundary survey was made under my responsible charge and is accurate and correct to the best of my knowledge and belief. I further certify that this sketch meets the Standards of Practice, established by the Board of Professional Surveyors and Mappers, Chapter 53-17, Florida Administrative Codes, pursuant to current Section 472.027, Florida Statutes.

ROBERT L. THOMPSON (PRESIDENT)
PROFESSIONAL SURVEYOR AND MAPPER No. 3889 - STATE OF FLORIDA

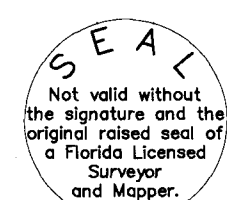

GENERAL CONSTRUCTION NOTES

GENERAL CONDITIONS

THIS SET OF DRAWINGS SHOULD NOT BE SCALED; USE DIMENSIONS AND INFORMATION SHOWN.

PRIOR TO PROCEEDING WITH ANY WORK AND FABRICATION, THE CONTRACTOR SHALL: VERIFY AND COORDINATE WITH ANY ARCHITECTURAL DRAWINGS FOR ALL DIMENSIONS AND ELEVATIONS SHOWN OR NOT SHOWN ON THE STRUCTURAL DRAWINGS. ANY DIMENSIONAL DISCREPANCY FOUND ON THE STRUCTURAL DRAWINGS SHALL BE CONTROLLED BY THE DIMENSIONS INDICATED ON THE ARCHITECTURAL DRAWINGS. CONTRACTOR SHALL FURTHER VERIFY AND CONFIRM WITH THE ARCHITECT AND THE STRUCTURAL ENGINEER FOR RESOLUTION OF SUCH DISCREPANCY.

VERIFY ALL EXISTING CONDITIONS AT THE JOB SITE, PROTECT AND MAINTAIN ALL EXISTING STRUCTURES, UTILITIES, FACILITIES AND THEIR CONTENTS.

REFER TO ARCHITECTURAL AND OTHER DRAWINGS FOR ANY DEMOLITION AND ADJUSTMENT / REMOVAL OF EXISTING FENCE, ANY UNDERGROUND / OVERHEAD UTILITIES.

THE CONTRACTOR SHALL BE RESPONSIBLE FOR ADEQUATE BRACING OF ALL STRUCTURAL MEMBERS, WALLS AND NON STRUCTURAL ITEMS DURING CONSTRUCTION.

REFER TO AND COORDINATE WITH THE CIVIL, ARCHITECTURAL, MECHANICAL, ELECTRICAL AND PLUMBING DRAWINGS FOR UTILITIES, OPENINGS, SLEEVES, ETC. NOT SHOWN ON THE STRUCTURAL DRAWINGS.

EMBEDMENT OF PIPES AND CONDUITS IN CONCRETE SHALL COMPLY WITH THE REQUIREMENTS OF THE CHAPTER SIX (6), SECTION 6.3 ACI-318 LATEST EDITION.

FOR MOUNTING AND SECURING MECHANICAL EQUIPMENT, REFER TO THE MANUFACTURER'S INSTRUCTIONS UNLESS INDICATED ELSEWHERE IN THE CONSTRUCTION DOCUMENTS.

THE GENERAL CONTRACTOR SHALL AT ALL TIMES MAINTAIN AT THE JOBSITE A CURRENT APPROVED SET OF DRAWINGS.

DESIGN CRITERIA

THE STRUCTURAL COMPONENTS FOR THIS PROJECT HAVE BEEN DESIGNED IN COMPLIANCE WITH THE FLORIDA BUILDING CODE (FBC) 2014.

THE FOLLOWING LOADS HAVE BEEN USED FOR THE STRUCTURAL DESIGN OF THE BUILDING:

GRAVITY LOADS:

GROUND FLOOR:
SUPERIMPOSED DEAD LOAD = 30 PSF
LIVE LOAD = 50 PSF

WIND LOADS:
IN ACCORDANCE WITH ASCE 7-10 WITH 3 SECOND SUSTAINED WIND GUSTS.
WIND VELOCITY=175 MPH

EXPOSURE= C
ENCLOSURE CATEGORY: PARTIALLY ENCLOSE (Gcpi = ±0.55)

CONCRETE COVER

MINIMUM CONCRETE COVER TO REINFORCING STEEL IN ACCORDANCE WITH ACI 318-08 AND SHALL BE AS FOLLOW:

ELEMENT:	BOTTOM:	TOP:	SIDE:
FOUNDATION	3"	2"	2"
BEAMS	1 1/2"	1 1/2"	1 1/2"
COLUMNS / WALLS	-	-	1 1/2"
SLAB ON GRADE	2"	1"	-
INT. STRUCT. SLAB	1"	1"	1 1/2"
EXT. STRUCT. SLAB	1"	1 1/2"	1 1/2"

FOUNDATION

FOUNDATIONS HAVE BEEN EVALUATED FOR A SOIL BEARING CAPACITY OF 2,500 PSF AND FINE SAND SOIL TYPE OF SUBSURFACE CONDITION, FROM FLORIDA ENGINEERING & TESTING, INC., JULY 5, 2015.

CONCRETE

SHALL BE A MIX DESIGNED IN ACCORDANCE WITH A.C.I. 301 (LATEST EDITION) TO ACHIEVE A 28-DAY COMPRESSIVE STRENGTH OF 3,000 P.S.I. AND A MAXIMUM WATER-CEMENT RATIO OF 0.40 AND A SLUMP OF 4"± 1".

ALL CONCRETE SHALL CONTAIN AN ENGINEER-APPROVED A.S.T.M. C494 TYPE 'D' ADMIXTURE (WATER-REDUCING RETARDER).

CONCRETE ON EXPOSED BALCONIES, SLABS, BEAMS AND STAIRS SHALL HAVE A TOP SURFACE COATED WITH "ALKYL-ALKYOXY SILANE SEALER" OR ENGINEER-APPROVED EQUAL IN ACCORDANCE WITH MANUFACTURER'S RECOMMENDATIONS. WATER-CEMENT RATIO IN EXPOSED BALCONIES SHALL BE 0.40.

TRANSPORTATION, PLACING, AND CURING OF CONCRETE SHALL COMPLY WITH A.C.I. 318 BUILDING CODE (LATEST EDITION).

ALL CONCRETE STRUCTURAL COMPONENTS SHALL HAVE CONCRETE STRENGTH TESTED IN ACCORDANCE WITH A.S.T.M. STANDARDS, FLORIDA BUILDING CODE 2014 AND ACI 318(LATEST EDITION). TEST CYLINDERS MUST BE TAKEN EVERY 50 CUBIC YARDS OF CONCRETE PRIOR TO PLACEMENT. TESTING LAB SHALL PROVIDE COPIES OF CONCRETE TESTS RESULTS TO ENGINEERS OFFICE FOR REVIEW.

CONCRETE MIX DESIGN SHALL BE SUBMITTED TO ENGINEER'S OFFICE FOR REVIEW.

REINFORCING STEEL

SHALL BE DEFORMED BARS, FREE FROM LOOSE RUST AND SCALE, AND CONFORMING TO A.S.T.M. A615 GRADE 60.

ALL ACCESSORIES SHALL HAVE UPTURNED LEGS, AND BE PLASTIC DIPPED AFTER FABRICATION. ACCESSORIES FOR REINFORCING SHALL BE INSTALLED IN ACCORDANCE WITH A.C.I. 315 CURRENT EDITION.

ALL PLACEMENT OF REINFORCING BARS SHALL BE IN ACCORDANCE WITH THE MANUAL OF STANDARD PRACTICE OF THE CONCRETE REINFORCING STEEL INSTITUTE.

PLASTIC TIPPED COLUMN SPACERS SHALL BE PROVIDED FOR VERTICAL COLUMN REINFORCING STEEL, SUCH THAT A 1 1/2" MINIMUM CLEARANCE IS MAINTAINED.

AS PER FBC 2014 R806.15.1, MASONRY JOINT REINFORCEMENT IN EXTERIOR WALLS OR INTERIOR WALLS EXPOSED TO MOIST ENVIRONMENT AND WEATHER SHALL BE HOT-DIPPED GALVANIZED AND COMPLY WITH ASTM A 153, CLASS B-2

BAR DEVELOPMENT AND LAP SPICE LENGTH CONTRACTOR MAY LAP SPICE STEEL REINFORCING BARS AT LOCATIONS OF HIS CHOOSING EXCEPT FOR THE FOLLOWING:

LONGITUDINAL BEAM TOP BARS AND CONCRETE SLAB TOP BARS SHALL BE SPLICED AT MID SPAN.

1. LONGITUDINAL CONCRETE BEAM BOTTOM BARS AND CONCRETE SLAB BOTTOM BARS SHALL BE SPLICED AT SUPPORT(S).

ALL STEEL REINFORCING LAP SPLICES, UNLESS INDICATED OTHERWISE, SHALL SATISFY THE FOLLOWING:

DEVELOPMENT LENGTH SCHEDULE										
BAR SIZE	#3	#4	#5	#6	#7	#8	#9	#10	#11	
TOP BAR *	1'-6"	2'-2"	2'-8"	3'-3"	4'-8"	5'-2"	5'-10"	6'-6"	7'-2"	
OTHER	1'-3"	1'-8"	2'-1"	2'-6"	3'-6"	4'-0"	4'-6"	5'-0"	5'-6"	

* TOP BAR IS DEFINED AS ANY HORIZONTAL BAR PLACED SUCH MORE THAN 12 INCHES OF CONCRETE IS PLACED BELOW THE BAR IN ANY SINGLE CONCRETE PLACEMENT. CONCRETE WALL HORIZONTAL STEEL REINFORCING BARS ARE CONSIDERED TOP BARS.

STRUCTURAL STEEL

STRUCTURAL STEEL HAS BEEN DESIGNED IN ACCORDANCE WITH THE F.B.C. 2014 AND AISC SPECIFICATIONS (LATEST EDITION).

STRUCTURAL STEEL SHALL MEET THE FOLLOWING REQUIREMENTS UNLESS NOTED OTHERWISE ON THE DRAWINGS:

TYPE	ASTM	GRADE	Fy
ALL STANDAR STEEL SHAPES		A50	50 KSI
STRUCTURAL TUBING	A500	----	46 KSI
ANCHOR BOLTS	A307	----	36 KSI
STRUCTURAL BOLTS	A325	----	
ERECTION BOLTS	A307	----	

CARBON STEEL WELDING SHALL CONFORM TO AWS D1.1-1 WITH AWS A5.1 OR A5.5 ELECTRODES FOR SHOP AND FIELD WELDS, CLASS E70XX.

SUBMIT WELD PROCEDURES AND WELDER CERTIFICATIONS TO CONSTRUCTION MANAGER FOR REVIEW.

ALL WELDING SHALL CONFORM WITH THE A.I.S.C. AND THE AMERICAN WELDING SOCIETY.

AFTER ERECTION, ALL STEEL SHALL BE CLEANED OF ALL RUST, LOOSE MILL SCALE, AND OTHER FOREIGN MATERIAL. SCUFFS AND ABRASIONS SHALL BE FIELD TOUCHED-UP. PROVIDE ONE SHOP COAT OF RUST INHIBITING PAINT MIN. 3 ML. DRY FILM THICKNESS).

THE FABRICATOR IS RESPONSIBLE FOR THE DESIGN OF ALL CONNECTIONS. CONNECTIONS SHOWN ON THE STRUCTURAL DRAWINGS ARE SCHEMATIC AND ARE ONLY INTENDED TO SHOW THE RELATIONSHIP OF MEMBERS CONNECTED CONNECTION DETAILS INDICATED ON THE DRAWINGS SHALL BE INCORPORATED INTO FABRICATOR'S CONNECTION DESIGN. ALL SHOP DRAWINGS SHALL BE SIGNED AND SEALED BY THE FABRICATOR'S ENGINEER WITH THE ENGINEER'S SEAL FOR THE STATE WHERE THE STRUCTURE IS LOCATED.

ENGINEER'S SEAL MAY BE QUALIFIED "FOR DESIGN OF CONNECTIONS ONLY." DELEGATED FLORIDA REGISTERED ENGINEER MUST SUBMIT SIGNED AND SEALED CALCULATIONS AND DRAWINGS TO THIS OFFICE FOR REVIEW AND APPROVAL PRIOR TO THE FABRICATION OF STEEL FRAMING AND CONNECTIONS.

STRUCTURAL STEEL SHALL BE PAINTED IN ACCORDANCE WITH SPECIFICATIONS. IF COATING NOT SPECIFIED, PROVIDE SHOP COAT COMPATIBLE PRIMER AND (2) FIELD COATS EPOXY (INDOORS) OR URETHANE (OUTDOORS) PAINT.

MODIFICATIONS OF EXISTING STRUCTURES

NEW CONCRETE TO EXISTING:

EXISTING CONCRETE SURFACES TO BE JOINED WITH NEW CONCRETE SHALL BE THOROUGHLY CLEANED AND ROUGHENED BY SANDBLASTING TO A 1/4" AMPLITUDE. COAT WITH EPOXY BONDING COMPOUND JUST PRIOR TO PLACEMENT OF NEW CONCRETE.

CUTS ON EXPOSED SURFACE:

SURFACES EXPOSED TO VIEW SHALL BE NEATLY SAW CUT TO A DEPTH OF 1" PRIOR TO REMOVING THE EXISTING CONCRETE. STOP SAWCUTS AT CORNERS, DO NOT CUT PAST (USE NEAT CHIPPING).

DOWELED REINFORCING STEEL:


DOWELS SHALL BE INSTALLED USING ADHESIVE. WHEN ADHESIVE HOLES ARE HORIZONTAL, THE HOLES SHALL BE DRILLED SLIGHTLY DOWNWARD (APPROX. 15 DEGREE). WHEN OVERHEAD HOLES ARE REQUIRED, CAPSULE ANCHOR ADHESIVE SHALL BE USED. CONTRACTOR TO CONFIRM THERE IS NO CONFLICT FOR DRILLING.

OPENING IN EXISTING CONCRETE:


NEW OPENINGS IN EXISTING CONCRETE SHALL BE CUT OVERSIZED AS SHOWN ON ARCHITECTURAL DRAWINGS AND SCHEDULES, COATED WITH EPOXY BONDING COMPOUND AND FINISHED TO THE REQUIRED OPENING SIZE WITH PROFILING MORTAR.

CONCRETE SURFACE PATCHING:

WHERE EXISTING CONCRETE OR MASONRY IS REMOVED FROM SLABS AND WALLS TO REMAIN, PATCH SURFACE WHERE EXPOSED AS FOLLOWS: CHIP DOWN 3/8" INCH MINIMUM BELOW ADJACENT SURFACE AND LEAVE ROUGH. CLEAN SURFACE, APPLY BONDING AGENT AND FINISH SURFACE TO MATCH ADJACENT WITH POLYMER CONCRETE.

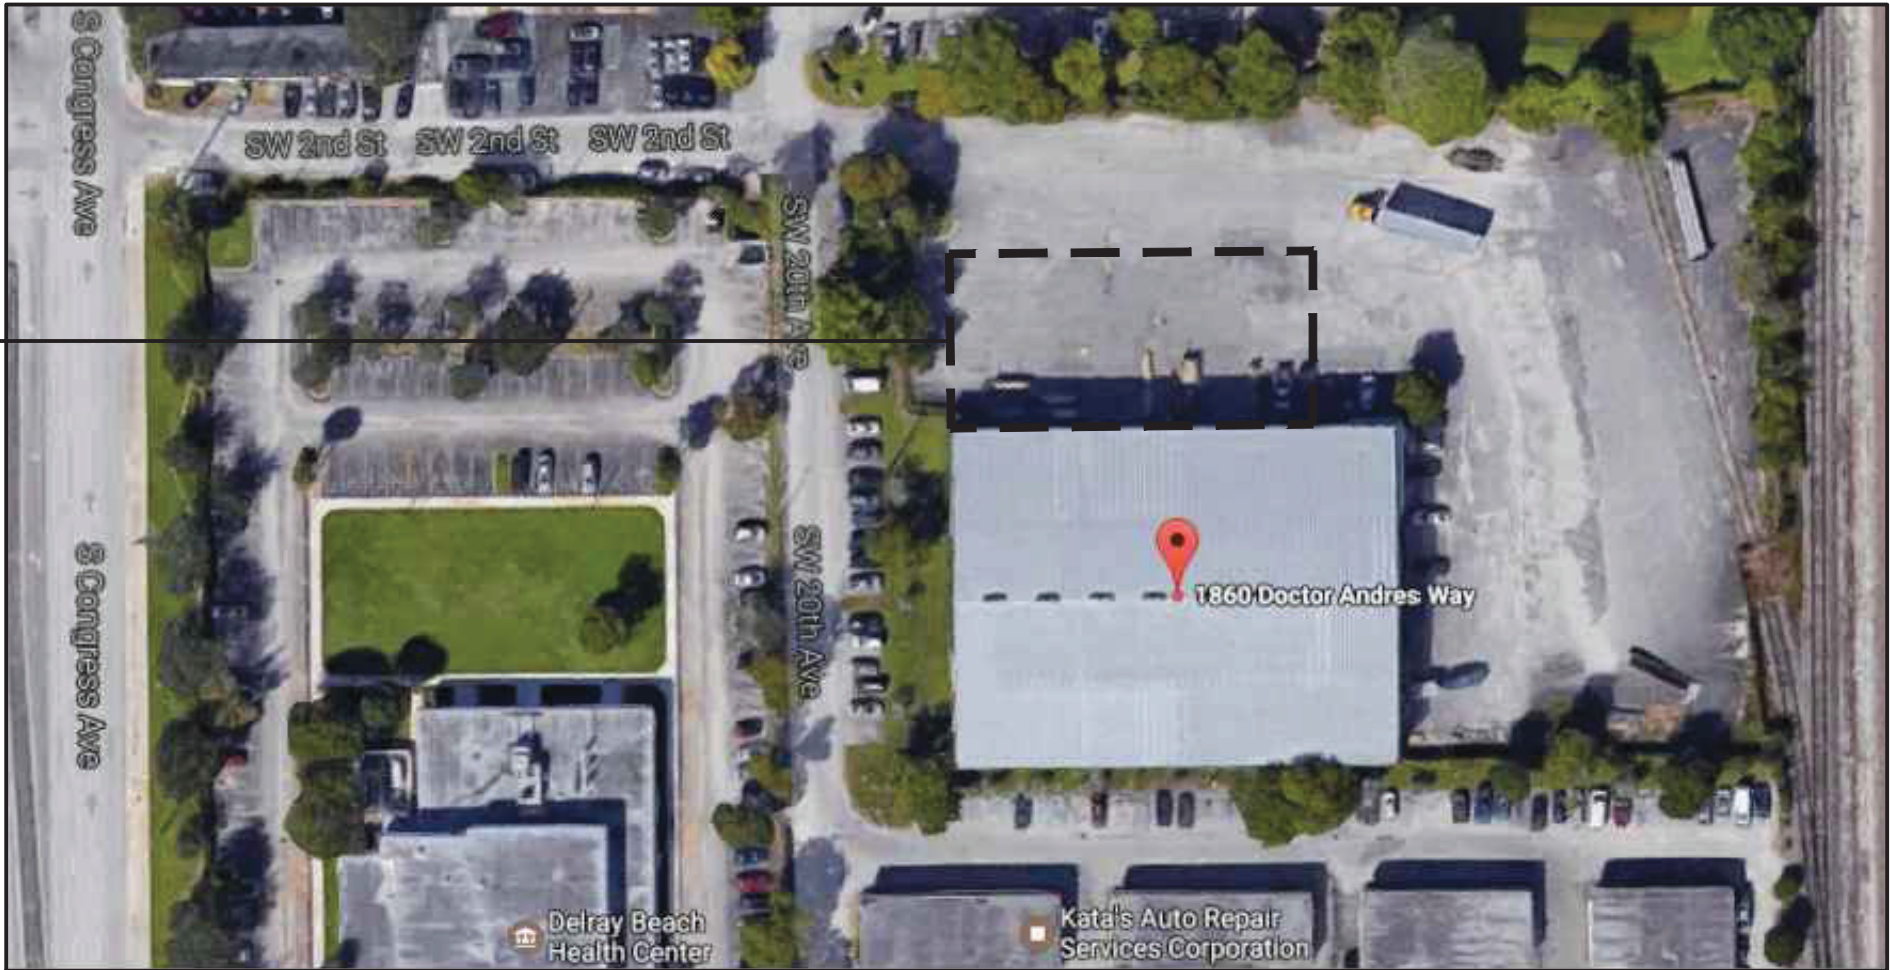

LOCATION MAP
SCALE: N.T.S

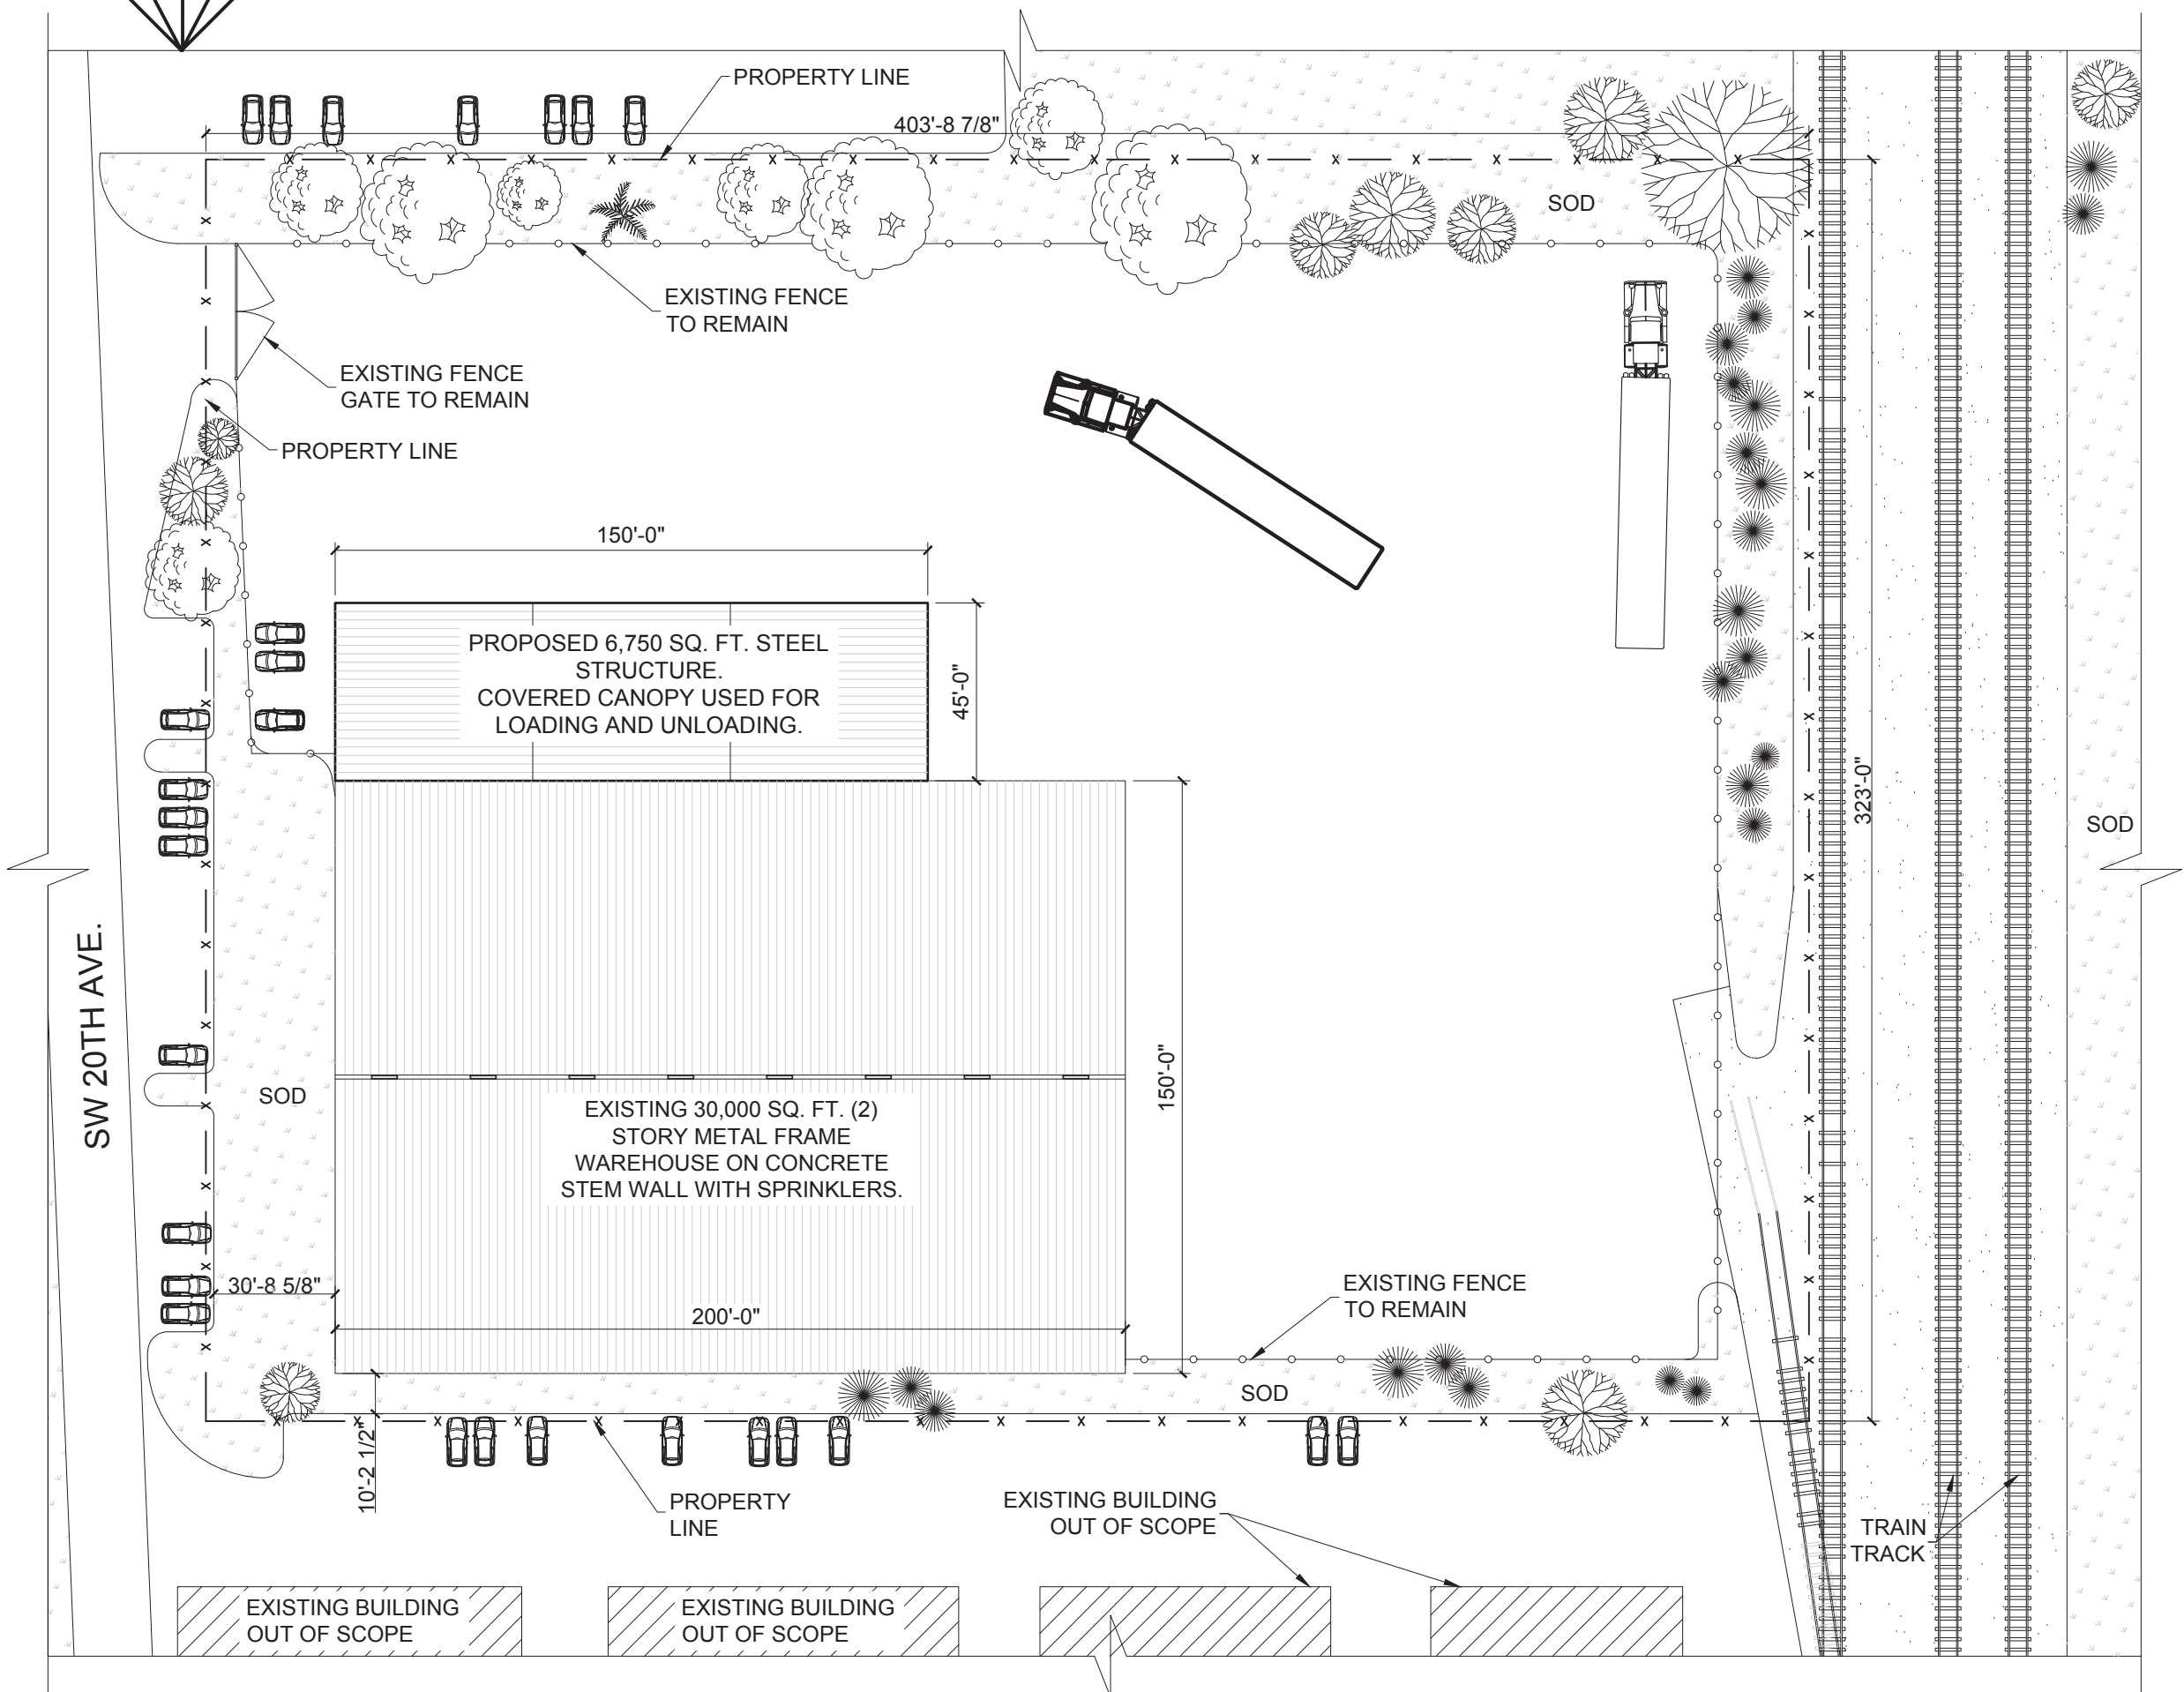

SITE PLAN
SCALE: N.T.S

SCOPE OF WORK

- 1- PROVIDE SCHEMATIC VIEWS OF THE NEW CANOPY TO PRESENT CALCULATED DESIGN LOADS ON EACH STRUCTURAL ELEMENT.
- 2- PROVIDE THE FOUNDATION PLAN AND ITS SPECIFICATIONS.

DRAWING LIST

- S-1: GENERAL NOTES
- S-2: FOUNDATION PLAN
- S-3: GROUND FLOOR PLAN & ROOF PLAN
- S-4: SECTIONS



6250 FLAGLER ST SUITE 114
MIAMI, FLORIDA 33144
PHONE 786-688-2002

CA # 29447
SEAL

JOSE A COMPRES, P.E.
FLORIDA P.E. LIC. # 65557

KYLE P. SAWCHUK
AR 96356

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2657 MIDDLE RIVER DRIVE
SUITE 1
FORT LAUDERDALE, FL
33306
954.801.1709
AA26002650



CLIENT:
HOOD INDUSTRIES


1860 DR. ANDRES WAY,
DELRAY BEACH, FL
33445







DATE: 12.09.16
NUMBER:
REVIEWED: JM
MANAGED: JC
DRAWN: MC

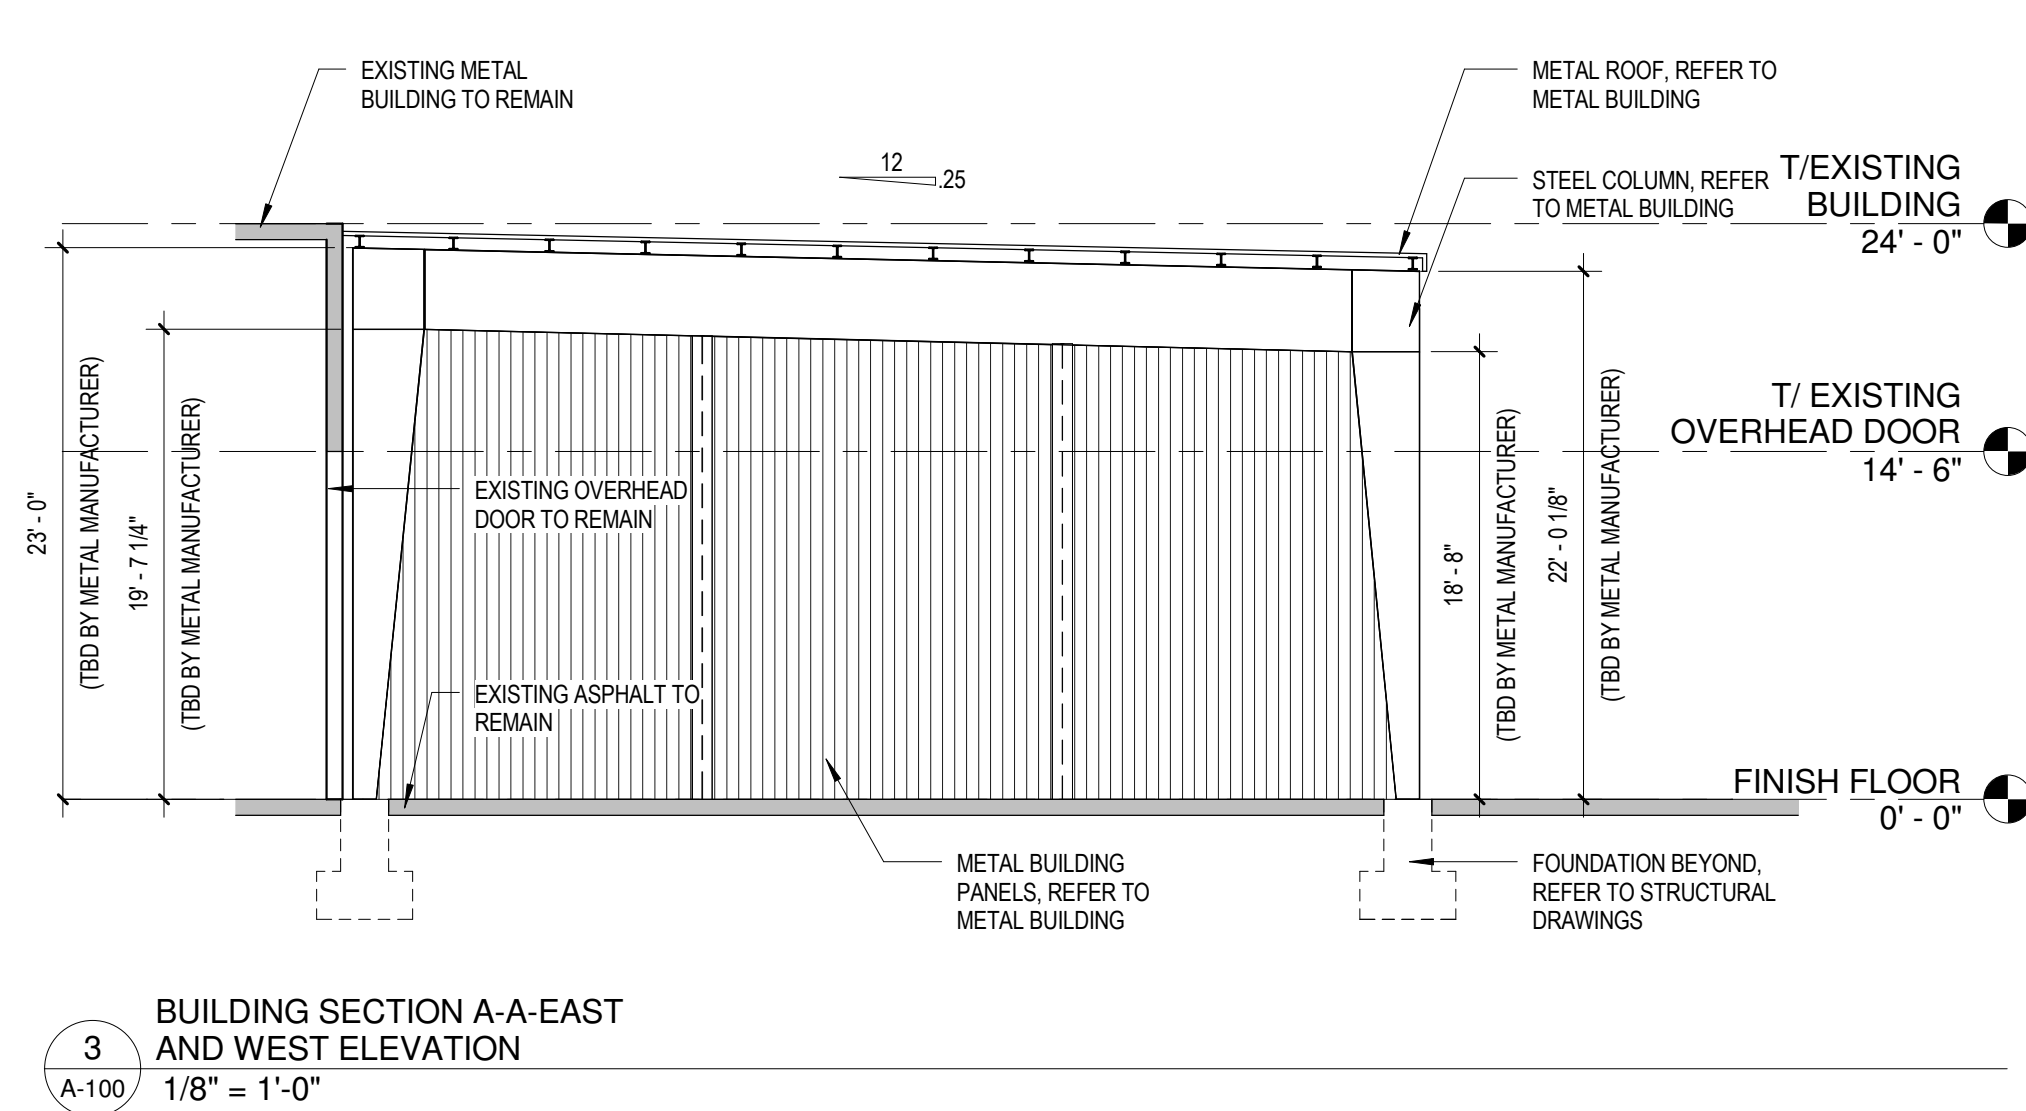REVISION:

GENERAL NOTES

S - 1



	EXISTING TO REMAIN		NEW CMU WALL
	WALL TO BE REMOVED		FIRE RATED WALL-TYPE "X" GYPSUM
	NEW STUD WALL		NEW WET WALL-CEMENT BOARD



EXISTING NORTH ELEVATION WHERE CANOPY IS GOING



EXISTING NORTH ELEVATION WHERE CANOPY IS GOING



ENTRANCE TO SITE



EXISTING NORTH-WEST ELEVATION



EXISTING EAST ELEVATION



NEIGHBOR TO THE NORTH



NEIGHBOR TO THE SOUTH

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AR 96356

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2657 MIDDLE RIVER DRIVE
SUITE 1
FORT LAUDERDALE, FL 33306
954.801.1709
AA26002650



RENOVATION FOR:
HOOD DISTRIBUTION

1860 DR. ANDRE'S WAY
DELRAY BEACH, FL
33445

DATE: 01.16.17
NUMBER: 15-033
REVIEWED: KPS
MANAGED: KPS
DRAWN: KPS

REVISION:

PHOTOS

HOOD DISTRIBUTION

EXTERIOR RENDERINGS



