## SITE PLAN REVIEW AND APPEARANCE BOARD CITY OF DELRAY BEACH ---STAFF REPORT---


MEETING DATE: November 30, 2016


ITEM:

Seaglass Cottages (104 Andrews Avenue) – Class V Site Plan associated with demolition of an existing single family residence and construction of a three-story 5-unit fee simple townhome development with a swimming pool and 2-car garage serving each unit.


**RECOMMENDATION:** Approve the Class V Site Plan, Landscape Plan and Architectural Elevations, subject to conditions.

| GENERAL DATA:          |  |
|------------------------|--|
| Agent                  | Richard Jones Architecture   |
| Applicant              | Seaside Builders   |
| Owner                  | Gregorski 17 LLC   |
| Property Size          | 19,440 sq. ft. (0.446 acre)  |
| Future Land Use Map    | MD (Medium Density Residential –<br>5 to 12 Dwelling Units Per Acre) |
| Current Zoning         | RM (Multiple Family Residential -<br>Medium Density)                 |
| Adjacent Zoning North: | RM (Multiple Family Residential -<br>Medium Density)                 |
| South:                 | RM (Multiple Family Residential -<br>Medium Density)                 |
| East:                  | RM (Multiple Family Residential -<br>Medium Density)                 |
| West:                  | R-1-AAA (Single Family Residential)                                  |
| Existing Land Use      | Single Family Residential  |
| Proposed Land Use      | Multiple Family Residential  |
| Water Service          | Existing on site   |
| Sewer Service          | Existing on site   |

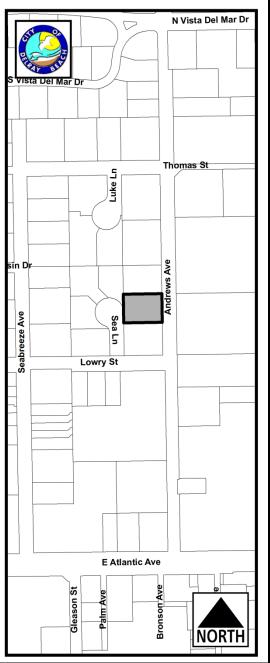

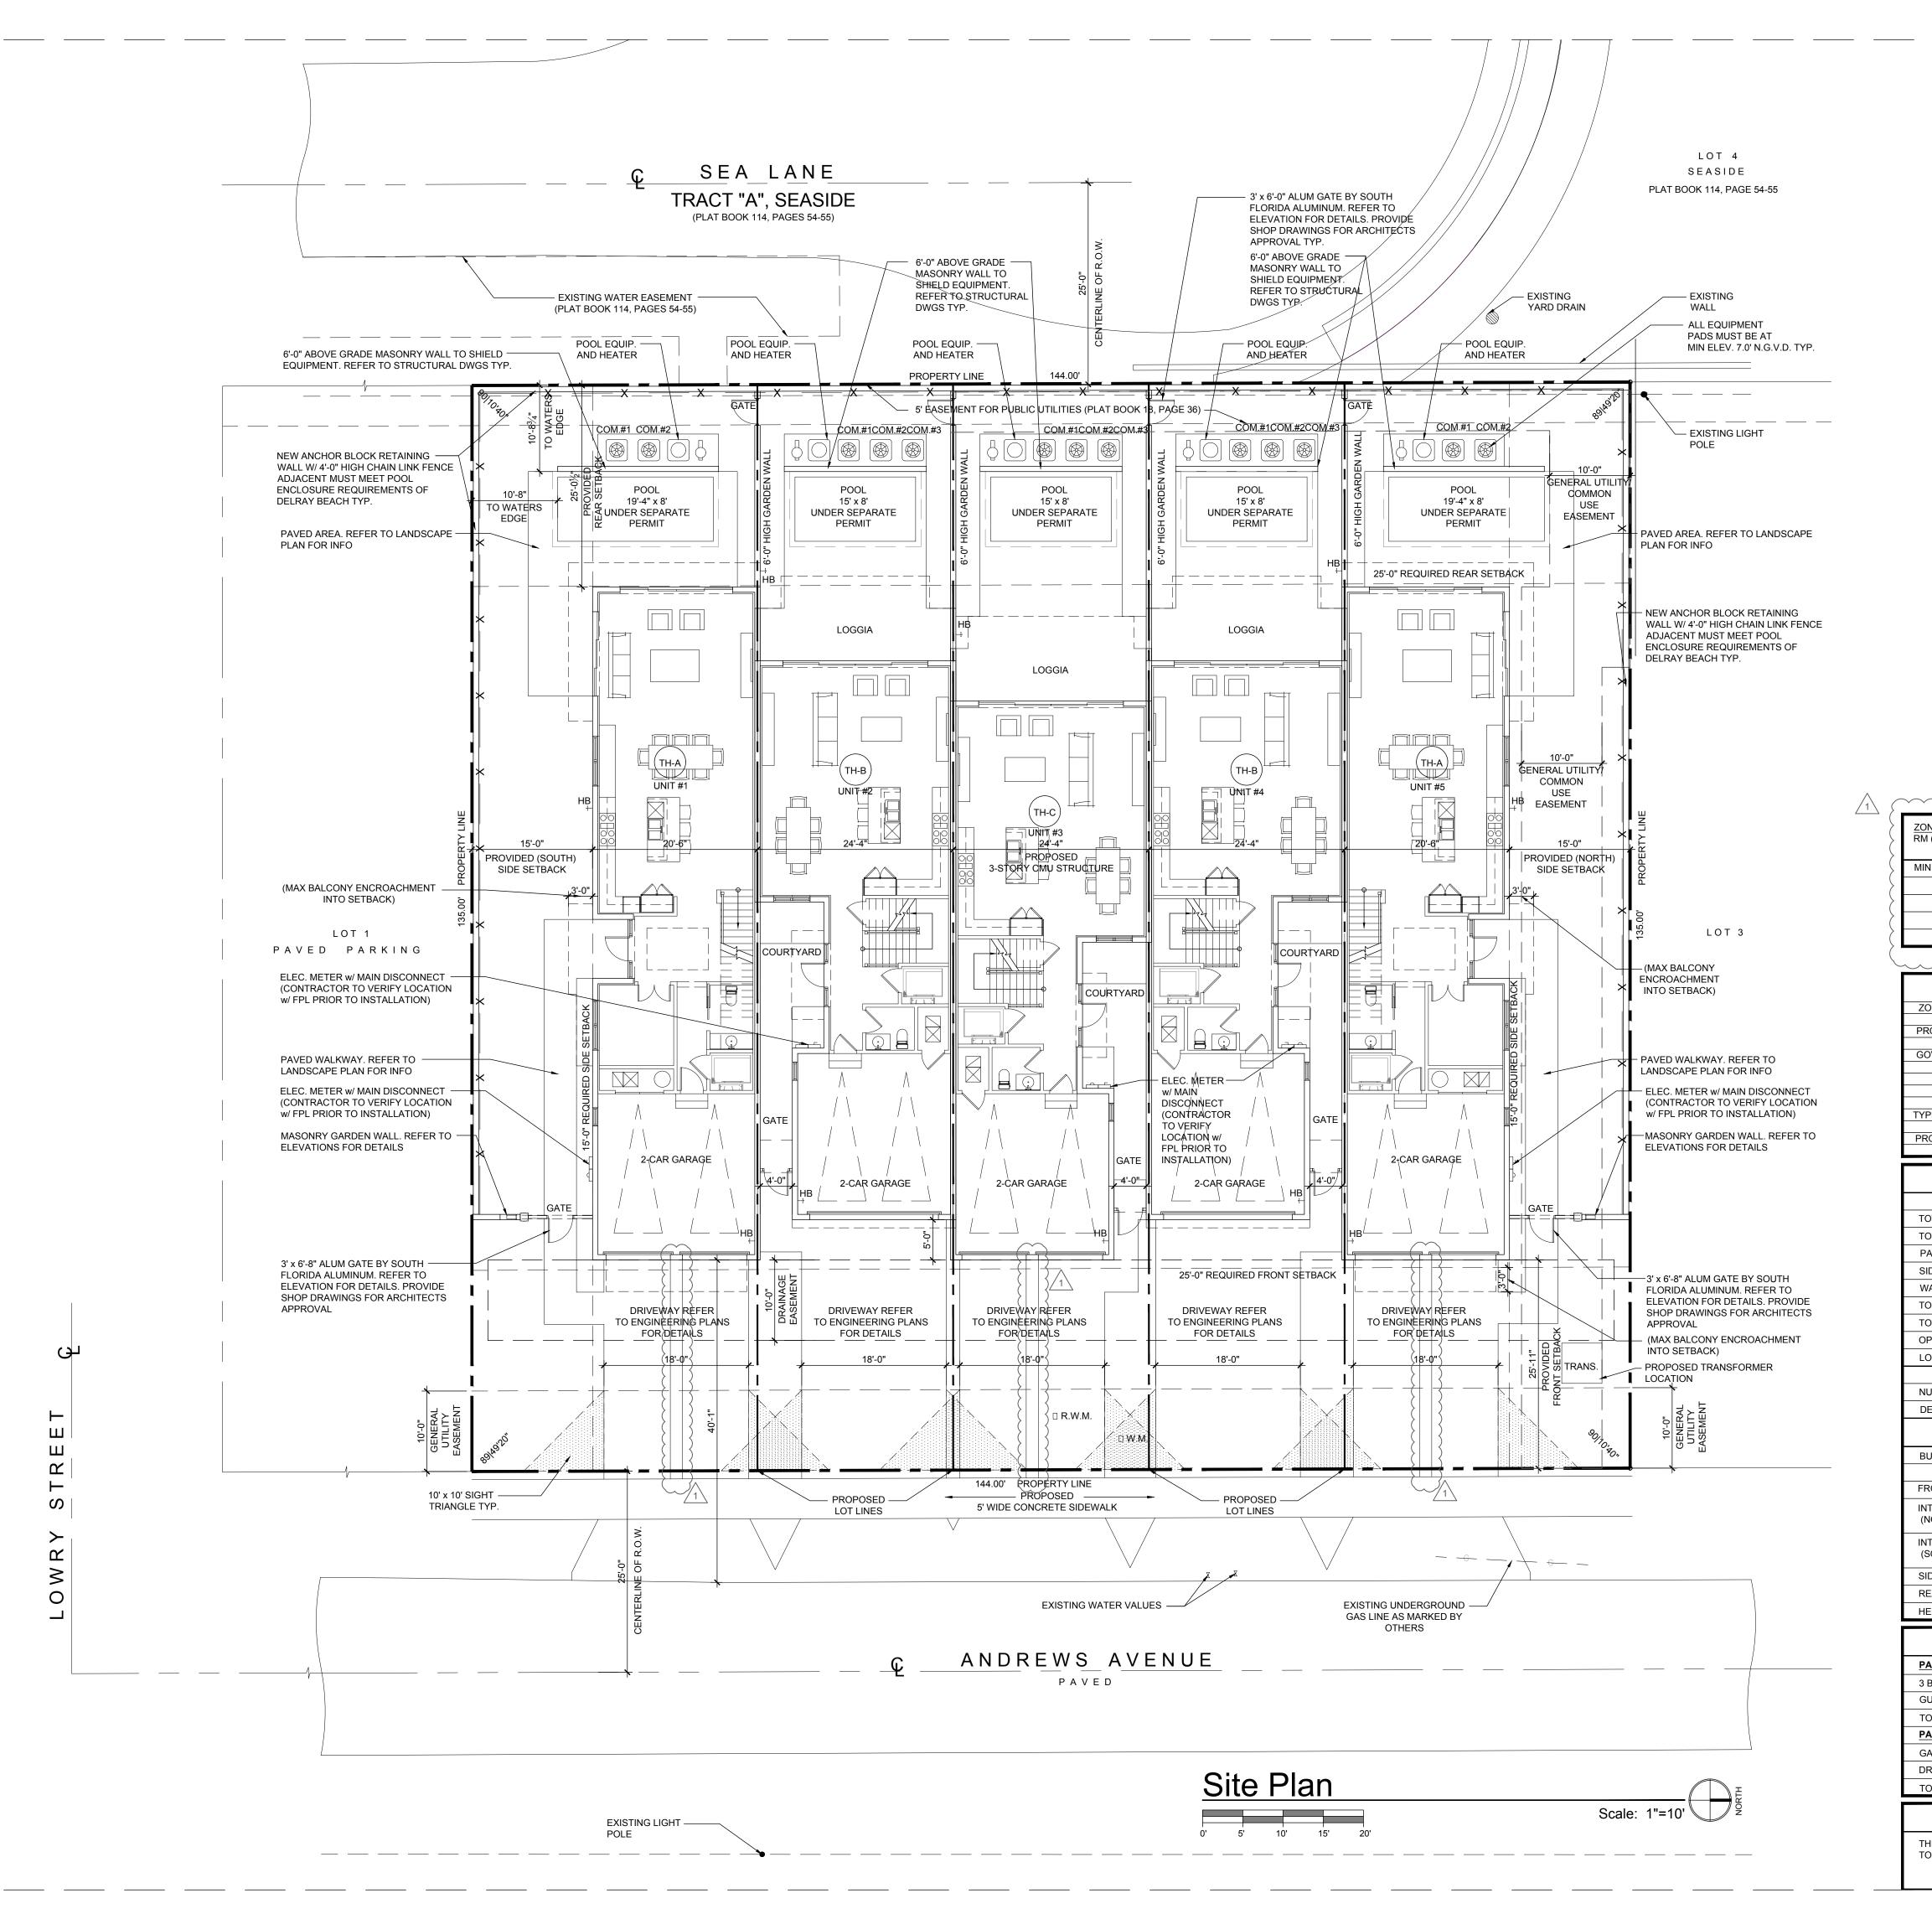

|  |  |   |  |   | RICHARD<br>ARCHITEC   | ZTURE<br>JE   SUITE 102<br>ORIDA 33444<br>561.274.9196<br>326001056            | ()<br>JURE            |
|--|--|---|--|---|---|--|-----------------------|
| VING<br>(MEDIUM DENSITY-   |  | 7 RESIDENTIAL)<br>3BR (UNIT 1)<br>3BR (UNIT 2)<br>3BR (UNIT 3)<br>3BR (UNIT 4)  | REQUIRED<br>1,250 SQ.FT.<br>1,250 SQ.FT.<br>1,250 SQ.FT.<br>1,250 SQ.FT.<br>1,250 SQ.FT.   | PROPOSED<br>3,702 SQ.FT.<br>4,981 SQ.FT.<br>4,488 SQ.FT.<br>4,981 SQ.FT.                  | SEAGLASS COTTAGES<br>SEAGLASS COTTAGES<br>104 ANDREWS AVE<br>DELRAY BEACH, FLORIDA                              | SEASIDE BUILDERS<br>185 NE 4TH AVENUE SUITE#104<br>DELRAY BEACH, FLORIDA 33483 | ARCHITE               |
| DNING DESIGNATION<br>OPOSED PROJECT:<br>DVERNING CODES:<br>DVERNING PAVED ARE/<br>DEWALKS/POOL DEC<br>DVERNING PAVED ARE/<br>DVERNING PAVED | DN:<br>DN:<br>PRINT<br>A<br>DKS<br>REA<br>A  | RM-ME<br>PROP(<br>FLORII<br>FLORII<br>NFPA<br>NFPA<br>TYPE<br>104 AN<br>DELRA   | DA BUILDING COD  | WN HOME BUILDING<br>E-2014 EDITION<br>ION CODE-2015 EDITION<br>12 EDITION<br>2012 EDITION | FLORIDA L FLORIDA L AA26001617   IE COMMISSION # DESIGNER: DRAWN BY: PLAN REVIEW: SUBMITTALS: ISSUED FOR PERMIT |  | S<br>H<br>Z<br>O<br>D |
| JILDING SETBACKS F<br>CONT<br>TERIOR SIDE<br>IORTH SIDE)<br>TERIOR SIDE<br>COUTH SIDE)<br>DE STREET<br>EAR<br>EIGHT<br>ARKING REQUIRED<br>BEDROOM UNIT : CA<br>JEST PARKING: FOR<br>DTAL REQUIRED = 1:<br>ARKING PROVIDED<br>ARAGE:<br>RIVEWAY:<br>DTAL:   | PURSUANT TO CIT<br>REQUIRED<br>25'/30'<br>15'/30'<br>25'/30'<br>25'-0"<br>35'-0"<br>F<br>LCULATED AT 2 SI<br>THE FIRST 20 UN<br>2.5 SPACES<br>= 10 S<br>= 10 S<br>= 20 S | TY ZONING CODES<br>PROV<br>25'-11"<br>15'-0"/<br>15'-0"/<br>25'-0<br>35'-<br>PARKING E<br>PACES PER UNIT =<br>IT 0.5 SPACES PER<br>SPACES<br>SPACES - FULL SIZ<br>SPACES - NO COM | VIDED<br>/30'-0"<br>35'-2"<br>A<br>0 1/2"<br>-0"<br>BREAKDOV<br>SREAKDOV<br>E 5 x 2= 10 SPACES<br>R UNIT = 5 x 0.5 = 2.<br>ZE 18' X 9'<br>PACT<br>SCRIPTIO | 11.20 NOTES NOTES NOTES NOTES NOTES   | REVISIONS:<br>1. SPRAB<br>COMMENTS<br>SITE PI<br>SITE PI  |  | ZIO HAR               |
| IE NORTH 19 FEET OF LOT 1, ALL OF LOT 2, AND THE SOUTH 50 FEET OF LOT 3 OF OCEAN BREEZE ESTATES, ACCORDING<br>THE PLAT THEREOF, RECORDED IN PLAT BOOK 18, PAGE 36, PUBLIC RECORDS OF PALM BEACH COUNTY, FLORIDA.   |  |   |  |   |   | ·I   |                       |

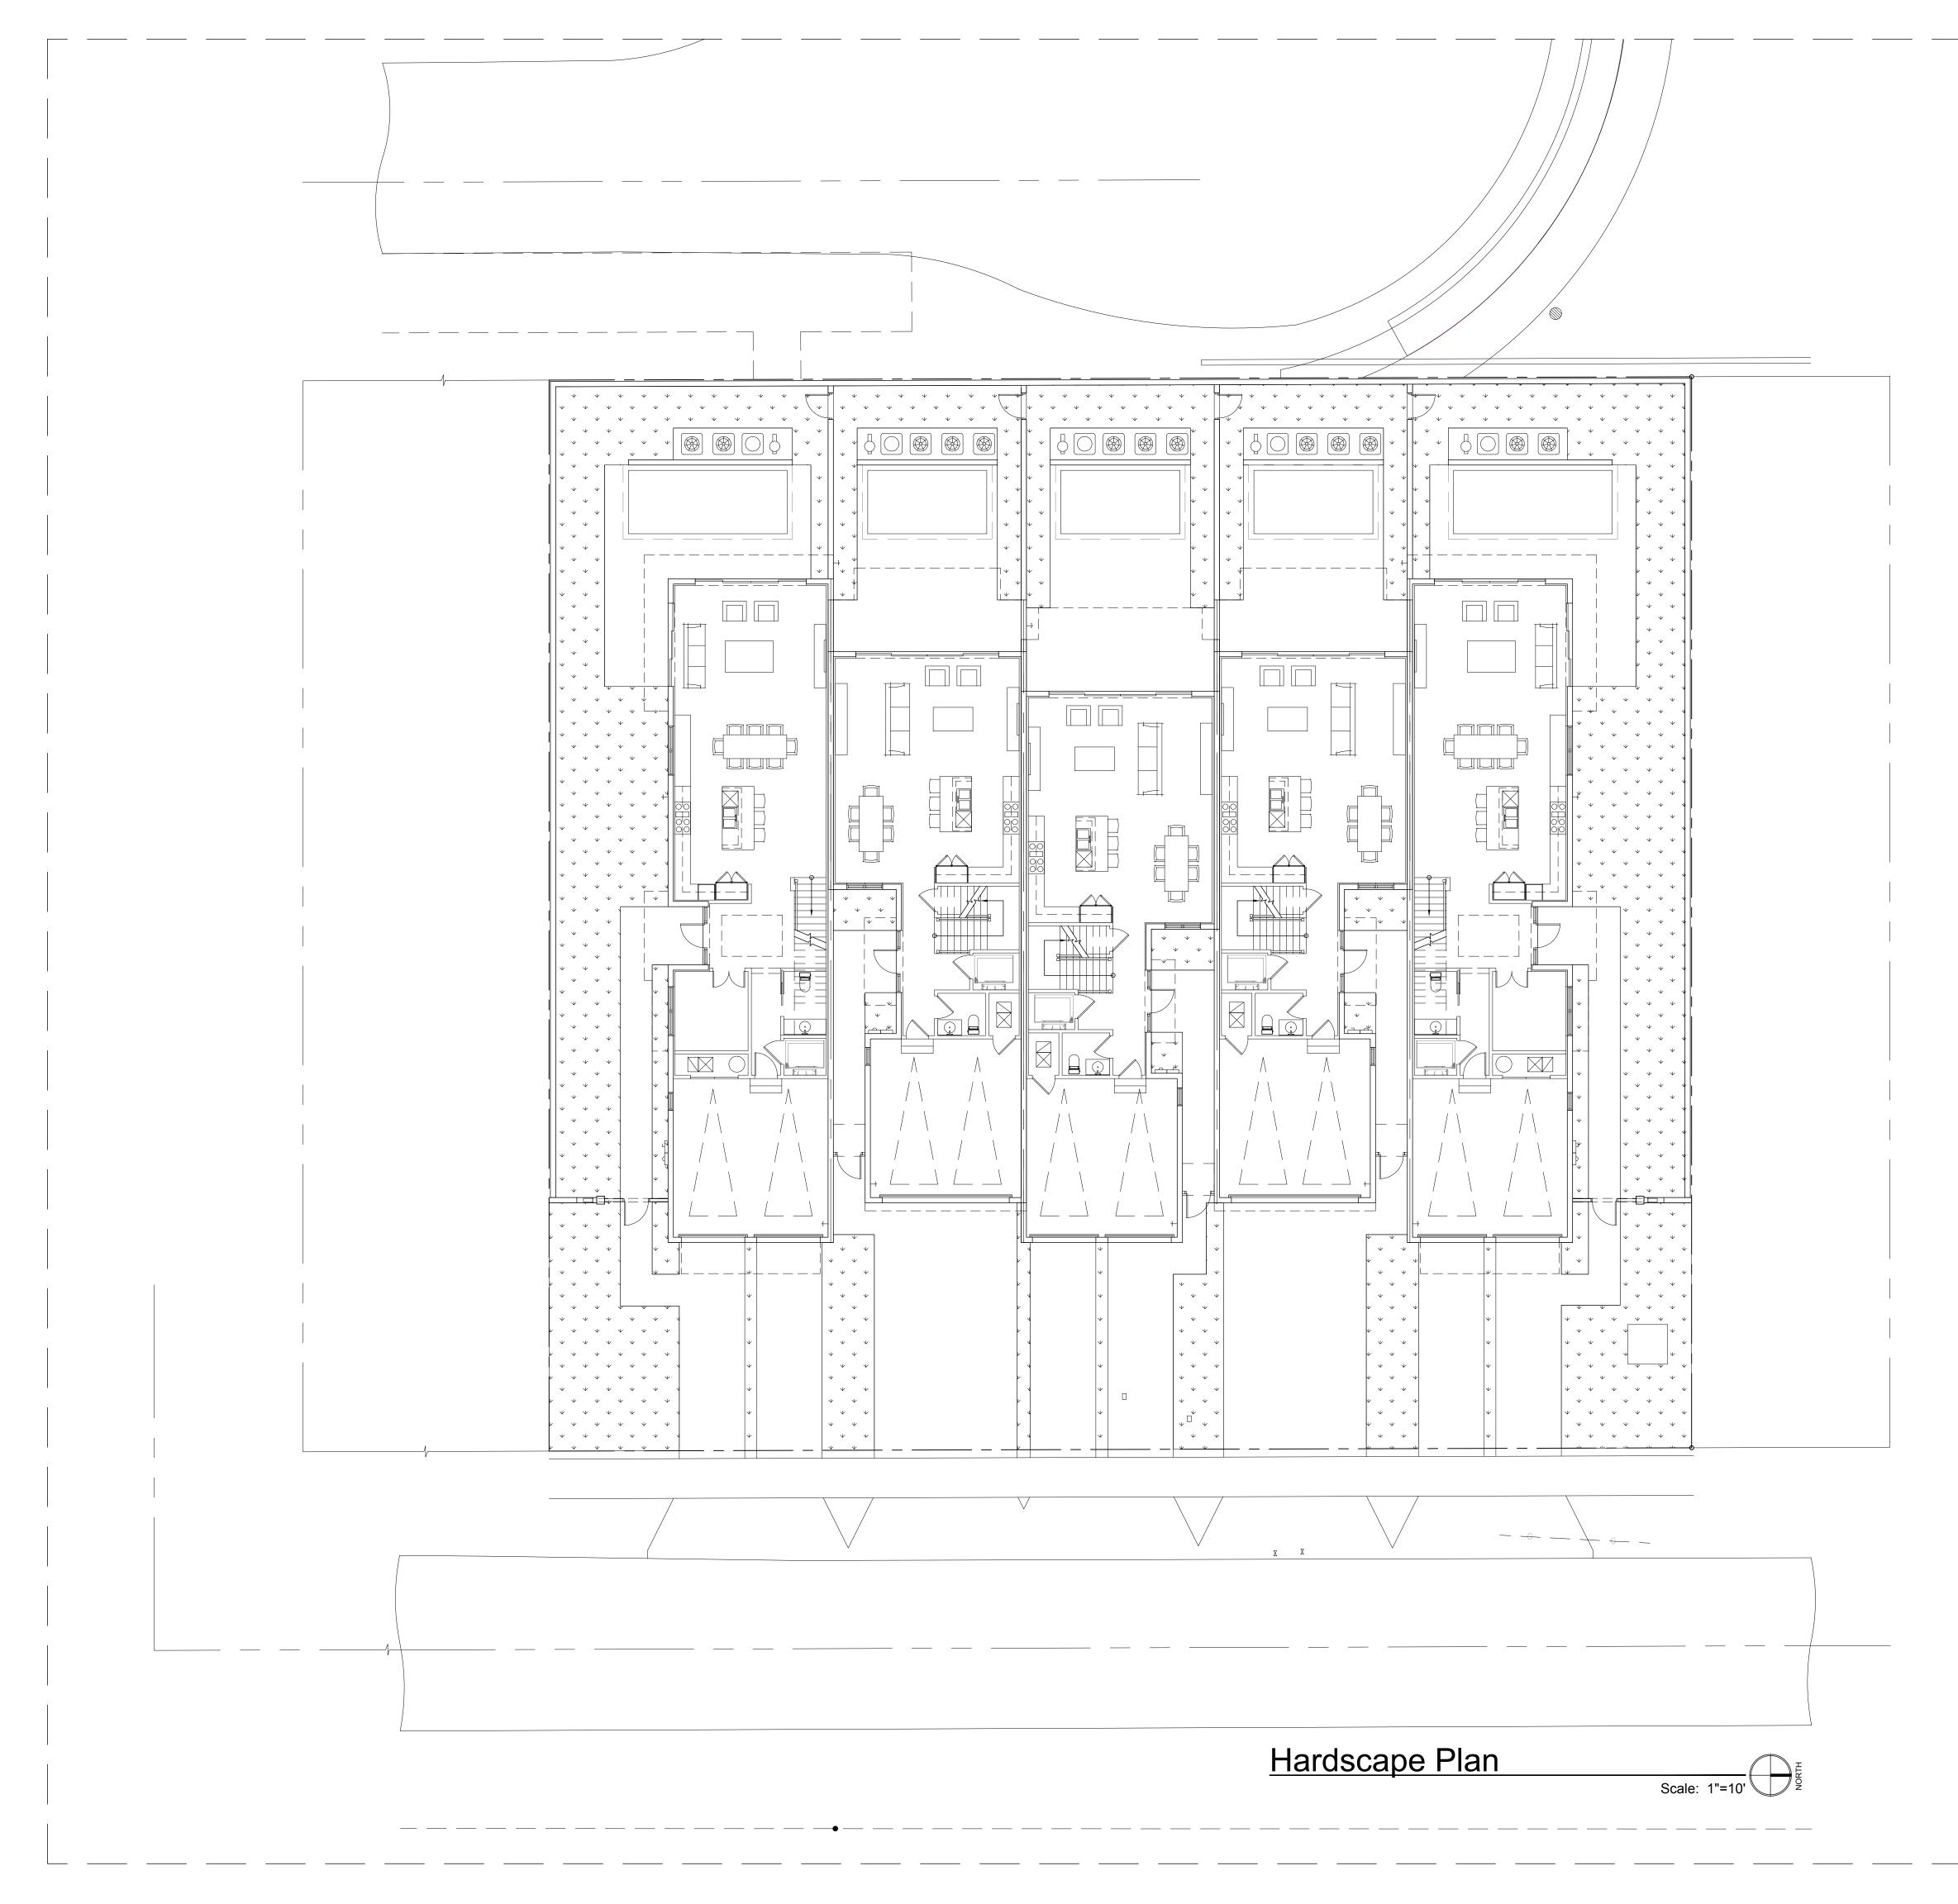


|                 |                                       |            | RICHARD J  | IONES  | _ `  |
|-----------------|---------------------------------------|------------|--|--|--|
|                 |                                       |            |  |  | H  |
|                 |                                       |            | ARCHITEC   | TURE   | JF   |
|                 |                                       |            | 10 S.E. FIRST AVENU<br>DELRAY BEACH, FLO                     | ORIDA 33444  |  |
|                 |                                       |            | V 561.274.9186   F<br>AA26001617   IB                        | 26001056   | ()   |
|                 |                                       |            | WWW.RJARCHITEC   | TURE.COM   | Ц  |
|                 |                                       |            |  |  |  |
|                 |                                       |            | AGES<br>AVE<br>CORIDA  | S<br>TE#104<br>A 33483   | Ţ  |
|                 |                                       |            | SEAGLASS COTTAGES<br>104 ANDREWS AVE<br>DELRAY BEACH, FLORIE | SEASIDE BUILDERS<br>185 NE 4TH AVENUE SUITE#104<br>DELRAY BEACH, FLORIDA 33483 |  |
|                 |                                       |            | EAGLAS<br>104 ANI<br>RAY BF                                  | SEASIL<br>85 NE 4TH A<br>ELRAY BEA   | ()   |
|                 |                                       |            | SI   | 1{<br>DI   | Image: A line of the second se |
|                 |                                       |            |  |  | V  |
|                 |                                       |            | FLORIDA LI   | CENSURE  | $(\mathbf{x})$   |
|                 |                                       |            |  |  |  |
|                 |                                       |            | AA26001617   IB<br>COMMISSION #                              | 16-020   | Z  |
|                 |                                       |            | DESIGNER:<br>DRAWN BY:<br>PLAN REVIEW:<br>SUBMITTALS:        | RJ<br>JS/RB/GJ<br>RJ   | $\mathbf{O}$   |
|                 |                                       |            | ISSUED FOR<br>PERMIT   | 12.16.16   | 5  |
|                 |                                       |            |  |  | $\bigcap$  |
|                 |                                       |            | REVISIONS:   |  | Z  |
|                 |                                       |            |  |  |  |
|                 |                                       |            |  |  |  |
|                 |                                       |            | HARDSC   | CAPE   |  |
| H               | ARDSCAPE DAT                          | Ā          | PLA  |  |  |
|                 | RSUANT TO CITY ZONING COL<br>PROVIDED |            |  |  |  |
| IMPERVIOUS AREA | 14,537 SQ.FT.                         | (NO HATCH) | SP-  | 2  |  |
| PERVIOUS AREA   | 4,902 SQ.FT.                          |            |  |  | · 1  |

| EXTERIOR PAINT COLORS  |  | ELEVATION NOTES  |    |   |
|--|--|--|----|---|
| 1 WALL COLOR: SW 7005 PURE WHITE                             | A STANDING SEAM METAL ROOF (PRE WEATHERED GALVALUME).  | KALUMINUM GATE (COLOR: POWDER COAT SW 7005 PURE WHITE ) SEE SITE PLAN FOR SIZE. PROVIDE SHOP<br>DRAWINGS FOR ARCHITECT'S REVIEW AND APPROVAL.  | Τ  | 8"x8" CY<br>CONNE   |
| 2 WINDOW FRAME COLOR: WHITE                                  | B 39" HIGH ALUMINUM RAILING SYSTEM (COLOR: POWDER COAT - ) WITH RECESSED MOUNTED POSTS. PROVIDE SHOP DRAWINGS FOR ARCHITECT'S REVIEW & APPROVAL.                           | L         TERRACE/BALC. WATER PROOFING SYSTEM & FLASHING- WATERPROOF CLEAR SEALER ON PORCELAIN TILE ON<br>THIN SET EPOXY GROUT OVER TREMCO (OR EQUIV.) SLOPE TO EXTERIOR (MIN. 1/8" PER FOOT). INSTALL PER |    | GLASS (<br>DOOR S   |
| 3 ROOF: STANDING SEAM METAL ROOF (PRE WEATHERED GALVALUME)   | C VERTICAL STUCCO SIMULATED BOARD AND BATTEN. 3" WIDE BANDS AT CORNER AND 3" WIDE BANDS<br>IN A FIELD. PROVIDE 4'X4' MOCK UP FOR ARCHITECTS APPROVAL PRIOR TO INSTALLATION | MANUFACTURER'S SPECIFICATIONS. UNDERSIDE OF DECK - SPRAYED ICYNENE PROSEAL INSULATION WHERE<br>BALCONY ENCLOSES A/C SPACE - MINIMUM AVERAGE R-19 ENTIRE ASSEMBLY.  |    | CONNEC<br>GLASS (<br>DOOR S<br>FLUSH F<br>APPRO\<br>1" RAISE<br>SHED R<br>CONNEC<br>DECORA<br>CYPRES<br>3" SMOC |
| 4 RAILING/GATES COLOR: SW 7005 PURE WHITE                    | D IMPACT RESISTANT DOORS AND WINDOWS w/ ALUMINUM FRAMES (WINDOW FRAME COLOR: WHITE) PROVIDE SHOP DRAWINGS FOR ARCHITECT'S REVIEW AND APPROVAL.                             | M MASONRY PIER w/ SMOOTH STUCCO. REFER TO DETAIL FOR BANDING PROFILES.   | W  | 1" RAISE  |
| 5 BRACKETS/COLUMNS/SOFFIT/FASICA/BANDING: SW 7005 PURE WHITE | E 2" OVER 8" SMOOTH STUCCO BAND  | N POURED CONCRETE COLUMN W/ 2" CHAMFER EDGES. SEE DETAIL   |    | SHED R  |
|  | F     2" OVER 4" SMOOTH STUCCO BAND  | P POURED CONCRETE PIER W/ 2" CHAMFER EDGES. SEE DETAIL   | Υ  | DECORA  |
|  | G 4" SMOOTH STUCCO BAND  | Q DECORATIVE LIGHT FIXTURE   | Ζ  | CYPRES  |
|  | H SMOOTH STUCCO FINISH   | R     FOAM LOUVER AT GABLE END. SEE DETAIL   | AA | 3" SMOC   |
|  | J CYPRESS WOOD ARBOR. SEE DETAIL   | S DECORATIVE FOAM CORBEL WITH HARDCOAT FINISH UNDER BALCONY (SEE DETAIL).  | BB | SMOOTH  |





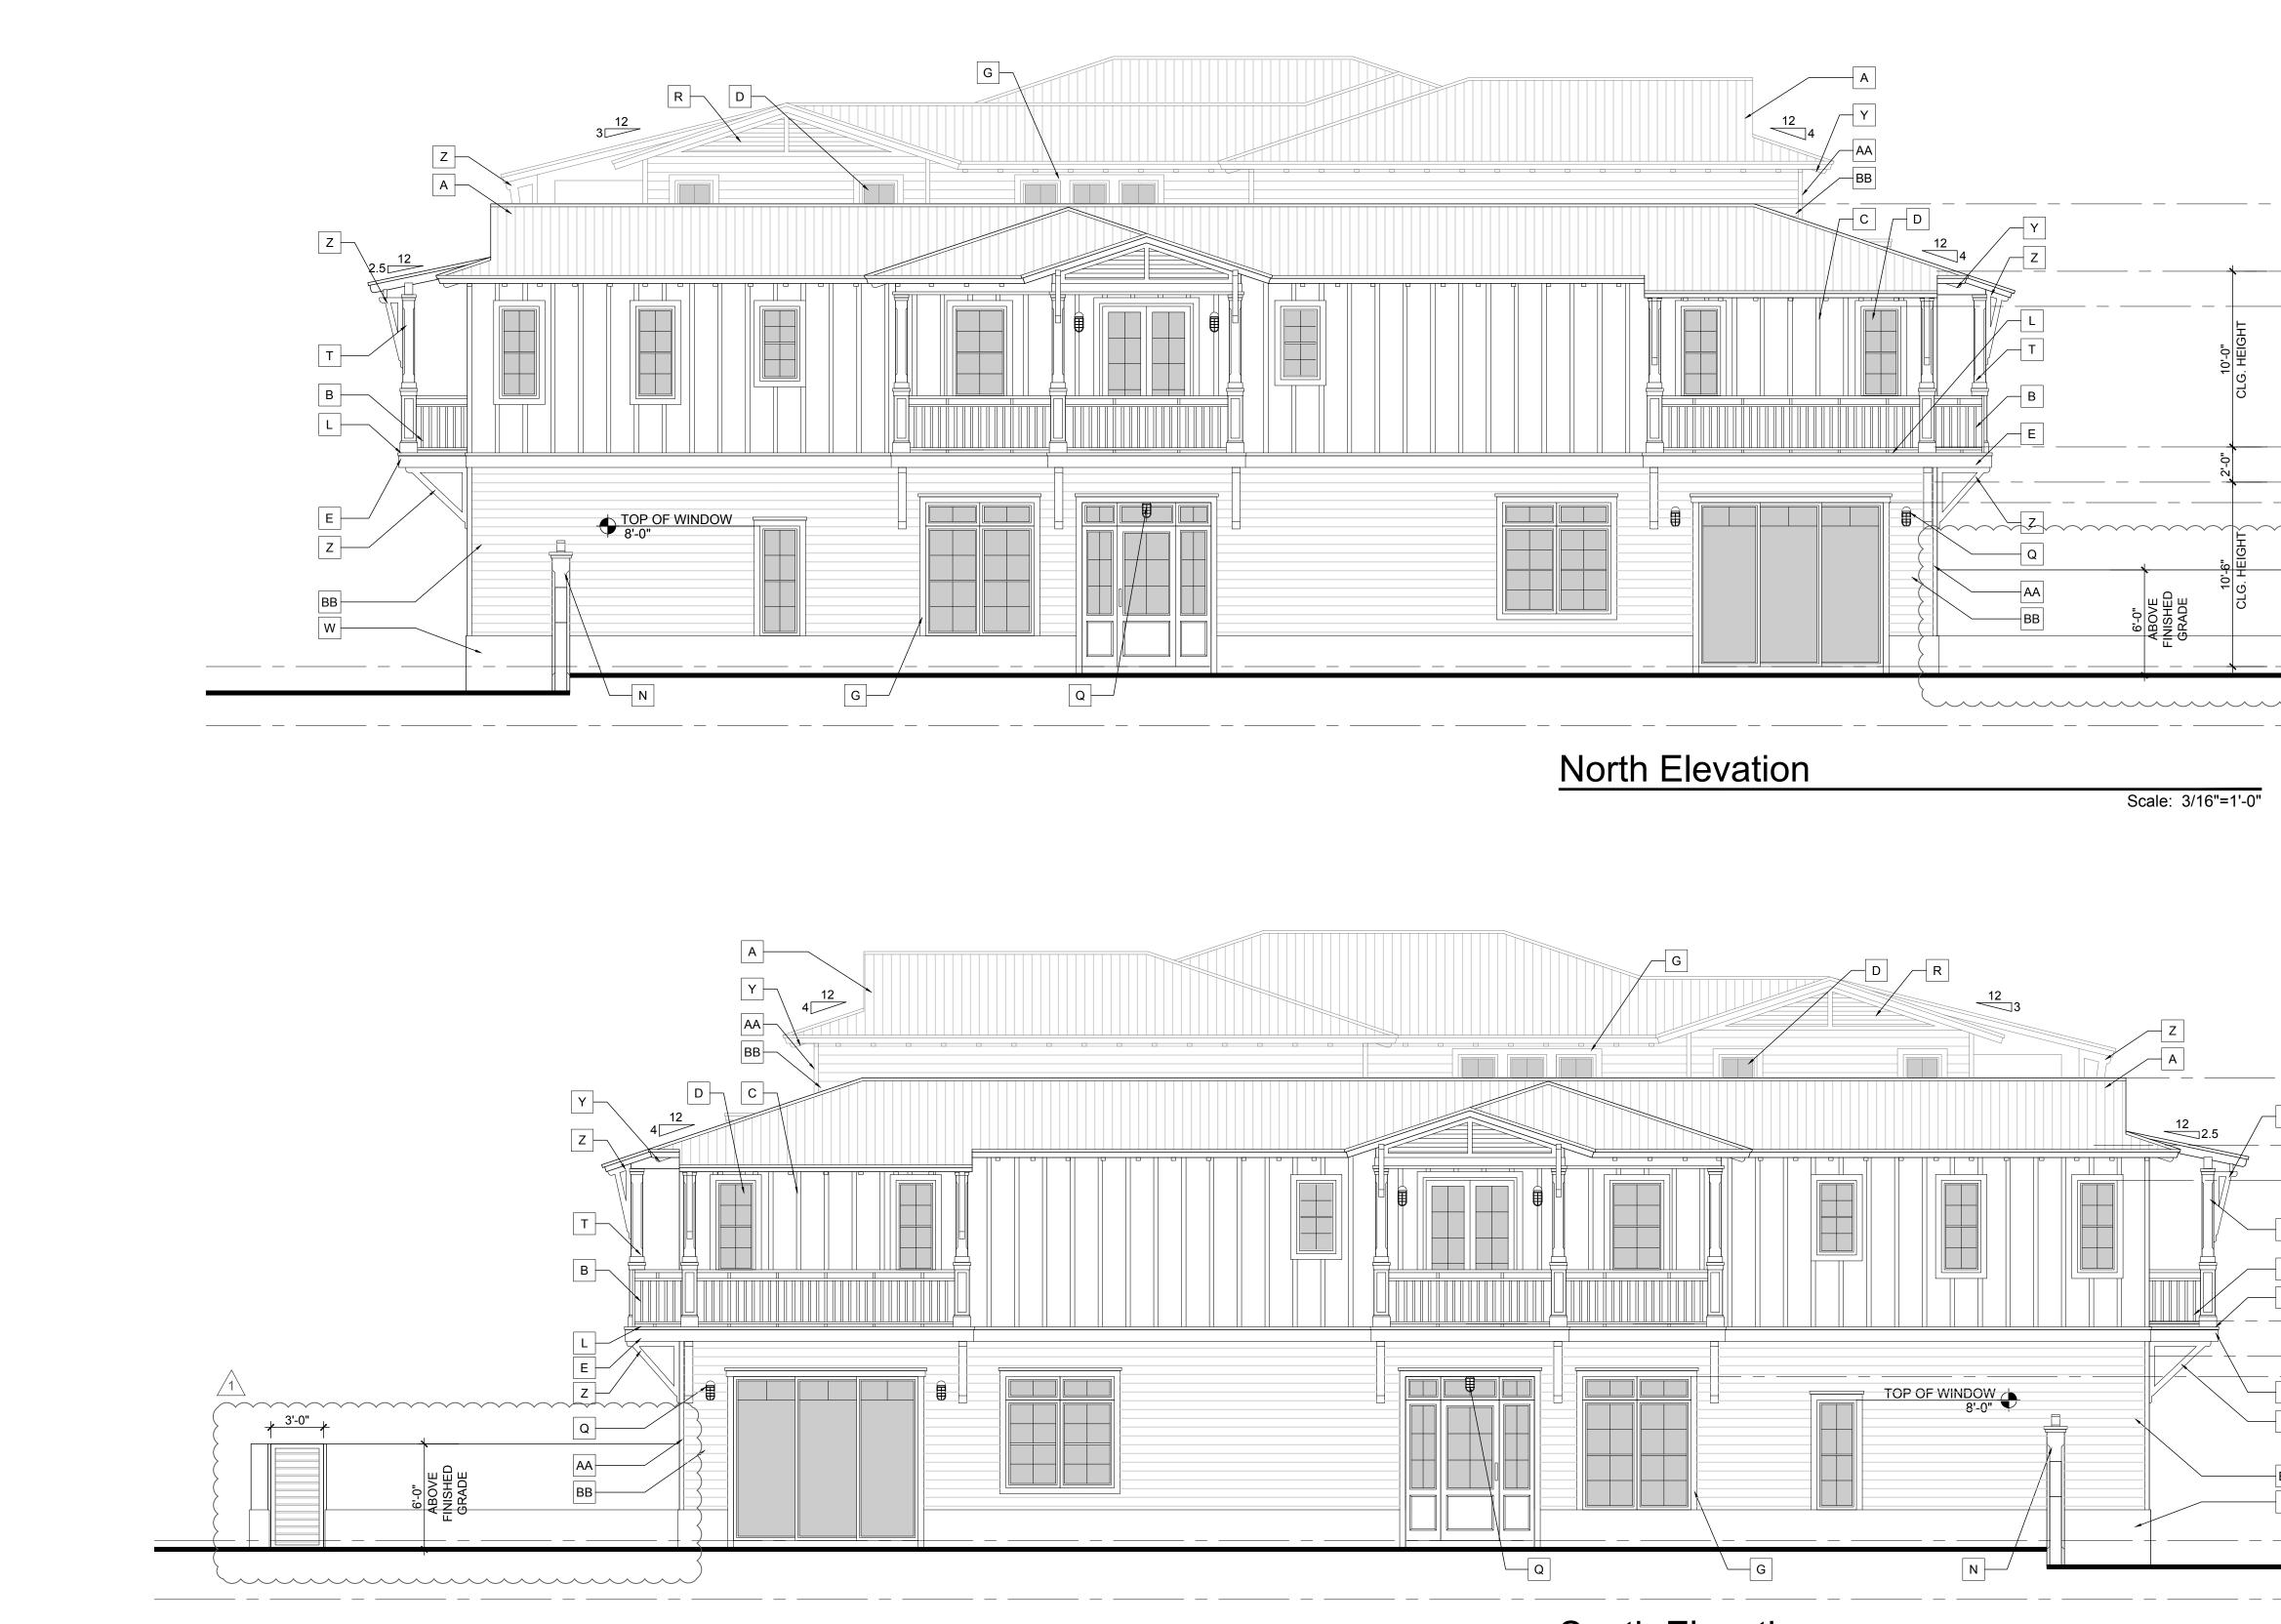

| EXTERIOR PAINT COLORS |  |   | EXTERIOR PAINT COLORS  |   |  |    |                        |
|-----------------------|--|---|--|---|--|----|------------------------|
| 1                     | WALL COLOR: SW 7005 PURE WHITE                             | Α | STANDING SEAM METAL ROOF (PRE WEATHERED GALVALUME).  | Κ | ALUMINUM GATE (COLOR: POWDER COAT SW 7005 PURE WHITE ) SEE SITE PLAN FOR SIZE. PROVIDE SHOP DRAWINGS FOR ARCHITECT'S REVIEW AND APPROVAL.  | Τ  | 8"x8" CYPR<br>CONNECTI |
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| 3                     | ROOF: STANDING SEAM METAL ROOF (PRE WEATHERED GALVALUME)   | С | VERTICAL STUCCO SIMULATED BOARD AND BATTEN. 3" WIDE BANDS AT CORNER AND 3" WIDE BANDS<br>IN A FIELD. PROVIDE 4'X4' MOCK UP FOR ARCHITECTS APPROVAL PRIOR TO INSTALLATION |   | MANUFACTURER'S SPECIFICATIONS. UNDERSIDE OF DECK - SPRAYED ICYNENE PROSEAL INSULATION WHERE<br>BALCONY ENCLOSES A/C SPACE - MINIMUM AVERAGE R-19 ENTIRE ASSEMBLY.                                |    | FLUSH PAN<br>APPROVAL  |
| 4                     | RAILING/GATES COLOR: SW 7005 PURE WHITE                    | D | IMPACT RESISTANT DOORS AND WINDOWS w/ ALUMINUM FRAMES (WINDOW FRAME COLOR: WHITE) PROVIDE SHOP DRAWINGS FOR ARCHITECT'S REVIEW AND APPROVAL.                             | Μ | MASONRY PIER w/ SMOOTH STUCCO. REFER TO DETAIL FOR BANDING PROFILES.   | W  | 1" RAISED              |
| 5                     | BRACKETS/COLUMNS/SOFFIT/FASICA/BANDING: SW 7005 PURE WHITE | Ε | 2" OVER 8" SMOOTH STUCCO BAND  | Ν | POURED CONCRETE COLUMN W/ 2" CHAMFER EDGES. SEE DETAIL   | X  | SHED ROO<br>CONNECTI   |
|                       |  | F | 2" OVER 4" SMOOTH STUCCO BAND  | Ρ | POURED CONCRETE PIER W/ 2" CHAMFER EDGES. SEE DETAIL   | Y  | DECORATI               |
|                       |  | G | 4" SMOOTH STUCCO BAND  | Q | DECORATIVE LIGHT FIXTURE   | Ζ  | CYPRESS                |
|                       |  | Η | SMOOTH STUCCO FINISH   | R | FOAM LOUVER AT GABLE END. SEE DETAIL   | AA | 3" SMOOTH              |
|                       |  | J | CYPRESS WOOD ARBOR. SEE DETAIL   | S | DECORATIVE FOAM CORBEL WITH HARDCOAT FINISH UNDER BALCONY (SEE DETAIL).  | BB | SMOOTH S               |

# South Elevation

Scale: 3/16"=1'-0"

| (TWO STORY PORTION)<br>TOP OF RIDGE<br>26'-4" ↓<br>(TWO STORY PORTION)<br>TOP OF ROOF BEAM<br>22'-6" ↓<br>(TWO STORY PORTION)<br>TOP OF WINDOWS/DOORS<br>20'-6" ↓  | RICHARD JONES   |         |
|--|---|---------|
| TOP OF FIRST FINISH FLOOR<br>0'-0" (7.6' NGVD)<br>   | SEAGLASS COTTAGES<br>104 ANDREWS AVE<br>DELRAY BEACH, FLORIDA<br>SEASIDE BUILDERS<br>185 NE 4TH AVENUE SUITE#104<br>DELRAY BEACH, FLORIDA 33483         | ARCHITE |
| (TWO STORY PORTION)  | FLORIDA LICENSURE   | S       |
| Z<br>Z<br>(TWO STORY PORTION)<br>TOP OF ROOF BEAM<br>22'-6"<br>(TWO STORY PORTION)<br>TOP OF WINDOWS/DOORS<br>20'-6"<br>B<br>L<br>(TWO STORY PORTION)<br>TOP OF SECOND FLOOR BEAM<br>12'-6"<br>0<br>0<br>0<br>0<br>0<br>0<br>0<br>0<br>0<br>0<br>0<br>0<br>0   | AA26001617   IB26001056<br>COMMISSION # 16-020<br>DESIGNER: RJ<br>DRAWN BY: JS/RB/GJ<br>PLAN REVIEW: RJ<br>SUBMITTALS:<br>ISSUED FOR 12.16.16<br>PERMIT |         |
| Z     FOP       BB     OP       W     OP       OP     OP | REVISIONS:<br>SPRAB COMMENTS<br>11.02.16  |         |
| B" CYPRESS WOOD POST WITH 1" CHAMFER EDGES (SEE STRUCTURAL DRAWINGS FOR HIDDEN<br>NNECTIONS).<br>ASS GARAGE DOORS BY BP DOORS. PROVIDE NOA FOR ARCHITECTS REVIEW AND APPROVAL.REFER TO<br>OR SCHEDULE.<br>JSH PANEL METAL GARAGE DOOR W/ AZEK TRIM - PROVIDE SHOP DRAWINGS FOR ARCHITECT'S REVIEW AND<br>PROVAL. REFER TO DOOR SCHEDULE.<br>RAISED SMOOTH STUCCO BASE<br>ED ROOF WITH WOOD BRACKET SUPPORTS (SEE DETAIL) SEE STRUCTURAL DRAWINGS FOR HIDDEN<br>NNECTIONS.<br>CORATIVE FOAM OUTLOOKER WITH HARDCOAT FINISH @24" O.C. TYPICAL (SEE DETAIL).  | NORTH AND<br>SOUTH<br>ELEVATIONS  |         |
| PRESS WOOD BRACKET. SEE DETAIL SMOOTH STUCCO CORNER BOARD OOTH STUCCO TO SIMULATE 6" LAP SIDING W/ 1" REVEAL   | A-3.2   |         |
|  |   |         |