

rchitecture, in a

Architect, Planner and Designer AA-26002044

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ISSUED FOR BUILDING PERMIT

8. 10. 18

PERMIT

CONSTRUCTION

PROJECT TITLE

MIXED USE **BUILDING ADDITION** / **RENOVATION** 

230 GEORGE BUSH BLVD. DELRAY BEACH, FL

CLIENT APPROVAL

REVISED Ø1.IØ.IT AS PER P4Z COMMENTS:

I. ADJUSTED SETBACKS. 2. ADDED ADA
ACCESS FROM EXISTING SIDEWALK.

REVISED ØB.IB.IT AS PER P4Z
COMMENTS: I. REMOVED (1) PARKING
SPACE AND INCREASE STACKING DISTANCE.
2. ADJUSTED LOCATION OF DDCY
(SEE CIVIL DRAWINGS). 3. SETBACK DIMENSIONS
OF A/C UNITS AND GENERATORS HAVE BEEN
PROVIDED. 4. CORRECTED LABELING OF REAR
AND SIDE SETBACKS.
5. CHANGED DRAWING SCALE TO I' = 10'-0'.

REVISED II.IG.17 AS PER P&Z COMMENTS: CHANGED PARKING REQUIREMENTS. REVISED 6.1.18 AS PER HPB COMMENTS:

1. NOW SHOWING 2 H.C. SPACES AND ELECTRIC YEHICLE CHARGERS. 2. CROSSWALK TO H.C. SPACES IS NOW SHOWN WITH A HEAVIER LINE WEIGHT. 3. NOW SHOWN ACCESSIBLE PARKING SPACE SYMBOL ON BOTH H.C. SPACES.

4. DUMPSTER ENCLOSURE HAS BEEN UPDATED TREFLECT DIMENSION AND MATERIAL CHANGES.

REVISED II.I6.18 AS PER OWNER COMMENTS: 1. ADDED STAIRS TOWER TO ROOF DECK. 2. UPDATED CALCULATIONS TO REFLECT OFFICE AND RESIDENTIAL USE. REVISED 02.0(1.19 AS PER OWNER COMMENTS:

1. ADDED ELEVATOR TO STAIR TOWER TO ROOF DECK. 2. PROPOSED SETBACKS.

THIS DRAWING IS NOT FOR CONSTRUCTION, IT HAS BEEN ISSUED FOR GOVERNMENTAL REVIEW AND/OR PRELIMINARY PRICING ONLY.

FILE NUMBER 616A101


DRAWING TITLE

**PROPOSED** SITE PLAN

DRAWN BY 03.22.17 GE/JC JOB NUMBER

20150616

#### FLOOR NOTES WATER CLOSET TO COMPLY W/ ADA - TOP OF SEAT @ 19' AFF. SECURITY ALARM ('ADT' OR EQUAL), TELEPHONE CONC. PAVERS NON SLIP - SAND SET ON (VERIFY W/ OWNER ON STYLE AND COLOR). 4 CABLE PANEL @ 60" AFF APPROX. AREA CALCULATIONS | 0 | 1 BEDDING SAND - OVER 4 (AFTER COMPACTION) ALL SHOWERS TO HAVE NON - SLIP CERAMIC TILE SHOWER FLOOR FIRESPRINKLER STAND PIPE SEE FIRE SPRINKLER DRAWINGS FOR LIMEROCK BASE (LBRIOO) COMPACTED SUBGRADE (COMPLY W/ADA) - SLOPE TO DRAIN - SET IN SHOWER PAN - ALL SIZE AND ACTUAL LOCATION. W/ 98 % MAX, DENSITY, NOTE: CONTRACTOR TO PROVIDE OTAL UNDER A/C OTAL UNDER ROC TILE TO BE APPROVED BY OWNER. OWNER WITH SAMPLES FOR APPROVAL. POURED IN PLACE CONC SLAB. SEE STRUC DWGS (TYP.) ALL INTERIOR DOORS TO BE 8'-0" HT. - TMI000 (PR-BYPASS DOORS) W/ BALCONIES TO SLOPE 1/8 1/FT. (WRAPPED W/ 'AZEK' TO SIMULATE PROPOSED PHASE I - GROUND FLOOR AREA ©2 CONTRACTOR TO COORDINATE W/ FP&L ON NEW UNDERGROUND SERVICE. COMMERCIAL GRADE RECESSED TRACKS - STAINED WOOD W/ GLASS RESIN (NOTE: ALL DOORS TO COMPLY W/ ADA REQUIREMENTS). 68 SQ.FT "MR STEAM" FOR STEAM SHOWER - SYSTEM \$MS-150E OR EQUAL - SEE M.E.P. DRAWINGS & MANUF, SPEC'S FOR ALL INSTALLATION ALL BALCONIES TO HAVE 1/2" MAX. STEP DOWN FROM F.F. 144 SQ.FT STAIR #1 SEE SHEET ALOI DRAWING FOR H.C. PARKING (INCLUDING THINSET PAVERS) SEE STRUCT. DWGS. FOR MIN. 6"th. Ø3 SPACES / SPEC. STAIR #2 149 SQ FT REQUIREMENTS - VERIFY W/ OWNER ON SYSTEM (LOCATED IN POURED CONCRETE BALCONY W/1/2"/FT. SLOPE FOR POSITIVE LEVATOR #1 PIPE RAIL RING DIRE PAGE FLORIDA ALUMINUM' OR EQUAL. PIPE RAIL RING BIKE RACK AS PER DETAIL 8/A1.02 BY 'SOUTH PHASE II - FUTURE GROUND FLOOR TENANT SPACE 6' x 6' CLEAR SMOOTH CEDAR WOOD COLUMNS 94 STEAM SHOWER ENCLOSURE W/ MIN. % TH. CLEAR GLASS - W/ INLINE DOOR & PANELS - W/ BRUSHED CHROME CLIPS - BY THE OTAL GROUND FLOOR AREA 3.522 SQ.FT (W/ 1' $\times$ 10' 'AZEX' TRIMMED BASE & 1" $\times$ 1" @ THE TOP-'ORIGINAL FRAMELESS SHOWER DOORS' OR EQUAL SEE STRUCT, DRAWINGS FOR HIDDEN CONNECTIONS. TRASH ENCLOSURE - W/ 48" HT. CONCRETE LOW WALL W/ %" SMOOTH STUCCO PAINTED FINISH W/ SELF CLOSING, SELF LATCHING (CONTRACTOR TO SUBMIT SHOP DWG'S FOR APPROVAL). A3.00 STRUCTURAL STEEL COLUMN - SEE STRUCTURAL DRAWINGS -WEST SIDE COVERED ENTRANCE 103 SQ.FT LOCKING DECORATIVE ALUMINIUM GATES - (MIN. 48" HT.) - SEE 6 x 12 SMOOTH CLEAR CYPRESS WOOD BEAM - PAINTED CONTRACTOR TO SUPPLY SHOP DRAWINGS FOR APPROVAL PRIOR TAL GROUND FLOOR AREA UNDER ROOF EXTERIOR ELEVATIONS & DOOR SCHEDULE. SEE STRUCTURAL DRWGS. TO FABRICATION. 96 BARN DOOR BY "RUSTICA HARDWARE" (COTTAGE WALNUT) OR EQUAL W/ STAINED PLANKS & DARK OIL BRUSHED BRONZE 2" x 12" & 12" x 6" CONCRETE PILASTERS W/ 5/8" 2-COATS SMOOTH CONTRACTOR TO PROVIDE "KNOX-BOX" AS PER DELRAY 66 FIRE DEPT. (ACCESS FOR MAIN ENTRY AND GARAGE DOOR). STUCCO PAINTED FINISH. BARN DOOR HARDWARE NOTES FOR X-RAY ROOM SEE EXTERIOR ELEVATIONS FOR 1' x 2' VERTICAL STUCCO BATTENS LINE OF CONC. BALCONY ABOVE - SEE EXTERIOR ELEVATIONS @ 16" O.C. OVER 7/8" 3-COATS SMOOTH STUCCO FINISH - PAINTED CONTRACTOR TO COORDINATE W/ OWNER FOR UNDER COUNTER 4 STRUCTURAL DRAWINGS. APPLIANCES / SPECIFICATIONS 08 ALL WALKWAY' TO HAVE A MAX. 2% CROSS SLOPE. SEE EXTERIOR ELEVATIONS FOR LOCATIONS OF 1/8' 3-COAT 98 SYSTEM FOR LAB ROOM. CONTRACTOR TO COORDINATE W/ OWNER ON WALL EXHAUST LEAD GLASS VIEWING WINDOW BY "RADIATION PROTECTION SMOOTH STUCCO W/ 6" LAP SIDING-FINISH-PAINTED (NOTE: PRODUCTS, INC." OR EQUAL. HEADER HEIGHT TO BE 65" OFF 'WATTZILLA DUO' - DUAL 80-AMP CAR CHARGER OR EQUAL - SEE ELECTRICAL DRAWINGS (CONTRACTOR TO INCLUDE IN BID FOR APPLY SCRATCH DIRECTLY TO BLOCK PRIOR TO LAPSIDING FLOOR FINISH. - VERIFY SIZE WITH OWNER. MAIL CENTER - MIN. (2) RECESSED LETTER BOXES - STANDARD SOLID WOOD CORE DOOR W/ 3-PIECE HOLLOW METAL KNOCKDOWN PRICING PURPOSES (LOCATED AT SOUTH EAST PARKING SPACES) 99 ALUMINUM FINISH - PRIVATE ACCESS W/ (2) KEYS SEE EXTERIOR ELEVATIONS FOR LOCATIONS OF 2-COAT 5/8" DOOR FRAME BY "PITTS LITTLE" OR EQUAL, CENTER CORE OF \*2245AP AND (1) 2-DOOR PARCEL LOCKERS W/ USPS ACCESS OOR TO BE LEAD LINED WITH 1/16" LEAD. 16 GA. COLD ROLLED \*2272P BY 'MAILBOX DEPOT' OR EQUAL. W/ 4'-0' SERVICE COUNTERTOP W/ FORMICA FINISH (ADA COMPLIANT). ALL A/C COMPRESSORS TO BE 4'TH CONC. PAD: CAPACITY AS STEEL DOOR FRAME LINED W/ 1/16"LEAD. (VERIFY W/ OWNER ON DETERMINED BY MECHANICAL ENGINEER. SEE HVAC PLAN & SITE 62 CONT 1 1/4"HT. x 4" COPPER DRIP EDGE @ ALL BALCONIES. MBIØØ GROSSING STATION BY "MOPEC" OR EQUAL. VERIFY ALL REQUIRED ELECTRICAL & PLUMBING CONNECTIONS. (CONFIRM CONTRACTOR TO PROVIDE MIN. OF $\frac{1}{20}$ ' LEAD BARRIER SHEETROCK- MIN. 1'-Ø' AFF. AS PER NEW GAS GENERATOR - CONTRACTOR TO VERIFY EXISTING ALL BALCONIES/PORCHES TO RECEIVE THINSET "MARBLE OF THE CAPACITY/DEMANDS W/ OWNER / UTILITY COMPANY FOR NEW WORLD' - LOTUS STYLE: QUARTZITE SET - 18' L imes 18' W WITH 3/16' MODEL W/ OWNER BEFORE ORDERING.) BUREAU OF RADIATION CONTROL' (F.D.O.H.) ADDITION / BUILDING. - (NOTE: UNIT TO BE PROTECTED DURING GROUT JOINTS OVER .125' LIQUID WATERPROOFING ON CONC. DECK CONSTRUCTION AND MAINTAINED) VULKEM 360' OR EQ. (REQ. SAMPLE FOR OWNER APPROYAL). STACKABLE WASHER & DRYER AS PER OWNER. SRT-100 "SUPERFICIAL RADIATION THERAPY SYSTEM", INSTALLATION AS PER (2) GAS "TANKLESS" WATER HEATER OR EQUAL, CAPACITY AS ALUMINUM DECORATIVE RAILING W/ POWDER COAT FINISH (COLOR APPLY TREMPROOF WATERPROOFING MEMBRANCE BY "TREMCO" DETERMINED BY PLUMBING ENGINEER - SEE PLUMBING PLAN. BLACK) - TOP OF RAIL MIN. 42" (BOTTOM RAIL MAX. 2" AFF. -OR EQUAL. ALONG EXTERIOR OF FOUNDATION WALL BELOW GRADE. WALL MOUNTED SRT-100 CONTROL CONSOLE. YP.)- PROVIDE SHOP DRAWINGS / SAMPLE. BY 'SOUTH FLORIDA 3 HOSE BIB W/ YACUUM BREAKER - SEE PLUMBING DRAWINGS. 03 ACCORDION ACOUSTICAL PARTITION WALL BY 'HUFCOR' OR EQUAL. VERIFY W/ MANUFACTURER'S INSTRUCTIONS FOR ALUMINUM' OR EQUAL. (SEE DETAIL 9 ON SHEET A8.02.) ALL REQUIRED WIRING AND CONNECTIONS TO 1 DECORATIVE "BAHAMA" ALUMINUM LOUVER SHUTTERS W/ E.S.P. 6" ht. CONC. WHEEL STOP - SEE CIVIL DRAWINGS FOR SRT-100 "SUPERFICIAL RADIATION THERAPY 65 POWDER COAT FINISH (COLOR BLACK). BY 'SOUTH FLORIDA 14 SPECIFICATIONS. 104 24' x 24' FIBERGLASS MOP SINK BY 'DURASTONE' OR EQUAL. SYSTEM". (NOTE: CONSOLE MUST NOT PROJECT ALUMINUM" OR EQUAL. (CONTRACTOR TO PROVIDE SHOP DRAWINGS OUT FROM THE WALL MORE THAN 4"). ALL EXTERIOR DOORS ("FLEMING" D OR EQUAL) 2 2 2 CONTRACTOR TO PROVIDE PLUMBING FOR FUTURE SINK. 15 TO BE IMPACT RESISTANT AND COMPLY W/ ALL DADE DECOR ALUM. SHUTTERS (COLOR BLACK) TO HAVE 2 X SPACERS @ 6 EXAMINATION TABLE. (VERIFY W/ OWNER.) COUNTY IMPACT AND WIND CYCLING TESTING REQUIREMENTS. REAR FOR PROTECTION FROM BUILDING. AS PER "SOUTH FLORIDA CONTRACTOR TO COORDINATE III/ PLUMBING & CIVIL DRAIIINGS CONTRACTOR TO PROVIDE CERTIFICATE OF COMPLIANCE NOTE: DASH RECTANGLE FOR ALL ROOF RAIN LEADERS & EMERGENCY OVERFLOW LINES. (TYP.) - SEE EXTERIOR ELEVATIONS AND DOOR SCHEDULE CONTRACTOR TO PROVIDE PLUMBING IN WALL FOR ALL HANDSINKS -VERIFY WOWNER ON SPEC. (NOTE: ALL FIRE RATED INDICATES MIN. FLOOR | 101 | ELEVATOR MACHINE ROOM TO COMPLY W/ THYSSENKRUPP CLEARANCE FOR PARALLEL NOTE: DASH RECTANGLE INDICATES MIN. FLOOR CLEARANCE FOR JALLS, FLOORS AND CEILINGS TO HAVE ALL PENETRATIONS 7 7 7 AND FORWARD APPROACH 16 PARALLEL AND FORWARD APPROACH FOR VARIOUS LOCATIONS DOOR TO BE SELF CLOSING, SELF LOCKING & A "B" LABEL DOOR PROTECTED AS PER SHEET AS.05 FOR VARIOUS LOCATIONS THROUGHOUT SPACE - THE OFFICE PORTION OF BUILDING TO K K K K HROUGHOUT SPACE / TH ALL FLOORING SHALL BE "NONSKID", COMMERCIAL GRADE & 2. INSTALL A 10 LB. MIN. CLASS "ABC" FIRE EXTINGUISHER. COMPLY WITH ALL APPLICABLE ADA REQUIREMENTS. COMPLY W/ ADA REQUIREMENTS. 3. PROVIDE SMOKE DETECTOR - SEE ELECTRICAL DRAWINGS. BUILDING TO COMPLY WITH 4"th CONC SLAB (3000 PSI) W/ 6 x 6-WI.4 x WI.4 W.W.F. IN FLAT SEE ROOM FINISH SCHEDULES FOR ALL WALLS, CEILINGS & FLOOR UTILTY SINK 20GA. STAINLESS STEEL - DEEP I-BOWL SHEETS PLACED OVER 10-MIL POLYETHYLENE VAPOR BARRIER LAP 6" AND TAPE ALL JOINTS ON WELL COMPACTED FILL. TERMITE ALL APPLICABLE ADA COVERINGS -VERIFY W/ OWNER. (VERIFY SPEC. / SELECTION WITH OWNER). REQUIREMENTS. TREATED. (SOIL PREPARATION - 'DURBAN-TC' 1% - 5 GAL PER 10 SHELL-CONTRACTOR TO VERIFY W/ OWNER ALL REQUIRED HT'S CONTRACTOR TO PROVIDE SHOP DRAWINGS FOR ALL CABINETRY. S.F. OF SLAB AREA (SAW-CUT CONTROL JOINTS @ LESS THAN OR & BACKING FOR ALL PLASMA/FLAT SCREEN TV LOCATIONS (TYP.). ALL CABINETRY TO HAVE UPPER AND LOWER W/ FLUSH DOORS AND EQUAL TO 20'-0" EACH WAY) SEE STRUCTURAL DRAWINGS. FLOOR DRAIN - SEE PROPOSED PLUMBING DRAWINGS FOR ALL LIGHT VALANCE - (NOTE: ALL TO BE ADA ACCESSIBLE). BOND BREAKER ( $\frac{1}{2}$ ISOLATION JOINT) - SEE STRUCTURAL DRUGS FOR ALL LOCATIONS AND SPECIFICATIONS. CONNECTIONS (TYP. @ ALL OFFICE BATHROOMS). SECOND FLOOR KITCHEN SINK: 20 GA. STAINLESS STEEL, DBL BOWL UNDERMOUNT W/ DISPOSAL - TO BE SELECTED BY OWNER. EMPERED FRAMELESS GLASS SHOWER ENCLOSURE & DOOR 1/2" 34' SLAB RECESS @ PERIMETER OF EXTERIOR BLOCK WALLS FOR 19 THE SECOND FLOOR AND ROOF DECK MIN. THICKNESS W/ BRUSHED CHROME CLIPS. GE MONOGRAM 36" DUEL-FUEL PROFESSIONAL RANGE W/ 6 BURNERS \*ZDP366NPSS (NATURAL GAS) - (STYLE AND FINISH TO BE 20"H x 18"D TILED (MATERIAL TO BE SELECTED BY OWNER) BENCH 6' HOLLOW CORE PLANKS W/2' TOPPING AT SECOND FLOOR - SEE STRUC. DRUG'S. - NOTE: SECOND FLOOR BALCONIES TO BE 13 W/ 5/16" 'DUROCK' OVER 3 5/8' 20 GA. METAL STUDS @ 20' O.C. SELECTED BY OWNER) CONTRACTOR TO COORDINATE W/ PLUMBER FOR GAS LINE AND CONNECTION (FOR PRICING PURPOSES ONLY) POURED CONCRETE W/ 2' STEP DOWN (FINISH DECK W/ 1/2' MAX. ALL TILE FLR'G TO BE NON-SLIP. ALL SHOWER FLRS TO BE GE 36" GLASS CANOPY HOOD "ZY900SLSS (NOTE: EXHAUST HOOD RECESSED 1/2" MAX. BELOW FINISH FLOOR & SLOPE TO DRAIN SET SHOULD HAVE A W/ 3" MIN. OVERLAP W/ COOKTOP)-(STYLE AND $\mid_{21}\mid$ continuous i-HR rated 8' concrete block wall w/ %' Type 'X FINISH TO BE SELECTED BY OWNER) - FOR PRICING PURPOSES ONLY. GYPSUM WALL BOARD W/ LEVEL IV FINISH - PAINTED ON 18" MIRROR TO BE 14" SQUARE CUT W/ 1" REVEAL BETWEEN EDGE \$ GE 30' ELECTRIC CONVECTION SINGLE WALL OVEN INTERSECTING WALL & CEILING. AND STAIR WALLS TO BE FILLED W/"TAILORED FOAM OF FLORIDA 113 \*ZET90505HSS W/ GE MONOGRAM BUILT-IN OVEN WITH INC'- "CORE-FILL 500" OR EQUAL (NOTE: INTERIOR STAIRWELL ADVANTIUM SPEEDCOOK TECHNOLOGY - 240V \*Z5C2201JSS STYLE AND FINISHED TO BE SELECTED BY OWNER. WALLS TO BE EXPOSED CM.U. PAINTED WITH BLOCK FILLER & TOOL DOORS BY 'TRUSTILE' OR EQUAL-SEE DOOR SCHEDULE (NOTE: ALL DOORS TO COMPLY W/ ADA REQUIREMENTS) C. BATHROOM DOORS TO HAVE "OCCUPIED" SIGNAGE - NOTE: NON-LOAD BEARING 5' INT. PARTITION WALL W/ (1) LAYER OF 5/8' GE FULLY INTEGRATED DISHWASHER \*ZDT800SSFSS - (STYLE ALL SIGNAGE TO BE MOUNTED ON HALLWAY SIDE OF WALL NEXT TYPE-'X' G.W.B. W/ 9MOOTH LEVEL IV FINISH - PAINTED ON EA. SIDE AND FINISH TO BE SELECTED BY OWNER). FOR PRICING OF 35/2 GA, MTL, STUDS @ 24' O.C. W/ BATT, SOUND INSULATION PURPOSES ONLY EVERY BATHROOM DOOR LOCK SHALL BE DESIGNED TO (SEE DIM. FLR. PLANS FOR ACTUAL WALL THICKNESS) (M.R. PERMIT THE OPENING OF THE LOCKED DOOR FROM THE OUTSIDE IN 36' GE BUILT-IN BOTTOM-FREEZER REFRIGERATOR SUB \*ZIC636@NHLH (STYLE AND FINISH TO BE SELECTED BY DRYWALL @ BATHROOMS, 5/8" DENS-SHEILD BEHIND TILE). (NOTE AN EMERGENCY (ALL DOORS TO BE ADA COMPLIANT). STUDS TO BE 12" Ø.C. WHEN INSTALLING M.R. DRYWALL CLG'S. (TYP.) (NOTE: UL\*U419 FOR 1HR RATED PARTITIONS - IF APPLICABLE). 5 EQUALLY SPACED 12" D. WIRE SHELVES W/ WHITE VINYL COATING OWNER), FOR PRICING PURPOSES ONLY. CONTRACTOR TO PROVIDE BACKING @ ALL WALLS W/ SHELVING \$ RECESSED ELECTRICAL OUTLETS AND SWITCH BOXES IN ONE HOUR UNDERCOUNTER REFRIGERATOR - CONTRACTOR TO FIRE RATED PARTITION SHALL BE METALLIC WITH A SURFACE NOT 116 COORDINATE LOCATIONS WITH OWNER - NOTE: ALL 6 x 6 NON-SKID CERAMIC TILE - COMPLY W/ ADA (VERIFY W/ OUNER ON STYLE AND COLOR) TO EXCEED 16 9Q. IN. AND THE SURFACE AREA OF THE BOX SHALL NOT EXCEED 100 9Q. IN. PER 100 9Q. FT. OF WALL SURFACE. BOXES APPLIANCE TO BE SELECTED BY OWNER. W/ OWNER ON STYLE AND COLOR). LOCATED ON THE OPPOSITE SIDE OF THE PARTITION SHALL BE CONFERENCE ROOM GLASS PARTITIONS: 1 BOBRICK SURFACE MTD. TOILET PAPER HOLDER UNDER 117 | MONOLITHIC TEMPERED GLASS (HEIGHT - 10'-0") W/ OPOLYMER STRIPS FOR GLASS TO GLASS JOINTS SEE FLOOR PLAN FOR LOCATION OF 5 LB. (ABC) RATING FIRE 24 EXTINGUISHERS AND WALL HANGERS - TOP OF EXTINGUISHERS MAX 40' ABOVE FLOOR - FOR PRICING PURPOSES USE RECESSED BOBRICK SANITARY NAPKIN DISPENSER BOTTOM AT DEEP U-CHANNELS - CONTRACTOR TO PROVIDE SHOP DRAWINGS FOR APPROVAL ("10-2000" CRL 40' AFF, MAX, W/ SURFACE MTD CABINETS - "LARSENS" SOLID DOOR W/ BLACK TYPE A - DIECUT CASCADE GLASS WALL OFFICE SYSTEM . BOBRICK PAPER TOWEL DISPENSER BOTTOM AT 40" AFF. LETTERING (STAINLESS STEEL) #FSO -2409. FRAMELESS - OR FOLIAL . MAX. W/ SURFACE MTD 25 STYPE 'X' GYP9UM WALL BOARD - PAINTED ON IS FURRING FOR PRICING PURPOSES ONLY). BOBRICK MIRROR ABOVE SINK BOTTOM MOUNTED AT CHANNELS @ 24" O.C. W/ R4.1 FI-FOIL INSULATION BETWEEN FURRING & CONTRACTOR PRICE TO INCLUDE (4) FLOOR 40" AFF, MAXIO BIM, OF REFLECTIVE SURFACE. 118 OUTLETS (QUAD'S) TO BE LOCATED UNDER FRONT DESK AT FRONT LOBBY WAITING AREA MAINTAIN PROPER FIRE RATING AT ALL PENETRATIONS OF RATED WALL ASSEMBLIES I.E. MECHANICAL AND ELECTRICAL SERVICE (TYP. BOTH FLOORS) - VERIFY EXACT LOCATION W/ OWNER. BOBRICK SEAT COVER DISPENSER BOTTOM AT 40" A.F.F. MAX. W/ SURFACE MTD. 27 FURRED OUT WALL 6' TO 8' FOR PLUMBING STACK - SEE PLUMBING PLANS FOR LOCATIONS. EXAM #05 WALL MTD. LAVATORY AT 30" A.F.F. TO BOTT. OF APRON. BATT SOUND INSULATION TO BE INSTALLED IN ALL WALLS. (TYP. 9.9. I 1/2" DIA, GRAB BAR 42" LONG © 34" A.F.F. AND 12" FROM CORNER OF WALL W/ CONCEALED ANCHOR PLATE. 28 THROUGHOUT). AIR HANDLING UNIT: CAPACITY AS DETERMINED BY MECHANICAL (G2) \ 29 ENGINEER. SEE HYAC PLAN. ALL UNITS TO BE EQUIPPED W/ UY 9.9. 1 1/2" DIA. GRAB BAR 36" LONG @ 36" A.F.F. W/ CONCEALED ANCHOR PLATE. LIGHT AT COIL & DRAIN PAN. SEE MECHANICAL DRAWING FOR ALL DUCT WORK SIZES AND 30 SPECIFICATIONS (NOTE: STRUCTURAL STEEL AND A/C SUBCONTRACTOR TO COORDINATE ALL SHOP DRAWINGS PRIOR TO FABRICATION TO AVOID ALL CONFLICTS). 31 STACKABLE WASHER AND DRYER TO BE SELECTED BY OWNER. PREFAB LAUNDRY CONNECTION BOX FOR WASHER AND DRYER DOUBLE HOSE BIBB OUTLET CONNECTION OUTLET BOX W/ DRAIN BOX - 'SIOUX CHIEF 696 SERIES' OR EQUAL. GALV. METAL DRYER VENT THRU FRONT WALL. DRYER VENT SHALL EXAM #04 33 NOT EXCEED MANUFACTURER'S, RECOMMENDATION, AND/ OR 25'L. GIS PROVIDE RECESSED WALL MOUNTED DRYER VENT HOSE RECEPTACLE DRYER BOX \*480 'IN-O-VATE TECHNOLOGIES' OR EQUAL. 34 STAINLESS STEEL SINK BY 'ELKAY ASANA' OR EQUAL. 19-5/8' X 16-11/16" $\times$ 6" - SINGLE BOWL TOP MOUNT W/ 'AMERICAN STANDARD' MONTERREY PC 1500.160 CENTERSET FAUCET. BEE PROPOSED SITE PLAN FOR MODIFICATIONS TO EXISTING ALL EXTERIOR DOORS & WINDOWS TO HAVE 'DYMONIC 100' CAULKING @ BUCK/CMU/ALUM. FRAME CONDITIONS (TYP.) PARKING LOT. -ALUMINUM EXTERIOR DOOR THRESHOLD SET IN MASTIC OVER 36 'GRACE YYCOR PLUS' - MIN. 12' TURN @JAMB. (W/ 1/2" MAX. HT. ALL WINDOW CORNERS & SILLS TO BE WRAPPED W/ 'GRACE YYCOR PLUS' WINDOW SEAL, TURNING UP 12' @ JAMBS (NOTE: WINDOW TO HAVE CAST-IN-PLACE CONC. SILLS. (G17) 38 ALL WINDOWS TO HAVE I x F.T. WD BUCKS ANCHORED TO CONC. AS PER PRODUCT APPROVAL. DR. OFFICE PGT' SINGLE HUNG & FIXED ALUM, WINDOWS (COLOR: BLACK) TO BE IMPACT RESISTANT AND COMPLY W/ALL DADE COUNTY IMPACT AND WIND CYCLING TESTING REQUIREMENTS CONTRACTOR TO PROVIDE CERTIFICATE OF COMPLIANCE (TYP.). PGT' - FAUX - FIXED WINDOW W/ INTERIOR SIDE TO BE PAINTED BLACK (TYP.) SEE DETAIL FOR RECESSED STUCCOED 4' CONC. BLOCK). ENDURA 254 BY THYSSENKRUPP ELEVATOR OR EQUAL. -CONTRACTOR TO PROVIDE SIGNED & SEALED SHOP DRAWINGS BREAKROOM FOR ARCHITECT/STATE APPROVAL. EXPOSED CMU. WALLS TO BE PAINTED W/ BLOCK FILLER (TYP. 42 EXPOSED CMU, WALLS TO DE TAINLE AT STAIRWELLS) - VERIFY W/ OWNER. $1\frac{1}{2}$ " DIA. PIPE GUARDRAIL SHALL BE SHOP PRIMED & FIELD 43 PAINTED - TOP OF RAIL MIN. 42 WITH VERTICAL PICKETS TO BLOCK PASSAGE OF 4" SPHERE. (BOTTOM RAIL MAX. 2" ABOVE FINISH TOP LANDING). PROVIDE SHOP DRAWINGS/ SAMPLE FOR OWNER APPROVAL - SEE SHEET A4.00 ALL STAIR WALL RAIL SHALL EXTEND 12" BEYOND THE BOTTOM RISER THE RAIL SHALL CONTINUE TO SLOPE FOR ONE TREAD LENGTH AND SHALL RETURN TO THE WALL. CONTRACTOR TO PROVIDE SHOP DRAWINGS FOR APPROVAL PRIOR TO FABRICATION. -SEE SHEET A4.00 CONCRETE STAIR & LANDING - CONTRACTOR TO PROVIDE SHOP DRAWINGS FOR APPROVAL PRIOR TO FABRICATION. HANDRAIL SHALL WRAP CONTINUOUSLY AROUND LANDINGS - ALL ALLINGS & STEEL BRACKETS TO BE FIELD PRIMED AND PAINTED-COLOR CHARCOAL GRAY -SEE SHEET A4.03/A4.04. SEE ELECTRICAL & PLUMBING PLAN FOR DRINKING FOUNTAIN CONNECTION - "ELKAY" OR EQUAL - "LZSTL89C @ OFFICE - WALL SEE ELECTRICAL DRAWINGS FOR EXACT LOCATION OF ALL 48 PANELS & SPEC'S. ELECTRICAL SERVICE PANEL @ 60" ABOVE FLOOR, 6EE ELECTRICAL DRAWINGS. MAIN DISCONNECT, ELECTRICAL PANELS -SEE ELECTRICAL

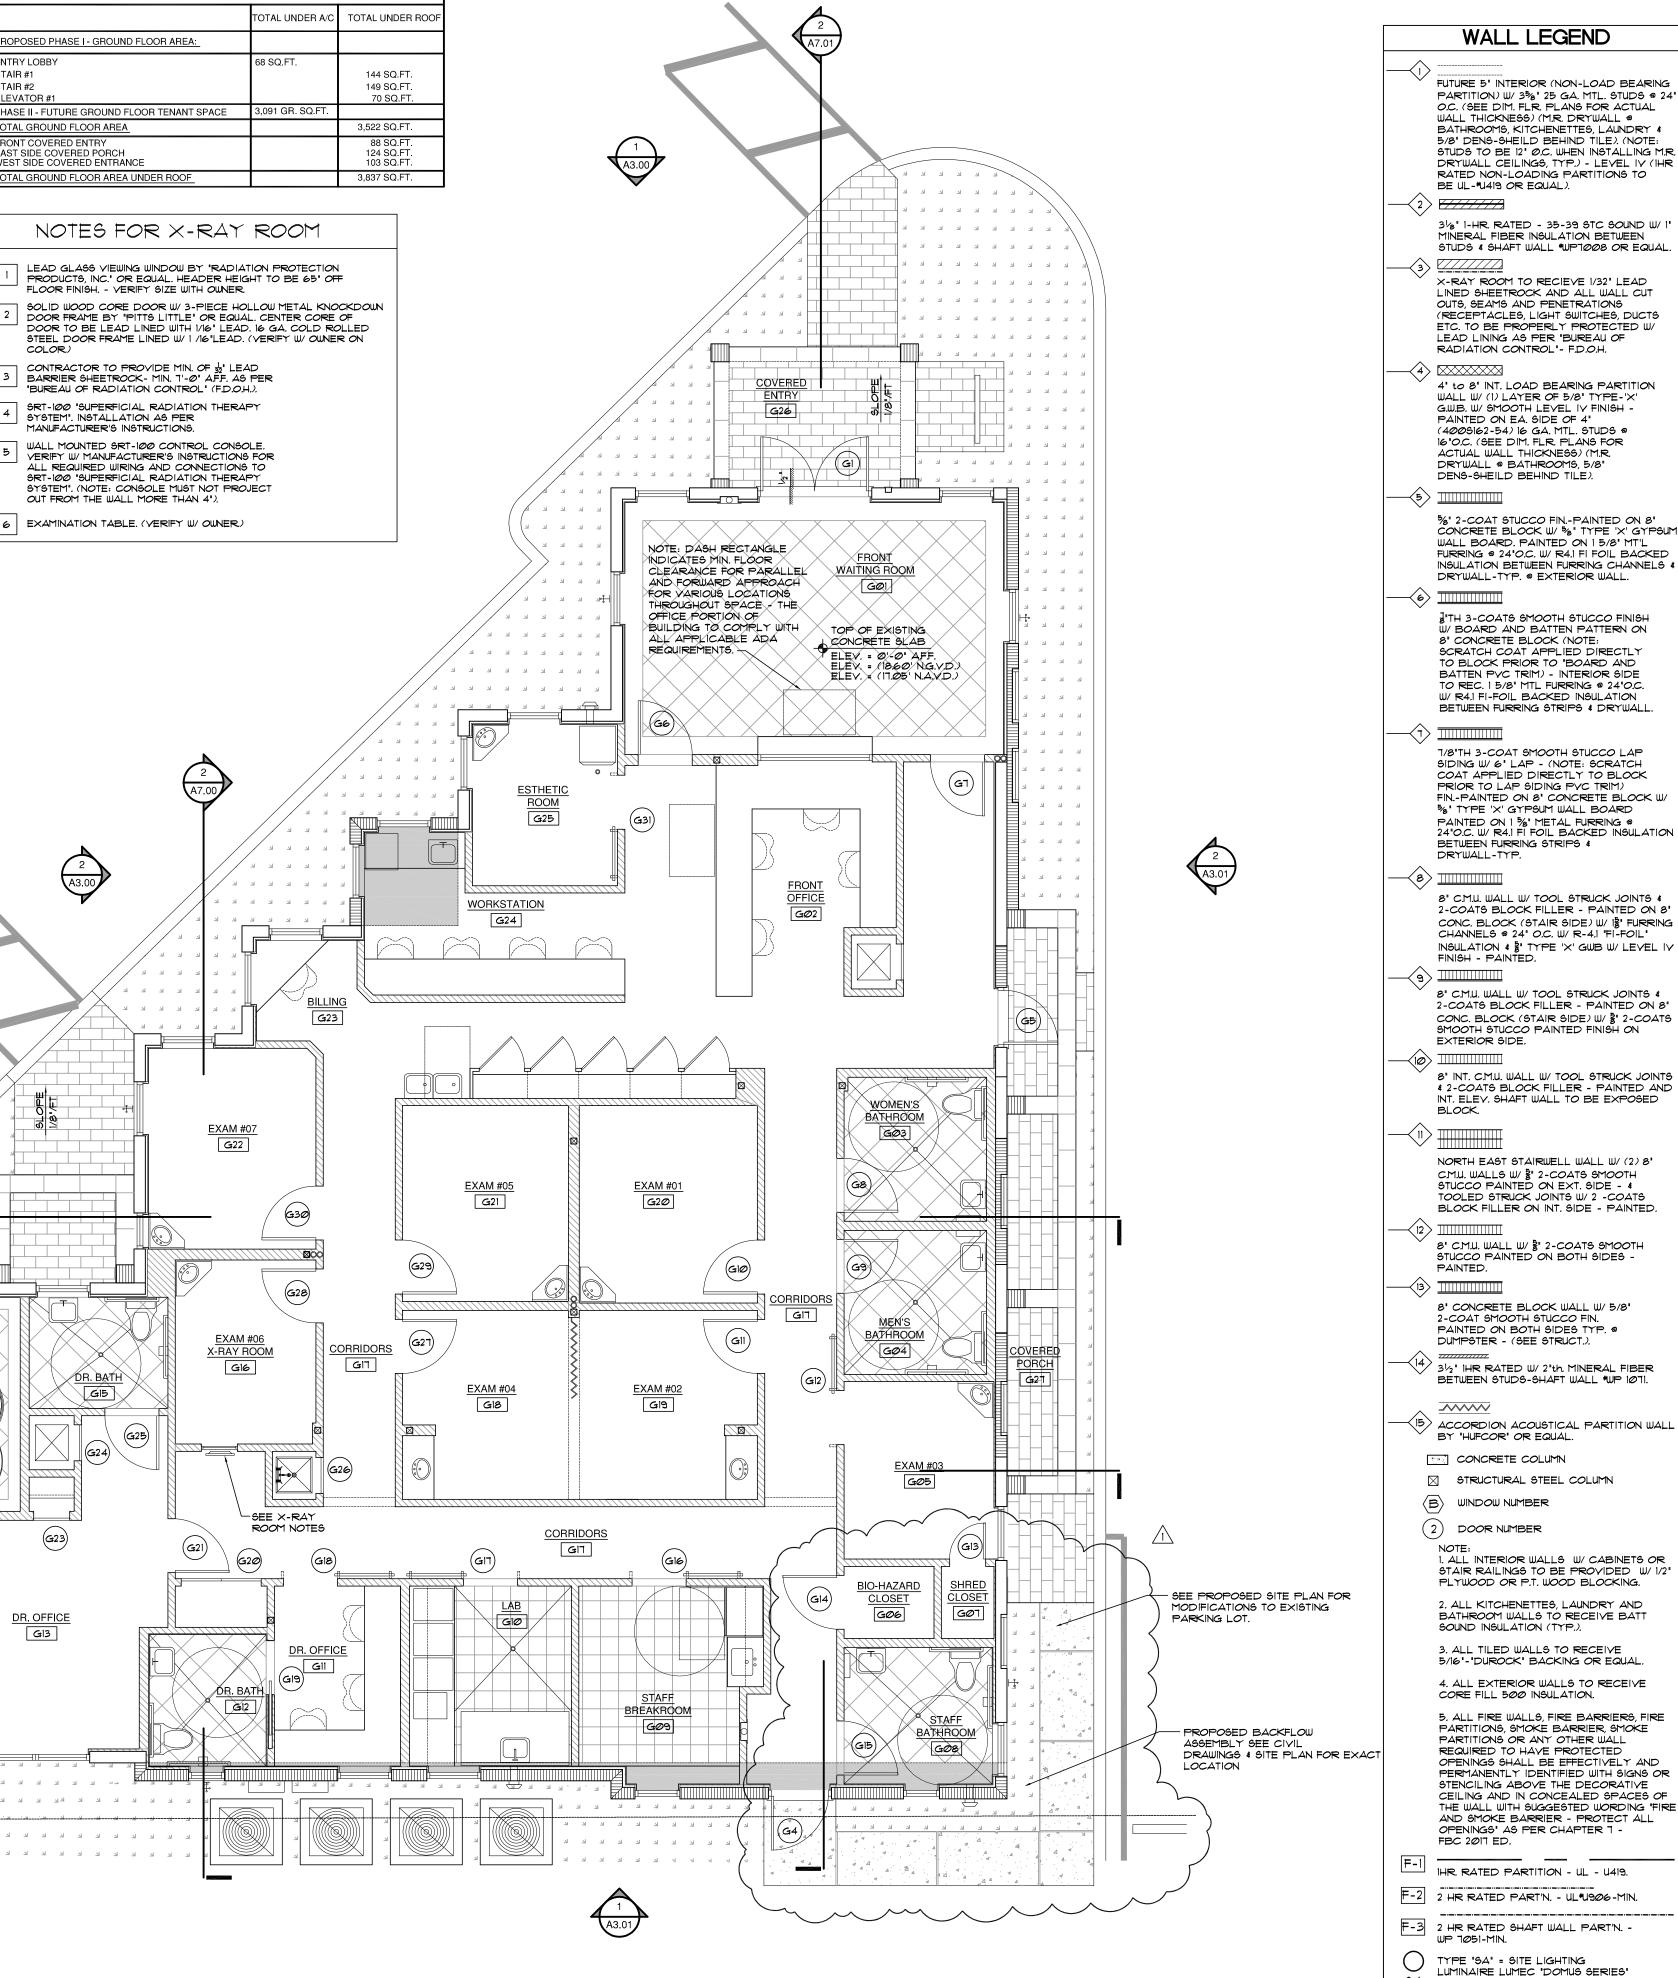

chitecture, in

architecture, planning and design AA-26002044

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ISSUED FOR BUILDING PERMIT BIDS 8. 10. 18 PERMIT

CONSTRUCTION

PROJECT TITLE

**MIXED USE** 

230 GEORGE BUSH **DELRAY BEACH, FL** 

CLIENT APPROVAL

REVISIONS REVISED 02.01.19 AS PER OWNER COMMENTS:

1. REVISED GROUND FLOOR AND RELOCATED EXIT DOOR.

SA CATALOG \* DMS50-135W80LED 4K-R-LE3F

NOTES:

1. DO NOT SCALE DRAWINGS!

(SEE GENERAL NOTES)

2. FIELD VERIFY ALL DIMENSIONS!

3. CONTRACTOR TO VERIFY ALL EXISTING CONDITIONS, AND NOTIFY ARCHITECT IF ANY DESCRIPANCY W/ DRAWINGS.

THIS DRAWING IS NOT FOR CONSTRUCTION, IT HAS BEEN ISSUED FOR GOVERNMENTAL REVIEW AND/OR PRELIMINARY PRICING

FILE NUMBER

616A200N

DRAWING TITLE

**PROPOSED GROUND FLOOR NOTED PLAN** 

> 3.13.17 GE/MJ

20150616

DRAWING NUMBER

A2.00N / SCALE : 3/16"=1'-0"

PROPOSED GROUND FLOOR NOTED PLAN

1. ALL RAMPS DEPICTED ON PLANS TO HAVE MAX. SLOPE OF 1:17 2. ALL DOORS & WINDOWS TO BE IMPACT RESISTANT AND COMPLY W/ ALL DADE COUNTY IMPACT AND WIND CYCLE TESTING REQUIREMENTS. 3. ALL EXTERIOR DOORS TO HAVE A 1/2" MAX. THRESHOLD. 4. ALL SIDEWALKS HAVE A MAX. SLOPE OF 2%.

51 LOW YOLTAGE /PANELS - TELEPHONE, SOUND SYSTEM & COMPUTER PANEL @ 60' AFF.

#### **FLOOR NOTES** 52 SECURITY ALARM ("ADT" OR EQUAL), TELEPHONE CONC. PAVERS NON SLIP - SAND SET ON I' BEDDING SAND - OVER 4' (AFTER COMPACTION) LIMEROCK BASE (LBRIOO) COMPACTED SUBGRADE 53 SIZE AND ACTUAL LOCATION. W/ 98 % MAX. DENSITY. NOTE: CONTRACTOR TO PROVIDE OWNER WITH SAMPLES FOR APPROVAL. O2 CONTRACTOR TO COORDINATE W/ FP&L ON NEW UNDERGROUND SERVICE. SEE SHEET AI.ØI DRAWING FOR H.C. PARKING Ø3 SPACES / SPEC. PIPE RAIL RING BIKE RACK AS PER DETAIL 8/A1.02 BY 'SOUTH 64 FLORIDA ALUMINUM" OR EQUAL. 6" x 6" CLEAR SMOOTH CEDAR WOOD COLUMNS TRASH ENCLOSURE - W/ 48" HT. CONCRETE LOW WALL W/ %" SMOOTH STUCCO PAINTED FINISH W/ SELF CLOSING, SELF LATCHING LOCKING DECORATIVE ALUMINIUM GATES - (MIN. 48' HT.) - SEE EXTERIOR ELEVATIONS & DOOR SCHEDULE. CONTRACTOR TO PROVIDE "KNOX-BOX" AS PER DELRAY 66 FIRE DEPT. (ACCESS FOR MAIN ENTRY AND GARAGE DOOR). LINE OF CONC. BALCONY ABOVE - SEE EXTERIOR ELEVATIONS 4 STRUCTURAL DRAWINGS. → AT SECOND FLOOR 08 ALL WALKWAY' TO HAVE A MAX. 2% CROSS SLOPE. "WATTZILLA DUO" - DUAL 80-AMP CAR CHARGER OR EQUAL - SEE ELECTRICAL DRAWINGS (CONTRACTOR TO INCLUDE IN BID FOR PRICING PURPOSES (LOCATED AT SOUTH EAST PARKING SPACES) -ALL A/C COMPRESSORS TO DE 4 TH CONC. TAD. CONTROL & SITE DETERMINED BY MECHANICAL ENGINEER. SEE HVAC PLAN & SITE PLAN. ALL A/C COMPRESSORS TO BE 4"TH CONC. PAD: CAPACITY AS 62 CONT 1 1/4"HT. x 4" COPPER DRIP EDGE @ ALL BALCONIES. NEW GAS GENERATOR - CONTRACTOR TO VERIFY EXISTING CAPACITY/DEMANDS W/ OWNER / UTILITY COMPANY FOR NEW ADDITION / BUILDING. - (NOTE: UNIT TO BE PROTECTED DURING CONSTRUCTION AND MAINTAINED). (2) GAS "TANKLESS" WATER HEATER OR EQUAL, CAPACITY AS DETERMINED BY PLUMBING ENGINEER - SEE PLUMBING PLAN. 13 HOSE BIB W/ VACUUM BREAKER - SEE PLUMBING DRAWINGS. 6' ht. CONC. WHEEL STOP - SEE CIVIL DRAWINGS FOR ALL EXTERIOR DOORS ('FLEMING' D OR EQUAL) TO BE IMPACT REGISTANT AND COMPLY W/ ALL DADE COUNTY IMPACT AND WIND CYCLING TESTING REQUIREMENTS. CONTRACTOR TO PROVIDE CERTIFICATE OF COMPLIANCE (TYP.) - SEE EXTERIOR ELEVATIONS AND DOOR SCHEDULE NOTE: DASH RECTANGLE INDICATES MIN. FLOOR CLEARANCE FOR PARALLEL AND FORWARD APPROACH FOR VARIOUS LOCATIONS THROUGHOUT SPACE - THE OFFICE PORTION OF BUILDING TO COMPLY WITH ALL APPLICABLE ADA REQUIREMENTS 4"th CONC SLAB (3000 PSI) W/ 6 x 6-W1.4 x W1.4 W.W.F. IN FLAT | 17 | SHEETS PLACED OVER 10-MIL POLYETHYLENE VAPOR BARRIER LAP 6" AND TAPE ALL JOINTS ON WELL COMPACTED FILL. TERMIT! TREATED (SOIL PREPARATION - 'DURBAN-TC' 1% - 5 GAL PER 10 S.F. OF SLAB AREA (SAW-CUT CONTROL JOINTS @ LESS THAN OR EQUAL TO 20'-0' EACH WAY) SEE STRUCTURAL DRAWINGS. BOND BREAKER ( 19 ISOLATION JOINT) - SEE STRUCTURAL DRIVES 34" SLAB RECESS @ PERIMETER OF EXTERIOR BLOCK WALLS FOR 6' HOLLOW CORE PLANKS W/ 2" TOPPING AT SECOND FLOOR - SEE STRUC. DRWG'S. - NOTE: SECOND FLOOR BALCONIES TO BE POURED CONCRETE W/ 2" STEP DOWN (FINISH DECK W/ 1/2" MAX. | 21 | CONTINUOUS I-HR RATED 8' CONCRETE BLOCK WALL W/ 5/2 TYPE 'X' J GYPSUM WALL BOARD W/LEVEL IV FINISH - PAINTED ON 18". FURRING CHANNELS @ 24 O.C. INT. SIDE. -ALL EXTERIOR WALLS. AND STAIR WALLS TO BE FILLED W/'TAILORED FOAM OF FLORIDA, INC"- "CORE-FILL 500" OR EQUAL (NOTE: INTERIOR STAIRWELL WALLS TO BE EXPOSED C.M.U. PAINTED WITH BLOCK FILLER & TOOL NON-LOAD BEARING 5' INT. PARTITION WALL W/ (1) LAYER OF 5/8" 22 TYPE-'X' G.W.B. W/ SMOOTH LEVEL IV FINISH - PAINTED ON EA. SIDE OF 35/8" 20 GA. MTL. STUDS @ 24" O.C. W/ BATT. SOUND INSULATION (SEE DIM. FLR. PLANS FOR ACTUAL WALL THICKNESS) (M.R. YWALL @ BATHROOMS, 5/8' DENS-SHEILD BEHIND TILE). (NOTE: STUDS TO BE 12" O.C. WHEN INSTALLING M.R. DRYWALL CLG'S. (TYP.) (NOTE: UL\*U419 FOR IHR RATED PARTITIONS - IF APPLICABLE). RECESSED ELECTRICAL OUTLETS AND SWITCH BOXES IN ONE HOUR 23 FIRE RATED PARTITION SHALL BE METALLIC WITH A SURFACE NOT 6 x 6 NON-SKID CERAMIC TILE - COMPLY W/ ADA (VERIFY W/ OWNER ON STYLE AND COLOR) TO EXCEED 16 SQ. IN. AND THE SURFACE AREA OF THE BOX SHALL NOT EXCEED 100 SQ. IN. PER 100 SQ. FT. OF WALL SURFACE. BOXES LOCATED ON THE OPPOSITE SIDE OF THE PARTITION SHALL BE SEE FLOOR PLAN FOR LOCATION OF 5 LB. (ABC) RATING FIRE 24 EXTINGUISHERS AND WALL HANGERS - TOP OF EXTINGUISHERS MAX 40" ABOVE FLOOR - FOR PRICING PURPOSES USE RECESSED CABINETS - "LARSENS" SOLID DOOR W/ BLACK TYPE A - DIECUT LETTERING (STAINLESS STEEL) #FSO -2409. TYPE 'X' GYPSUM WALL BOARD - PAINTED ON IS" FURRING § TYPE 'X' GYPSUM WALL BOARD - MAINTED ON 18 MICHANNELS & 24" O.C. W/ R4.1 FI-FOIL INSULATION BETWEEN FURRING \$ 40" A.F. MAX.TO BTM. OF REFLECTIVE SURFACE. MAINTAIN PROPER FIRE RATING AT ALL PENETRATIONS OF RATED 85 BOBRICK SOAP DISPENSER WALL ASSEMBLIES IE. MECHANICAL AND ELECTRICAL SERVICE RUNS - SEE SHEET AS Ø5. FURRED OUT WALL 6' TO 8' FOR PLUMBING STACK - SEE PLUMBING PLANS FOR LOCATIONS. 87 WALL MTD. LAVATORY AT 30' A.F.F. TO BOTT. OF APRON. BATT SOUND INSULATION TO BE INSTALLED IN ALL WALLS. (TYP. AIR HANDLING UNIT: CAPACITY AS DETERMINED BY MECHANICAL 29 ENGINEER SEE HYAC PLAN, ALL UNITS TO BE EQUIPPED W/ UY LIGHT AT COIL & DRAIN PAN. 30 SEE MECHANICAL DRAWING FOR ALL DUCT WORK SIZES AND SPECIFICATIONS (NOTE: STRUCTURAL STEEL AND A/C SUBCONTRACTOR TO COORDINATE ALL SHOP DRAWINGS PRIOR TO FABRICATION TO AVOID ALL CONFLICTS). 31 STACKABLE WASHER AND DRYER TO BE SELECTED BY OWNER. PREFAB LAUNDRY CONNECTION BOX FOR WASHER AND DRYER DOUBLE HOSE BIBB OUTLET CONNECTION OUTLET BOX W/ DRAIN BOX - 'SIOUX CHIEF 696 SERIES' OR EQUAL. GALY. METAL DRYER VENT THRU FRONT WALL. DRYER VENT SHALL 33 NOT EXCEED MANUFACTURER'S. RECOMMENDATION, AND/ OR 25'L. PROVIDE RECESSED WALL MOUNTED DRYER VENT HOSE RECEPTACLE DRYER BOX \*480 "IN-O-YATE TECHNOLOGIES" OR EQUAL. 34 STAINLESS STEEL SINK BY "ELKAY ASANA" OR EQUAL. 19-5/8" x 16-11/16" x 6" - SINGLE BOWL TOP MOUNT W/ "AMERICAN STANDARD" ALL EXTERIOR DOORS & WINDOWS TO HAVE 'DYMONIC 100' CAULKING @ BUCK/CMU/ALUM. FRAME CONDITIONS (TYP.) ALUMINUM EXTERIOR DOOR THRESHOLD SET IN MASTIC OVER 'GRACE VYCOR PLUS' - MIN. 12' TURN @JAMB. (W/ 1/2" MAX. HT. ALL WINDOW CORNERS & SILLS TO BE WRATTED W. GARDES VYCOR PLUS' WINDOW SEAL, TURNING UP 12' @ JAMBS (NOTE: WINDOW TO HAVE CAST-IN-PLACE CONC. SILLS, 38 ALL WINDOWS TO HAVE I X F.T. WID BUCKS ANCHORED TO CONC. AS PER PRODUCT APPROVAL. 'PGT' SINGLE HUNG & FIXED ALUM. WINDOWS (COLOR: BLACK) TO BE IMPACT RESISTANT AND COMPLY W/ALL DADE COUNTY IMPACT AND WIND CYCLING TESTING REQUIREMENTS CONTRACTOR TO PROVIDE CERTIFICATE OF COMPLIANCE (TYP... 'PGT' - FAUX - FIXED WINDOW W/ INTERIOR SIDE TO BE 40 PAINTED BLACK (TYP.) SEE DETAIL FOR RECESSED STUCCOED 4" CONC. BLOCK). ENDURA 25A BY THYSSENKRUPP ELEVATOR OR EQUAL. -CONTRACTOR TO PROVIDE SIGNED & SEALED SHOP DRAWINGS FOR ARCHITECT/STATE APPROVAL. EXPOSED CMU. WALLS TO BE PAINTED W/ BLOCK FILLER (TYP. AT STAIRWELLS) - VERIFY W/ OWNER. $^{43}$ $^{11/2}$ DIA. PIPE GUARDRAIL SHALL BE SHOP PRIMED & FIELD PAINTED - TOP OF RAIL MIN. 42' WITH VERTICAL PICKETS TO BLOCK PASSAGE OF 4" SPHERE. (BOTTOM RAIL MAX. 2" ABOVE FINISH TOP LANDING), PROVIDE SHOP DRAWINGS/ SAMPLE FOR OWNER APPROVAL - SEE SHEET A400 44 ALL STAIR WALL RAIL SHALL EXTEND 12' BEYOND THE BOTTOM RISER. THE RAIL SHALL CONTINUE TO SLOPE FOR ONE TREAD LENGTH AND SHALL RETURN TO THE WALL. CONTRACTOR TO PROVIDE SHOP DRAWINGS FOR APPROVAL PRIOR TO FABRICATION. - SEE SHEET A4.00 45 CONCRETE STAIR & LANDING - CONTRACTOR TO PROVIDE SHOP DRAWINGS FOR APPROVAL PRIOR TO FABRICATION. HANDRAIL SHALL WRAP CONTINUOUSLY AROUND LANDINGS - ALL 46 RAILINGS & STEEL BRACKETS TO BE FIELD PRIMED AND PAINTED COLOR CHARCOAL GRAY -SEE SHEET A4.03/A4.04. SEE ELECTRICAL & PLUMBING PLAN FOR DRINKING FOUNTAIN CONNECTION - "ELKAY" OR EQUAL - "LZSTL86C @ OFFICE - WALL MOUNTED FOUNTAIN. SEE ELECTRICAL DRAWINGS FOR EXACT LOCATION OF ALL 48 PANELS & SPEC'S.

49 ELECTRICAL SERVICE PANEL ® 60' ABOVE FLOOR, SEE ELECTRICAL DRAWINGS.

MAIN DISCONNECT, ELECTRICAL PANELS -SEE ELECTRICAL

51 LOW VOLTAGE /PANELS - TELEPHONE, SOUND SYSTEM & COMPUTER PANEL @ 60" AF.F.

\$ CABLE PANEL ® 60° A.F.F.

SEE STRUCTURAL DRUGS.

SMOOTH STUCCO FINISH, PAINTED TYP

PROTECTED AS PER SHEET AS.05.

COMPLY W/ ADA REQUIREMENTS.

COVERINGS - VERIFY W/ OWNER.

INTERSECTING WALL & CEILING.

40" A.F.F. MAX. W/ SURFACE MTD.

MAX. W/ SURFACE MTD.

IN SHOWER PAN.

CONNECTIONS (TYP. @ ALL OFFICE BATHROOMS).

AN EMERGENCY (ALL DOORS TO BE ADA COMPLIANT).


BOBRICK SANITARY NAPKIN DISPENSER BOTTOM AT


BOBRICK MIRROR ABOVE SINK BOTTOM MOUNTED AT

MIN. THICKNESS W/ BRUSHED CHROME CLIPS.

STUCCO PAINTED FINISH.

(W/ I'  $\times$  10' 'AZEX' TRIMMED BASE & I'  $\times$  I'  $\otimes$  THE TOPSEE STRUCT. DRAWINGS FOR HIDDEN CONNECTIONS.

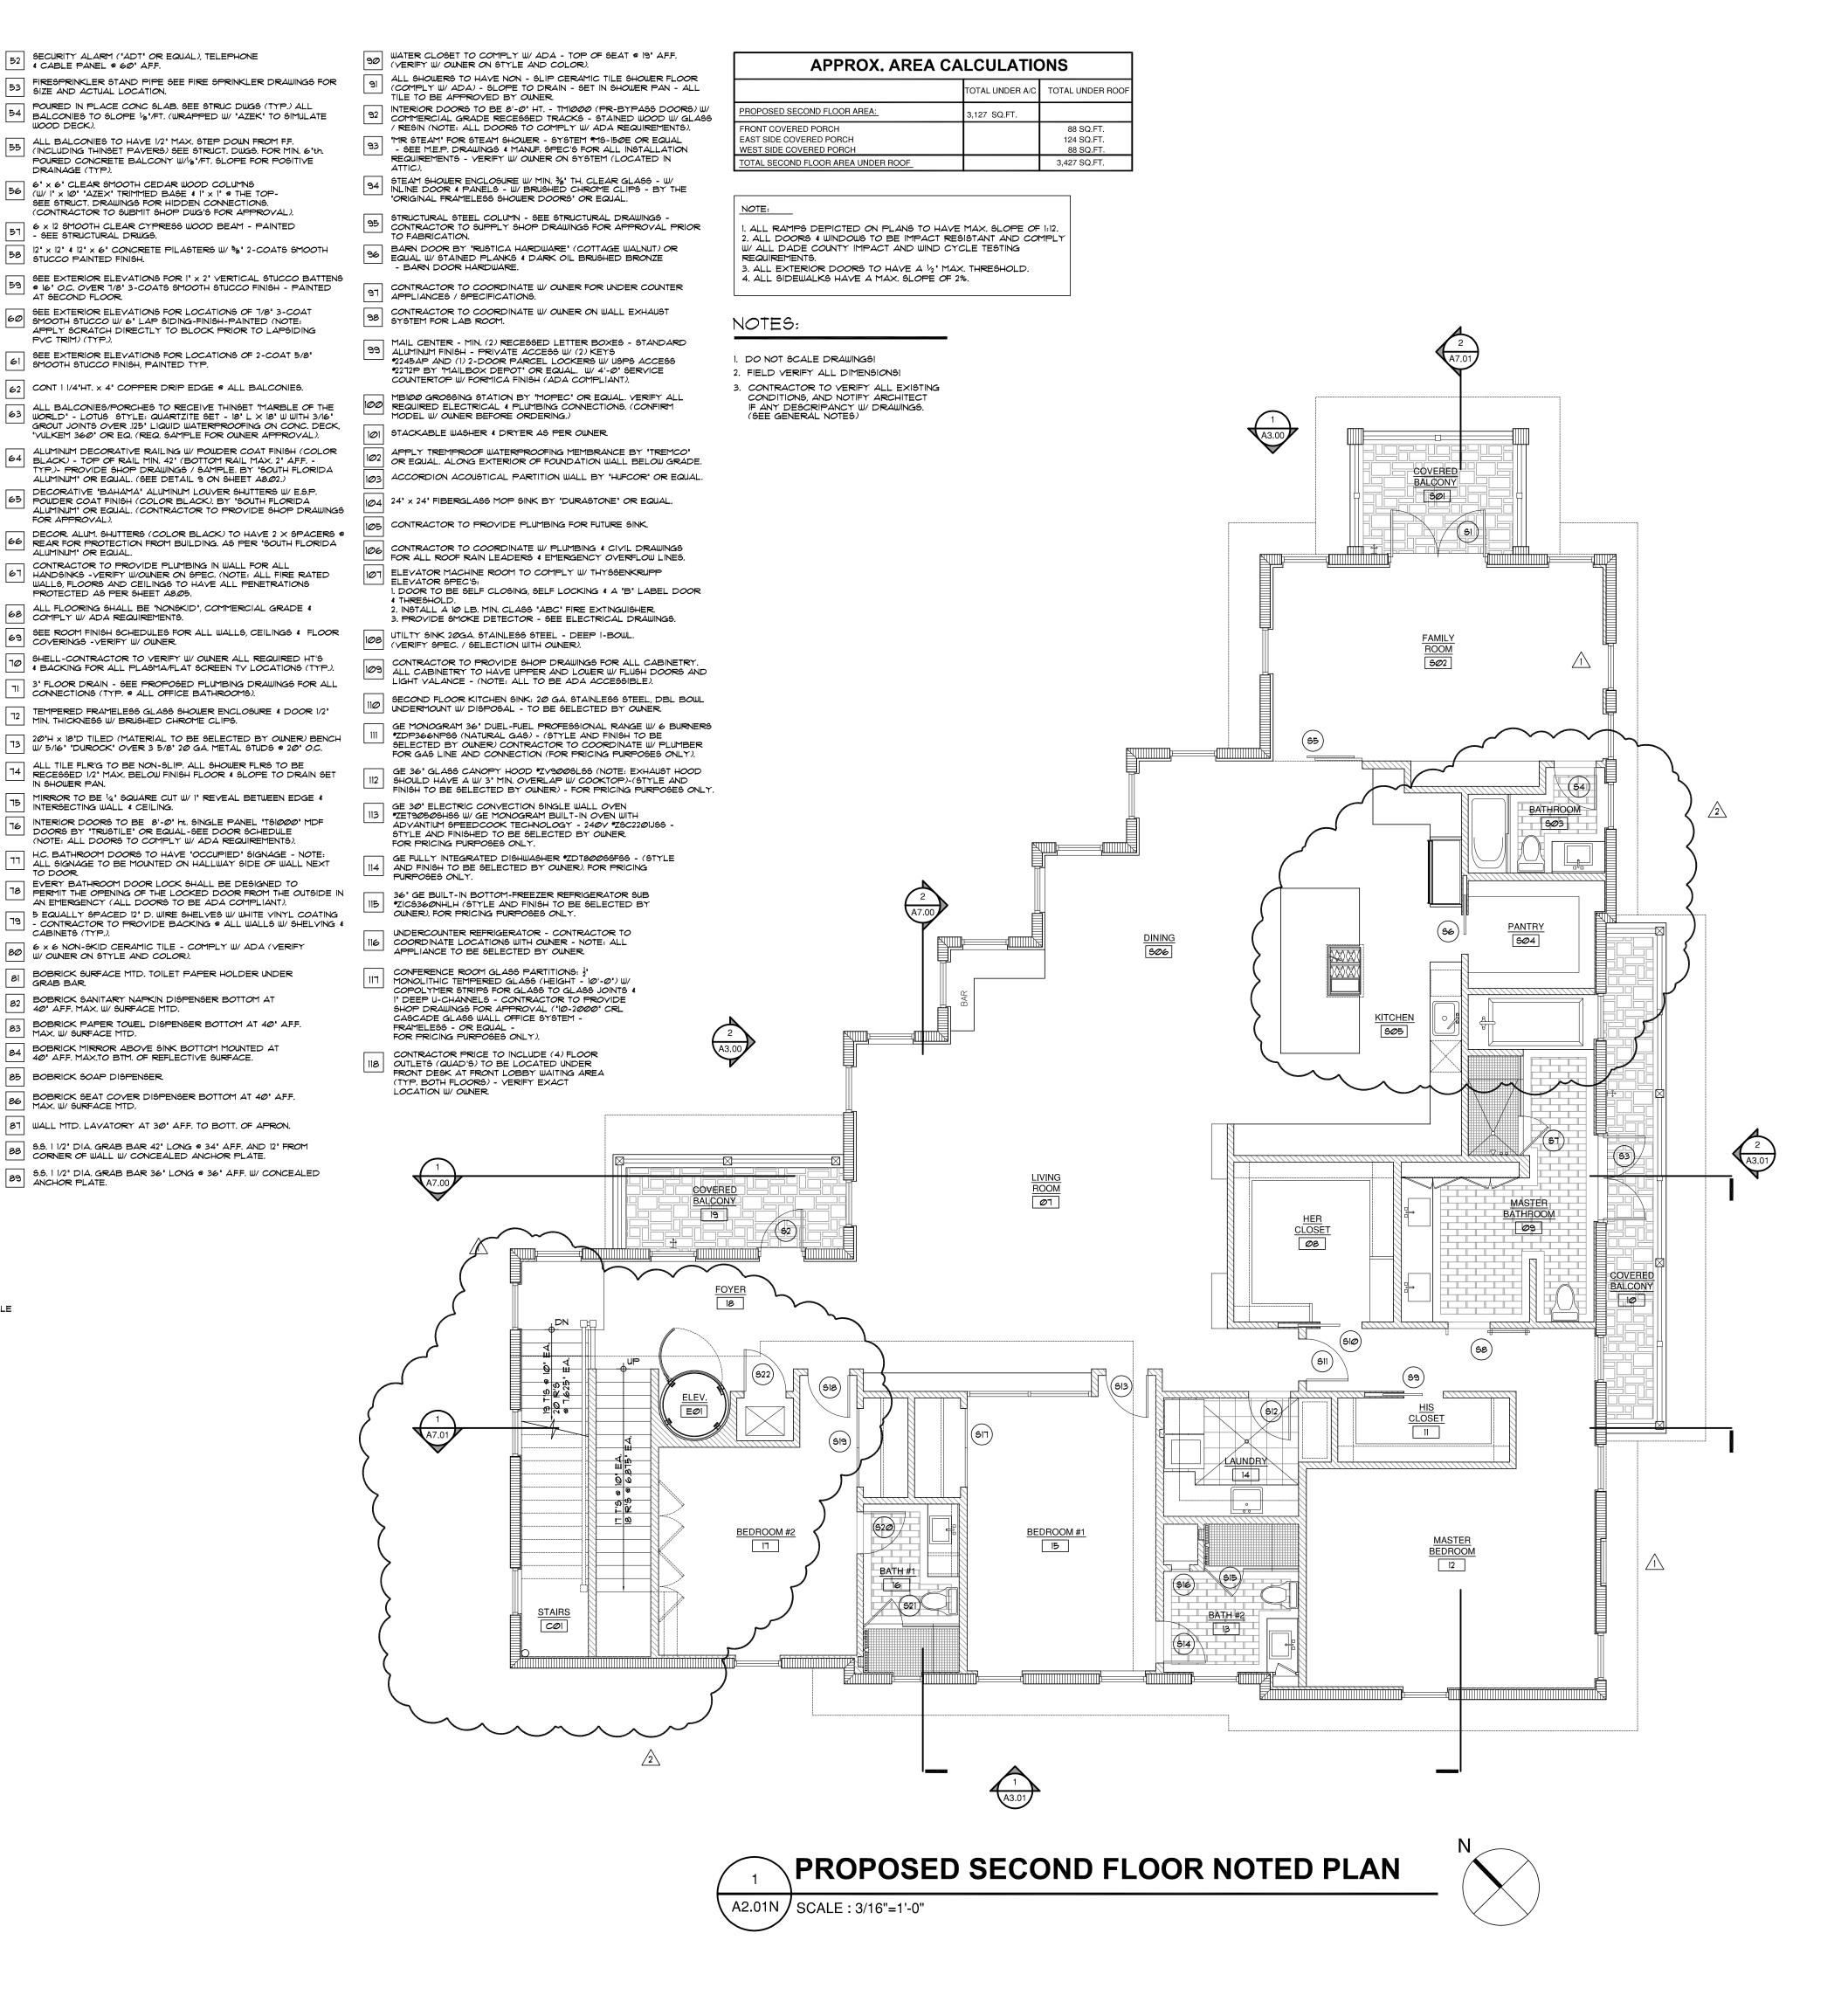

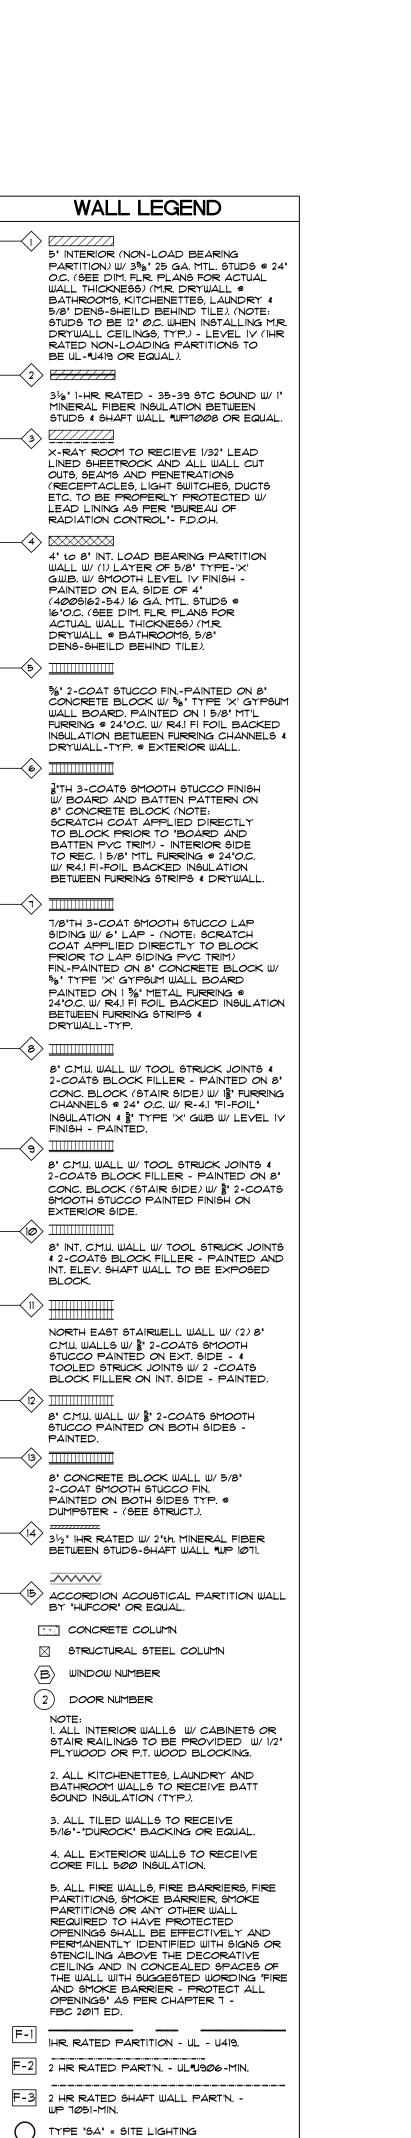

 $\langle 2 \rangle$ 

\_\_\_\_\_\_

DRYWALL-TYP.

EXTERIOR SIDE.

PAINTED.

LUMINAIRE LUMEC 'DOMUS SERIES'
SA CATALOG \* DMS50-135W80LED 4K-R-LE3F



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Delray Beach, Florida 33483

ISSUED FOR BUILDING PERMIT BIDS 8. 10. 18

PERMIT

CONSTRUCTION

PROJECT TITLE

**MIXED USE** BUILDING **ADDITION** RENOVATION

230 GEORGE BUSH BLVD. **DELRAY BEACH, FL** 

CLIENT APPROVAL

REVISIONS

REVISED Ø8.16.17 AS PER P\$Z COMMENTS: 1. CONVERTED DECORATIVE LOUVERS & FAUX WINDOWS OFF OF STAIR #1 & STAIR #2 INTO REAL 2. REMOVED A/C & ELECTRICAL

CLOSETS IN HALLWAY. REVISED 02.01.19 AS PER OWNER COMMENTS: 1. ELIMINATED INTERIOR STAIRWELL. 2. REVISED SECOND FLOOR

RESIDENCE.

THIS DRAWING IS NOT FOR CONSTRUCTION, IT HAS BEEN ISSUED FOR GOVERNMENTAL REVIEW AND/OR PRELIMINARY PRICING

FILE NUMBER

DRAWING TITLE

616A201N

**PROPOSED SECOND FLOOR NOTED** 

**PLAN** 3.20.17 GE/JC

JOB NUMBER 20150616

<u>LEGEND:</u>

INDICATES ROOF OVERHANG. (TYP.)

INDICATES PRECAST HEADER OVER OPENING, SEE TYPICAL 6:12 SLOPE FOR MAIN ROOF \$ 3:12 SLOPE FOR PITCH BREAK STRUCT. DWG'S FOR SIZE AND CONNECTION

NOTE: CONTRACTOR TO PROVIDE MECHANICAL AND TRUSS FABRICATOR

WITH ALL THE APPROPRIATE DRAWINGS FOR COORDINATION OF DUCT WORK PENETRATIONS, THROUGHOUT THE STRUCTURE. (TYPICAL) NOTE: ROOF ATTIC SHALL COMPLY W/ FBC - 2017 ED - ATTIC SPACE

NOTE: ROOF TO BE "CLOSED SYSTEM" USING BLOWN ON R-20 "ICYNENE" INSULATION (OPEN CELL W/PROTECTIVE COATING "DC-315") BY "GALE INSULATION" OR EQUAL TO THE UNDERSIDE OF THE ROOF SHEATHING (TYP.).

4 LOWER ROOF CONDITIONS.

RC	ROOF DRAINAGE CALCULATIONS							
RAIN FALL RATE (5 IN. / HR.), AS PER SECTION 1106 F.P.C. 2011	ROOF AREA 'A'	ROOF AREA 'B'	ROOF AREA 'C'	ROOF AREA 'D'	ROOF AREA 'E'			
ROOF AREA (HORIZONTALLY PROJECTED)	88 S.F.	632 S.F.	201 S.F.	500 S.F.	278 S.F.			
PLUS / AREA OF PARAPET WALL: AREA OF CONTRIBUTING:	N/A	244 S.F. @ 50% = 122 S.F.	128 S.F. @ 50% = 64 S.F.	204 S.F. @ 50% = 102 S.F.	224 S.F. @ 50% = 112 S.F.			
UPPER ROOF:	N/A	N/A	N/A	N/A	N/A			
TOTAL ROOF AREA:	88 S.F.	754 S.F.	562 S.F.	602 S.F.	390 S.F.			
VERTICAL CONDUCTORS AND LEADERS FROM TABLE 1106.2								
REQUIRED LEADER DIMENSIONS	(1) <b>3" dia.</b> (1,760 S.F.)	(1) 3" dia. (1,760 S.F.)	(1) <b>3" dia.</b> (1,760 S.F.)	(1) 3" dia. (1,760 S.F.)	(1) 3" dia. (1,760 S.F.)			
PROVIDED LEADER DIMENSIONS	(1) 4" dia. (3,680 S.F.)	(1) 4" dia. (3,680 S.F.)	(1) 4" dia. (3,680 S.F.)	(1) 4" dia. (3,680 S.F.)	(1) <b>4" dia.</b> (3,680 S.F.)			
PROVIDED 3" DIA. O	VERFLOW DRAINS IN ADDITION	FOR EMERGENCY OVERFLOW O	CONDITIONS					

PARAPET HEIGHT EXCEPTION:


AS PER F.B.C. 2017 - SECTION 705.11.4:

1. WHERE ROOF AND CEILING FRAMING ELEMENTS ARE PARALLEL TO THE WALLS, SUCH FRAMING AND ELEMENTS SUPPORTING SUCH FRAMING SHALL NOT BE OF LESS THAN 1-HOUR FIRE-RESISTANCE-RATED CONSTRUCTION FOR A WIDTH OF 10 FEET MEASURED FROM THE INTERIOR SIDE OF THE WALL.

2. WHERE ROOF AND CEILING FRAMING ELEMENTS ARE NOT PARALLEL TO THE WALL, THE ENTIRE SPAN OF SUCH FRAMING AND ELEMENTS SUPPORTING SUCH FRAMING SHALL NOT BE OF LESS THAN 1-HOUR FIRE-RESISTANCE-RATED CONSTRUCTION.


3. OPENINGS IN THE ROOF SHALL NOT BE LOCATED WITHIN 10 FEET OF THE 1-HOUR FIRE-RESISTANCE-RATED EXTERIOR WALL MEASURED FROM THE INTERIOR SIDE OF THE WALL.

4. THE ENTIRE BUILDING SHALL BE PROVIDED WITH NOT LESS THAN A CLASS B ROOF COVERING.

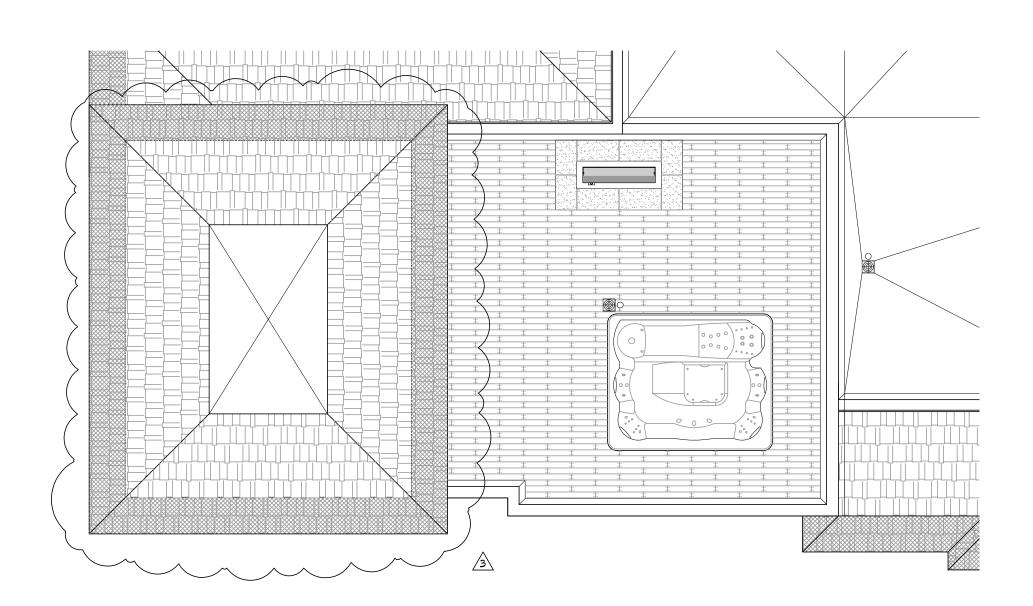

PROPOSED SUNDECK PLAN

A2.02 / SCALE : 3/16"=1'-0"

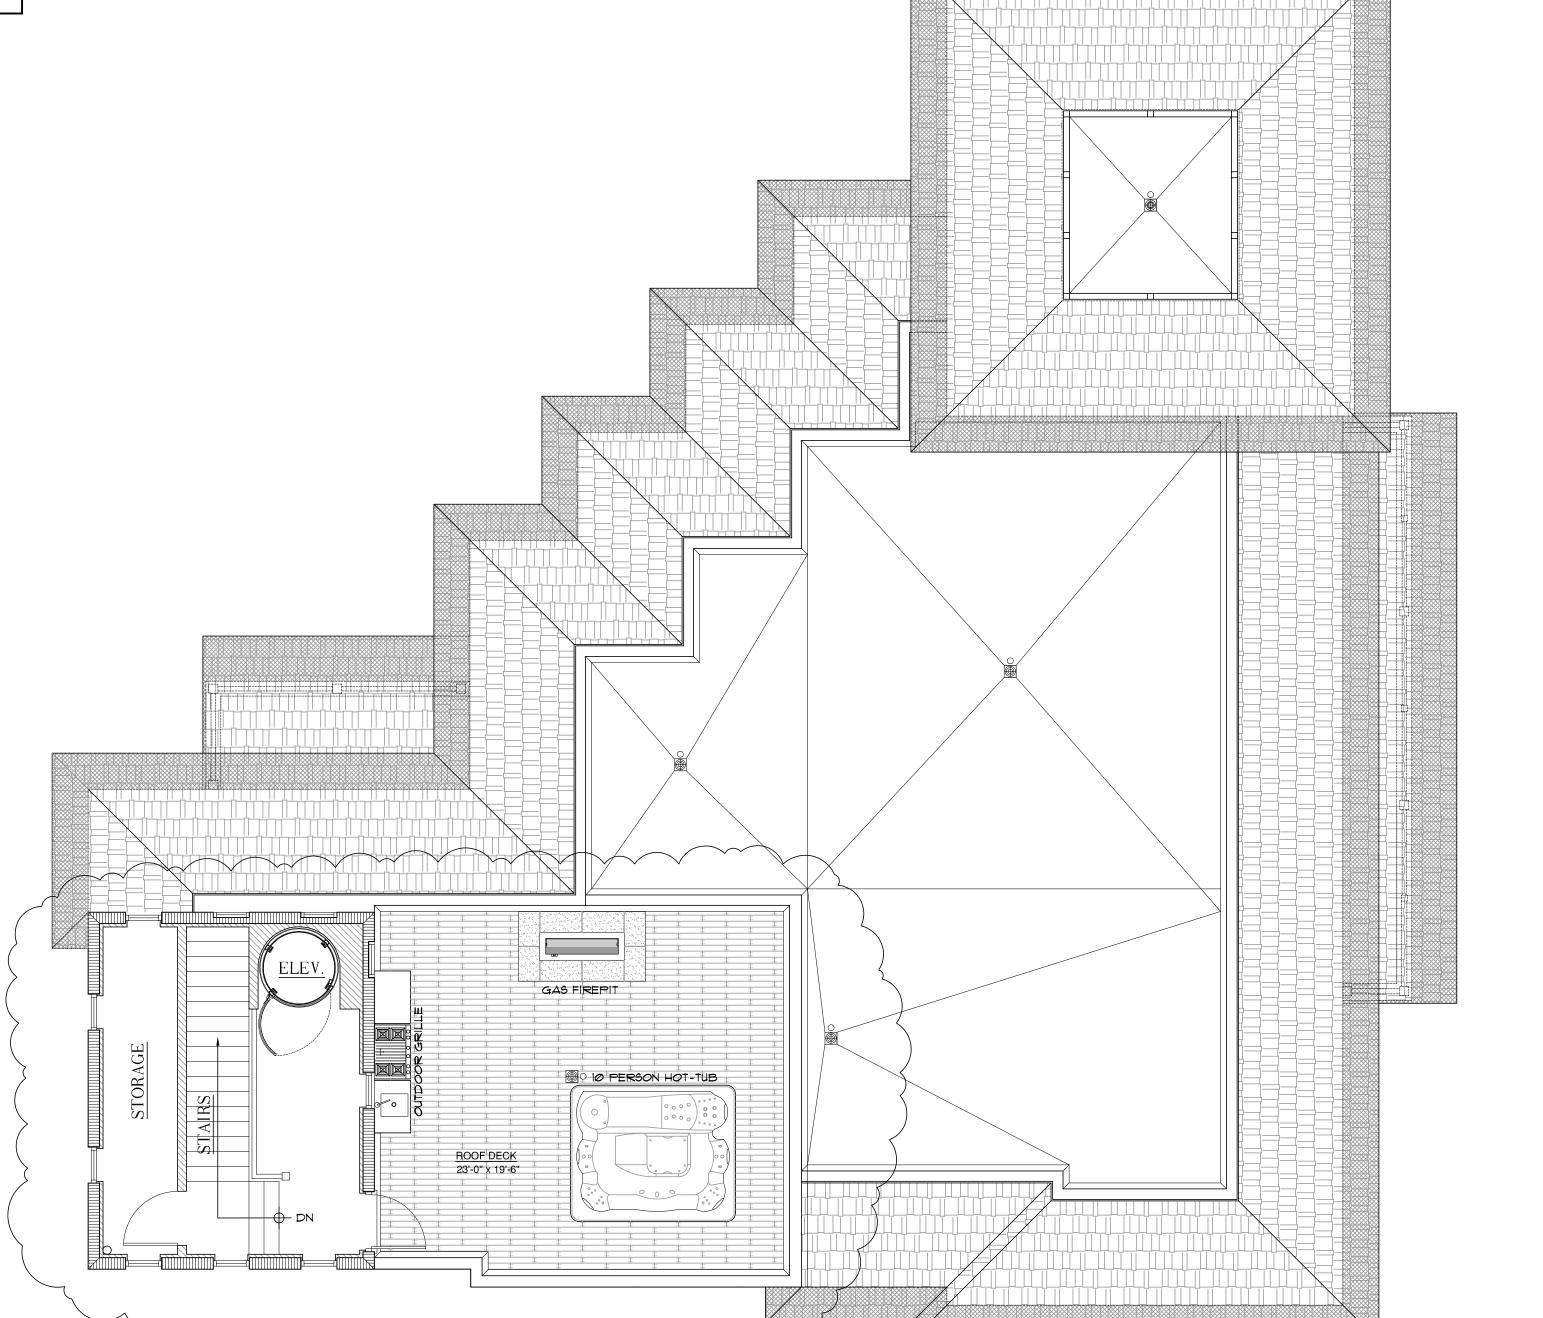





NOTES:

I. DO NOT SCALE DRAWINGS! 2. FIELD VERIFY ALL DIMENSIONS! CONTRACTOR TO VERIFY ALL EXISTING CONDITIONS, AND NOTIFY ARCHITECT IF ANY DESCRIPANCY W/ DRAWINGS. (SEE GENERAL NOTES)



## Designer AA-26002044

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I ISSUED FOR BUILDING PERMIT

BIDS 8. 10. 18

PERMIT

CONSTRUCTION

PROJECT TITLE

# **MIXED USE** BUILDING **ADDIITON** / **RENOVATION**

## 230 GEORGE BUSH BLVD. **DELRAY BEACH, FL**

CLIENT APPROVAL

REVISIONS

REVISIONS

REVISED 8.10.18 AS PER PLAN
REVIEW COMMENTS:

1. PROVIDED NOTE OUTLINING
DECORATIVE RAILING LOAD
REQUIREMENTS.

2. RELOCATED ROOF ACCESS
HATCH TO AS TO BE MIN. 10'-0"
AWAY FROM INSIDE FACE OF
PARAPET.

3. PROVIDED LIFELINE ANCHORAGE
FOR MAINTENANCE WORKERS.

4. NOTED PARAPET HEIGHT
EXCEPTION CRITERIA BASED ON
BUILDINGS 1-HOUR FIRE RATING
RESISTANCE.

REVISED 11.16.18 AS PER OWNER COMMENTS:

1. EXTENDED STAIRS TO ROOF

REVISED 02.01.19 AS PER OWNER COMMENTS:

1. EXTENDED ELEVATOR TO ROOF DECK.

THIS DRAWING IS NOT FOR CONSTRUCTION, IT HAS BEEN ISSUED FOR GOVERNMENTAL REVIEW AND/OR PRELIMINARY PRICING

FILE NUMBER

616A202

DRAWING TITLE PROPOSED **ROOF PLAN** 

GE/JC 3.20.17 JOB NUMBER

20150616

DRAWING NUMBER

**A2.02** 



### ELEV. = 34'-10' AFF. L TOP OF ROOF DECK ELEV. = 32'-11" A.F.F. MEAN ROOF HT. ELEV. = 31'-3" AFF. ROOF BEARING HT ELEV. = 29'-2" A.F.F. TOP OF PARAPET ELEV. = 29'-0' AFF. LOW ROOF BEARING HEIGHT TOP OF CONCRETE SUN DECK (CEILING HEIGHT) ELEV. = 24'-8" AFF. ELEV. = 24'-0" A.F.F. TOP OF SECOND FLOOR L DOORS & WINDOWS TOP OF SECOND FLOOR DOORS & WINDOWS ELEV. = 20'-8" AFF. ELEV. = 20'-8" A.F.F. SECOND FLOOR FINISH (TOP OF CONCRETE BEAM) SECOND FLOOR FINISH (TOP OF CONCRETE BEAM) ELEV. = 12'-8" A.F.F. ELEV. = 12'-8" A.F.F. TOP OF GROUND FLOOR DOORS & WINDOWS ELEV. = 8'-0' AFF. GROUND FLOOR FINISH GROUND FLOOR FINISH ELEV. = 0'-0' AFF. ELEV. = (1860' NG.V.D.) ELEV. = (17.05' N.A.V.D.) ELEV. = Ø'-Ø' AFF. ELEV. = (1860' NG.V.D.) ELEV. = (17.05' N.A.V.D.) AVERAGE CROWN OF ROAD ELEV. = -1'-4'4" BFF. ELEV. = (17.25' NG.V.D.) ELEV. = (15.7' N.A.V.D.)

## **EXTERIOR STUCCO**

1. APPLY SCRATCH COAT WITH SUFFICIENT PRESSURE TO KEY WELL INTO LATH. TROWEL AFTER INITIAL SET AND SCRATCH TO ROUGHEN SURFACE. 2. APPLY BROWN COAT AFTER SCRATCH COAT HAS SET FIRM AND HARD AND HAS BEEN STRAIGHTENED TO A TRUE SURFACE WITHOUT THE USE OF ADDITIONAL WATER.

#### 3. DAMPEN BROWN COAT EVENLY PRIOR TO APPLICATION OF FINISH COAT. APPLY FINISH COAT AND BRING FINISH COAT TO A TRUE, EVEN SURFACE, FINISHED AS

4. TWO (2) COAT WORK (ON MASONRY): APPLY TWO (2) COAT STUCCO TO CONCRETE AND MASONRY AREAS' TOTAL THICKNESS, FIVE-EIGHTHS (5/8) INCH MINIMUM. 5. THREE (3) COAT WORK (ON LATH): APPLY THREE (3) COAT STUCCO TO METAL 

6. RUN DRIP GROOVES IN STUCCO. PROVIDE RUN DRIP GROOVES IN EXTERIOR DOORWAY HEADS AND EXTERIOR WINDOW HEADS. 1. ALL STUCCO HEADERS, SILLS AND BANDING TO BE PROVIDED WITH A MIN. 1/8" SLOPE FOR PROPER SHEDDING OF RAIN WATER.

8. ALL POLYSTYRENE BOARD SHALL BE INSTALLED AS PER CURRENT MANUFACTURER'S PUBLISHED INSTRUCTIONS FOR INSTALLATION OF SYSTEM AS APPLICABLE TO EACH TYPE OF SUBSTRATE INDICATED. REINFORCING FABRIC CONSISTS OF A BALANCED, ALKALINE-RESISTANT OPEN-WEAVE GLASS-FIBER COMPLING WITH ASTM D 578 AND WEIGHING NOT LESS THAN 8 OZ. PER SQUARE YARD.

WIND PRESSURES ( PSF )
EXTERIOR DOORS, WINDOWS,
COMPONENTS AND CLADDING
COM CITETIO AND CEADDING

TRIBUTARY AREA (ft ) <sup>2</sup>	ZONE (4)		ZONE (5)	
	(+) POSITIVE	(-) NEGATIVE	(+) POSITIVE	(-) NEGATIVE
1 TO 2Ø	41	-48	41	-60
21 TO 50	39	-46	39	-56
51 TO 100	37	-44	37	-50
101 TO 150	35	-42	35	-46
151 TO 25Ø	34	-41	34	-44
NOTES:				

#### P-3 BRILLIANT WHITE - STUCCO HEADERS, SILLS, BANDING AND FASCIA. GRAND TETON WHITE \*AC-42 P-4 (LAP-SIDING) P-5 'IWP' - FIBERGLASS ENTRY DOOR W/ 'MAHOGANY' FINISH. BLACK BEAUTY \*2128-10 DECORATIVE ALUM. RAILINGS, ALUMINUM SHUTTERS & WINDOW FRAMES. NOTE: ALL COLORS ARE FOR PRICING PURPOSES

LIGHT FIXTURES

#BCD90070BZ - ELECT. WALL

ALL LIGHT FIXTURES TO BE APPROVED BY

(F) TROY LIGHTING "NEWTON"

G TROY LIGHTING "NEWTON"

CEILING MOUNTED.

#FCD90040BZ - ELECT.

PAINT LEGEND

-1 (SMOOTH STUCCO & "BOARD & BATTEN")

ALL SURFACES TO BE CLEANED &

PRIMED AS PER BENJAMIN MOORE.

P-2 SHINGLE ROOFING SYSTEM 'GAF'

ONLY, CONTRACTOR TO PROVIDE SAMPLES FOR

SECOND FLOOR STRUCTURE & ROOF

MOUNTED.

OWNER/ARCHITECT

P-1 ACADIA WHITE \*AC-41

"PEWTER GRAY"

I) ZONE 5 IS DEFINED AS ANY DOOR OR WINDOW WITHIN 1'-0" FROM ANY CORNER OF THE BUILDING ALL OTHER LOCATIONS ARE DEFINED AS ZONE 4. ) PRESSURE RATINGS REQUIRED FOR WINDOWS / DOORS SHOWN HEREIN ARE BASED ON ASCE 1-10 COMPONENTS AND CLADDING - ASD DESIGN (06W) NO FURTHER REDUCTION IS ALLOWED.

## **ELEVATION NOTES**

ALUM RAIL WIDOWS WALK W/ E.S.P. POWDER COAT FINISH OI. (COLOR WHITE). 2-PIECE CONT. ALUMINUM FLASHING TO MATCH ROOF @ OUTER EDGE. TOP OF RAIL 36" ABOVE ROOF DECK. PROVIDE SHOP DWGS & SAMPLE BY "SOUTH FL ALUM" OR EQ.

TIMBERLINE ULTRA HD SERIES SHINGLE ROOFING SYSTEM "GAF" (PEWTER GRAY) OR EQUAL ON 30\* FELT T.T. TO 19/32" A.P.A. RATED EXT. GRADE PLYWOOD SHEATHING.

LINE OF 3 & 12 ROOF PITCH BREAK -SEE STRUCT. DWGS. 03. A ROOF PLAN. CONT. ALUM. DRIP EDGE ON CONT. P.T. 1 x 2 ON CONT. 2 x 4

SMOOTH CLEAR CEDAR FASCIA -PAINTED. DBL P.T. 646 3" x 6" x 36" DECORATIVE BRACKETS 05. -PAINTED- \* +/36" O.C. -SEE REFLECTIVE CEILING PLAN FOR LAYOUT (TYP. @ ENTRY TOWER FEATURE). PROVIDE ALT. PRICE FOR DECORATIVE FOAM BRACKETS.

RECESSED SMOOTH STUCCO PANELS ON 6' CONCRETE 06. BLOCK -SEE STRUCTURAL DRAWINGS (TYP. @ ENTRY TOWER FEATURE AT ENDS / MANSARD ROOFS).

DECORATIVE RAISED STUCCO BANDING @ ROOF 01. PARAPET (TOP LAYER 2"HT x 2"W & BOTT. 2" HT. x 1" W). WITH LIGHT TEXTURED FINISH, CONTRACTOR TO PROVIDE SAMPLES OF ALL BANDING FOR APPROVAL

3" x 6" x 20" DECORATIVE OUTRIGGER (NOTE: KING 08. OUTRIGGERS 30") -PAINTED- @ 24" O.C. BY "FOAM FACTORY" OR EQUAL W/ HARDCOAT FINISH ON 1"  $\times$  6" CONT. RAISED STUCCO FRIEZE BOARD - SEE REFLECTIVE CEILING PLAN FOR LAYOUT.

CONT. 2" x 2" CONT. SMOOTH STUCCO BANDING AT UNDERSIDE OF OUTRIGGERS AND STUCCO FRIEZE BOARD - TYP. AT UNDERSIDE OF ROOF OVERHANG

PARAPET COPING TO BE SLOPED FOR POSITIVE DRAINAGE - ALL CAPS TO BE FABRICATED FROM PRE-FINISHED .032 ALUM. - IN 10'-0' STRAIGHT SECTIONS. - ALLOW A 1/4" SPACE BETWEEN THE ENDS PRE-FABRICATED FROM ONE PIECE WITH EA. LEG BEING A MIN. 2'-0" IN LENGTH.

UPPER FRAMED EXTERIOR PARAPET WALL TO RECEIVE 3-COAT 7/8"th. SMOOTH STUCCO FINISH ØN 2.5 SELF FURRING PAPER BACKED GALY, METAL LATH OVER "TYVEK" (COMMERCIAL) STUCCO WRAP OVER 19/32" APA RATED EXTERIOR GRADE PLYWOOD -

SECOND FLOOR EXTERIOR TO RECEIVE 1" x 2" VERTICAL STUCCO FINISH - PAINTED. 7/8" 3-COAT SMOOTH STUCCO W/ 6" LAP SIDING-FINISH-

PRIOR TO LAPSIDING PYC TRIM) (TYP.). " STUCCO CONTROL JOINTS - STUCCO SUB-CONTRACTOR TO COORDINATE WITH ARCHITECT FOR ALL LOCATIONS.

2-COAT 5/8" SMOOTH STUCCO FINISH, PAINTED TYP.

(2) LAYER STEP RAISED HORIZONTAL STUCCO BANDING W/ 2"ht  $\times$  2"dp TOP LAYER W/ LOWER LAYER BEING 4"ht x 1" PROJECTION - LOCATED @ BOARD AND BATTEN STUCCO SIDING - PAINTED -

SLOPED FOR POSITIVE DRAINAGE. (2) LAYER STEP RAISED HORIZONTAL STUCCO BANDING W/ 2"ht x 2"dp TOP LAYER W/ LOWER NDERSIDE OF STUCCO LAP SIDING - PAINTED -

2" x 4" SMOOTH STUCCO- PAINTED (TYP. @ ALL CORNERS AND WINDOW SURROUNDS - NOTE: WINDOW HEADERS TO HAVE 2" RAISED SMOOTH STUCCO BAND W/ 1' OVERHANG.)

1' TH. x 2'HT. SMOOTH RAISED STUCCO SILL WINDOW & 1'TH x 4'HT. STUCCO SKIRT - PAINTED (TYP.).

22. (W/ DECORATIVE I' × 'AZEK' TRIM), PAINTED (TYP. @ DOORS) SLOPED FOR POSITIVE DRAINAGE 14" RAISED SMOOTH STUCCO BASE, TYPICAL ALONG

NOTE: APPLY TREMPROOF WATERPROOFING MEMBRANCE BY "TREMCO" OR EQUAL. ALONG NORTHEAST & SOUTHEAST

13. STUCCO BATTENS @ 16' O.C. OVER 1/8' 3-COATS SMOOTH PAINTED (NOTE: APPLY SCRATCH DIRECTLY TO BLOCK

LAYER BEING 6"ht x 1" PROJECTION - LOCATED @ SLOPED FOR POSITIVE DRAINAGE.

EXTERIOR STUCCO TO EXTEND A MIN. 1'-0' BELOW GRADE -(TYP. @ ENTIRE PERIMETER).

 $6" \times 12"$  SMOOTH CLEAR CEDAR WOOD BEAM 545 PAINTED (ALL CONN. TO BE HIDDEN -SEE STRUCT.)

6W x 8D x 8'-0" DECORATIVE FOAM BEAMS (W/ HARDCOAT 26. FINISH BY FOAM FACTORY OR EQUAL) AT LOWER MAIN

SCALE: 3/16"=1'-0"

COVERED ENTRANCE) -SUBMIT SHOP DRAWING FOR APPROVAL. 6' x 6' CLEAR SMOOTH CEDAR WOOD COLUMNS
(W/ 1' x 10' 'A7E'' TEIMMED TO THE (W/ |  $\times$  10" 'AZEX' TRIMMED BASE & |  $\times$  1" @ THE TOP-SEE STRUCT, DRAWINGS FOR HIDDEN CONNECTIONS. (CONTRACTOR TO SUBMIT SHOP DWG'S FOR APPROVAL.

4 x 6 SMOOTH CLEAR CEDAR WOOD BRACKET \$4\$ PAINTED - SEE STRUCT. DWG'S, FOR ALL HIDDEN

8'  $\times$  12' CONCRETE BEAM W/  $\S$ ' 2-COATS SMOOTH STUCCO FINISH TO BE CENTERED OVER CONC. COLUMNS BELOW - SEE STRUCTURAL DRAWINGS

| 30. | 12' x 12' CONCRETE COLUMNS & PILASTERS (SEE FLOOR PLAN) W/ % 2-COATS SMOOTH STUCCO PAINTED FINISH (1' x 1' DECORATIVE AZEX TRIM AT THE TOP) \$ 1 1/4" RAISED SMOOTH STUCCO BANDING AT BASE - SEE STRUCTURAL DRAWINGS.

16"d x 8"w x 42"L & 64"L, DECORATIVE BRACKETS W/ TAPERED PROFILE BY "FOAM FACTORY" OR EQ. W/ TOUGH COAT FINISH (TYP. AT UNDERSIDE OF COVERED PORCHES), NOTE: CONTRACTOR TO PROVIDE SAMPLE FOR OWNER/ARCH APPROVAL

POURED IN PLACE CONC SLAB. SEE STRUC DWGS (TYP.) ALL BALCONIES TO SLOPE 1/81/FT. (WRAPPED W/ "AZEK" TO SIMULATE WOOD DECK).

CONT 1 1/4"HT. x 4" COPPER DRIP EDGE @ ALL BALCONIES. PAVERS BY "GEMPAVERS" OR EQUAL - 'OLD CANADA' RANDOM SIZES (9 x 6, 9 x 9 \$ 9 x 12) GREY CEMENT MIXES 'TAN CHOCOLATE' - SLAB TO BE MUDSET OVER .125' LIQUID WATERPROOFING ON CONC. DECK, "YULKEM 360" OR EQ. (REQ. SAMPLE

FOR OWNER APPROVAL) DECOR. ALUM. SHUTTERS (COLOR BLACK) TO HAVE 2 X SPACERS @ REAR FOR PROTECTION FROM BUILDING. AS PER 'SOUTH FLORIDA ALUMINUM' OR EQUAL.

ALUMINUM DECORATIVE RAIL W/ E.S.P. POWDER COAT FINISH (COLOR BLACK) - TOP OF RAIL MIN 42" WITH VERTICAL PICKET PATTERN TO BE SPACED TO BLOCK PASSAGE OF 4" SPHERE. (BOTTOM RAIL MAX. 2" AFF. -TYP.) - PROVIDE SHOP DRAWINGS FOR STYLE, SIZES AND DESIGN SAFETY / SAMPLE. BY 'SOUTH FLORIDA ALUMINUM' OR EQUAL. (NOTE: ALL EXTERIOR RAILINGS SHALL COMPLY W/ F.B.C. 2017 EDITION).

DECORATIVE "BAHAMA" ALUMINUM LOUVER SHUTTERS. SET IN A 45 DEGREE POSITION W/ E.S.P. POWDER COAT FINISH (COLOR TO BE BLACK). BY "SOUTH FLORIDA ALUMINUM' OR EQUAL. (CONTRACTOR TO PROVIDE SHOP DRAWINGS FOR APPROVAL).

"THERMA TRU" DOORS (GLAZED FIBERGLASS ENTRY DOOR W/ MAHOGANY FINISH) - W/ DOUBLE-GLAZED TINTED GLASS W/ AN AVG. U-FACTOR EQUAL TO 085 AND AVG. SHGC EQUAL TO 06 WITH 03 FENESTRATION VALUE TO BE IMPACT RESISTANT AND COMPLY W/ ALL DADE COUNTY IMPACT AND WIND CYCLING TESTING REQUIREMENTS. CONTRACTOR TO PROVIDE CERTIFICATE OF COMPLIANCE (TYP.).

"PGT" SINGLE HUNG, FIXED ALUM. WINDOWS TO BE IMPACT RESISTANT AND COMPLY W/ALL DADE COUNTY IMPACT AND WIND CYCLING TESTING REQUIREMENTS (TYP.). (NOTE: REFLECTIVE GLASS IS NOT PERMITTED).

PROPOSED NORTHWEST ELEVATION

PAINTED BLACK (TYP.) SEE DETAIL FOR RECESSED STUCCOED 4' CONC. BLOCK). NOT USE.

ALL ALUM. EXT. DOOR THRESHOLDS & WINDOW SILLS

TO BE SET IN "YULKEM 350" OR EQUAL & CONCRETE

"PGT" - FAUX - FIXED WINDOW W/ INTERIOR SIDE TO BE

THRESHOLD/ CONCRETE SILL (W/ 2" MAX. HT. DOOR ALL EXTERIOR DOORS & WINDOWS TO HAVE "DYMONIC 100" CAULKING @ BUCK/CMU/ALUM. FRAME

ALL DOOR & WINDOW CORNERS, HDR'S, & JAMBS TO BE SEALED W/ "VULKEM 350" - APPLIED SYNTHETIC PERMEABLE AIR AND VAPOR BARRIER MEMBRANE

- INSTALLED AS PER MANUF. SPEC'S BY "TREMCO" ALL WINDOWS TO HAVE I X P.T. WD BUCKS ANCHORED TO CONC AS PER PRODUCT APPROVAL.

SEE ROOF PLAN FOR BUILT-UP CRICKET FOR POSITIVE DRAINAGE.

PROVIDE KICK OUT FLASHING TO DIVERT ROOF WATER

FLOW AWAY FROM WALL. ADDRESS NUMBERS & LOCATION TO BE APPROVED BY OWNER (NOTE: NUMBERS MUST BE MIN. 6" IN HEIGHT AND ON A CONTRASTING BACKGROUND

SEE ELECTRICAL DRAWING FOR ALL EXTERIOR LIGHTING FIXTURES & SPECS.

ALL BALCONIES/PORCHES TO RECEIVE THINSET "MARBLE OF THE WORLD" - LOTUS STYLE: QUARTZITE SET - 18" L  $\times$  18" W WITH 3/16" GROUT JOINTS OVER .125" LIQUID WATERPROOFING ON CONC. DECK, VULKEM 360" OR EQ. (REQ. SAMPLE FOR OWNER

#### NOTES:

I. DO NOT SCALE DRAWINGS!

2. FIELD VERIFY ALL DIMENSIONS! 3. CONTRACTOR TO VERIFY ALL EXISTING CONDITIONS, AND NOTIFY ARCHITECT IF ANY DESCRIPANCY W/ DRAWINGS. (SEE GENERAL NOTES)

4. ALL AREA CALCULATIONS ARE APPROX. 5. ALL EXTERIOR DOOR & WINDOW LOCATIONS TO MATCH EXTERIOR ELEVATIONS-SEE SHEETS A3.00 & A3.01.

6. CONTRACTOR TO PROVIDE "KNOX-BOX" (PROVIDE KEYS FOR BOTH FRONT ENTRY

rchitecture,in

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ISSUED FOR

BIDS

PERMIT

CONSTRUCTION

PROJECT TITLE **MIXED USE** 

BUILDING **ADDITION**/ RENOVATION

230 GEORGE BUSH AVE

**DELRAY BEACH, FL** 

CLIENT APPROVAL

REVISIONS REVISED Ø1.10.11 AS PER P&Z COMMENTS: 1. ADJUSTED SETBACKS.

COMMENTS: I. ADDED REFERENCE DIMENSION FROM CROWN OF ROAD TO ROOF MEAN HEIGHT. 2. ADDED HATCH PATTERN TO DENOTE ROOF STRUCTURE. 3. CHANGED DECORATIVE TO REAL WINDOWS, 4, CHANGED FAUX

WINDOW ON NORTHEAST ELEVATION INTO A REAL WINDOW. REVISED 6.1.18 AS PER HPE DOORS ARE NOW SHOWN AS

=  $\sqrt{3}$  COMMENTS: I. ALL EXTERIOR FIBERGLASS W/ MAHOGANY FINISH 2. NORTHWEST ELEVATION NOW SHOWS STUCCO PANEL AS NOTED REVISED 12418 AS PER OWNER


1/4 comments: 1. Added fixed glass at 2. ADDED 8' TO SECOND FLOOR STRUCTURE. 3. ADJUSTED WINDOW SIZES FROM 30" x 60" to 36" x 72".

REVISED Ø1.02.19 AS PER OWNER COMMENTS: I. EXTENDED ELEVATOR TO ROOF DECK. 2. REMOVED BAHAMA SHUTTERS.

FILE NUMBER 616A300

DRAWING TITLE **PROPOSED ELEVATIONS** 

11.20.16 GE/JC 20150616

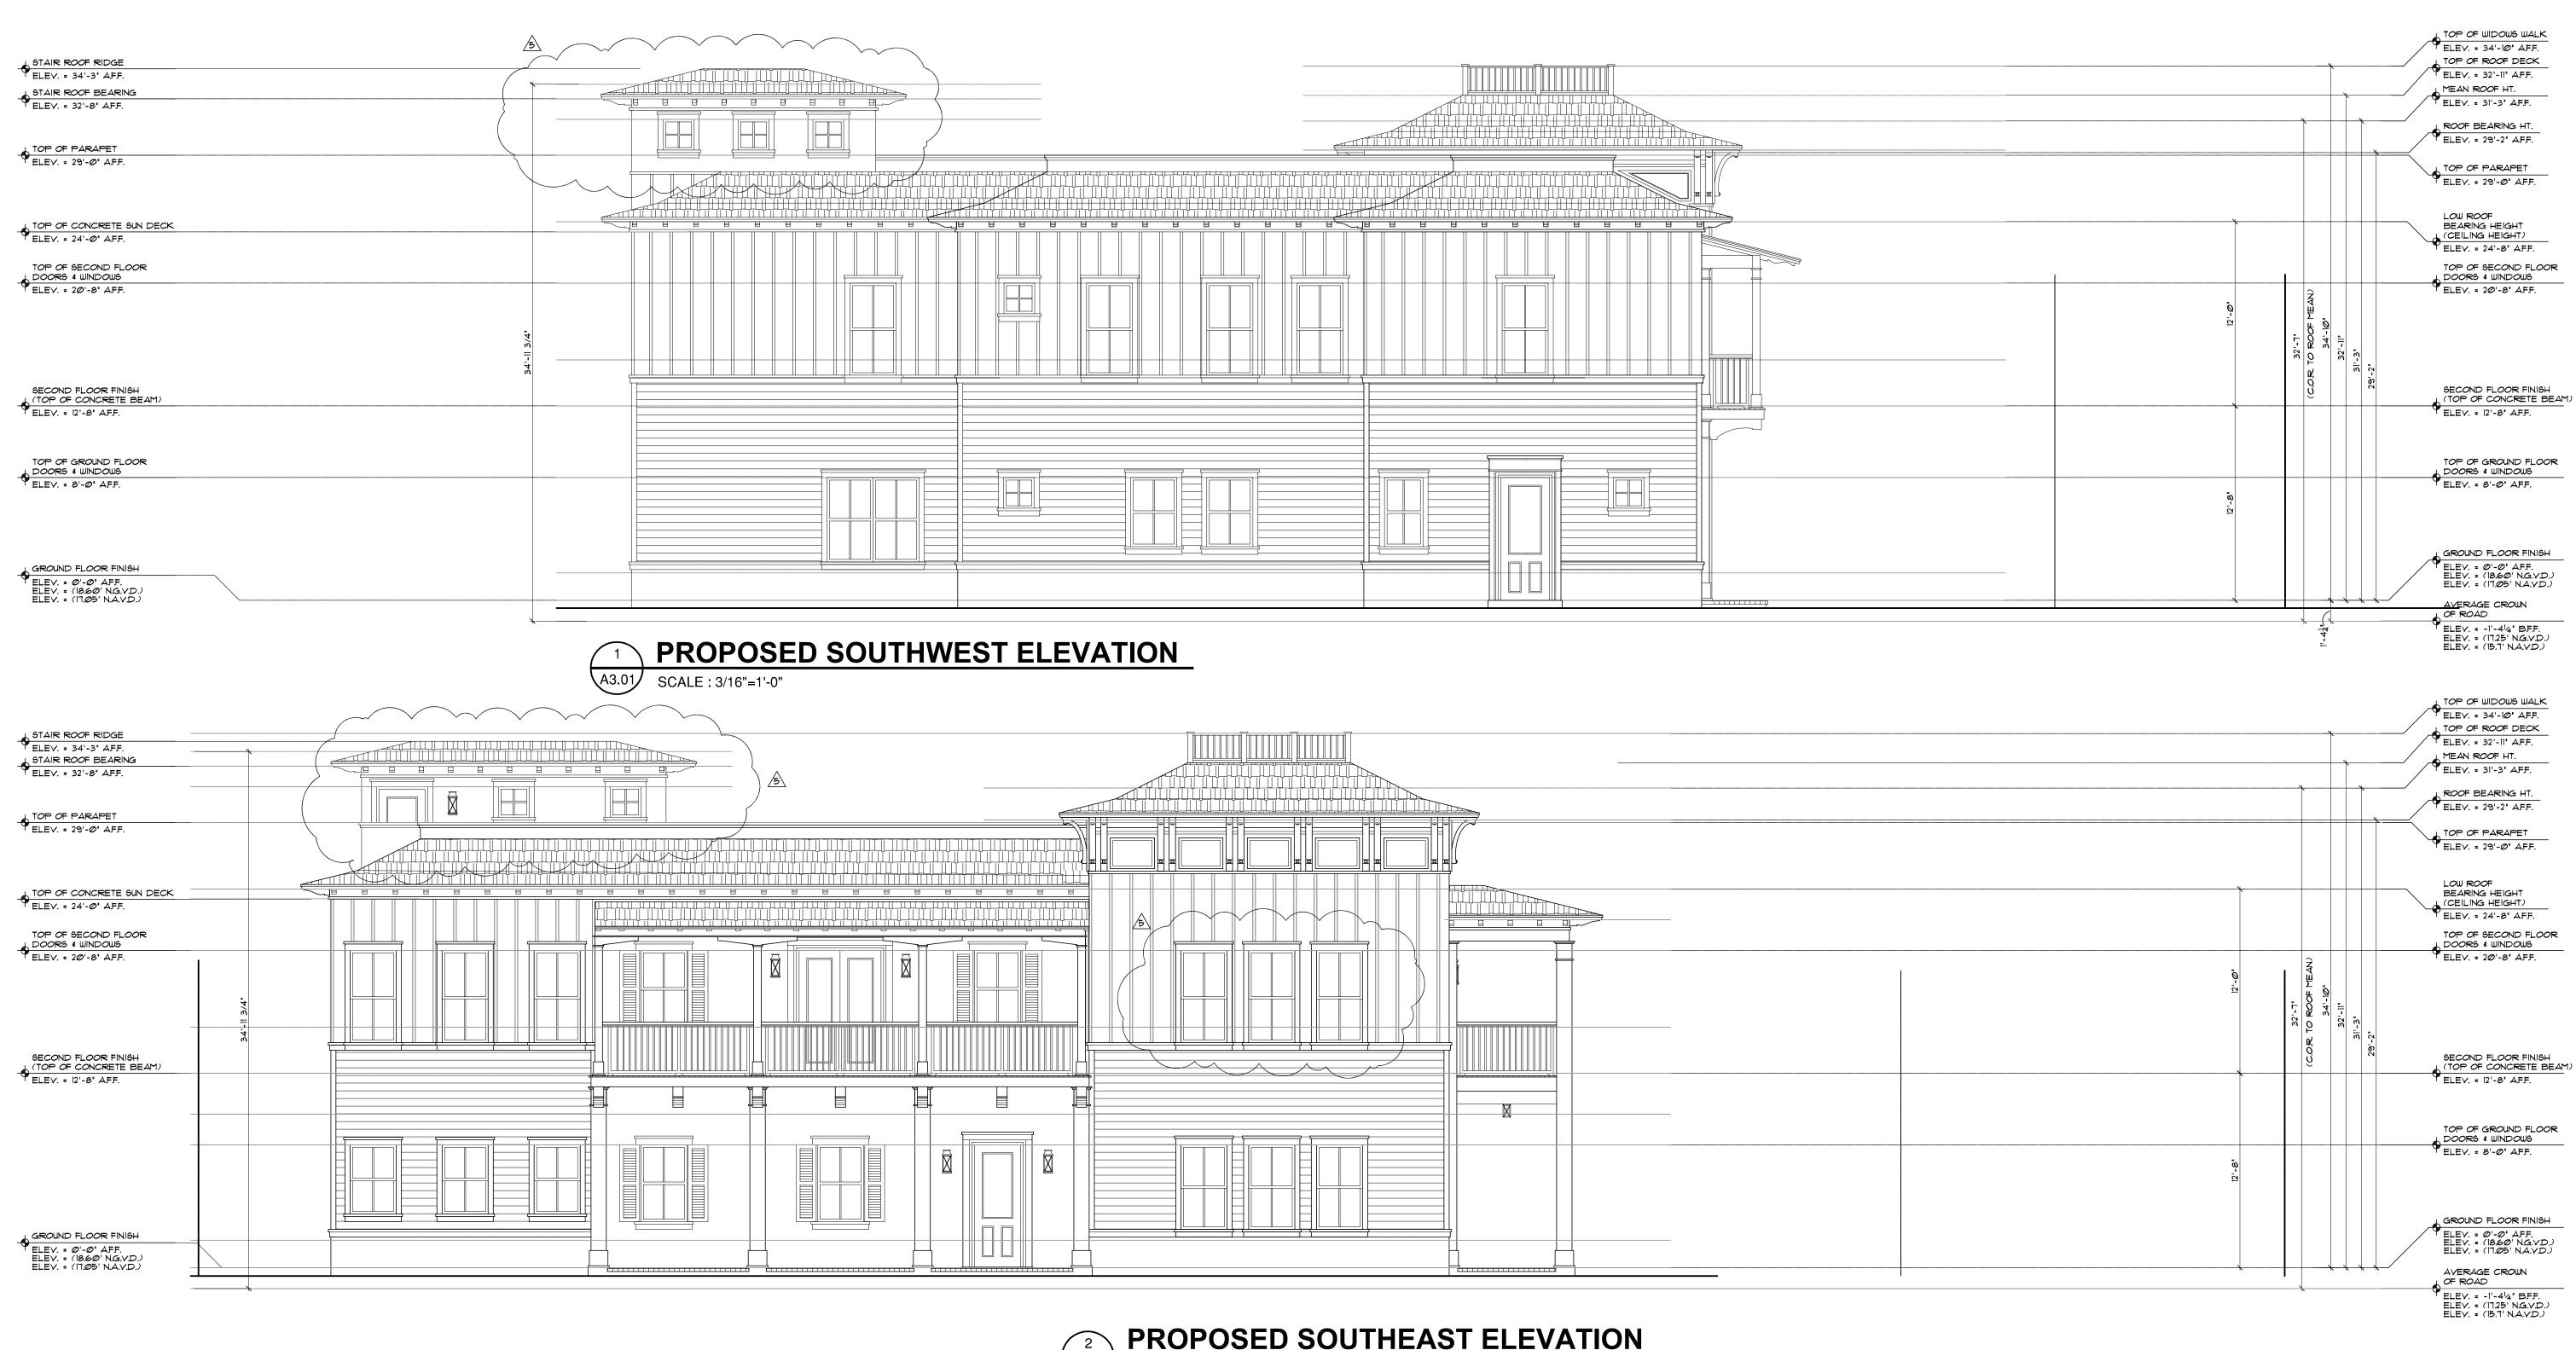

#### WIND PRESSURES ( PSF ) EXTERIOR DOORS, WINDOWS, COMPONENTS AND CLADDING **TRIBUTARY** AREA (ft ) (-) NEGATIVE (+) POSITIVE (-) NEGATIVE (+) POSITIVE 1 TO 20 21 TO 50 51 TO 100 151 TO 25Ø

1) ZONE 5 IS DEFINED AS ANY DOOR OR WINDOW WITHIN 1'-0' FROM ANY CORNER OF THE BUILDING. ALL OTHER LOCATIONS ARE DEFINED AS ZONE 4. 2) PRESSURE RATINGS REQUIRED FOR WINDOWS / DOORS SHOWN HEREIN ARE BASED ON ASCE 1-10 COMPONENTS AND CLADDING - ASD DESIGN (0.6W) NO FURTHER REDUCTION IS ALLOWED.

### **EXTERIOR STUCCO**

METAL LATH APPLICATION: I. APPLY SCRATCH COAT WITH SUFFICIENT PRESSURE TO KEY WELL INTO LATH. TROWEL AFTER INITIAL SET AND SCRATCH TO ROUGHEN SURFACE. 2. APPLY BROWN COAT AFTER SCRATCH COAT HAS SET FIRM AND HARD AND HAS BEEN STRAIGHTENED TO A TRUE SURFACE WITHOUT THE USE OF ADDITIONAL WATER. LEAVE ROUGH TO RECEIVE FINISH COAT. 3. DAMPEN BROWN COAT EVENLY PRIOR TO APPLICATION OF FINISH COAT. APPLY

FINISH COAT AND BRING FINISH COAT TO A TRUE, EVEN SURFACE, FINISHED AS APPROVED BY OWNER. 4 TIJO (2) COAT IJJORK (ON MASONRY), APPLY TIJO (2) COAT STUCCO TO CONCRETE

AND MASONRY AREAS' TOTAL THICKNESS, FIVE-EIGHTHS (5/8) INCH MINIMUM. 5. THREE (3) COAT WORK (ON LATH): APPLY THREE (3) COAT STUCCO TO METAL LATH: TOTAL (1) INCH THICK. AREAS: TOTAL THICKNESS, FIVE-EIGHTHS (5/8) INCH

6. RUN DRIP GROOVES IN STUCCO. PROVIDE RUN DRIP GROOVES IN EXTERIOR DOORWAY HEADS AND EXTERIOR WINDOW HEADS. 7. ALL STUCCO HEADERS, SILLS AND BANDING TO BE PROVIDED WITH A MIN. 1/8' SLOPE FOR PROPER SHEDDING OF RAIN WATER.

8. ALL POLYSTYRENE BOARD SHALL BE INSTALLED AS PER CURRENT MANUFACTURER'S PUBLISHED INSTRUCTIONS FOR INSTALLATION OF SYSTEM AS APPLICABLE TO EACH TYPE OF SUBSTRATE INDICATED. REINFORCING FABRIC CONSISTS OF A BALANCED, ALKALINE-RESISTANT OPEN-WEAVE GLASS-FIBER COMPLING WITH ASTM D 518 AND WEIGHING NOT LESS THAN 8 OZ. PER SQUARE YARD.

### **ELEVATION NOTES** ALUM RAIL WIDOWS WALK W/ E.S.P. POWDER COAT FINISH

LIGHT FIXTURES

\*BCD90010BZ - ELECT. WALL

ALL LIGHT FIXTURES TO BE APPROVED BY

(SMOOTH STUCCO & "BOARD & BATTEN")

TIMBERLINE ULTRA HD SERIES

SHINGLE ROOFING SYSTEM "GAF"

HEADERS, SILLS, BANDING AND FASCIA.

ALUMINUM SHUTTERS & WINDOW FRAMES.

NOTE: ALL COLORS ARE FOR PRICING PURPOSES

ONLY, CONTRACTOR TO PROVIDE SAMPLES FOR

SECOND FLOOR STRUCTURE & ROOF

PAINT LEGEND

ALL SURFACES TO BE CLEANED \$

ACADIA WHITE \*AC-41

'PEWTER GRAY"

P-4 (LAP-SIDING)

OWNER APPROVAL.

BRILLIANT WHITE - STUCCO

P-5 "IWP" - FIBERGLASS ENTRY DOOR W/ "MAHOGANY" FINISH.

BLACK BEAUTY \*2128-10

P-6 DECORATIVE ALUM. RAILINGS,

GRAND TETON WHITE \*AC-42

PRIMED AS PER BENJAMIN MOORE.

TROY LIGHTING "NEWTON"

TROY LIGHTING "NEWTON"
#FCD90040BZ - ELECT.

CEILING MOUNTED.

MOUNTED.

OWNER/ARCHITECT

- (COLOR WHITE). 2-PIECE CONT. ALUMINUM FLASHING TO MATCH ROOF @ OUTER EDGE. TOP OF RAIL 36" ABOVE ROOF DECK. PROVIDE SHOP DWGS & SAMPLE BY "SOUTH FL ALUM" OR EQ.
- TIMBERLINE ULTRA HD SERIES SHINGLE ROOFING SYSTEM 'GAF' (PEWTER GRAY) OR EQUAL ON 30\* FELT T.T. TO 19/32" A.P.A. RATED EXT. GRADE PLYWOOD SHEATHING.
- CONT. ALUM. DRIP EDGE ON CONT. P.T. 1  $\times$  2 ON CONT. 2  $\times$  4 SMOOTH CLEAR CEDAR FASCIA -PAINTED.

LINE OF 3 & 12 ROOF PITCH BREAK -SEE STRUCT. DWGS.

- DBL P.T. 646 3" x 6" x 36" DECORATIVE BRACKETS 05. -PAINTED- @ +/36' O.C. -SEE REFLECTIVE CEILING PLAN FOR LAYOUT (TYP. @ ENTRY TOWER FEATURE). PROVIDE ALT. PRICE FOR DECORATIVE FOAM BRACKETS.
- RECESSED SMOOTH STUCCO PANELS ON 6' CONCRETE 06. BLOCK -SEE STRUCTURAL DRAWINGS (TYP. . ENTRY TOWER FEATURE AT ENDS / MANSARD ROOFS)
- DECORATIVE RAISED STUCCO BANDING @ ROOF PARAPET (TOP LAYER 2"HT x 2"W & BOTT. 2" HT. x 1" W). WITH LIGHT TEXTURED FINISH . CONTRACTOR TO PROVIDE SAMPLES OF ALL BANDING FOR APPROVAL
- 3" x 6" x 20" DECORATIVE OUTRIGGER (NOTE: KING OUTRIGGERS 30") -PAINTED- @ 24" O.C. BY "FOAM FACTORY" OR EQUAL W/ HARDCOAT FINISH ON 1"  $\times$  6" CONT. RAISED STUCCO FRIEZE BOARD - SEE REFLECTIVE CEILING PLAN FOR LAYOUT.
- CONT. 2' x 2' CONT. SMOOTH STUCCO BANDING AT UNDERSIDE OF OUTRIGGERS AND STUCCO FRIEZE
- BOARD TYP. AT UNDERSIDE OF ROOF OVERHANG. PARAPET COPING TO BE SLOPED FOR POSITIVE DRAINAGE - ALL CAPS TO BE FABRICATED FROM PRE-FINISHED .032 ALUM. - IN 10'-0" STRAIGHT SECTIONS. - ALLOW A 1/4" SPACE BETWEEN THE ENDS FOR EXPANSION. - ALL CORNERS SHALL BE PRE-FABRICATED FROM ONE PIECE WITH EA. LEG
- BEING A MIN. 2'-0' IN LENGTH. UPPER FRAMED EXTERIOR PARAPET WALL TO RECEIVE 3-COAT 1/8"th. SMOOTH STUCCO FINISH ØN 2.5 BELF FURRING PAPER BACKED GALV, METAL LATH OVER "TYVEK" (COMMERCIAL) STUCCO WRAP OVER 9/32" APA RATED EXTERIOR GRADE PLYWOOD -

# SCALE: 3/16"=1'-0"

12. NOT USED.

- SECOND FLOOR EXTERIOR TO RECEIVE 1' x 2" VERTICAL STUCCO BATTENS @ 16" O.C. OVER 7/8" 3-COATS SMOOTH STUCCO FINISH - PAINTED. 7/8" 3-COAT SMOOTH STUCCO W/ 6" LAP SIDING-FINISH-
- PAINTED (NOTE: APPLY SCRATCH DIRECTLY TO BLOCK PRIOR TO LAPSIDING PVC TRIM) (TYP.).  $rac{1}{2}$ " STUCCO CONTROL JOINTS - STUCCO SUB-CONTRACTOR TO COORDINATE WITH ARCHITECT FOR ALL LOCATIONS.
- 2-COAT 5/8" SMOOTH STUCCO FINISH, PAINTED TYP.
- (2) LAYER STEP RAISED HORIZONTAL STUCCO BANDING W/2"ht x 2"dp TOP LAYER W/LOWER LAYER BEING 4"ht x 1" PROJECTION - LOCATED @ BOARD AND BATTEN STUCCO SIDING - PAINTED -BLOPED FOR POSITIVE DRAINAGE.
- (2) LAYER STEP RAISED HORIZONTAL STUCCO 19. BANDING W/2"ht x 2"dp TOP LAYER W/LOWER LAYER BEING 6"ht x 1" PROJECTION - LOCATED @ INDERSIDE OF STUCCO LAP SIDING - PAINTED SLOPED FOR POSITIVE DRAINAGE.
- 2' x 4' 9M00TH STUCCO- PAINTED (TYP. @ ALL CORNERS AND WINDOW SURROUNDS NOTE: WINDOW HEADERS TO HAVE 2" RAISED SMOOTH STUCCO BAND W/ 1' OVERHANG.)
- 21. I' TH. x 2"HT. SMOOTH RAISED STUCSS STEEL THE STUCS SKIRT PAINTED (TYP.). " TH.  $\times$  2"HT. SMOOTH RAISED STUCCO SILL WINDOW \$ " TH. x 8"HT. "AZEK" (WOOD SIMULATED) HEADER TRIM (W/ DECORATIVE I' x "AZEK" TRIM), PAINTED (TYP. @

DOORS) SLOPED FOR POSITIVE DRAINAGE.

FRONT OF STRUCTURE.

EXTERIOR STUCCO TO EXTEND A MIN. 1'-0' BELOW GRADE -(TYP. @ ENTIRE PERIMETER). NOTE: APPLY TREMPROOF WATERPROOFING MEMBRANCE BY 'TREMCO' OR EQUAL. ALONG NORTHEAST & SOUTHEAST 6" x 12" SMOOTH CLEAR CEDAR WOOD BEAM \$4\$

PAINTED (ALL CONN. TO BE HIDDEN -SEE STRUCT.)

14" RAISED SMOOTH STUCCO BASE, TYPICAL ALONG

- $6 \text{W} \times 8 \text{D} \times 8' \text{-} 0"$  DECORATIVE FOAM BEAMS (W/ HARDCOAT 26. FINISH BY FOAM FACTORY OR EQUAL) AT LOWER MAIN COVERED ENTRANCE) - SUBMIT SHOP DRAWING FOR APPROVAL.
- 6' x 6' CLEAR SMOOTH CEDAR WOOD COLUMNS (W/ I' x 10' 'AZEX' TRIMMED BASE & I' x I' @ THE TOP-6" x 6" CLEAR SMOOTH CEDAR WOOD COLUMNS SEE STRUCT. DRAWINGS FOR HIDDEN CONNECTIONS. (CONTRACTOR TO SUBMIT SHOP DWG'S FOR APPROVAL)
- 28. PAINTED SEE STRUCT, DWG'S, FOR ALL HIDDEN CONNECTIONS. 8" x 12" CONCRETE BEAM W/ &" 2-COATS SMOOTH 29. STUCCO FINISH TO BE CENTERED OVER CONC. COLUMNS BELOW - SEE STRUCTURAL DRAWINGS.

4 x 6 SMOOTH CLEAR CEDAR WOOD BRACKET 545

- 30. | 12" x 12" CONCRETE COLUMNO + TILLOU L. STILLOU L. 12" x 12" CONCRETE COLUMNS & PILASTERS (SEE PAINTED FINISH (1" x 1" DECORATIVE AZEX TRIM AT THE TOP) & 1 1/4" RAISED SMOOTH STUCCO BANDING AT BASE - SEE STRUCTURAL DRAWINGS.
- W/ TOUGH COAT FINISH (TYP. AT UNDERSIDE OF COVERED PORCHES), NOTE: CONTRACTOR TO PROVIDE SAMPLE FOR OWNER/ARCH APPROVAL POURED IN PLACE CONC SLAB. SEE STRUC DWGS (TYP.) ALL BALCONIES TO SLOPE 1/2"/FT. (WRAPPED

 $\bigcap$  16"d x 8"w x 42"L & 64"L, DECORATIVE BRACKETS

31. W TAPERED PROFILE BY "FOAM FACTORY" OR EQ.

- W/ "AZEK" TO SIMULATE WOOD DECK). CONT | 1/4"HT. x 4" COPPER DRIP EDGE @ ALL BALCONIES. PAVERS BY "GEMPAVERS" OR EQUAL - 'OLD
- CANADA' RANDOM SIZES (9 x 6, 9 x 9 & 9 x 12) GREY CEMENT MIXES 'TAN CHOCOLATE' - SLAB TO BE MUDSET OVER .125" LIQUID WATERPROOFING ON CONC. DECK, 'VULKEM 360' OR EQ. (REQ. SAMPLE FOR OWNER APPROVAL)
- DECOR. ALUM. SHUTTERS (COLOR BLACK) TO HAVE 2 X SPACERS @ REAR FOR PROTECTION FROM BUILDING. AS PER 'SOUTH FLORIDA ALUMINUM' OR EQUAL.
- ALUMINUM DECORATIVE RAIL W/ E.S.P. POWDER COAT FINISH (COLOR BLACK) TOP OF RAIL MIN. 42" WITH VERTICAL PICKET PATTERN TO BE SPACED TO BLOCK PASSAGE OF 4" SPHERE. (BOTTOM RAIL MAX. 2" A.F.F. -TYP.) - PROVIDE SHOP DRAWINGS FOR STYLE, SIZES AND DESIGN SAFETY / SAMPLE, BY "SOUTH FLORIDA ALUMINUM OR EQUAL. (NOTE: ALL EXTERIOR RAILINGS SHALL COMPLY W/ F.B.C. 2017 EDITION).

DECORATIVE "BAHAMA" ALUMINUM LOUVER SHUTTERS. SET IN A 45 DEGREE POSITION W/ E.S.P. POWDER COAT FINISH (COLOR TO BE BLACK). BY 'SOUTH FLORIDA ALUMINUM" OR EQUAL. (CONTRACTOR TO PROVIDE SHOP DRAWINGS FOR APPROVAL).

PROVIDE KICK OUT FLASHING TO DIVERT ROOF WATER

ADDRESS NUMBERS & LOCATION TO BE APPROVED BY

ALL BALCONIES/PORCHES TO RECEIVE THINSET

'VULKEM 360' OR EQ. (REQ. SAMPLE FOR OWNER

"MARBLE OF THE WORLD" - LOTUS STYLE: QUARTZITE

SET - 18" L  $\times$  18" W WITH 3/16" GROUT JOINTS OVER .125"

OWNER. (NOTE: NUMBERS MUST BE MIN. 6" IN HEIGHT AND

FLOW AWAY FROM WALL.

APPROVAL).

. DO NOT SCALE DRAWINGS!

(SEE GENERAL NOTES)

SEE SHEETS A3.00 & A3.01.

2. FIELD VERIFY ALL DIMENSIONS!

3. CONTRACTOR TO VERIFY ALL EXISTING

CONDITIONS, AND NOTIFY ARCHITECT

F ANY DESCRIPANCY W/ DRAWINGS.

TO MATCH EXTERIOR ELEVATIONS-

4. ALL AREA CALCULATIONS ARE APPROX.

6. CONTRACTOR TO PROVIDE "KNOX-BOX"

(PROVIDE KEYS FOR BOTH FRONT ENTRY

5. ALL EXTERIOR DOOR & WINDOW LOCATIONS

NOTES:

DOORS).

ON A CONTRASTING BACKGROUND).

SEE ELECTRICAL DRAWING FOR ALL

EXTERIOR LIGHTING FIXTURES & SPECS.

LIQUID WATERPROOFING ON CONC. DECK,

- "THERMA TRU" DOORS (GLAZED FIBERGLASS ENTRY 38. DOOR W/ MAHOGANY FINISH) - W/ DOUBLE-GLAZED TINTED GLASS W/ AN AVG. U-FACTOR EQUAL TO Ø85 AND AVG. SHGC EQUAL TO 06 WITH 03 FENESTRATION VALUE TO BE IMPACT REGISTANT AND COMPLY W/ ALL DADE COUNTY IMPACT AND WIND CYCLING TESTING REQUIREMENTS. CONTRACTOR TO PROVIDE CERTIFICATE OF COMPLIANCE (TYP.).
- "PGT" SINGLE HUNG, FIXED ALUM. WINDOWS TO BE 39. IMPACT RESISTANT AND COMPLY WALL DADE COUNTY IMPACT AND WIND CYCLING TESTING REQUIREMENTS CONTRACTOR TO PROVIDE CERTIFICATE OF COMPLIANCE (TYP.). (NOTE: REFLECTIVE GLASS IS NOT PERMITTED).
- "PGT" FAUX FIXED WINDOW W/ INTERIOR SIDE TO BE 40. PAINTED BLACK (TYP.) SEE DETAIL FOR RECESSED STUCCOED 4" CONC. BLOCK).
- ALL ALUM. EXT. DOOR THRESHOLDS & WINDOW SILLS TO BE SET IN "YULKEM 350" OR EQUAL & CONCRETE

THRESHOLD/ CONCRETE SILL (W/ 2" MAX. HT. DOOR

NOT USE.

- ALL EXTERIOR DOORS & WINDOWS TO HAVE "DYMONIC 100" CAULKING @ BUCK/CMU/ALUM. FRAME CONDITIONS (TYP.).
- ALL DOOR & WINDOW CORNERS, HDR'S. & JAMBS TO 44 BE SEALED W/ 'VULKEM 350' - APPLIED SYNTHETIC PERMEABLE AIR AND VAPOR BARRIER MEMBRANE - INSTALLED AS PER MANUF, SPEC'S BY "TREMCO"
- ALL WINDOWS TO HAVE 1  $\times$  P.T. WD BUCKS ANCHORED TO CONC AS PER PRODUCT APPROVAL.
- SEE ROOF PLAN FOR BUILT-UP CRICKET FOR POSITIVE DRAINAGE.



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ISSUED FOR

PERMIT CONSTRUCTION

BIDS

PROJECT TITLE

# **MIXED USE BUILDING ADDITION**/ **RENOVATION**

230 GEORGE BUSH AVE DELRAY BEACH, FL

CLIENT APPROVAL

REVISIONS REVISED Ø7.1Ø.17 AS PER P&Z COMMENTS: 1. ADJUSTED SETBACKS. REVISED 8.18.17 AS PER P&Z COMMENTS: 1. ADDED REFERENCE DIMENSION FROM CROWN OF ROAD TO ROOF MEAN HEIGHT. 2. CONVERTED FAUX WINDOW ON SOUTHEAST ELEVATION TO A REAL

WINDOW. 3. ADDED HATCH PATTERN TO DENOTE ROOF STRUCTURE. REVISED 6.1.18 AS PER HPB  $^{\prime}$  comments:1. All exterior DOORS ARE NOW SHOWN AS FIBERGLASS W/ MAHOGANY FINISH. 2. SOUTHWEST ELEVATION NOW

SHOWS STUCCO PANEL AS NOTED. REVISED 7.24.18 AS PER OWNER 4 COMMENTS: I. ADDED FIXED GLASS AT TOWER ENTRY FEATURE. 2. ADDED 8' TO SECOND FLOOR STRUCTURE, 3. INCREASED WINDO

SIZES FROM 30" x 60" to 36" x 72 REVISED 02.01.19 AS PER OWNER COMMENTS: 1, EXTENDED

ELEVATOR TO ROOF DECK

FILE NUMBER 616A301

DRAWING TITLE **PROPOSED** 

**ELEVATIONS** 

11.20.16 GE/JC

JOB NUMBER 20150616