FRANK ROZZO SECRET-MEMORIAL GARDEN

220 & 226 N. Swinton Avenue Delray Beach, FL 33444

LANDSCAPE PLANS for COA Submittal

(Certificate of Appropriateness Application, Historic Preservation Board)

List of Drawings:

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PR-1	Project Data
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SU-1	Composite Survey Plan
Exhibit	Survey, prepared by O'Brien, Suiter & O'Brian, Inc., June 21, 2019

Murakami Landscape Architects

326 NE 1st Avenue Delray Beach, FL 33444 561 213 7229 cell 561 276 7750 office Don@MLandscape.net

Submittal Date: July 24th, 2019 Revisions: September 12, 2019



Location Plan
Not To Scale

FRANK ROZZO SECRET-MEMORIAL GARDEN

220 & 226 N. Swinton Avenue Delray Beach, FL 33444

OWNER: Frank Rozzo

COA Certificate of
Appropriateness Application,
Historic Preservation Board



Revision: SEPTEMBER 12, 2019

North:

Scale: NO SCALE

Job Number:

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COVER SHEET

C-

Sht. 1 of 16

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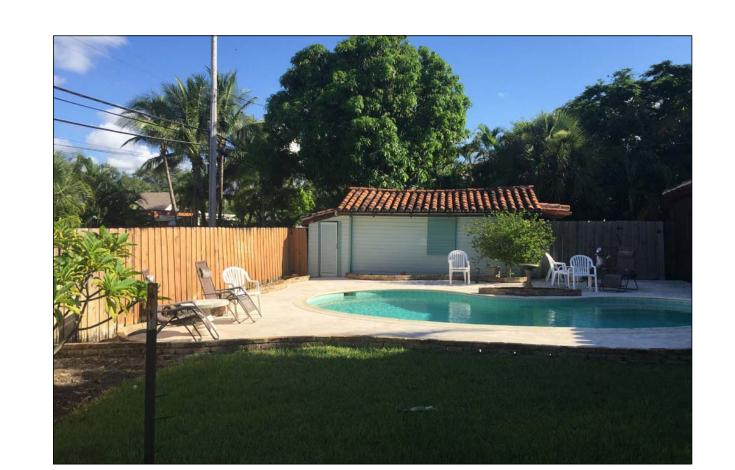


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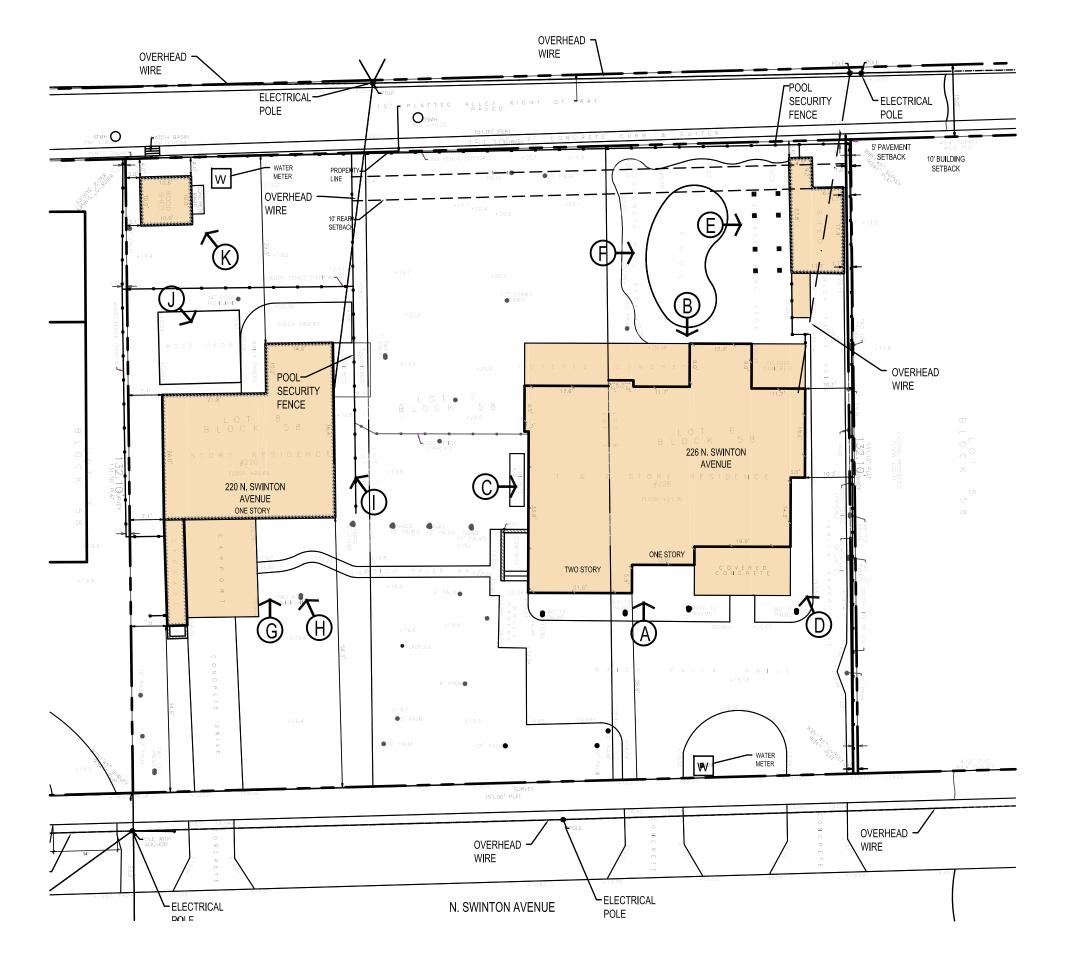








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B





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Revision: SEPTEMBER 12, 2019

Scale: 1"=20'

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Drawing Name:

Checked By:

Date: JULY 24, 2019, COA SUBMIT

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EXISTING BUILDING


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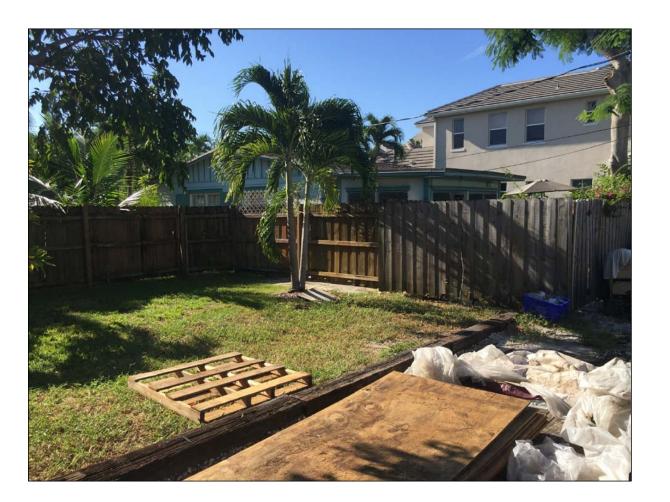
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Sht. 2 of 16

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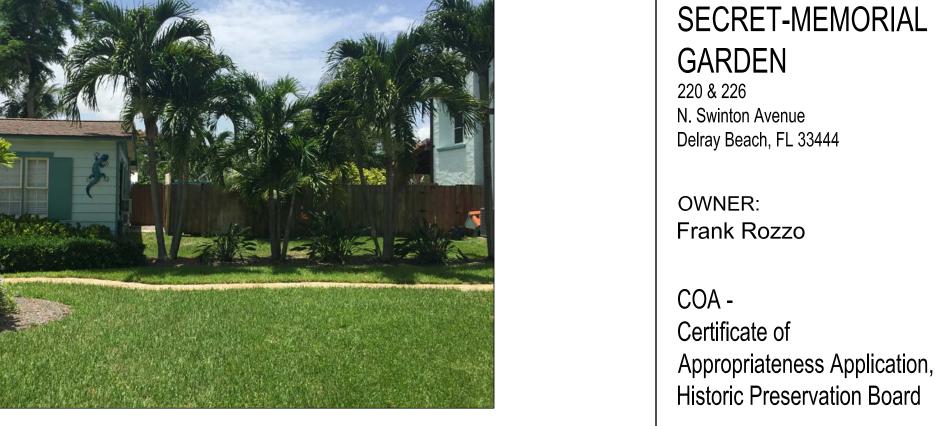









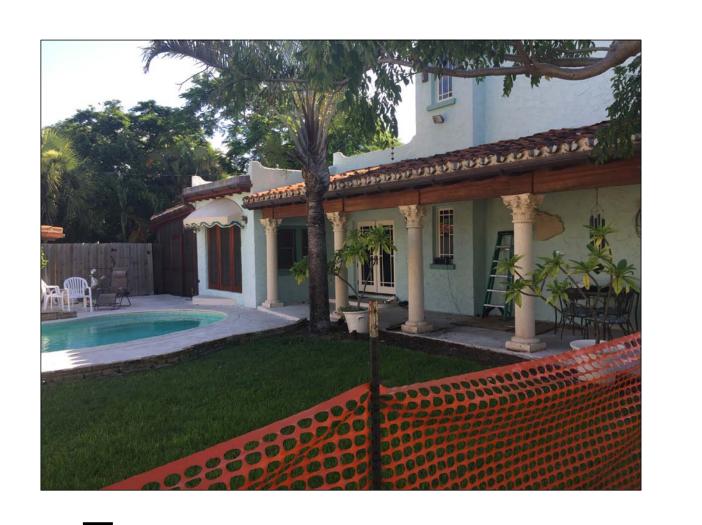









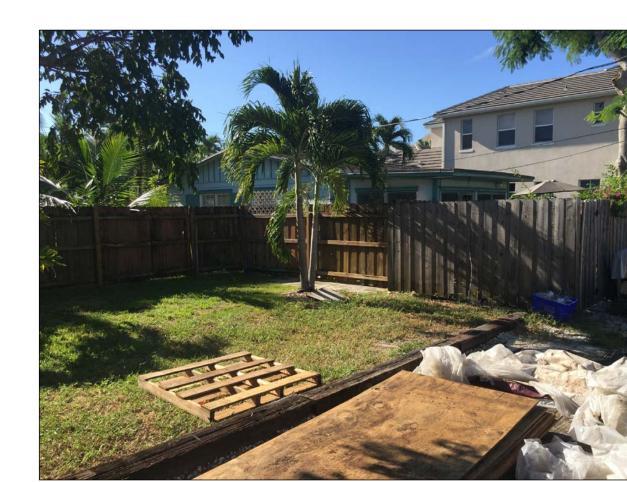

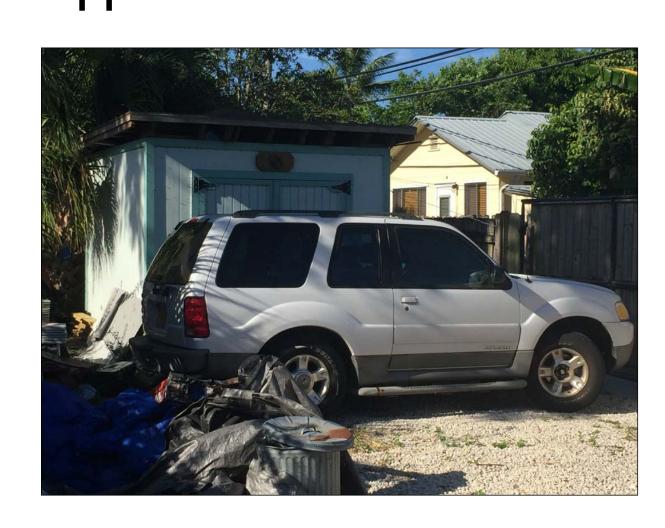



N. SWINTON AVENUE

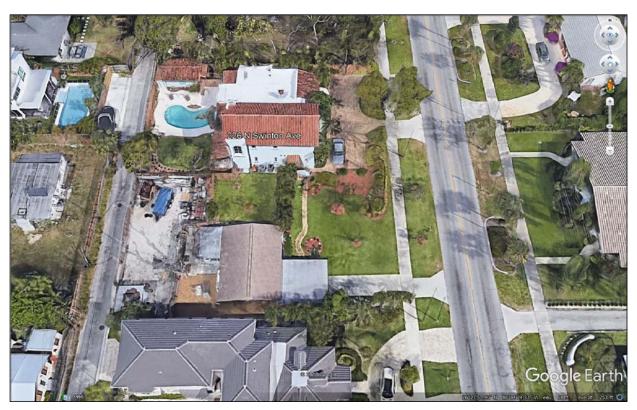

226 N. SWINTON AVENUE


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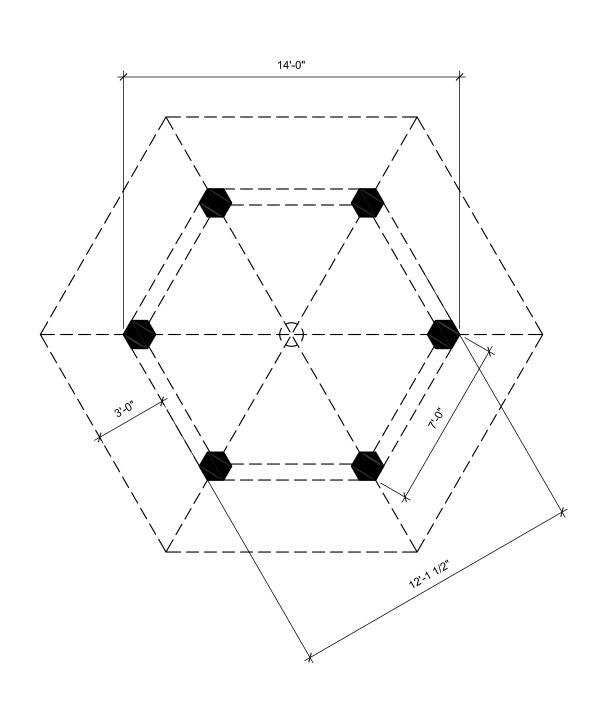



FRANK ROZZO


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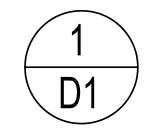
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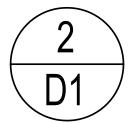




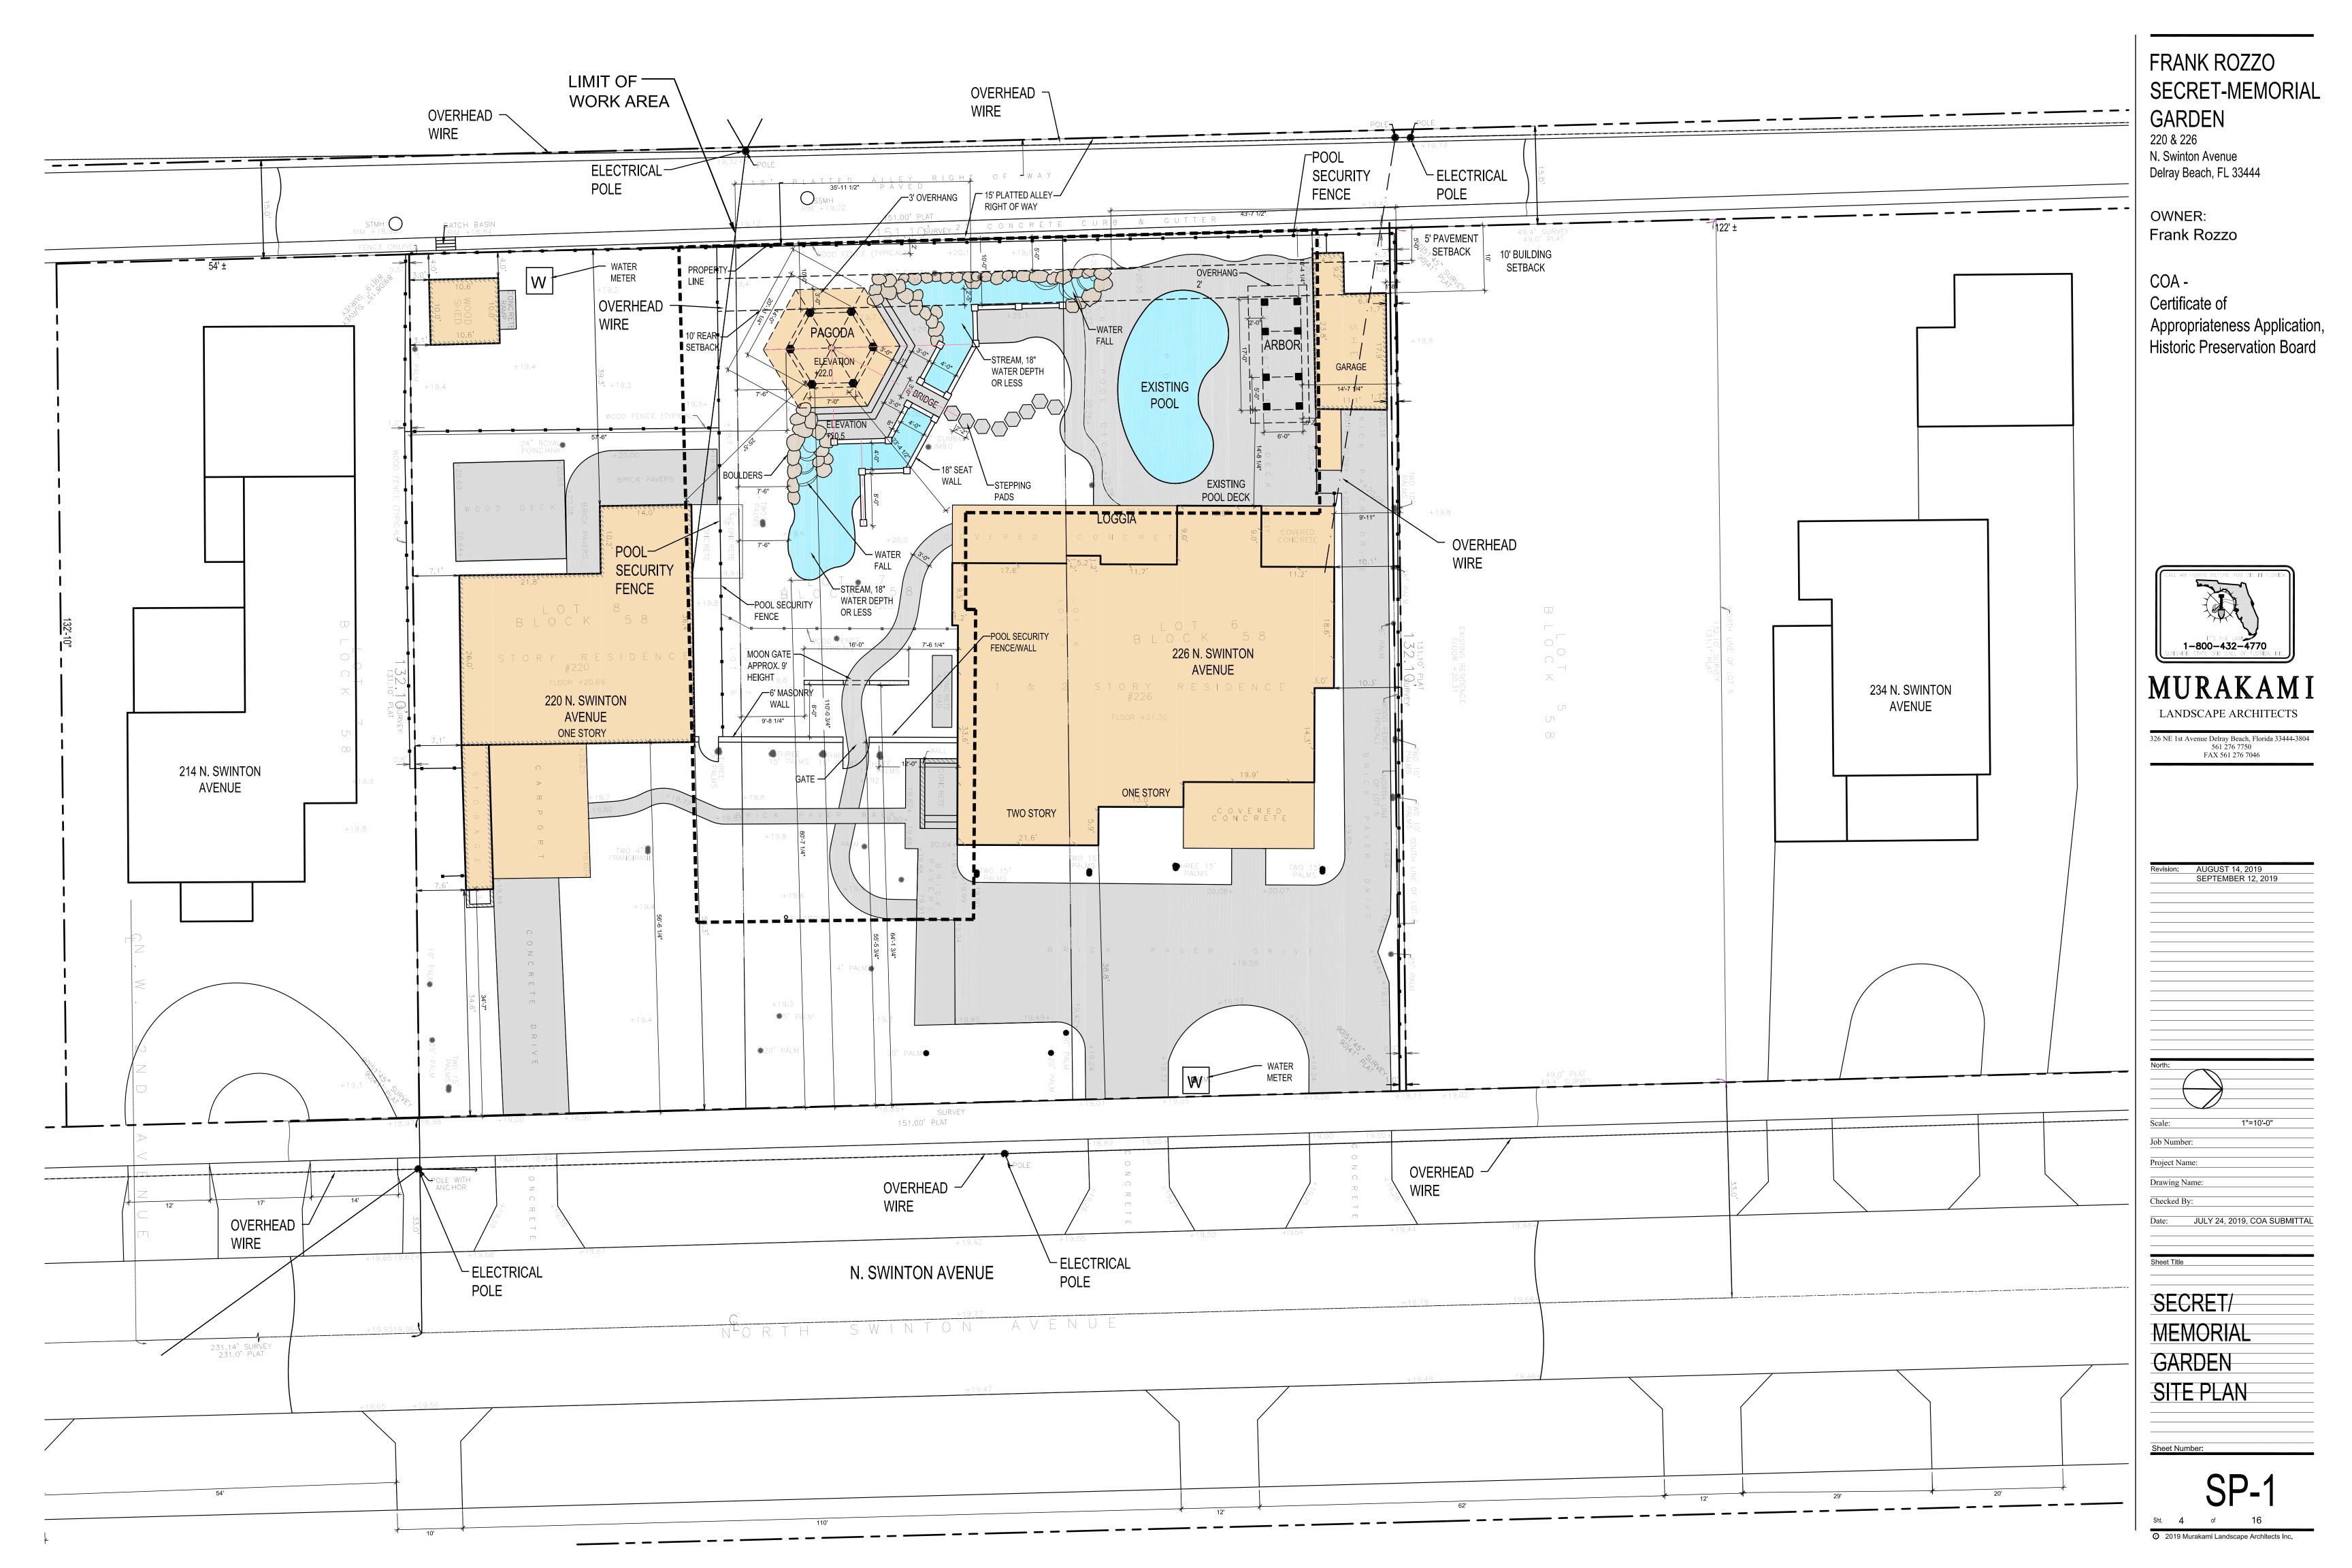


PAGODA PLAN
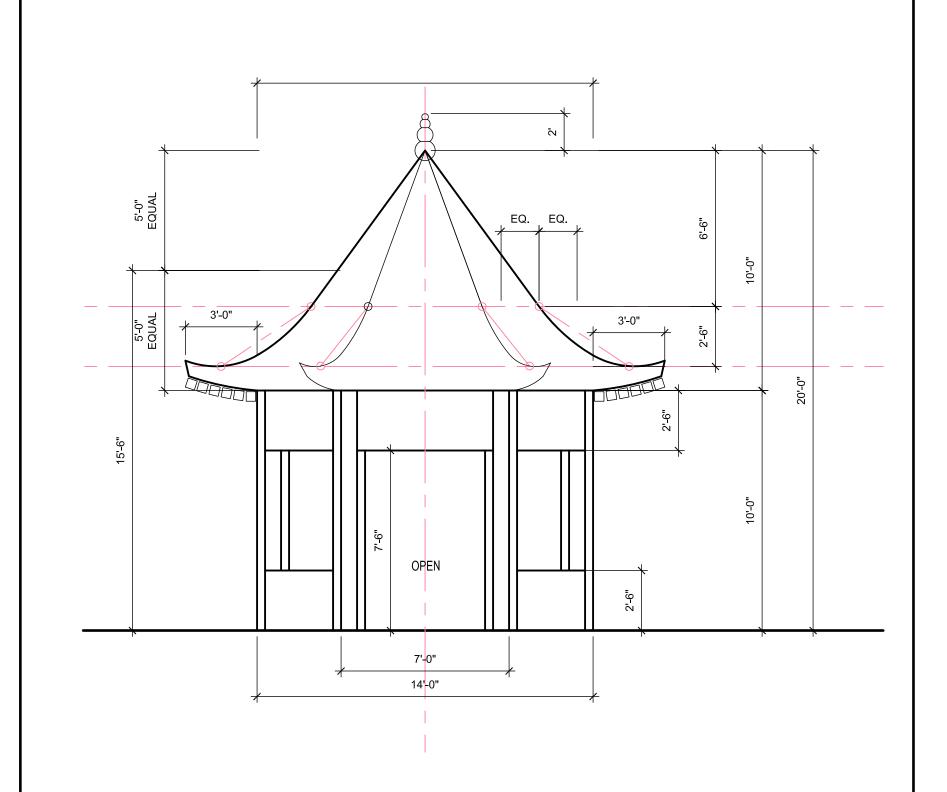
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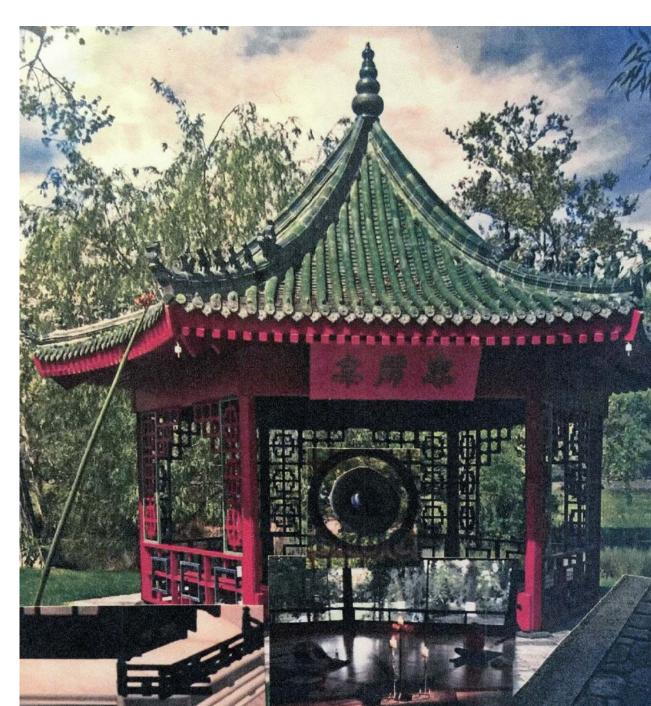
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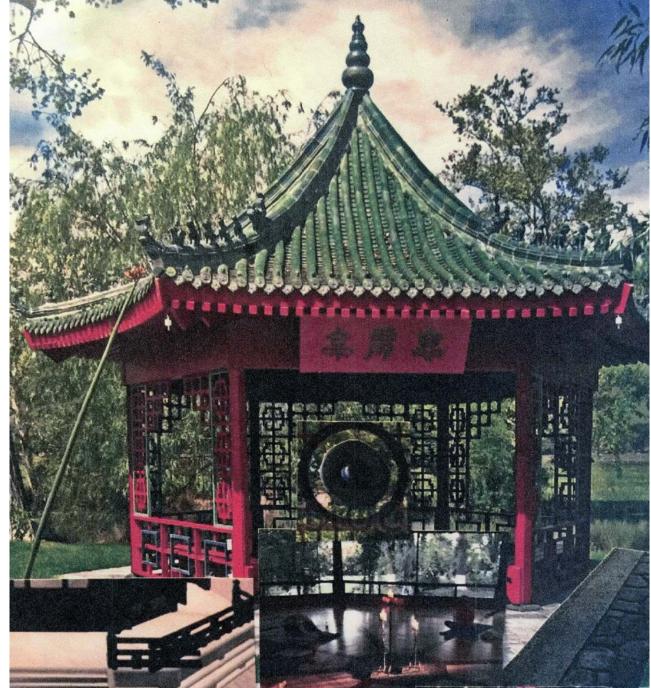
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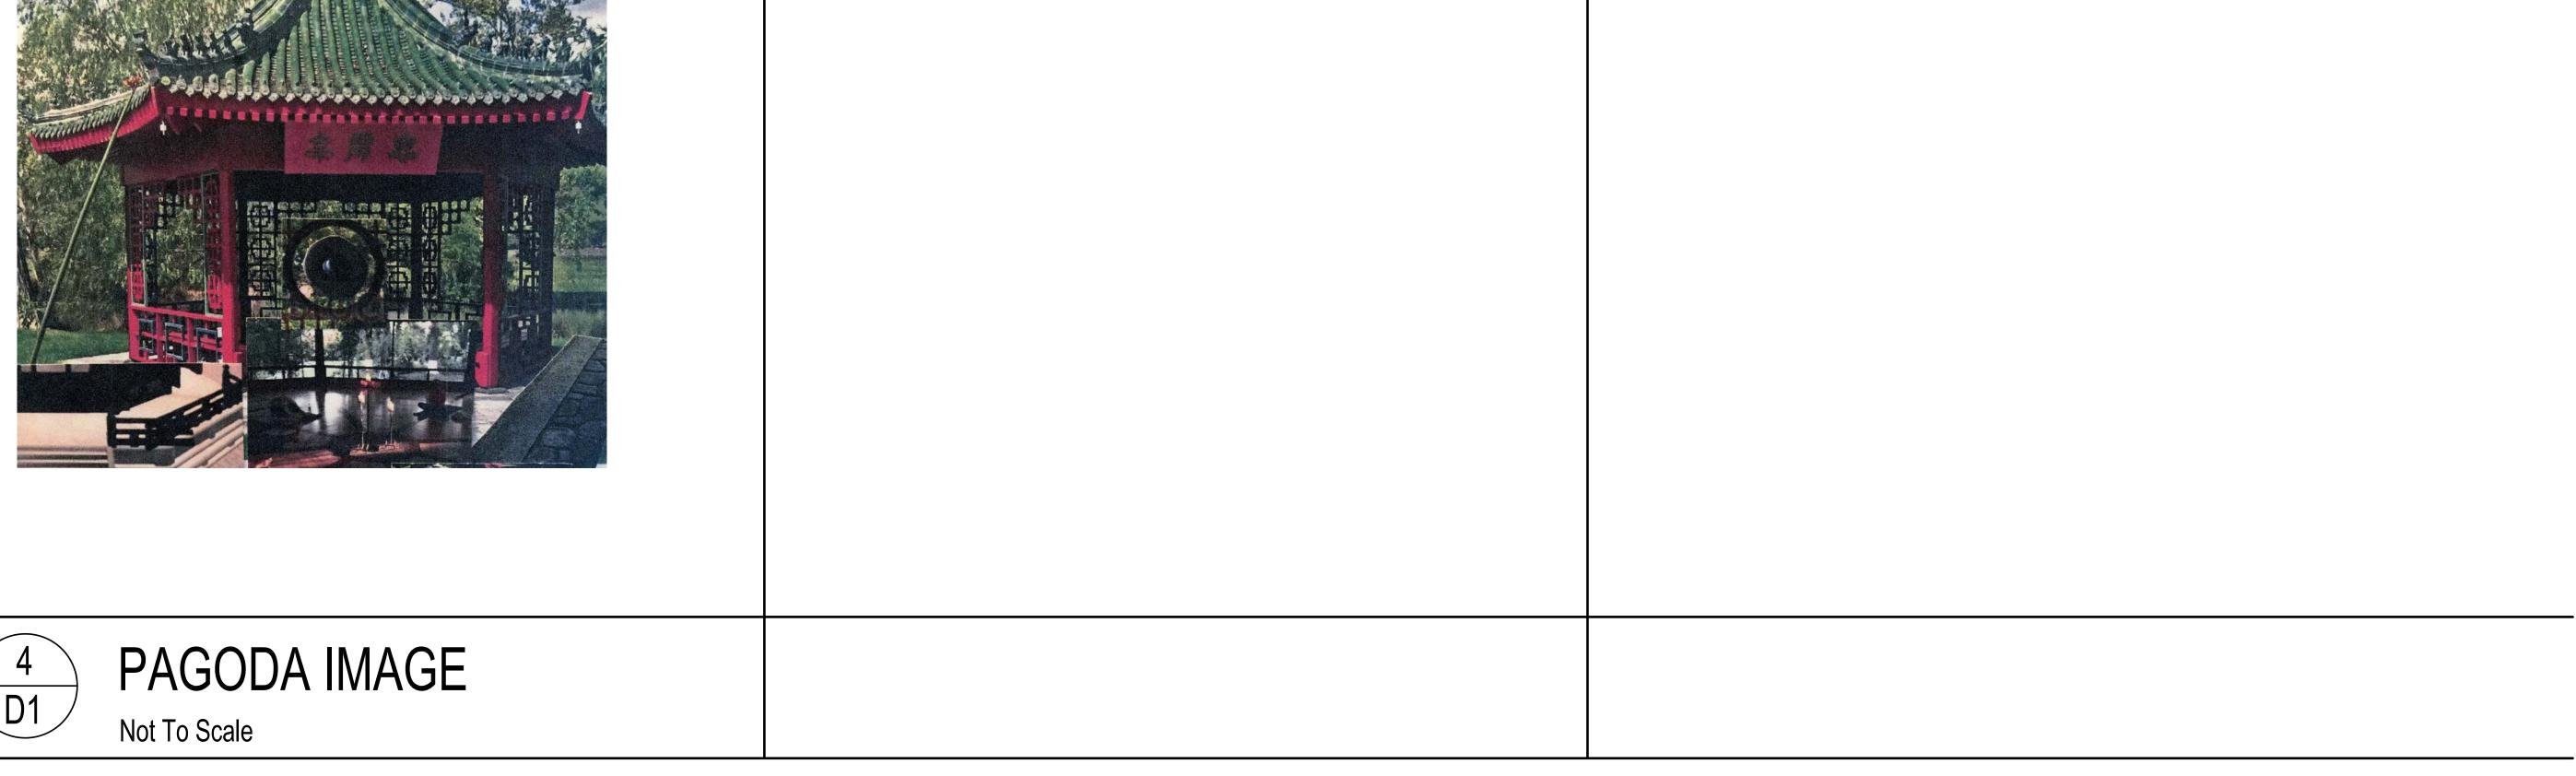


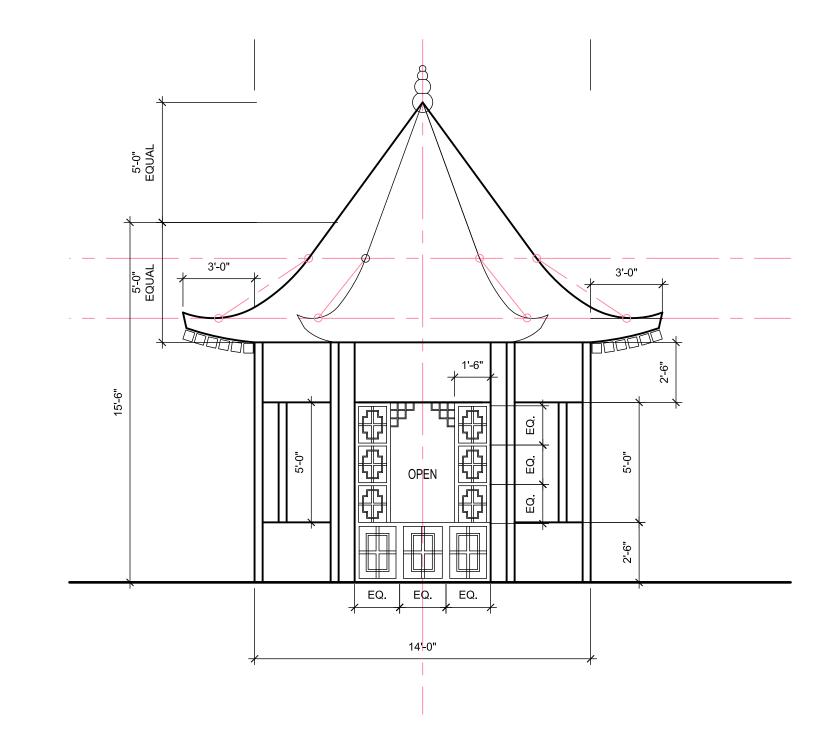PAGODA SIDE ELEVATION

Scale: 1/4"=1'-0"



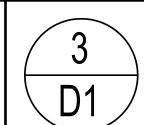



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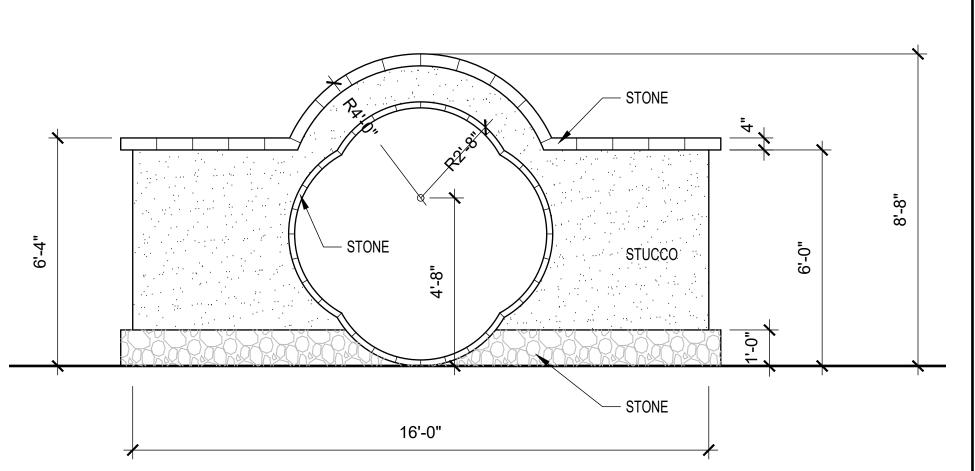
> OWNER: Frank Rozzo


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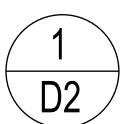
326 NE 1st Avenue Delray Beach, Florida 33444-3804 561 276 7750 FAX 561 276 7046

PAGODA DETAILS








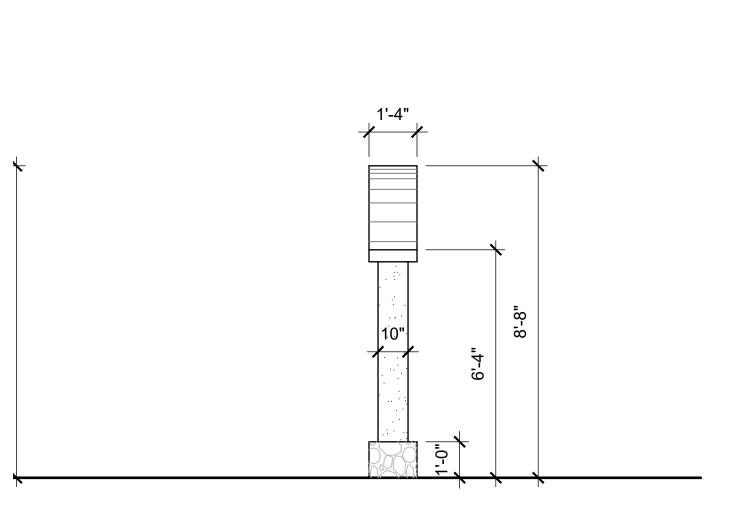


MOON GATE FRONT ELEVATION

Scale: 3/8"=1'-0"

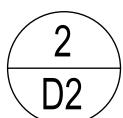


MOON GATE SIDE ELEVATION


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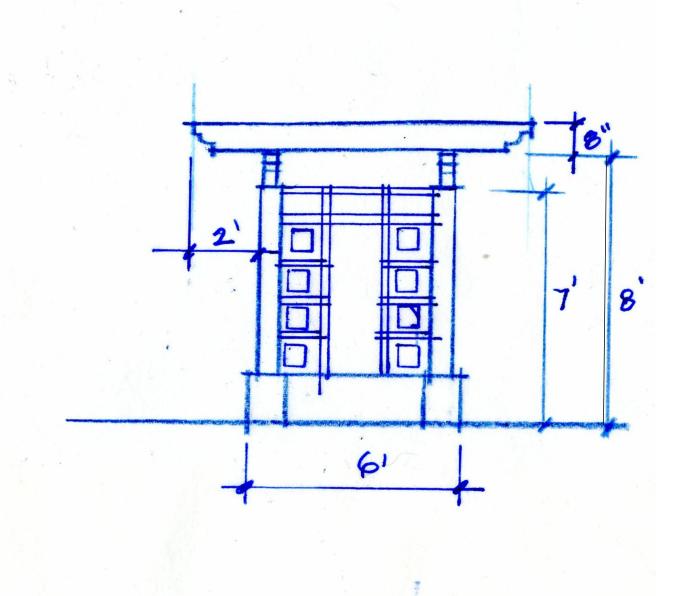


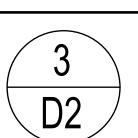MOON GATE IMAGE

Scale: 3/8"=1'-0"



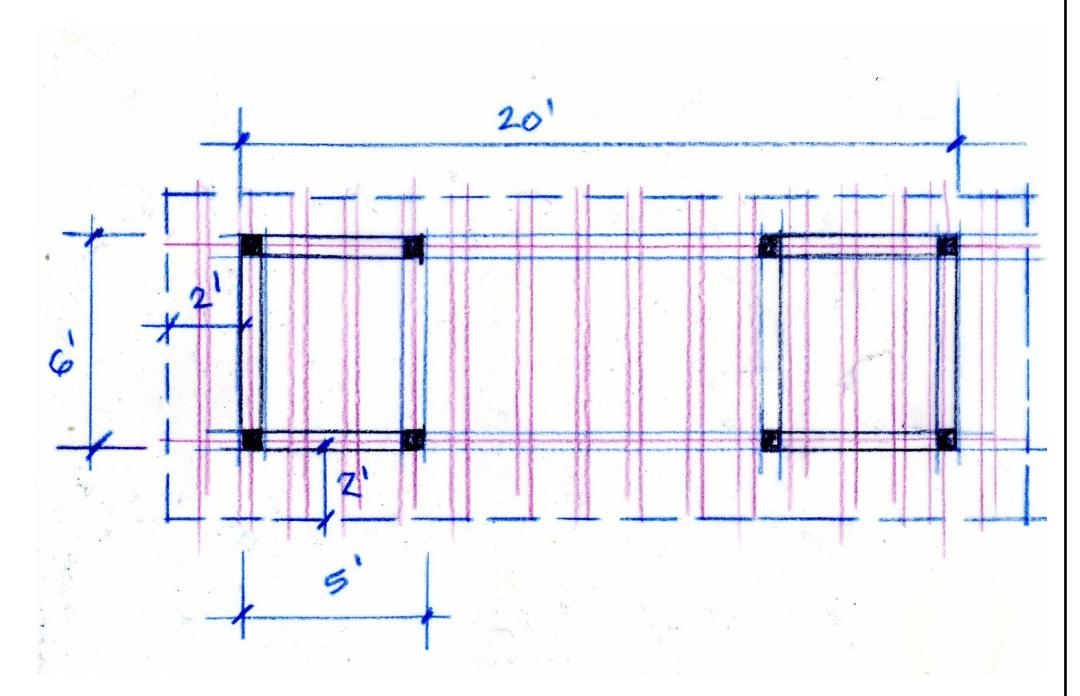


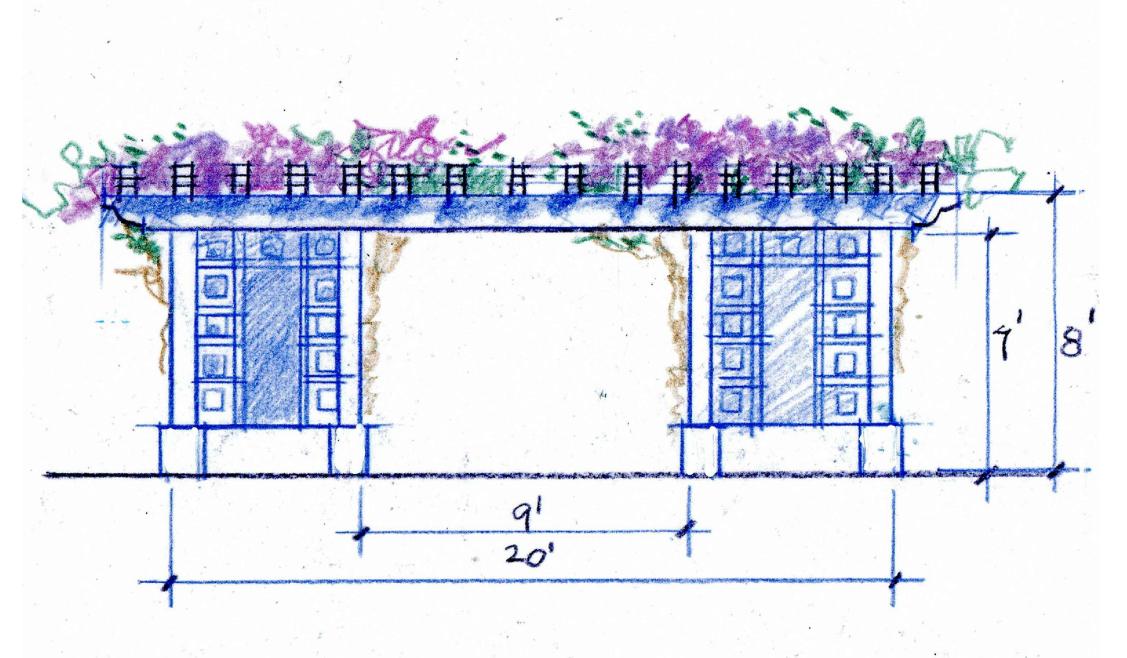

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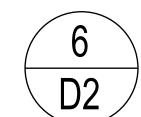
ARBOR PLAN

Scale: 3/8"=1'-0"

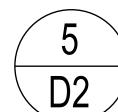

ARBOR FRONT ELEVATION

Scale: 3/8"=1'-0"



ARBOR SIDE ELEVATION

Scale: 3/8"=1'-0"

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Scale: 1/4"=1'-0"

Project Name:

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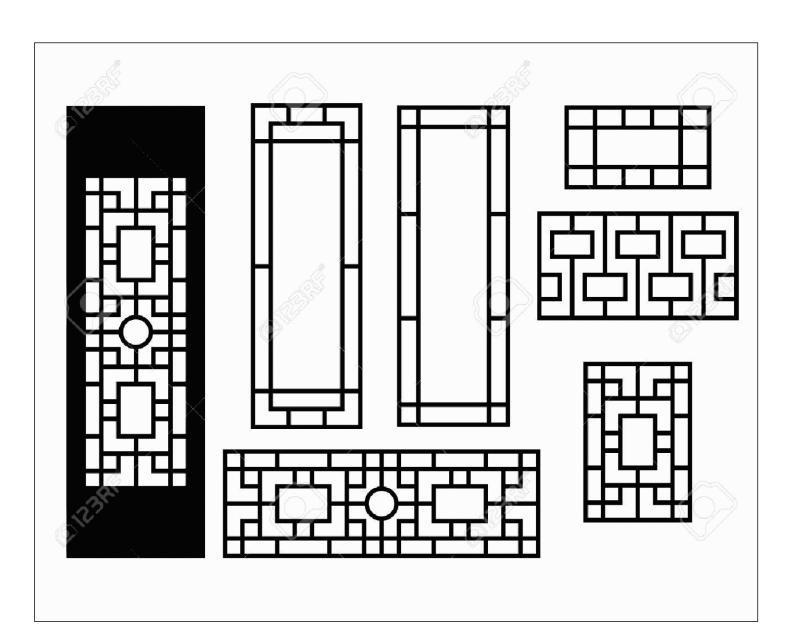
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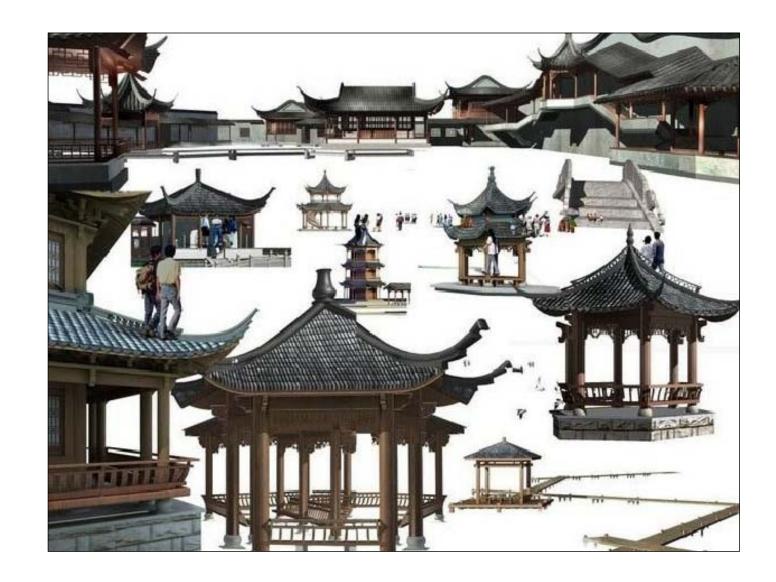
ARBOR & MOON
GATE DETAILS

Chart Number


D-2

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√190x70 SG8 rafter, H3.2 treated

tiles on roofing underlay on 20mm plywood roof on 50x50 purlins at 180 crs, all timber H3.2 treated

→H3.2 treated timber Roof Beam 3

-190x70 SG8 rafter, H3.2 treated

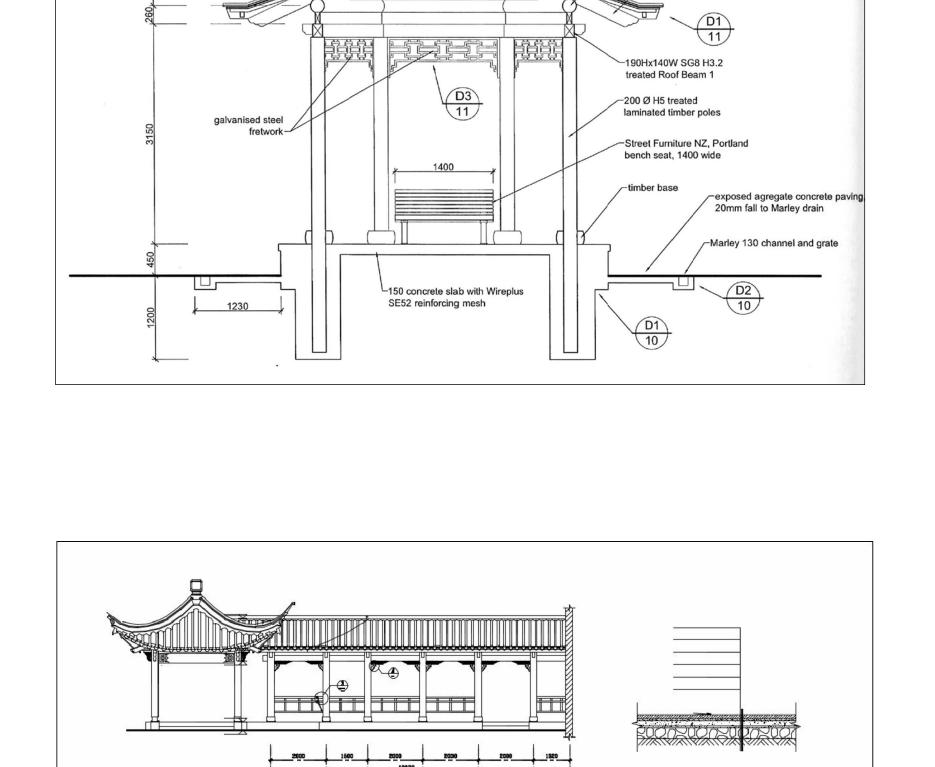laminated timber finial, H3.2 treated-





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MURAKAM I LANDSCAPE ARCHITECTS

326 NE 1st Avenue Delray Beach, Florida 33444-3804
561 276 7750
FAX 561 276 7046

Revision: SEPTEMBER 12, 2019

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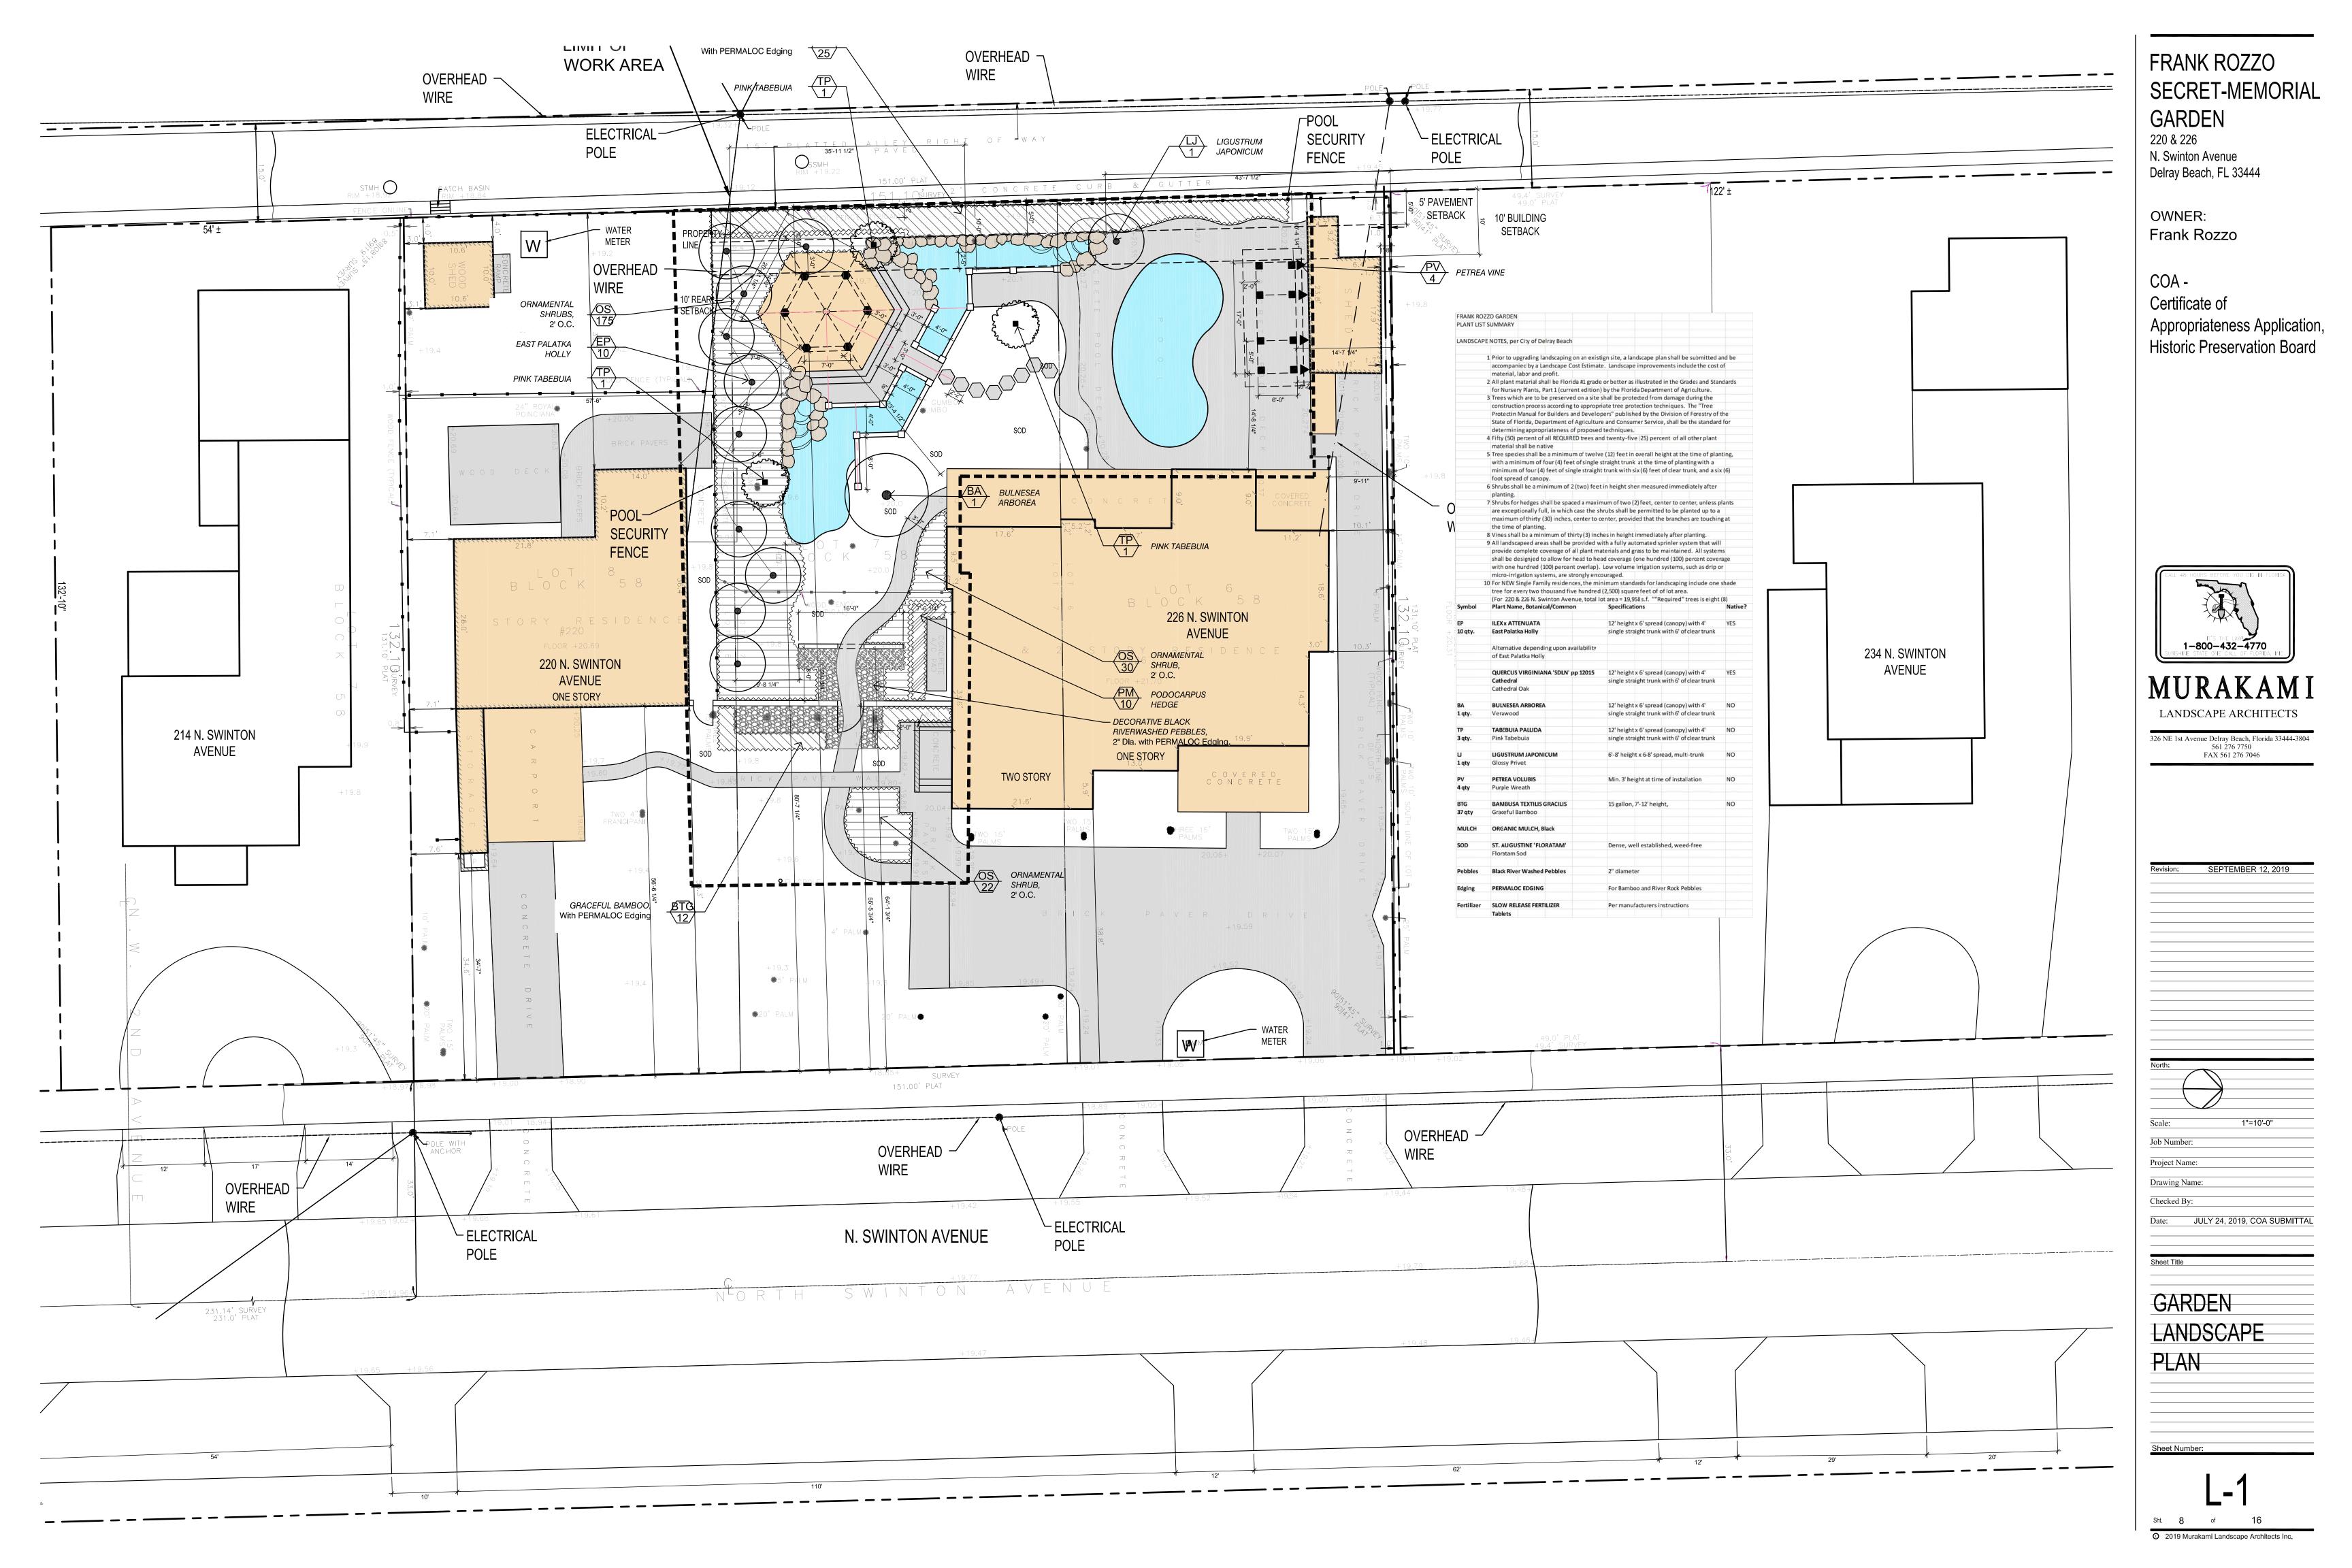
PAGODA CHARACTER

IMAGE

Sheet Number:

D-3

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PLANTING SPECIFICATIONS

THE WORK INCLUDES FURNISHING ALL PLANS, MATERIALS, EQUIPMENT, AND LABOR THESE SPECIFICATIONS

II. PLANT MATERIALS

A. PLANT LIST

A LIST OF PLANT MATERIALS IS INCLUDED WITHIN THESE DRAWINGS.

1. QUANTITIES NECESSARY TO COMPLETE THE PLANTING ARE INDICATED WITHIN

2. THE CONTRACTOR SHALL NOT BE RELIEVED OF THE RESPONSIBILITY OF OBTAINING SPECIFIED MATERIALS IN ADVANCE IF SPECIAL GROWING CONDITIONS OR OTHER ARRANGEMENTS MUST BE MADE IN ORDER TO SUPPLY SPECIFIED MATERIALS.

3. PLANT QUANTITIES ARE PROVIDED ONLY FOR THE CONVENIENCE OF LANDSCAPE CONTRACTOR. IN ALL CASES, THE PLANS SHALL HAVE PRECEDENCE OVER THE PLANT LIST IN QUANTITY AND AREA COVERAGE. ANY DICREPANCIES SHALL BE BROUGHT TO THE ATTENTION OF THE LANDSCAPE ARCHITECT. THE LANDSCAPE CONTRACTOR IS RESPONSIBLE FOR CHECKING THE PLANS FOR PLANT QUANTITIES, AND AREA CALCULATIONS.

1. PLANTS SHALL HAVE A HABIT OF GROWTH THAT IS NORMAL FOR THE SPECIES AND SHALL BE HEALTHY, VIGOROUS, AND EQUAL FOR EXCEED THE MEASUREMENTS SPECIFIED IN THE PLANT LIST. WHICH ARE MINIMUM ACCEPTABLE SIZES. THEY SHALL BE MEASURED BEFORE PRUNING WITH BRANCHES IN NORMAL POSITION. ANY NECESSARY PRUNING SHALL BE DONE AT THE PLACE OF GROWTH PRIOR TO TRANSPLANTING. REQUIREMENTS FOR MEASUREMENTS, BRANCHING, GRADING QUALITY, BALLING AND BURLAPPING OR PLANTS IN THE PLANT LIST SHALL FOLLOW THE FLORIDA 'GRADES AND STANDARDS FOR NURSERY STOCK. FOR FLORIDA NO. 1 OR BETTER AS OUTLINED IN THE 'GRADES AND STANDARDS FOR NURSERY PLANTS', PUBLISHED BY THE FLORIDA DEPARTMENT OF AGRICULTURE AND CONSUMER SERVICES. PLANTS THAT MEET THE REQUIREMENTS SPECIFIED, BUT DO NOT HAVE THE NORMAL BALANCE OF HEIGHT AND SPREAD TYPICAL FOR THE RESPECTIVE PLANT, SHALL NOT BE ACCEPTED.

2. ALL PLANT MATERIAL SHALL BE FLORIDA NO. 1 GRADE OR BETTER AS GIVEN IN THE CURRENT "GRADES AND STANDARDS FOR NURSERY PLANTS, PREPARED BY THE STATE OF FLORIDA DEPARTMENT OF AGRICULTURE AND CONSUMER SERVICES.

3. TREE CALIPER (TRUNK DIAMETER) SHALL BE MEASURED AT A POINT WHICH IS AT LEAST FOUR AND ONE-HALF (4 1/2) FEET (DBH) ABOVE EXISTING GRADE LEVEL OR AS DICTATED BY CITY/COUNTY/OR OTHER REGULATING AGENCY TO CONFORM WITH CODE REOUIREMENTS. THE MOST RESTRICTIVE CRITERIA FOR CALIPER MEASUREMENT SHALL APPLY. IF THEIR ARE ANY QUESTIONS OR CONFLICTS IN THE CODE, NOTIFY LANDSCAPE ARCHITECT IMMEDIATELY FOR RESOLUTION.

4. PALM CALIPER SHALL BE MEASURED AS REQUIRED BY APPLICABLE JURISDICTIONAL CODES (DBH OR OTHERWISE)

5. ALL PLANT MATERIALS SHALL BE SUBJECT TO INSPECTION AND APPROVAL BY THE LANDSCAPE ARCHITECT AT PLACE OF GROWTH AND UPON DELIVERY FOR CONFORMITY TO SPECIFICATIONS.

6. ALL PLANTS SHALL BE TRUE TO SPECIES AND VARIETY AND SHALL CONFORM TO MEASUREMENTS SPECIFIED EXCEPT THAT PLANTS LARGER THAN SPECIFIED MAY BE USED IF APPROVED BY THE LANDSCAPE ARCHITECT. NO PLANTS SHALL BE

7. UNLESS OTHERWISE NOTED, ALL PLANTS SHALL BE EXCEPTIONALLY HEAVY, SYMMETRICAL, TIGHTLY KNIT, AND SO TRAINED OR FAVORED IN DEVELOPMENT AND APPEARANCE AS TO BE SUPERIOR TO FORM, NUMBER OF BRANCHES, COMPACTNESS, AND SYMMETRY

ACCEPTED MEASURING LESS THAN ANY OF THE SPECIFIED REQUIREMENTS.

D. SUBSTITUTIONS

SUBSTITUTIONS WILL BE PERMITTED ONLY UPON AUTHORIZATION BY THE LANDSCAPE ARCHITECT. REPLACEMENT SHALL BE OF THE NEAREST EQUIVALENT OBTAINABLE SIZE AND VARIETY OF THE PLANT HAVING THE SAME ESSENTIAL CHARACTERISTICS WITH AN EQUITABLE ADJUSTMENT OF CONTRACT PRICE. SHOULD THE LANDSCAPE ARCHITECT DEEM IT APPROPRIATE AND SUBSTITUTE PLANT MATERIAL OTHER THAN THAT SPECIFIED, IT SHALL BE ACCOMPLISHED AS LONG AS THE UNIT PRICE OF THE SUBSTITUTED ITEM DOES NOT EXCEED THE BID ITEM BEING REPLACED.

III. PLANTING

A. LAYOUT

1. LOCATION FOR PLANTS AND OUTLINES OF AREAS TO BE PLANTED AS INDICATED ON THE PLAN. WHERE CONSTRUCTION OR UTILITIES BELOW GROUND OR OVERHEAD ARE ENCOUNTERED OR WHERE CHANGES HAVE BEEN MADE IN THE CONSTRUCTION. NECESSARY ADJUSTMENTS WILL BE APPROVED BY THE LANDSCAPE ARCHITECT.

2. ALL TREE LOCATIONS SHALL BE STAKED BY THE CONTRACTOR AND APPROVED BY THE LANDSCAPE ARCHITECT BEFORE BEGINNING INSTALLATION OR WORK. ALL PLANTS AND PLANT LOCATIONS SHALL BE APPROVED IN FIELD BY THE LANDSCAPE ARCHITECT PRIOR TO PLANTING

B. GRADING

1. CONTRACTOR SHALL VERIFY EXISTING GRADES AND DRAINAGE PATTERNS AND SHALL COORDINATE ALL GRADING, PARTICULARLY MOUNDING, WITH THE LANDSCAPE ARCHITECT. ALL NEW GRADING SHALL HAVE SMOOTH TRANSITIONS INTO EXISTING

2 GENERAL CONTRACTOR TO BRING ROUGH FINISH GRADE TO WITHIN 3" OF THE TOP OF WALK OR CURB GRADE. LANDSCAPE CONTRACTOR SHALL BE REQUIRED TO FILL AND GRADE TO 2" BELOW TOP OF WALK OR CURB IN ALL PLANTING AREAS. FINISH GRADE IN PLANTING AND SOD AREAS IS THE RESPONSIBILITY OF THE LANDSCAPE CONTRACTOR. CONTRACTOR SHALL BE RESPONSIBLE FOR CALCULATING FILL AND

3. THE CONTRACTOR WILL CONSTRUCT EARTH BERMS IN THE LOCATIONS AND CONFIGURATIONS INDICATED ON THE PLANTING PLANS WITH TOPSOIL SUPPLIED BY THE CONTRACTOR FARTH BERMS SHALL BE COMPACTED TO SUCH A DEGREE THAT THEY SUPPLY A STABLE PLANTING SITE CAPABLE OF SUPPORTING TREES. SHRUBS, GROUND COVERS, VINES, AND LAWN. ALL ROUGH AND FINISH GRADING OF EARTH BERMS SHALL ALSO BE THE RESPONSIBILITY OF THE CONTRACTOR. IN THE VICINITY OF EACH EARTH BERM THE CONTRACTOR SHALL REGRADE AS NECESSARY TO BLEND EACH EARTH BERM INTO THE GENERAL CONTRACTOR'S SURROUNDING FINISH GRADE. THE CONTRACTOR SHALL INSURE THAT HIS WORK DOES NOT INTERRUPT ESTABLISHED DRAINAGE PATTERNS. FINAL GRADE OR EARTH BERMS SHALL BE APPROVED BY THE LANDSCAPE ARCHITECT PRIOR TO PLANTING, SODDING, OR SEEDING OPERATIONS.

4. THE CONTRACTOR SHALL COMPACT TOPSOIL WITH A ROLLER IMPARTING NO MORE THAN 2.5 LBS. PER SQUARE INCH. THE TOPSOIL SHALL BE ROLLED TWICE; THE FIRST PASS IS TO BE PERPENDICULAR TO THE SECOND. ANY IRREGULARITIES IN THE SURFACE RESULTING FROM TOPSOILING OR OTHER OPERATIONS SHALL BE CORRECTED IN ORDER TO PREVENT THE FORMATION OF DEPRESSIONS OR WATER

5. IMMEDIATELY PRIOR TO ANY TURF OR GROUND COVER WORK, THE CONTRACTOR WILL FINE GRADE THE TOPSOIL TO A SMOOTH, EVEN SURFACE ASSURING POSITIVE %. TURF WILL BE FLUSH TO THE TOP OF ADJACENT

C. SOIL PREPARATION

1. TOPSOIL TO BE USED FOR SOIL MIXTURE SHALL BE CLEAN, FERTILE, WELL-DRAINED AND OF UNIFORM QUALITY FREE OF CLAY, STONES, WEEDS, ROOTS AND FOREIGN DEBRIS. TOPSOIL TO BE APPROVED BY THE LANDSCAPE ARCHITECT. STANDARD PLANTING MIX SHALL BE COMPRISED OF A 60/40 MIX (SAND/FLORIDA MUCK).

AMENDMENTS SHALL BE ADDED TO PLANTING MIX PER SOIL TESTS. THE PH SHALL BE MAINTAINED AT 6.5 TO 7.5. THE SOIL SHALL BE IN A RELATIVELY DRY STATE AND MIXED THOROUGHLY BY HAND OR ROTARY MIXER. ALL PLANTING SHALL BE COATED WITH AN APPROVED WEED KILLER ACCORDING TO THE MANUFACTURER'S

2. ALL PLANTS TO RECEIVE 20-10-5 FORMULA 21 GRAMS AGRIFORM PLANTING TABLETS OR WOODACE 18 GRAM BRIQUETTES (14-3-3 FORMULA) AND SHALL BE EVENLY DISTRIBUTED IN PLANT PITS NO DEEPER THAN 4 INCHES. RATES OF APPLICATION AND DIRECTIONS SHALL BE IN ACCORDANCE TO MANUFACTURER'S

D. SETTING TREES

1. CONTRACTOR SHALL VERIFY ALL EXISTING FACILITIES AND UNDERGROUND CONDITIONS PRIOR TO BEGINNING EXCAVATIONS OF TREE PITS AND PLANT BEDS.

2. UNLESS OTHERWISE SPECIFIED, ALL TREES SHALL BE PLANTED IN PITS, CENTERED, AND SET ON SIX INCHES (6") OF COMPACTED TOPSOIL TOPSOIL TO SUCH DEPTHS THAT THE FINISHED GRADE LEVEL OF THE PLANT AFTER SETTLEMENT SHALL BE THE SAME AS THAT AT WHICH THE PLANT WAS GROWN. THEY SHALL BE PLANTED UPRIGHT AND FACED TO GIVE THE BEST APPEARANCE OR RELATIONSHIP TO GRADING. PLANTING SOIL SHALL BE PLACED AND COMPACTED THOROUGHLY AND SHALL BE SETTLED BY WATERING. NO FILLING AROUND TRUNKS WILL BE PERMITTED. AFTER THE GROUND SETTLES, ADDITIONAL SOIL SHALL BE FILLED INTO THE LEVEL OF THE FINISHED GRADE, ALLOWING THREE INCHES (3") OF MULCH TO FORM A SHALLOW SAUCER AROUND EACH PLANT.

3. LANDSCAPE CONTRACTOR IS RESPONSIBLE TO TEST EACH TREE PLANTING PIT FOR DRAINAGE AND ASSURE GOOD PERCOLATION PRIOR TO PLANTING TREES AND PALMS.

E. PRUNNING-NEW PLANT MATERIAL

REMOVE DEAD AND BROKEN BRANCHES FROM ALL PLANT MATERIAL. PRUNE TO RETAIN NATURAL GROWTH HABIT OR INDIVIDUAL PLANTS WITH AS MUCH HEIGHT AND SPREAD AS PRUNE TO NAA STANDARDS.

F. STAKING TREES

1. TREES SHALL BE STAKED WITHIN 24 HOURS AFTER EACH IS INSTALLED. AFTER 14 HOURS THE LANDSCAPE ARCHITECT WILL PROHIBIT ANY FURTHER PLANTING UNTIL ALL INSTALLED TREES ARE STAKED. SUCH STORAGE WILL NO WAY ALTER THE CONTRACTOR'S COMPLETION DATE.

2. STAKING OF TREES IS TO BE USED BY THE CONTRACTOR, WHO WILL BE RESPONSIBLE FOR MATERIAL REMAINING PLUMB AND STRAIGHT FOR ALL GIVEN CONDITIONS THROUGH THE GUARANTEE PERIOD.

3. STAKE ALL TREES UNDER THREE INCH (3") CALIPER WITH TWO (2) 8' STEEL T-POST TREE STAKES. LOCATE FIRST STAKE OPPOSITE FIRST. STAKES SHALL BE AS CLOSE TO MAIN TRUNK AS IS PRACTICAL, AVOIDING ROOT INJURY, AND DRIVEN AT LEAST EIGHTEEN INCHES (18") INTO FIRM GROUND.

4. TIE TREE TO STAKES USING APPROVED TREE TIES. TIES SHALL BE LOCATED MIDWAY WITHIN TREE CROWN OR AT A LOCATION APPROXIMATELY TWO-THIRDS (2/3) OF THE OVERALL HEIGHT OF THE TREE. LOCATE TIE JUST ABOVE MAJOR SIDE BRANCH IN ORDER TO DETER SLIPPAGE AND FASTEN TO STAKE. SECURE SECOND TIE OPPOSITE FIRST AT TREE AND FASTEN TO OPPOSITE STAKE.

G. GUYING TREE

1. GUY ALL TREES GREATER THAN THREE INCHES (3") IN CALIPER IN THREE (3) DIRECTIONS WITH TWO (2) STRANDS OF NO.12 GALVANIZED WIRE ATTACHED TO ANCHORS DRIVEN BELOW GRADE. WHEN SECURING WIRES TO TREES, COVER ALL WIRES WHICH MAY COME IN CONTACT WITH ANY PART OF THE TREE WITH NEW 3.4" DIAMETER BLACK RUBBER HOSE, PLACE GUYS NOT LESS THAN 1.3 HEIGHT OF TREE ABOVE GROUND. PLACE ANCHORS SO THAT GUYS ARE EQUALLY SPACED AND AT 45 DEGREE ANGLES TO HORIZON. KEEP GUYS TAUGHT UNTIL PROJECT COMPLETION. SECURE A RIBBON OF FLOURESCENT FLAGGING TAPE AT MIDPOINT OF EACH GUY WIRE.

2. NO NAILS OR ANY OTHER FASTENERS SHALL DIRECTLY PENETRATE THE BARK AND TRUNK OF THE TREE

ALL INDIVIDUAL TREE, PALM AND SHRUB PITS AND BEDS SHALL BE MULCHED WITH A MINIMUM THREE INCH (3") LAYER OF GRADE A, SHREDDED CYPRESS MULCH.

1. SOD SHALL BE ST. AUGUSTINE "FLORATAM", UNLESS OTHERWISE SPECIFIED, SOLID AND FREE OF WEEDS, LAID WITH ALTERNATING AND ABUTTING JOINTS. ALL SODDED AREAS ARE TO BE HAND RAKED BEFORE SOD IS INSTALLED. ROCKS STICKS, DEBRIS, AND BUMPS ARE TO BE ELIMINATED. SOD SHALL BE LAID TO THE EDGE OF PAVEMENT IN RIGHT-OF-WAY AND INSTALLED WITHIN 48 HOURS OF BEING CUT.

2. ALL NEWLY SODDED AREAS SHALL BLEND AND MATCH WITH EXISTING SODDED AREAS SO AS TO PRODUCE A SMOOTH, UNIFIED LAWN. THE LANDSCAPE ARCHITECT SHALL APPROVE FINAL GRADES PRIOR TO INSTALLATION OF LAWN.

IV. MAINTENANCE

MAINTENANCE SHALL BEGIN IMMEDIATELY AFTER EACH PLANT IS PLANTED AND SHALL CONTINUE UNTIL ALL PLANTING HAS PASSED FINAL INSPECTION AND ACCEPTANCE. MAINTENANCE SHALL INCLUDE WATERING, WEEDING, CULTIVATING, REMOVAL OR DEAD MATERIAL, RESETTING PLANTS TO PROPER GRADES OR UPRIGHT POSITION AND RESTORATION OF THE PLANTING SAUCER AND ANY OTHER NECESSARY OPERATIONS. PROPER PROTECTION TO LAWN AREAS SHALL BE PROVIDED AND ANY DAMAGE RESULTING FROM PLANTING OPERATIONS SHALL BE REPAIRED PROMPTLY.

V. INSPECTION AND ACCEPTANCE

INSPECTION OF WORK TO DETERMINE COMPLETION OF CONTRACT, EXCLUSIVE OF THE POSSIBLE REPLACEMENT OF PLANTS, WILL BE MADE BY THE OWNER AND/OR LANDSCAPE ARCHITECT AT THE CONCLUSION OF ALL PLANTING AND AT THE WRITTEN REQUEST OF THE CONTRACTOR.

AFTER INSPECTION. THE CONTRACTOR WILL BE NOTIFIED BY THE OWNER OF THE ACCEPTANCE OF ALL WORK OF PLANTING. EXCLUSIVE OF THE POSSIBLE REPLACEMENT OF PLANTS SUBJECT TO GUARANTEE OR IF THERE ARE ANY DEFICIENCIES OR THE REQUIREMENT FOR COMPLETION OF THE WORK.

VI. GUARANTEE AND REPLACEMENT

A. GUARANTEE

1. ALL NEW PLANT MATERIALS SHALL BE GUARANTEED OF ACCEPTANCE AND SHALL BE ALIVE AND IN SATISFACTORY CONDITION AND GROWTH FOR EACH SPECIFIC KIND OF PLANT AT THE END OF THE GUARANTEE PERIOD.

2. ALL TREES AND PALMS PLANTED SHALL BE FULLY WARRANTED BY THE CONTRACTOR AND WILL BE HEALTHY AND IN A FLOURISHING CONDITION OF ACTIVE GROWTH ONE (1) YEAR (365 CALENDAR DAYS) FROM DATE OF FINAL ACCEPTANCE.

3. ALL SHRUBS, GROUND COVERS, VINES AND SOD SHALL BE FULLY WARRANTED FOR

B. REPLACEMENT

1. AT THE END OF THE GUARANTEE PERIOD, ANDY PLANT REQUIRED UNDER THIS CONTRACT THAT IS DEAD OR NOT IN SATISFACTORY GROWTH, AS DETERMINED BY THE LANDSCAPE ARCHITECT, SHALL BE REMOVED FROM THE SITE AND REPLACED WITHIN FIFTEEN (15) DAYS WITH NO EXTRA COST TO OWNER.

2. ALL REPLACEMENTS SHALL BE PLANTS OF THE SAME KIND AND SIZE AS SPECIFIED IN THE PLANT LIST. THEY SHALL BE FURNISHED AND PLANTED AS SPECIFIED HEREIN. THE COST SHALL BE THE RESPONSIBILITY OF THE CONTRACTOR.

1. CONTRACTOR SHALL SCHEDULE AND ATTEND A PRE-CONSTRUCTION CONFERENCE WITH REPRESENTATIVES OF THE OWNER, THE LANDSCAPE ARCHITECT, AND THE ARCHITECT BEFORE COMMENCING WORK

2. ALL LANDSCAPING SHALL BE INSTALLED IN A SOUND, WORKMANLIKE MANNER AND ACCORDING TO ACCEPTED GOOD PLANTING PROCEDURES AS PRESCRIBED BY THE AMERICAN SOCIETY OF LANDSCAPE ARCHITECTS.

VII. CARE AND MAINTENANCE SCHEDULE


A. THE CONTRACTOR SHALL FURNISH THE OWNER WITH A WRITTEN AND DETAILED DESCRIPTION FOR THE CARE AND MAINTENANCE OF ALL PLANT MATERIAL AT THE TIME OF FINAL INSPECTION. THE OWNER AGREES TO EXECUTE THE INSTRUCTIONS FOR SUCH CARE AND MAINTENANCE.

B. ALL LANDSCAPING SHALL BE MAINTAINED IN A HEALTHY GROWING CONDITION AND SHALL BE KEPT FREE FROM REFUSE AND DEBRIS. MAINTENANCE SHALL INCLUDE WATERING, WEEDING, MOWING, FERTILIZING, TREATING, MULCHING, PRUNING, REMOVAL/ REPLACEMENT OF DEAD OR DISEASED TREES AND REMOVAL OF REFUSE AND DEBRIS ON A REGULAR BASIS SO AS TO PRESENT A NEAT AND WELL-KEPT APPEARANCE AT


BUILDING OR HARDSCAPE ELEMENT TRIM SOD IN A STRAIGHT LINE WHEN PLANTING BEDS TO A BUILDING OR OTHER USE GUIDE STRINGS TO IRREGULAR ALIGNMENTS ARE NOT ACCEPTABLE

SOD TRIMMING - LINEAR SHRUB BEDS


SECTION TREE RING NOT TO SCALE SINGLE ROW SPACING DIAGRAM FOR HEDGES

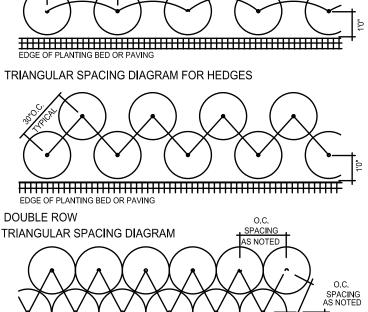

EDGE OF PLANTING BED OR PAVING

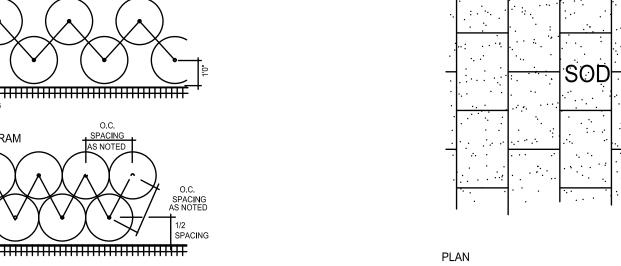



SHURB/PLANT SPACING DIAGRAMS

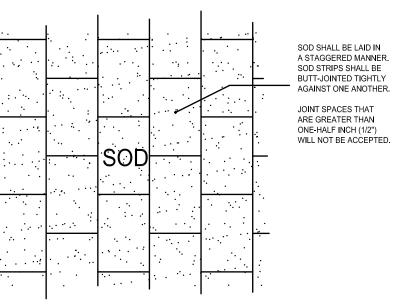

SOD PLANTING


NOT TO SCALE

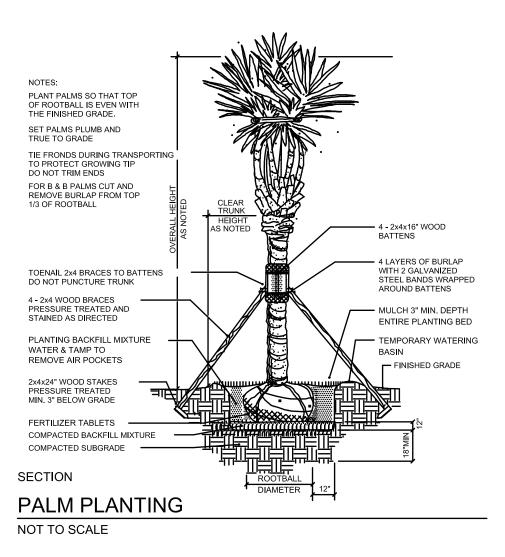

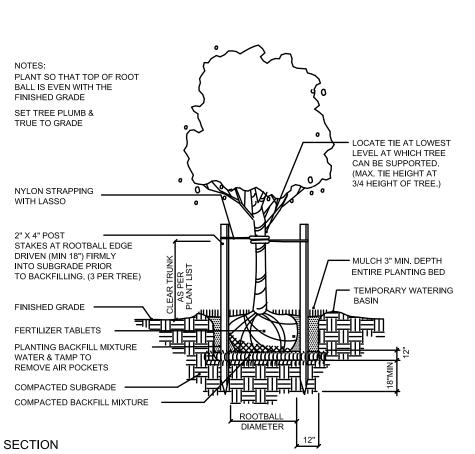

TREE PLANTING/STAKING


NOT TO SCALE [TO 3" CALIPER]

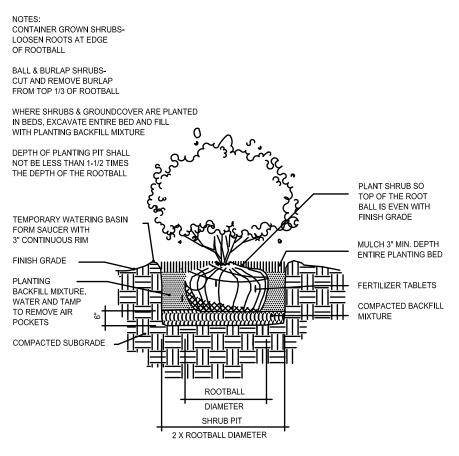

SECTION

SHRUB PLANTING

NOT TO SCALE

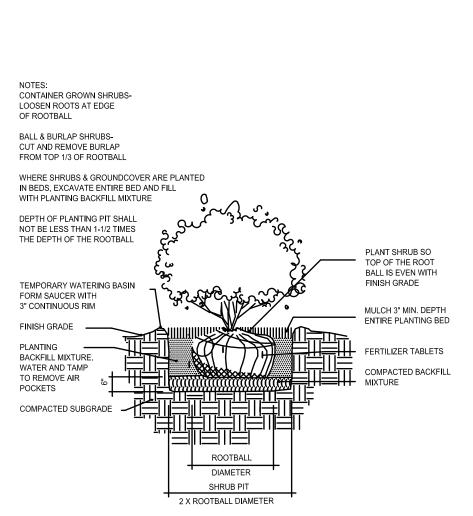

PLANT NOTES,

DETAILS &

Job Number

Project Name:

Checked By:

Drawing Name:

NO SCALE

JULY 24, 2019, COA SUBMITT

FRANK ROZZO

GARDEN

N. Swinton Avenue

Delray Beach, FL 33444

220 & 226

OWNER:

Frank Rozzo

Certificate of

SECRET-MEMORIAL

Appropriateness Application

Historic Preservation Board

1-800-432-4770

LANDSCAPE ARCHITECTS

326 NE 1st Avenue Delray Beach, Florida 33444-3804

FAX 561 276 7046

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Per LRD 4.6.16(C)(1)(b)4 "Contain a Statement of Intent as to the method and coverage of irrigation". Per LRD 4.6.16(F) Irrigation Requirements: "All landscaped areas shall be provided with a fully automated sprinkler system that will provide complete coverage of all plant materials and grass to be maintained. All systems shall be designed to allow for head-to-head coverage (one hundred

(100) percent coverage with one hundred (100) percent overlap)".


(ALTERNATE)



ILEX X ATTENUATA
East Palatka Hollv



QUERCUS VIRGINIANA
'SDLN'pp12015 Cathedral
Cathedral Oak

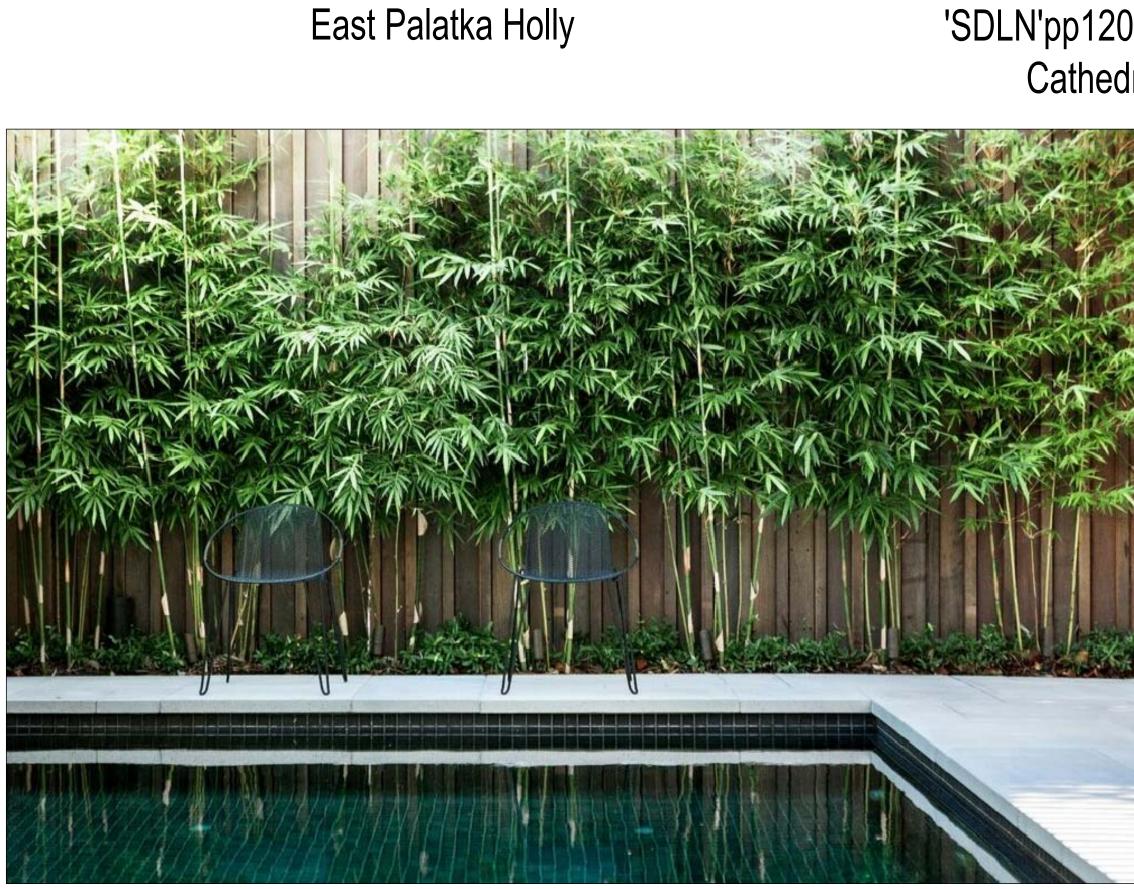

BAMBUSA TEXTILIS GRACILIS
Graceful Bamboo



BULNESIA ARBOREA Verawood



TABEBUIA PALLIDA Pink Tabebuia



PETREA VOLUBILIS
Purple Wreath

FRANK ROZZO SECRET-MEMORIAL GARDEN

220 & 226 N. Swinton Avenue Delray Beach, FL 33444

OWNER: Frank Rozzo

COA Certificate of
Appropriateness Application,
Historic Preservation Board



Revision: SEPTEMBER 12, 2019

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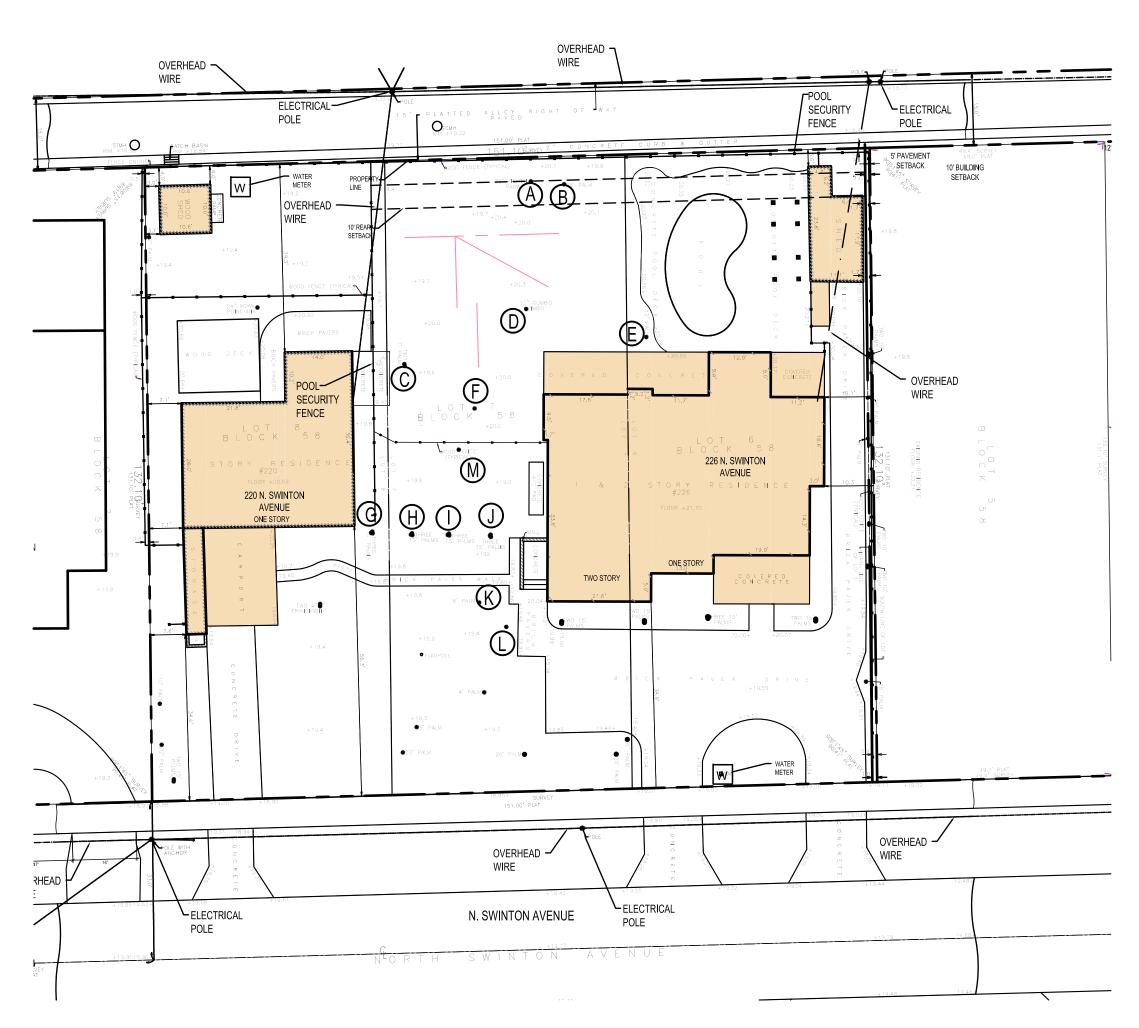
PLANT IMAGES


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L-3

Sht. 10 of 16

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TABULAR SUMMARY

Existing Trees and Palms, Relocation and/or Remove and Destroy

NOTE: Most all existing trees and palms shall be relocated in the front yard of 220 and 226 N. Swinton Avenue, and field located to fit with the existing landscape and to create a cohesive landscape. Most of the plant material are palms and esthetically, work best in the front yard, rather than in an

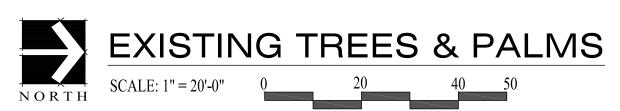Annual Control of the	red private garden.	ront yard, rather than in	all
Refernce	Tree/Palm	Size	
Α	CARYOTA MITIS Fishtail Palm	36" width cluster	Remain in place, if possi ble. Otherwise, remove and destroy
В	COCOS NUCIFERA Coconut Palm	20' overall	Relocate if possible, otherwise, remove and destory
c	ADONIDIA MERRILLII Christmas Palm	7' overall height	Relocate to front yard
D	BURSERA SIMARUBA Gumbo Limbo	12' diameter	Relocate to front yard
E	DYPSIS DECARYI Triangle Palm	12' height overall	Relocate to front yard
F	PLUMERIA OBTUSA Plumeria	6' overall height	Relocoate to front yard
G	ADONIDIA MERRILLI, triple Triple Christmas Palm	15' ht. overall	Relocate to front yard
н	ADONIDIA MERRILLI, triple Triple Christmas Palm	15' ht. overall	Relcoate to front yard
I	ADONIDIA MERRILLI, triple Triple Christmas Palm	15' ht. overall	Relcoate to front yard
J	ADONIDIA MERRILLI, triple Triple Christmas Palm	15' ht. overall	Relocate to front yard
К	ADONIDIA MERRILLI Christmas Palm	6' ht. overall	Relocate to front yard
Ĺ	COCOS NUCIFERA Coconut Palm	10' overall	Relocate to front yard
М	COCOS NUCIFERA Coconut Palm	10' overall	Relocate to front yard



A Fishtail Palm



B Coconut Palm



C Manilla Palm



D Gumbo Limbo



G, H, I, J Manilla Palm



E Triangle Palm

K Manilla Palm



F Plumeria

L Coconut Palm



M Coconut Palm



FRANK ROZZO

GARDEN

N. Swinton Avenue

Frank Rozzo

Certificate of

Delray Beach, FL 33444

220 & 226

OWNER:

COA -

SECRET-MEMORIAL

Appropriateness Application,

Historic Preservation Board

LANDSCAPE ARCHITECTS

326 NE 1st Avenue Delray Beach, Florida 33444-3804
561 276 7750
FAX 561 276 7046

	Revision:	SEPTEMBER	12,	2019
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North:			
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cale: 1"=20'

Job Number:
Project Name:

Drawing Name:
Checked By:

Date: JULY 24, 2019, COA SUBMITTAL


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EXISTING TREES & PALMS

L-4

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PROJECT DATA

220-226 N. Swinton Avenue

	Required-Permitted	Existing Lot 226 only	Proposed PAGODA only
Front Setback Side Interior Setback	25' 7.5'	38.5'/37.0 ' 1.7'/8.5'/10.1'/10.3'/13.5'	110' 7.5' and 57.5'
Rear Setback	10.0'	3.6'/41'0'	10'
Height/Floors	?	1 and 2 stories 12' & 30' H	20'
Width of Site	?	151'-10"	N/A
Depth of Site	?	132'-10"	N/A
Frontage	?	151'-10"	?
Total Site Area	?	19,958 s.f./ 0.46 ac	19,958 s.f./ 0.46 ac
Pervious Area	?	10,009 s.f./0.23 ac/50%	8,962 s.f./0.21 ac/45%
Impervious Area	?	9,949 s.f./0.23 ac/50%	10,996 s.f./0.25 ac/55%
Floor Area	?	4,026 s.f.	Pagoda 285 s.f./4,311 s.f.
Floor Area Ratio	?	FAR 0.20	FAR 0.22
Number of Dwelling Units	?	2	2
Density (Units per Acre)	?	0.23 units/acre	0.23 units/acre

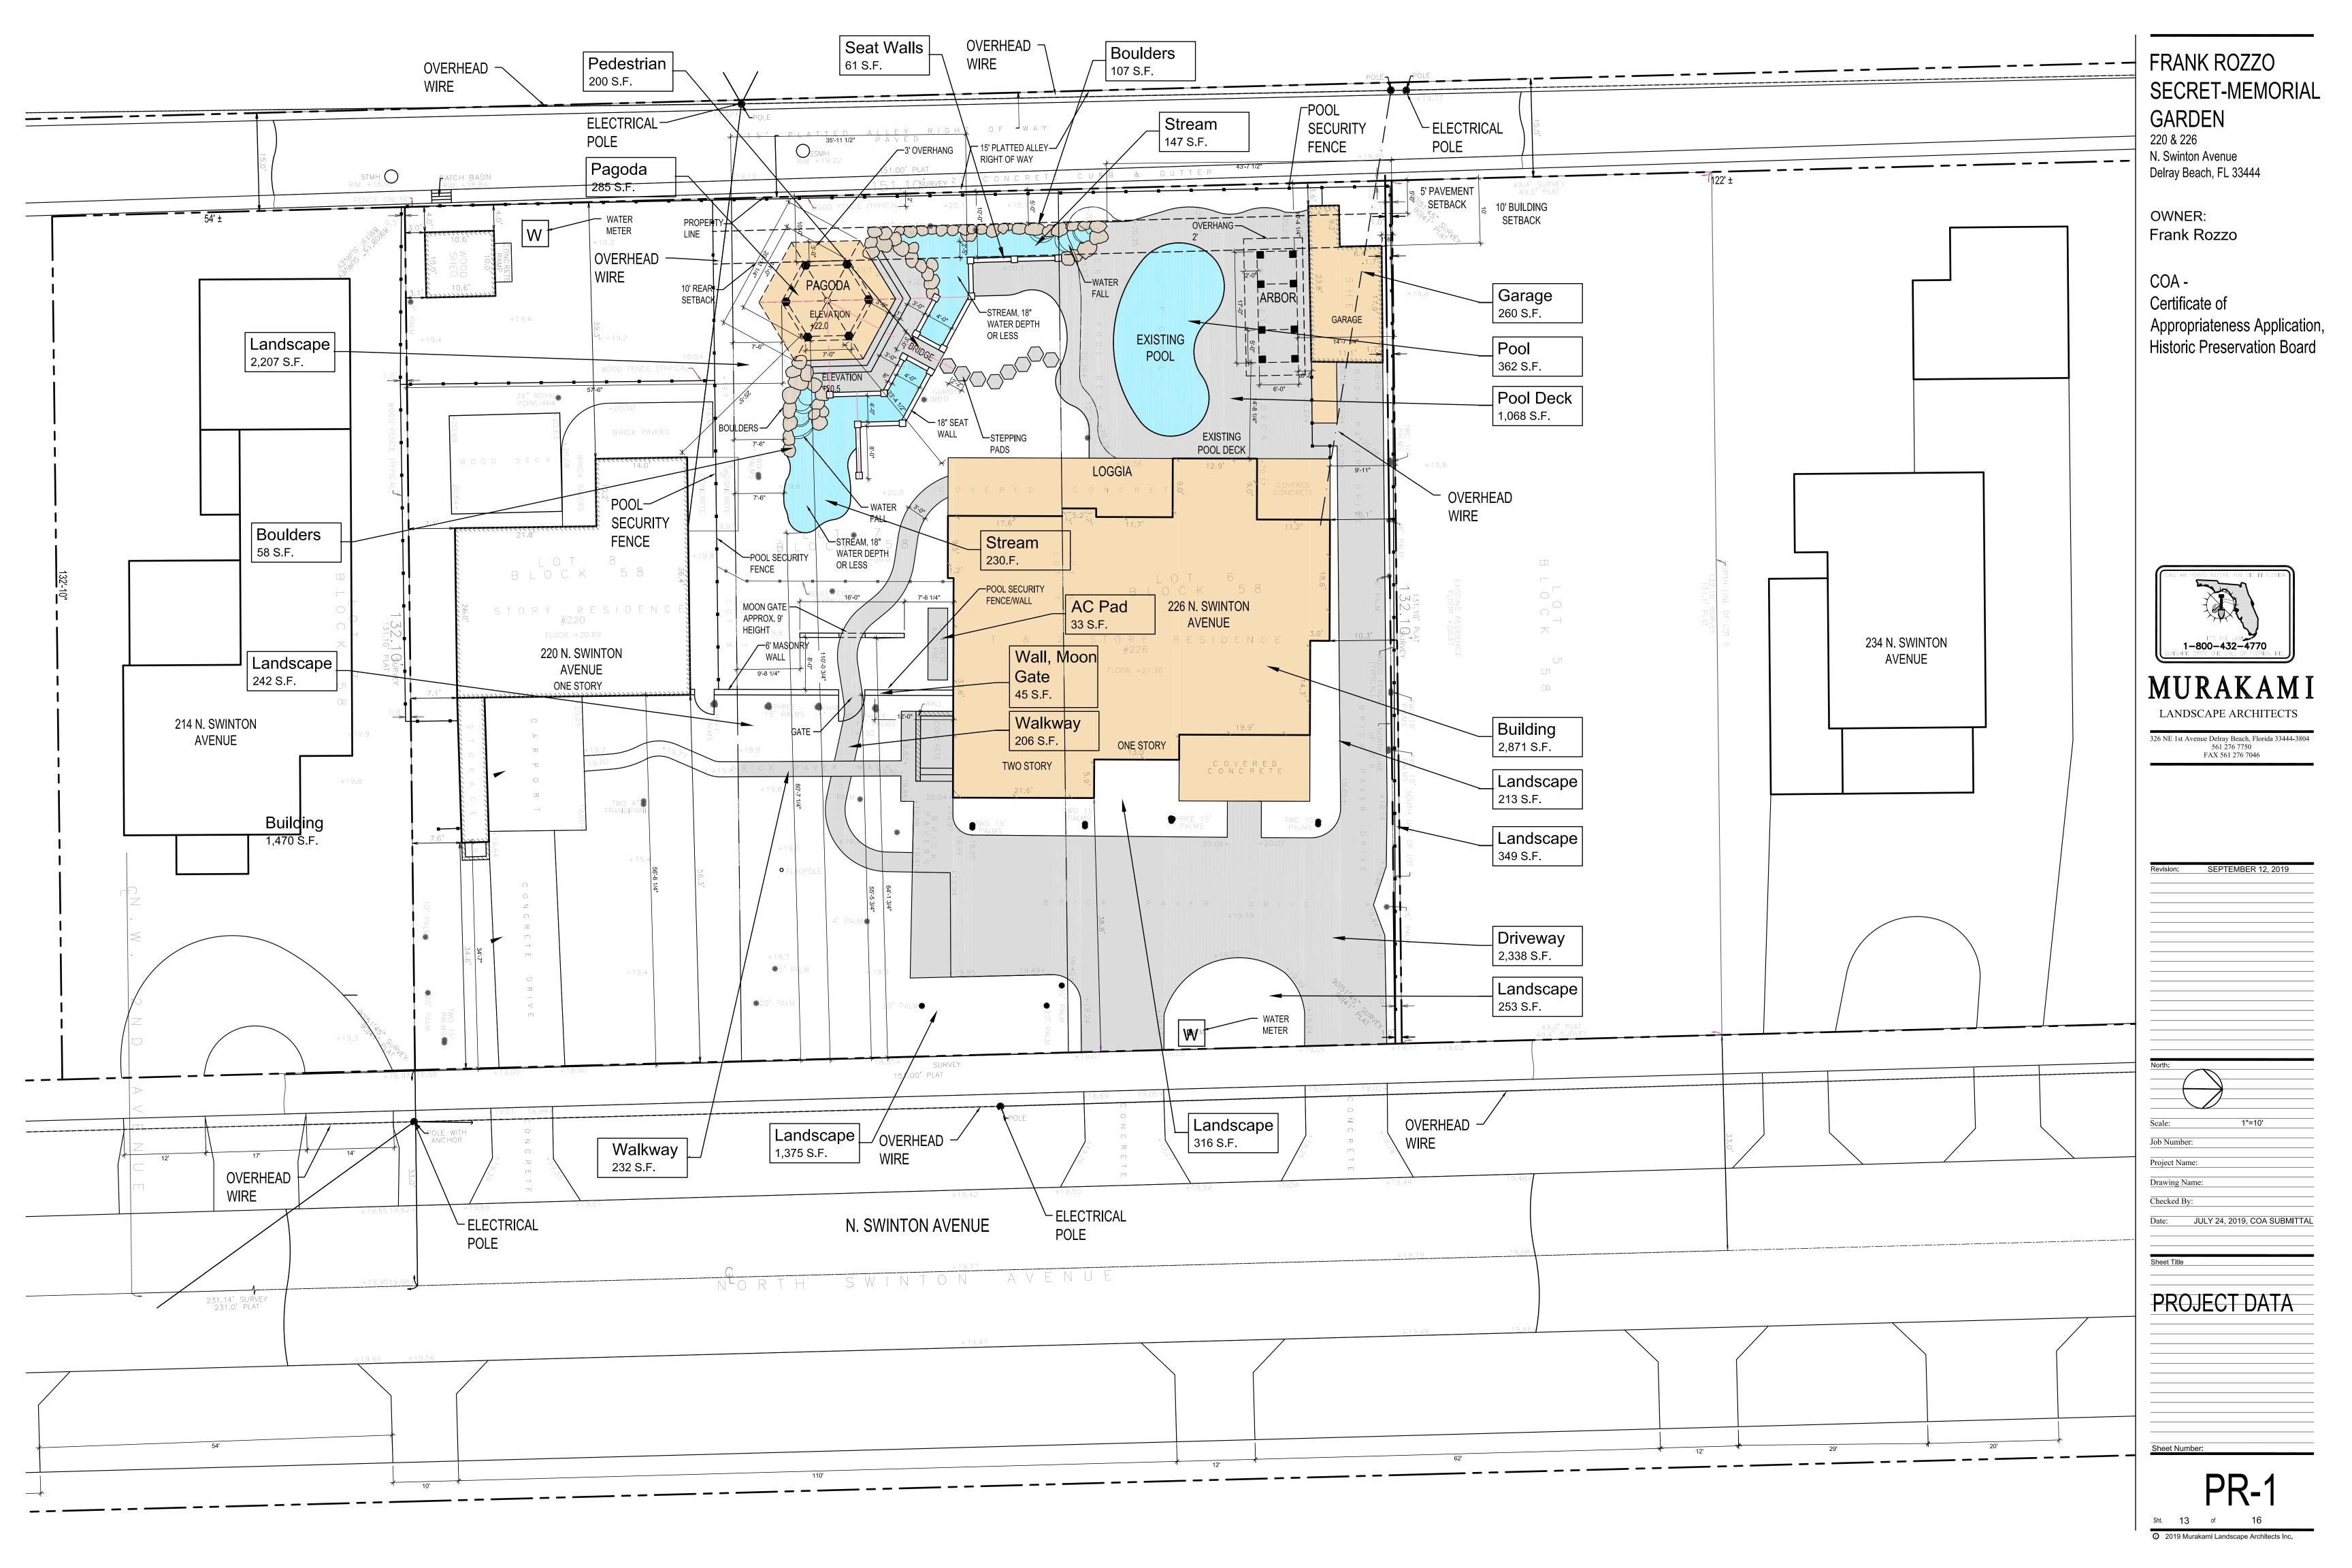Number of Units = 2

220 = 962 s.f. 226 = 3,064 s.f.

FRANK ROZZO SECRET-MEMORIAL GARDEN

220 & 226 N. Swinton Avenue Delray Beach, FL 33444

OWNER: Frank Rozzo

Certificate of Appropriateness Application, Historic Preservation Board




LANDSCAPE ARCHITECTS


326 NE 1st Avenue Delray Beach, Florida 33444-3804 561 276 7750 FAX 561 276 7046

Drawing Name:

Date: JULY 24, 2019, COA SUBMITTA

PROJECT DATA

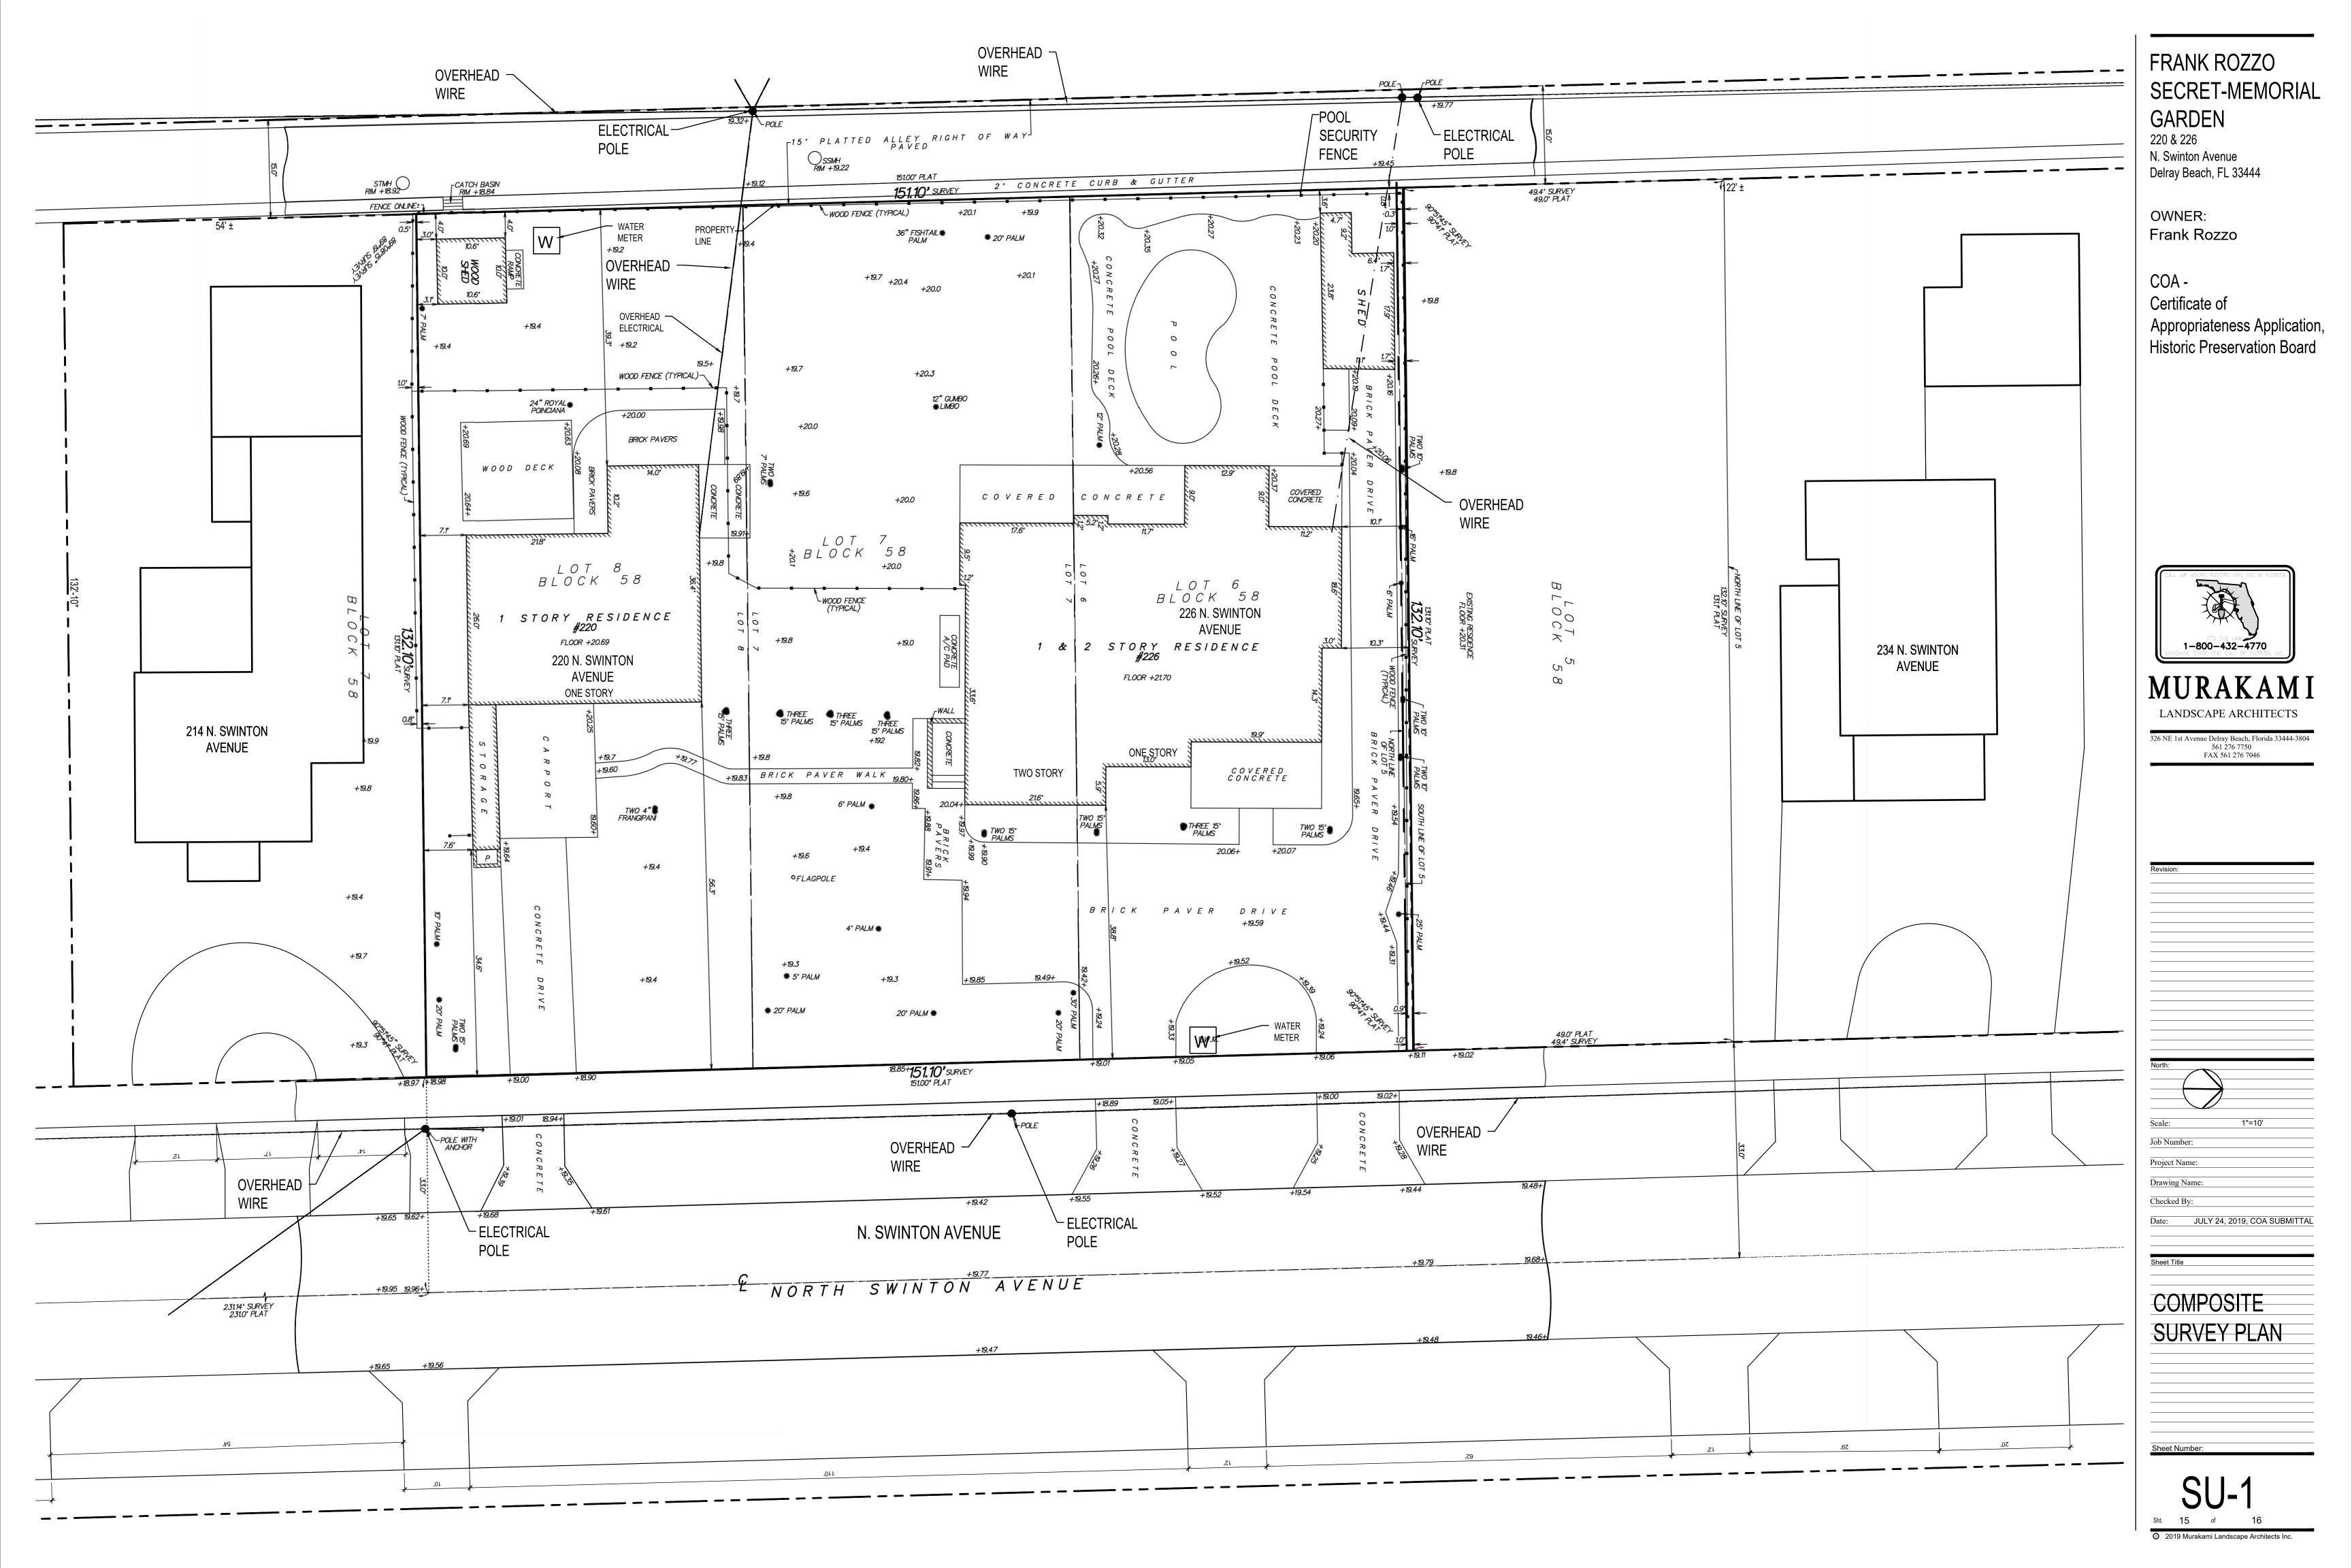

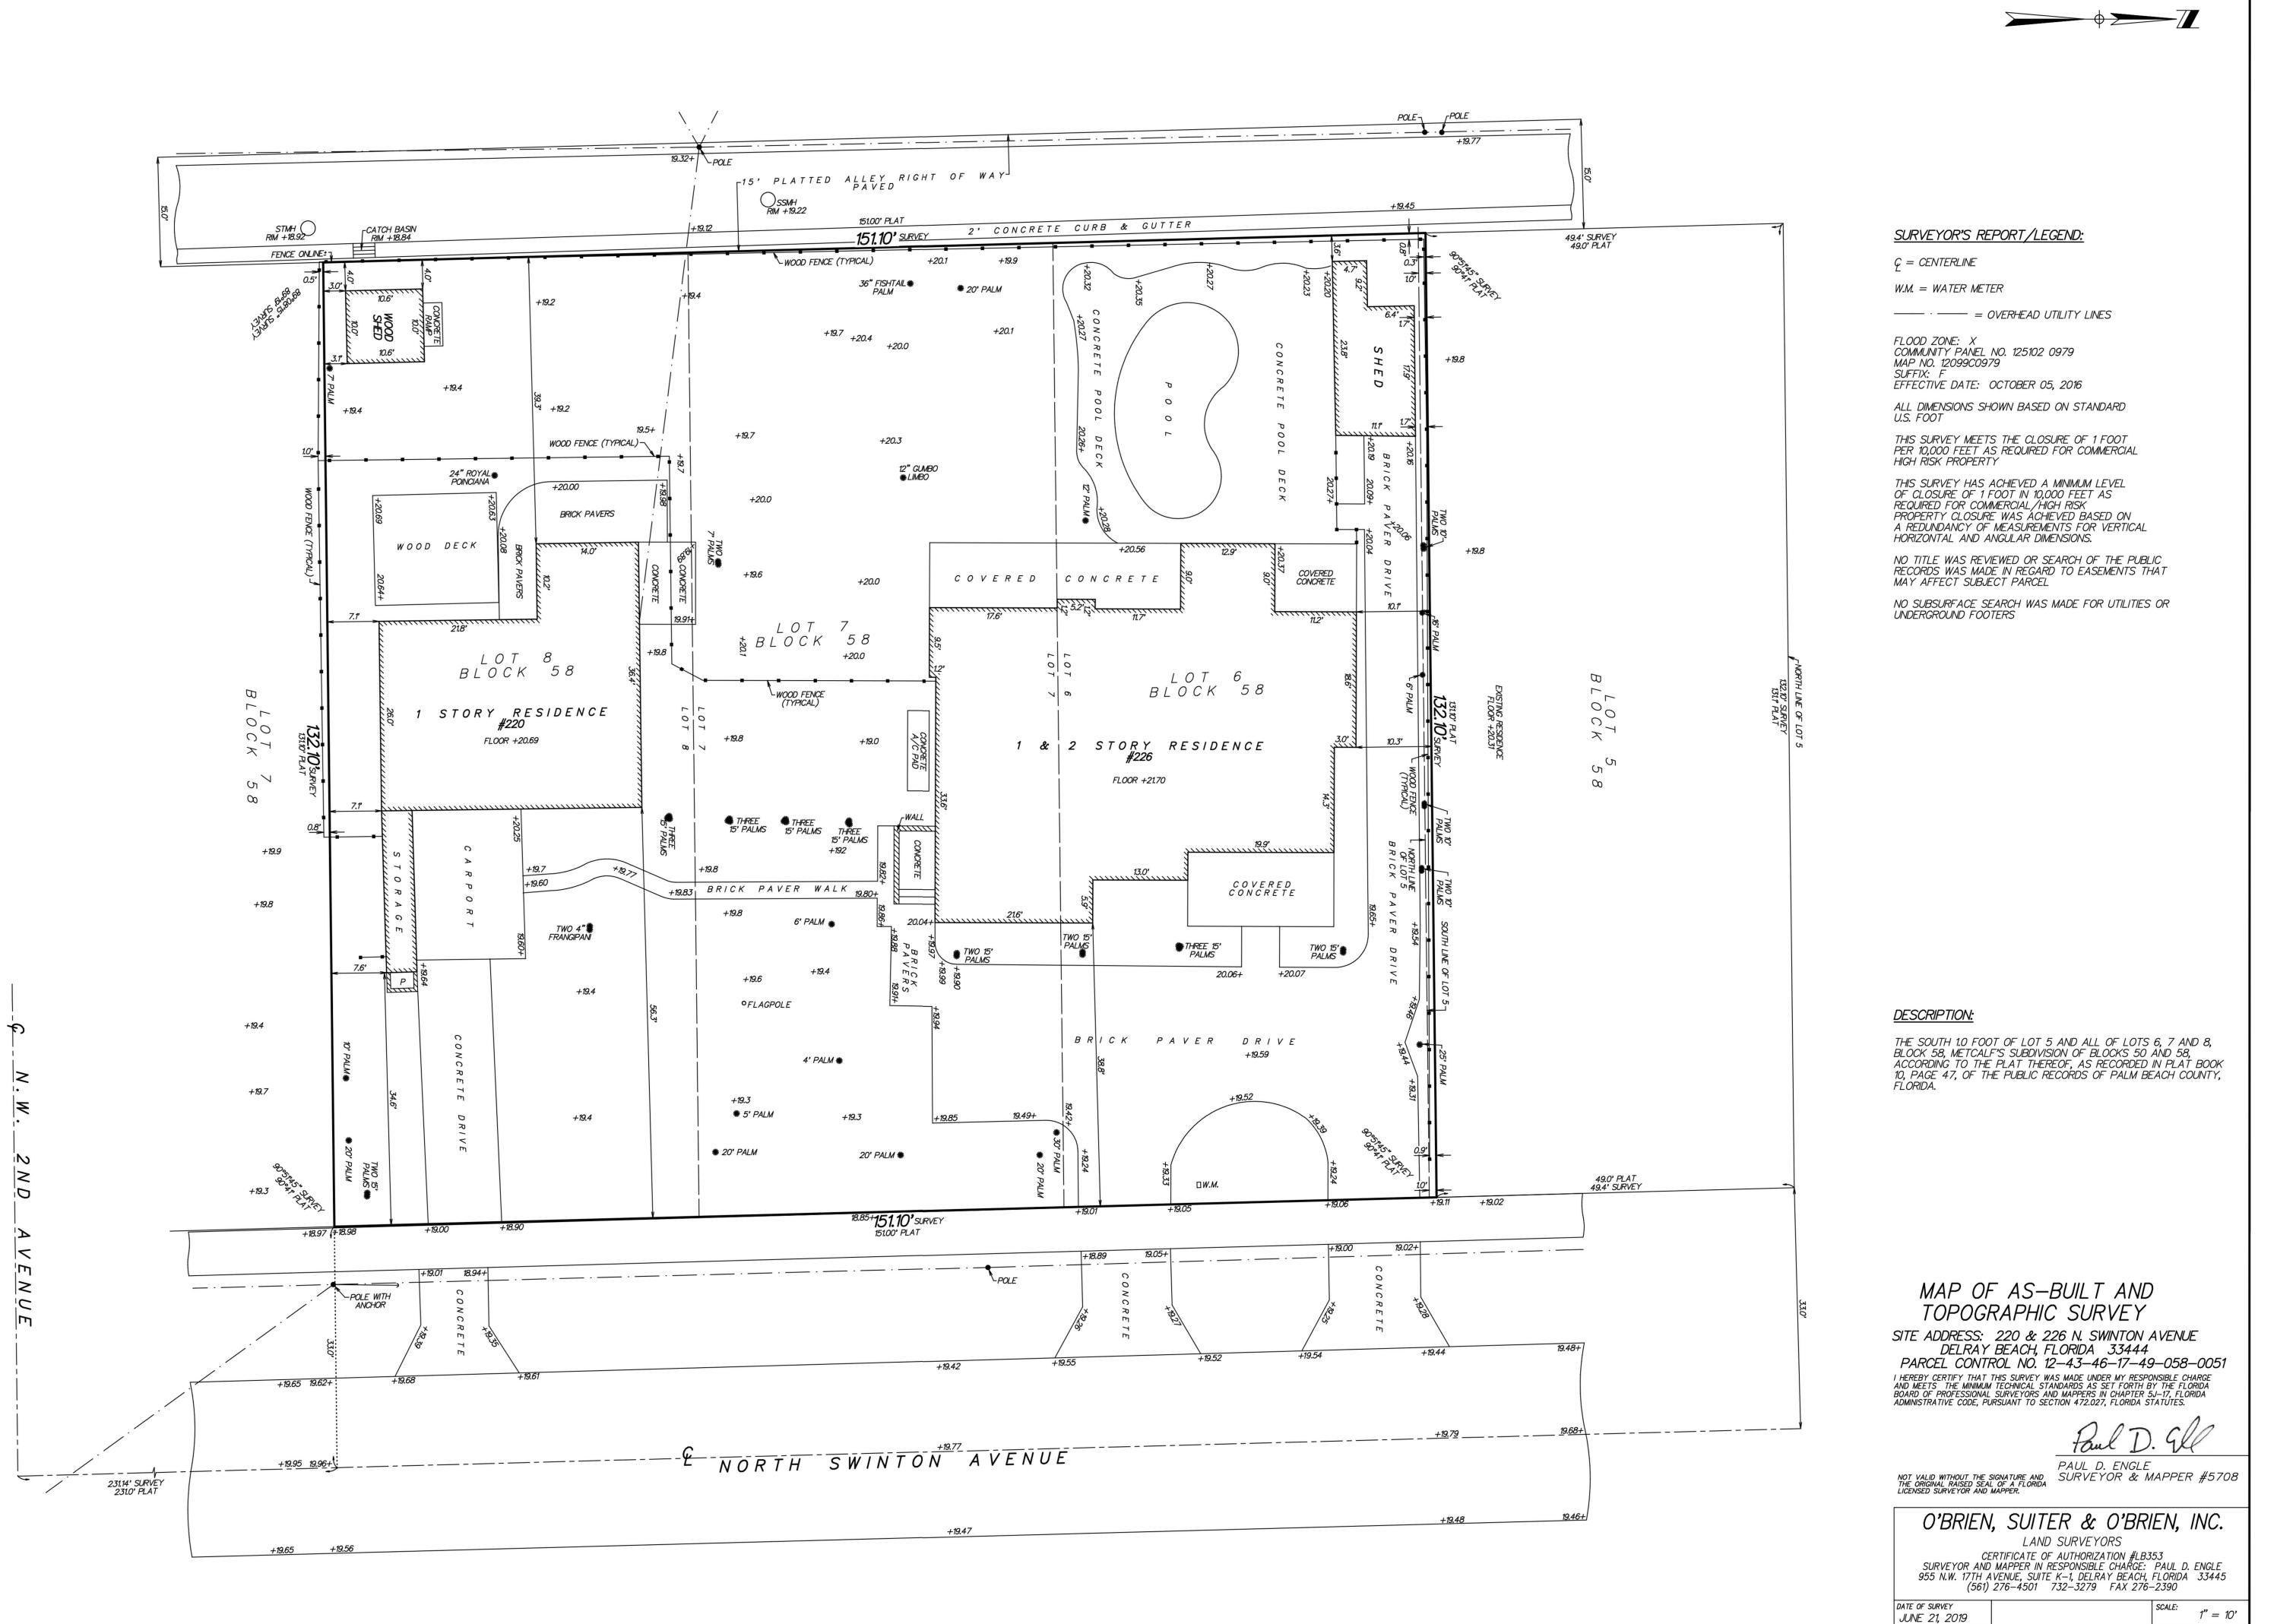

FRANK ROZZO SECRET-MEMORIAL GARDEN

220 & 226

N. Swinton Avenue

Delray Beach, FL 33444

OWNER: Frank Rozzo

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Historic Preservation Board



MURAKAMI

LANDSCAPE ARCHITECTS

326 NE 1st Avenue Delray Beach, Florida 33444-3804 561 276 7750 FAX 561 276 7046

ale: 1"=10'

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Drawing Name:

Project Name:

Checked By:

Date: JULY 24, 2019, COA SUBMITTA

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EXISTING TREES
& PALMS

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FIELD BOOK PAGE NO.

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EXHIBIT SHEET

Sht. 16 of 16

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