

Development Services Department

BOARD ACTION REPORT – APPEALABLE ITEM

Project Name: Banyan Court

Project Location: 13132 and 13038 Barwick Road & PCN 00424612000001050

Request: Master Development Plan Approval

Board: Planning & Zoning Board **Meeting Date:** October 21, 2019

Board Action:

At its October 21, 2019 meeting, the Planning & Zoning Board (PZB) considered a Master Development Plan (MDP) with three waivers for a 40-unit, zero lot line, single-family development and voted 7-0 to approve.

Project Description:

The Master Development Plan with waivers was submitted in conjunction with an annexation petition; Future Land Use Map (FLUM) amendment from Palm Beach County MR-5 to City of Delray Beach MD – Medium Density, 5-12 du / acre; and rezoning from Palm Beach County Agricultural Residential (AR) and Residential High (RH) to Planned Residential Development, 6 du / acre (PRD-6).

In 2017, the applicant filed an application with Palm Beach County to amend the land use designation from MR-5 to 8 du/acre. During the review process, it was determined by the Delray Beach City Manager, City Attorney, and City Development Services Director that the applicant should file a petition to annex into the City of Delray Beach. In 2018, the applicant filed a petition for annexation; future land use amendment to City MD - Medium Density, 5-12 du/acre; and rezoning to City RM-8 - Multiple-Family Residential to allow 53 townhomes. On October 15, 2018, the Planning and Zoning Board unanimously recommended approval of the annexation and FLUM amendment, and recommended approval of the rezoning (voting 4-2). However, the annexation petition and future land use petition were postponed prior to final action by the City Commission in December 2018, and the rezoning request (voted on as Ordinance 29-19) was withdrawn. The applicant resubmitted the rezoning request in early 2019 for rezoning to Planned Residential Development, 6 du / acre (PRD-6) to accommodate a 40-unit zero lot-line, single-family development. PRDs must be considered in conjunction with a Master Development Plan. The Board voted 7-0 on October 21, 2019 to approve the MDP with waivers, and voted 7-0 to recommend approval of the rezoning request.

The proposed Banyan Court development is bordered on the north by the LWDD L-30 Canal; to the east by Banyan Creek Elementary School; to the south by single family residences located in unincorporated Palm Beach County (the north side of Sabal Lakes Road); and to the west by Bexley Park, a Planned Residential Development (PRD) located within the City of Delray Beach; as well as a single family subdivision known as Golf Club Estates. The subject property encompasses three parcels: one single-family residence with two accessory structures is located on the northernmost parcel and the other two parcels are vacant.

Board Comments:

The Board expressed appreciation to the applicant for responding positively to board and community feedback about the rezoning request and development proposal initially presented to the board in October 2018.

Public Comments:

Members of the public spoke in support of the project.

Associated Actions:

The associated annexation petition, FLUM amendment, and rezoning request will be considered by City Commission at 1st reading on November 19, 2019 and at 2nd reading / adoption on January 14, 2020 (tentative).

Next Action:

The PZB action is final unless appealed by the City Commission.

PLANNING AND ZONING BOARD STAFF REPORT

Banyan Court (fka Banyan Cove) Rezoning

Meeting	File No.	Application Type
October 21, 2019	2018-162	Rezoning

Request


Provide a recommendation to the City Commission regarding the rezoning of three (3) parcels totaling 6.68± acres from Palm Beach County Agricultural Residential (AR) and Residential High (RH) to City of Delray Beach Planned Residential Development, 6 du / ac (PRD-6), and an associated Master Development Plan and waivers for Banyan Court (fka Banyan Cove).

Background Information

Banyan Court is a proposed single-family residential development on 6.68± acres bordered to the north by Canal LWDD L-30; to the east by the Banyan Creek Elementary School; to the south by single family residences located in unincorporated Palm Beach County


(the north side of Sabal Lakes Road); and to the west by Bexley Park, a Planned Residential Development (PRD) located within the City of Delray Beach; as well as a single family subdivision known as Golf Club Estates and a single family residence (located south of the L-30 Canal) all located within unincorporated Palm Beach County. The subject property encompasses three parcels: one single-family residence with two accessory structures is located on the northernmost parcel and the remaining two parcels are vacant.

The request for rezoning accompanies a petition for annexation and future land use map (FLUM) amendment. Several requests have previously been made to the City pertaining to the subject property. The history of petitions is outlined below.

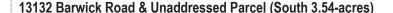

March 17, 1997: The Planning and Zoning Board considered requests for Annexation, Future Land Use Map amendment, and zoning of Medium Density

Residential (RM) and recommended that the requests be approved with an initial zoning of Medium Density Residential - 8 du/ac (RM-8). The petitions were withdrawn prior to final action by the City Commission.

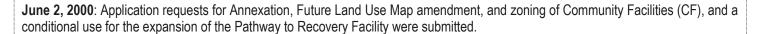

August 21, 2000: The Planning and Zoning Board recommended approval of the Annexation and Small-Scale Future Land Use Map amendment re-designating from Palm Beach County MR-5 to City CF, with a zoning designation of CF for Pathways to Recovery, Inc.

October 3, 2000: The City Commission denied the annexation, small-scale FLUM amendment, and rezoning request submitted on August 21, 2000. Subsequently, the buildings were demolished and the site has remained vacant.



13038 Barwick Road (North 3.13-acre Parcel)

March 19, 2012: The Planning and Zoning Board considered requests for Annexation, FLUM amendment re-designating from Palm Beach County MR-5 to City MD, and re-designating the zoning district from Palm Beach County AR to City Agricultural (A). The Board recommended approval to the City Commission of the requested petitions.

March 20, 2012: Palm Beach County Planning Department issued a letter of objection to the annexation contending that the proposed annexation would create an enclave. The application did not move forward to the City Commission.

June 8, 2012: A Water Service Agreement was approved to provide City water services for the property, for the use by the single-family residential structure.

13038 Barwick Road, 13132 Barwick Road & Unaddressed Parcel (All Parcels)

2017: The applicant filed an application with Palm Beach County to amend the land use designation from MR-5 to 8 du/acre. During the review process, it was determined by the Delray Beach City Manager, City Attorney, and City Development Services Director that the applicant should file a petition to annex into the City of Delray Beach. In 2018, the applicant filed a petition for annexation into the City, future land use amendment to City MD - Medium Density, 5-12 du/acre, and rezoning to City RM-8 - Multiple-Family Residential to allow 53 townhomes. The Planning and Zoning Board recommended approval of the annexation, FLUM amendment, and rezoning on October 15, 2018. However, the annexation petition and future land use petition were postponed prior to final action by the City Commission in December 2018, and the rezoning request (voted on as Ordinance 29-19) was withdrawn.

Review and Analysis

Rezoning

In accordance with LDR Section 2.4.5(C)(3) and Section 4.2.3, the subject request for rezoning is being considered in conjunction with the annexation request and FLUM amendment that the Planning and Zoning Board previously recommended approval of on October 15, 2018. The applicant has submitted a new rezoning request, to reflect feedback from City Boards, elected officials, and members of the public. The requested rezoning is to PRD-6 (no greater than 6 dwelling units per acre), with an associated Master Development Plan (which includes 3 waivers) for 40 zero-lot line single-family residences.

Pursuant to LDR Section 2.4.5(D)(1), the City Commission may amend the Official Zoning Map by ordinance after review and recommendation for approval by the Planning and Zoning Board. LDR Section 2.4.5(D) outlines the procedures for a zoning change, which includes the standard application items in LDR Section 2.4.3. In accordance with 2.4.3(E), a traffic study must be prepared to address the development of property under reasonable intensity pursuant to the existing and proposed zoning. Based on the traffic study (dated May 2, 2019) submitted by the applicant, the trips generated by the proposed 40 units would be 400 tpd, with 30 AM peak hour trips and 42 peak hour trips. The traffic study concludes that the estimated trips per day and AM / PM peak hour trips at project build-out in 2023 meets the requirements of Palm Beach County Traffic Performance Standards (TPS). The TPS approval letter from the Palm Beach County Traffic Division, dated July 18, 2019, confirms that the proposed development meets Palm Beach County Traffic Performance Standards.

Pursuant to LDR Section 2.4.5(D)(2), valid reasons for approving a change in zoning are:

- That the zoning had previously been changed, or was originally established, in error;
- That there has been a change in circumstance which makes the current zoning inappropriate;
- That the requested zoning is of similar intensity as allowed under the Future Land Use Map and that it is more appropriate for the property based upon circumstances particular to the site and/or neighborhood.

The application fulfills the last two criteria. The change of circumstance (annexation from Palm Beach County and land use map amendment) necessitates the adoption of City zoning. Concurrent with annexation, an initial zoning designation must be applied to the property consistent with the FLUM designation; Table L-6 in the Future Land Use Element considers the MD designation to be compatible with the PRD zoning district. The proposed zoning can be considered more appropriate to the surrounding neighborhoods than the existing AR and RH zoning designations because it allows a development intensity that is compatible with and similar to the existing

development. The surrounding uses are single family residential to the north; an elementary school to the east; single family residential to the south; and a mix of traditional single family, zero lot line single family, a multi-family triplex, and townhomes to the west.

Rezoning requests must meet five standards pursuant to **LDR Section 3.2.2**, which are described below as they relate to the proposed rezoning under consideration.

- (A) The most restrictive residential zoning district that is applicable given existing development patterns and typical lot sizes shall be applied to those areas identified as "stable" and "stabilization" on the Residential Neighborhood Categorization Map. Requests for rezonings to a different zoning designation, other than Community Facilities, Open Space, Open Space and Recreation, or Conservation shall be denied.
 - Because the subject property is located in unincorporated Palm Beach County, a category on the Residential Neighborhood Categorization Map has not been assigned. However, the City of Delray Beach neighborhoods adjacent to the subject property are categorized as Stable.
- (B) Rezoning to AC (Automotive Commercial) to accommodate auto dealerships shall not be permitted west of I-95.
 - Not applicable. This is a residential development.
- (C) Zoning changes that would result in strip commercial development shall be avoided. Where strip commercial developments or zoning currently exists along an arterial street, consideration should be given to increasing the depth of the commercial zoning in order to provide for better project design.
 - Not applicable. The proposed development is residential and does not have a commercial component.
- (D) That the rezoning shall result in allowing land uses which are deemed compatible with adjacent and nearby land use both existing and proposed; or that if an incompatibility may occur, that sufficient regulations exist to properly mitigate adverse impacts from the new use.

Under the proposed MD land use, PRD is a compatible zoning district. The PRD zoning district is characterized by "flexible densities in which multiple family and single family detached dwellings are designed together so as to: promote improved design, character, and quality of development; to preserve natural, scenic, and open space features of a site; and to accommodate flexibility in design." The existing uses and zoning surrounding the proposed development is as follows:

	Zoning Designation	Land Use	Use
North	LWDD L-30 Canal;	County-Low Residential, 3	Single family
	County-Single Family (RS)	units / acre (LR-3)	
South	County-Agricultural Residential (AR)	County- Medium Density Residential (MR-5)	Single family
East	City-Community Facilities (CF)	City-Community Facilities (CF)	Banyan Creek Elementary
West	County-Agricultural Residential (AR)	Low Density Residential (LD)	Golf Club Estates: single family Bexley Park: zero lot line, and townhomes

The proposed zoning is compatible with and similar to the surrounding residential development both in use and in development intensity. The Lake Worth Drainage District L-30 canal is located to the north of the development, which provides separation from the development to the north. Banyan Creek Elementary is located to the east, and a large portion of the site is retention / green space. Those applicable requirements to "properly mitigate adverse impacts from the new use" are reviewed with the Master Development Plan.

(E) Remaining, isolated infill lots within the coastal planning area shall be developed under zoning which is identical or similar to the zoning of adjacent properties; and, the resulting development shall be of a design and intensity which is similar to the adjacent development.

Not applicable. The proposed development is not within the coastal planning area.

LDR Section 4.4.7 - Planned Residential Development (PRD) District "provides a residential zoning district with flexible densities in which multiple family and single family detached dwellings" are allowed to "promote improved design, character, and quality of development; to preserve natural, scenic, and open space features of a site; and to accommodate flexibility in design." Single family conventional and zero lot line are allowed within the PRD district. Rezoning to PRD must be accompanied by a Master Development Plan (MDP). The applicant has submitted a MDP, along with a request for three waivers. Subsequent to approval of the MDP by the Planning and Zoning Board, the elevations must be approved by the Site Plan Review and Appearance Board (SPRAB). Development standards for the PRD are as follows:

a) At least 50 percent of the units must be in single family detached units where the overall density is six units per acre or less, or at least 40 percent where the overall density is greater than six units per acre;

The project is 100 percent single family detached units.

b) Fifteen percent of the gross area of the site must be placed in common open space where the overall density is six units per acre or less, or at least 20 percent where the overall density is greater than six units per acre;

The project has provided 32.8 percent open space.

c) Minimum site area is five acres.

The site is 6.68 acres.

Master Development Plan

LDR Section 2.4.5(F) provides the criteria for MDP approval. Generally, "the approving body must make a finding that development of the property pursuant to the site plan will be compatible and harmonious with adjacent and nearby properties and the City as a whole, so as not to cause substantial depreciation of property values." The MDP is subject to the provisions of LDR Section 3.2.3 (Standards for site plan and / or plat actions), as described below.

- (a) The development plan provides for an effective and unified treatment of the development potential of the site, making appropriate provisions for the preservation of scenic features and amenities of the site;
 - The proposed development provides circulation throughout the site with vehicle and pedestrian travelways. Three different home models are proposed by the applicant. Model A is 1,916 SF on a single-story. Models B and C are both two stories. Model B is 2,694 SF and Model C is 2,995 SF. The site layout preserves open space through the inclusion of four (4) green swales on the north west and south west borders of the property. A biological survey and a habitat analysis are not required based upon the existing conditions of the properties determined in a field assessment. However, the applicant is required to relocate and mitigate certain trees (relocation details are provided on the landscape plan).
- (b) The development plan fosters harmony with existing or proposed development in areas surrounding the site.
 - The surrounding existing developments provide a mix of community facilities, single-family homes, single-family zero lot line homes, triplexes, and townhomes. As a single-family zero lot line development, the proposed development is similar.
- (c) Buildings in the layout shall be an integral part of the development and have convenient access to and from adjacent uses and blocks;

- The development provides two points of ingress / egress on Barwick Road. There is also a linear park with a walking trail along Barwick Road, and a pedestrian arcade approximately midway between each driveway perpendicular to Barwick Road. This improves circulation and provides residents multiple options for mobility within the development and connection to the surrounding area.
- (d) In the multiple family portion, individual buildings shall be related to each other in design, masses, materials, placement, and connections so as to provide a visually and physically integrated development. Treatment of the sides and rear of buildings shall be comparable in amenity and appearance to the treatment given to the front.
 - Not applicable. The proposed development is a single-family development.
- **(e)** The landscape treatment for plazas, streets, paths, and service and parking areas shall be designed as an integral part of a coordinated landscape and street furniture design.
 - The linear path along Barwick Road has plantings along the pathway, as well as a row of plantings along the adjacent property line. The streets internal to the neighborhood have trees planted in front of each property, and the pedestrian entrance to the neighborhood is lined with a row of trees. Three of the four swale areas will have trees that have been relocated from other areas of the property; the fourth swale area includes many new trees, all identified in the landscape plan.
- (f) The location, shape, size, and character of the common open space must be suitable for the contemplated development in terms of density, population characteristics, and housing types;
 - **Section 4.4.7(F)(2)** requires that fifteen percent of the gross area of the site must be placed in common open space where the overall density is six units per acre or less. The development has provided 32.8% dispersed throughout the four large swale areas on the north west and south west sides of the property; two of the areas provide covered pavilions with benches and dog waste stations.
- (g) Common open space must be used for amenity or recreational purposes and must be suitably improved for its intended use. Natural features, worthy of preservation, shall be incorporated into the common open space system;
 - Several large trees are identified for relocation to swale areas on the landscape plan; two of the four swale areas include pavilions with benches, and dog waste stations.
- (h) Roads, pedestrian ways, and open space shall be designed as an integral part of the overall design and shall be properly related to buildings and appropriately landscaped;
 - There are two driveways that provide ingress and egress to the development from Barwick Road. An additional landscaped pedestrian pathway is located midway between the two entrances perpendicular to Barwick Road. The roads internal to the development have trees located at 40' intervals. The sidewalk runs through a landscaped linear park along the west property line along Barwick Road.
- (i) There shall be an adequate amount of pedestrian ways and landscape spaces to limit pedestrian use of vehicular ways, and to separate pedestrian ways and public transportation loading places from general vehicular circulation;
 - The applicant has provided 4' sidewalks internal to the development on both sides of the north-south road, and on both sides of the south roadway. There is a 5' sidewalk along the length of the property along Barwick Road, and a landscaped pedestrian arcade perpendicular to Barwick Road midway between the two entrances. A bus stop is located south of the development site along Barwick Road.
- (j) The location and design of pedestrian ways should emphasize desirable views of new and existing development.
 - The development provides multiple pedestrian pathways throughout the development that provide connectivity to the pedestrian network outside of the development. Additionally, all sidewalks are landscaped with trees at 40' intervals.

(k) Tot lots and recreational areas shall be a feature of all new housing developments which utilize PRD zone districts. (OSR A-3.3)

The applicant has provided two pavilions with dog waste stations and benches in two of the four green swale areas.

Waivers

The applicant has requested the following:

Waiver	Code Section	Required	Proposed	Request
Waiver 1	Zero Lot Line Side Setbacks	0/15'	0/10'	5' Reduction
	Section 4.3.4(H)(3)(a)			
Waiver 2	Minimum Lot Width/Frontage for Zero	60'	40'	20' Reduction
	Lot Line PRD Corner Lots			
	Section 4.3.4(k)			
Waiver 3	Sidewalk Width	5'	4'	1' Reduction
	Section 6.1.3(B)(1)(b)		(Internal)	

Pursuant to **LDR Section 2.4.7(B)(5)**, **Waivers: Findings**, prior to granting a waiver, the granting body shall make findings that the granting of the waiver:

a) Shall not adversely affect the neighboring area;

The requested waivers, to reduce the zero lot line side setbacks from 15' to 10', the minimum lot width and frontage from 60' to 40', and the sidewalk width from 5' to 4', are internal to the project and should have no direct effect on the neighboring area because they are internal to the neighborhood and do not face adjacent neighborhoods.

b) Shall not significantly diminish the provision of public facilities;

The requested waivers to reduce the minimum lot frontage and width and side setbacks relate to the site plan layout and do not impact public facilities, including the provision of water and sewer and access by emergency responders. The requested sidewalk width waiver relates to public facilities and required access. However, granting of the waiver will not negatively impact the public facility as the driveways function as the required passing area at 200-foot intervals, and is compliant with the Americans With Disabilities Act by meeting the slope requirements.

c) Shall not create an unsafe situation:

Waiver 1 allows sufficient space between the homes within the development for air circulation and landscaping. The reduction of corner lots in Waiver 2 provides sufficient and safe separation from roadways because of the parking spaces provided between the property lines along the street. The reduced sidewalk widths in Waiver 3 is compliant with the Americans with Disabilities Act and allows safe mobility for wheelchair users.

d) Does not result in the grant of a special privilege in that the same waiver would be granted under similar circumstances on other property for another applicant or owner.

The requested waivers could be granted in a similar circumstance for another applicant if they do not create any unsafe conditions, diminish public facilities, or adversely impact adjacent developments.

The applicant's waiver request and justification statement is attached.

Outstanding Technical Requirements

The following items are outstanding technical items that must be addressed prior to site plan certification of the Master Development Plan:

- The applicant must create easements for the water and sewer mains by separate instrument based on as-built locations, not on the plat. The City does not want the roadway ownership to be able to be confused with utility easements. Prior to Site Plan Certification show the proposed easements on the plans.
- The photometric plans show items labelled SD MH: 4 and SD MH: 1 out in the Right-of-Way of Barwick Road but these items are not identified as to what they are. There are details for a bollard light and a pole mounted light neither of which are acceptable to be placed in Barwick Road Right-of-Way although they are perfectly acceptable within the private roads/common areas. The City will require use of the City Standard light pole in Barwick Road Right-of-Way. This must be accomplished prior to Site Plan Certification.
- The minimum width for sidewalks per ADA is 5'. The driveways can be used as the required 60" x 60" wheelchair passing area every 200 feet. However, the driveway grades must accommodate the ADA required slope.
- As a new residential development greater than 25 units, the applicant must provide 100% of the cost of the purchase and installation of a bus shelter (\$11,000) per City of Delray Beach Comprehensive Plan, Policy A-1.5 and LDR Section 2.4.3 (D) (7) that at the time of building permit.

Review By Others

The subject property is not within a redevelopment area or overlay.

The **City Commission** is anticipated to review Ordinance No. 38-19 (Rezoning), Ordinance No. 37-19 (Future Land Use Map amendment), and Ordinance 27-18 (Annexation) at its meetings on November 19, 2019 (First Reading) and January 14, 2020 (Second Reading, Final Adoption).

Board Action Options

Separate motions must be made for the rezoning request and the master development plan with waivers. Options for board actions for each item are provided below.

Rezoning


- A. Recommend approval of Ordinance No. 38-19, a privately-initiated request to rezone 6.68± acres from Palm Beach County Agricultural Residential (AR) and Residential High (RH) to City Planned Residential Development, 6 du/acre (PRD-6), finding that the rezoning and approval thereof is consistent with the Comprehensive Plan and meets the criteria set forth in the Land Development Regulations.
- B. Recommend **denial** of Ordinance No. 38-19, a privately-initiated request to rezone 6.68± acres from Palm Beach County Agricultural Residential (AR) and Residential High (RH) to City Planned Residential Development, 6 du/acre (PRD-6), finding that the rezoning and approval thereof is not consistent with the Comprehensive Plan and does not meet the criteria set forth in the Land Development Regulations.
- C. Continue With Direction


Master Development Plan and Waivers


- A. Recommend **approval** of the Banyan Court Master Development Plan for 40 zero lot line single family lots; with a waiver from LDR Section 4.3.4(H)(3)(a) to allow a reduction from the required 15 foot setback to 10 feet, a waiver from LDR Section 4.3.4(k) to reduce the required frontage for corner lots from 60 feet to 40 feet, and a waiver from LDR Section 6.1.3(B)(1)(b) to reduce the width of internal sidewalks from 5 feet to four feet; finding that the approval thereof is consistent with the Comprehensive Plan and meets the criteria set forth in the Land Development Regulations.
- B. Recommend **approval**, **as amended**, of the Banyan Court Master Development Plan for 40 zero lot line single family lots; with a waiver from LDR Section 4.3.4(H)(3)(a) to allow a reduction from the required 15 foot setback to 10 feet, a waiver from LDR Section


- 4.3.4(k) to reduce the required frontage for corner lots from 60 feet to 40 feet, and a waiver from LDR Section 6.1.3(B)(1)(b) to reduce the width of internal sidewalks from 5 feet to four feet; finding that the approval thereof is consistent with the Comprehensive Plan and meets the criteria set forth in the Land Development Regulations.
- C. Recommend **denial** of the Banyan Court Master Development Plan for 40 zero lot line single family lots; with a waiver from LDR Section 4.3.4(H)(3)(a) to allow a reduction from the required 15 foot setback to 10 feet, a waiver from LDR Section 4.3.4(k) to reduce the required frontage for corner lots from 60 feet to 40 feet, and a waiver from LDR Section 6.1.3(B)(1)(b) to reduce the width of internal sidewalks from 5 feet to four feet; finding that the approval thereof is not consistent with the Comprehensive Plan and does not meet the criteria set forth in the Land Development Regulations.
- D. Continue With Direction


Public and Courtesy Notices					
\underline{X} Courtesy Notices are not applicable to this request.	Public Notices are not required for this request.				
	X Public Notice was posted at the property 7 calendar days prior to the meeting.				
	X Public Notice was mailed to property owners within a 500' radius 10 days prior to the meeting.				
	Public Notice was mailed to the adjacent property owners 20 days prior to the meeting.				
	X Public Notice was published in the Sun Sentinel October 11, 2019, 10 calendar days prior to the meeting.				
	X Public Notice was posted to the City's website 10 calendar days prior to the meeting.				
	X Public Notice was posted in the main lobby at City Hall 10 working days prior to the meeting.				
	X Agenda was posted at least 5 working days prior to meeting.				

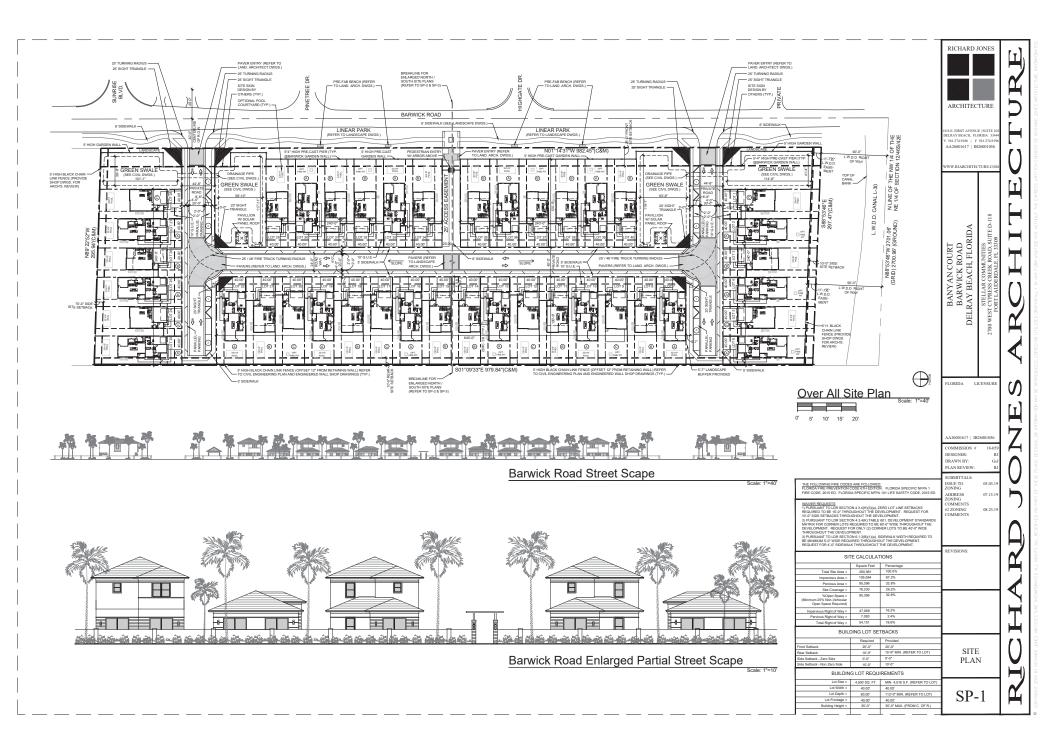

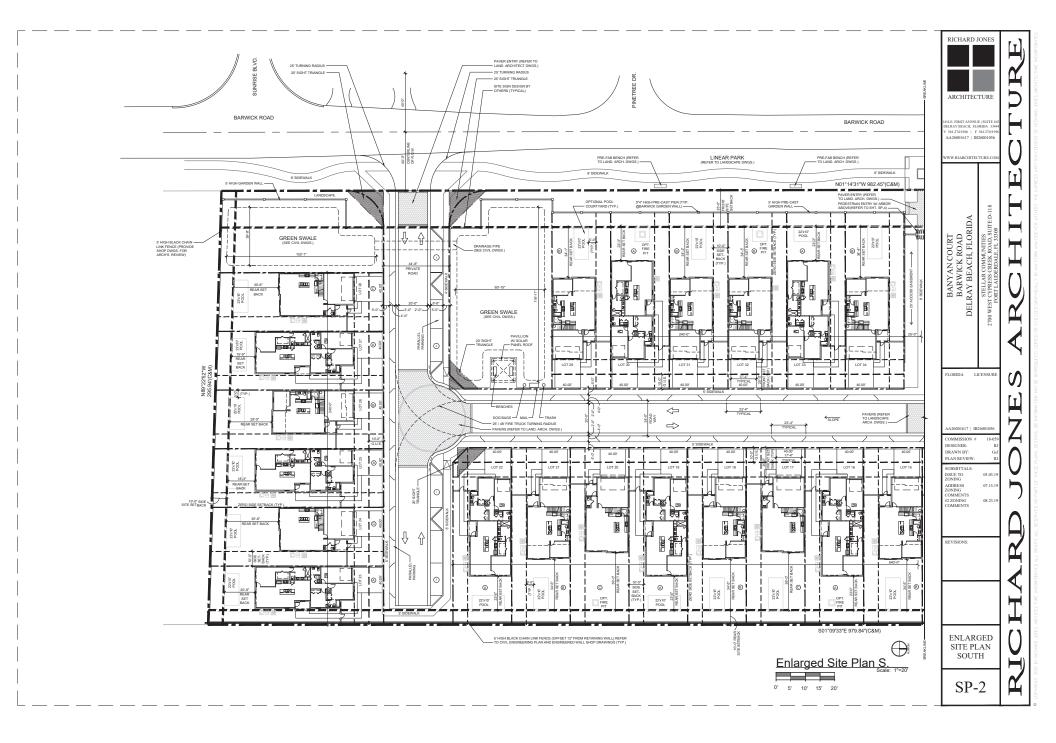

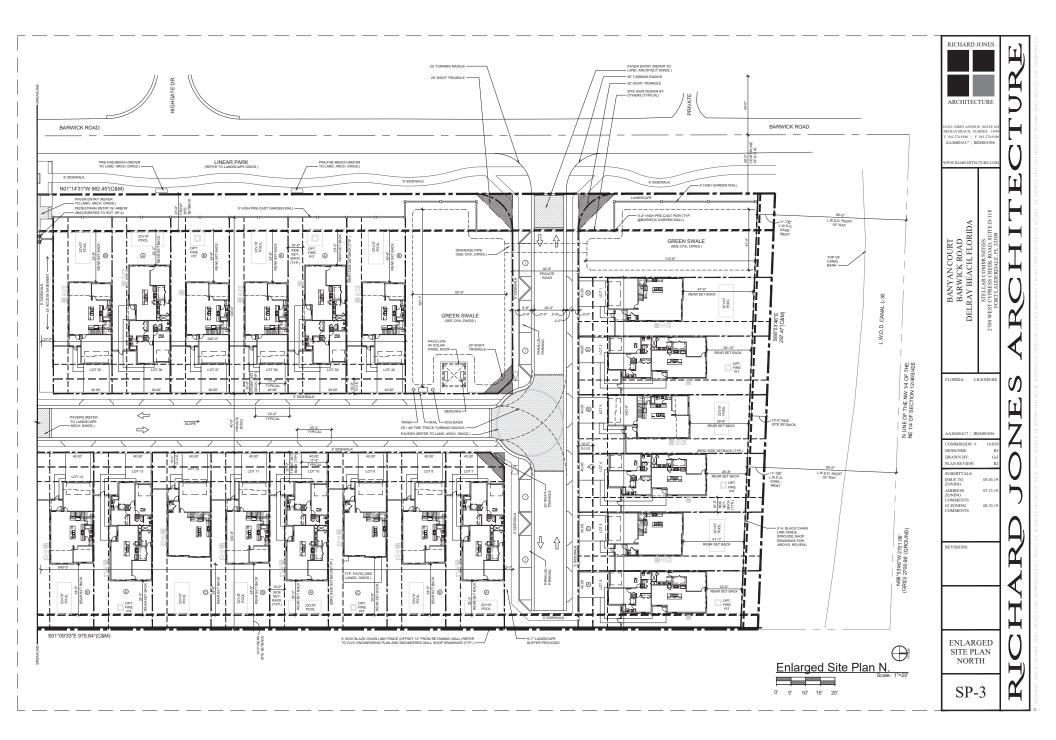

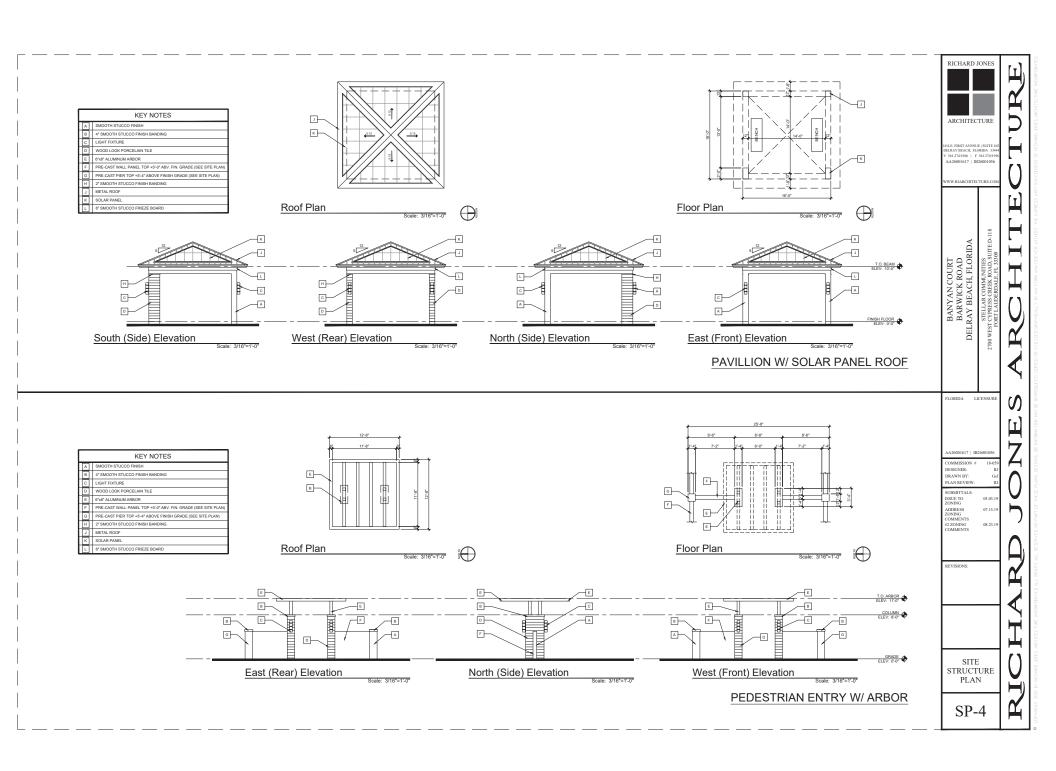


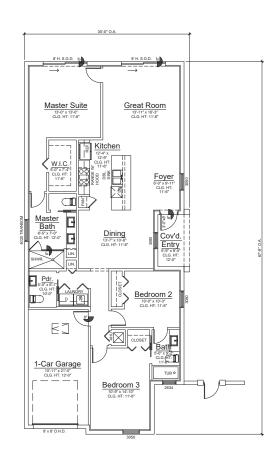



Floor Plan

Scale: 3/16"=1'-0"

TOTAL AREA

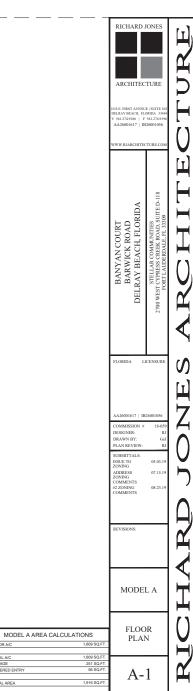


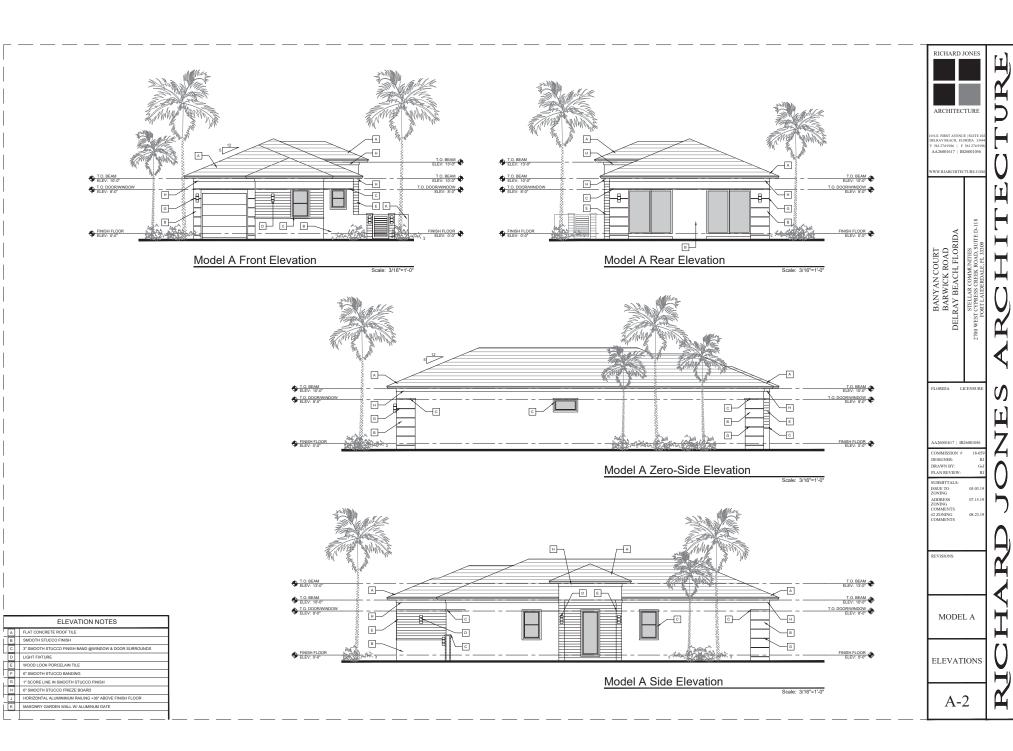

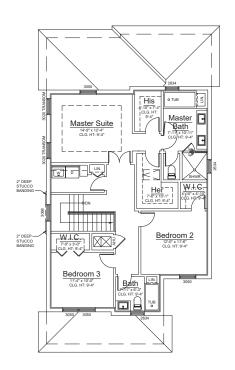

Second Floor Plan

Scale: 3/16"=1'-0"

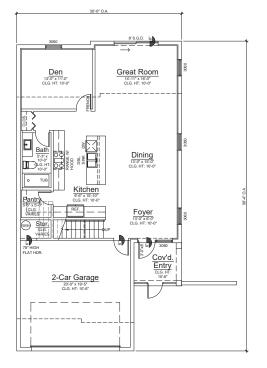

Ground Floor Plan

Scale: 3/16"=1'-0"

	ARCHITECTURE 10 S.E. FIRST AVENUE (SUITE 100 DELEAY BEACLE, FLORIDA 33444 V 5012749186 F 501274990 AAA26001617 IB226001056 WWW.RARCHITECTURE.COM						
	BANYAN COURT BARWICK ROAD DELRAY BEACH, FLORIDA	STELLAR COMMUNITIES 2700 WEST CYPRESS CREEK ROAD, SUITE D-118 FORT LAUDERDALE, FL 33309					
	FLORIDA LI AA26001617 IB: COMMISSION # DESIGNER: DRAWN BY: PLAN REVIEW:	26001056 18-059 RJ GsJ RJ					
	SUBMITTALS: ISSUE TO ZONENG ADDRESS ZONING COMMENTS #2 ZONING COMMENTS REVISIONS:	05.03.19 07.15.19 08.23.19					
	MODE	L B					
FT.	FLOO PLAN	R IS					


RICHARD JONES

 MODEL B AREA CALCULATIONS

 GROUND FLOOR AIC
 1,082 SQ.FT.


 SECOND FLOOR AC
 1,116 SQ.FT.

2.198 SO.FT. 428 SO.FT. 68 SO.FT. A-3

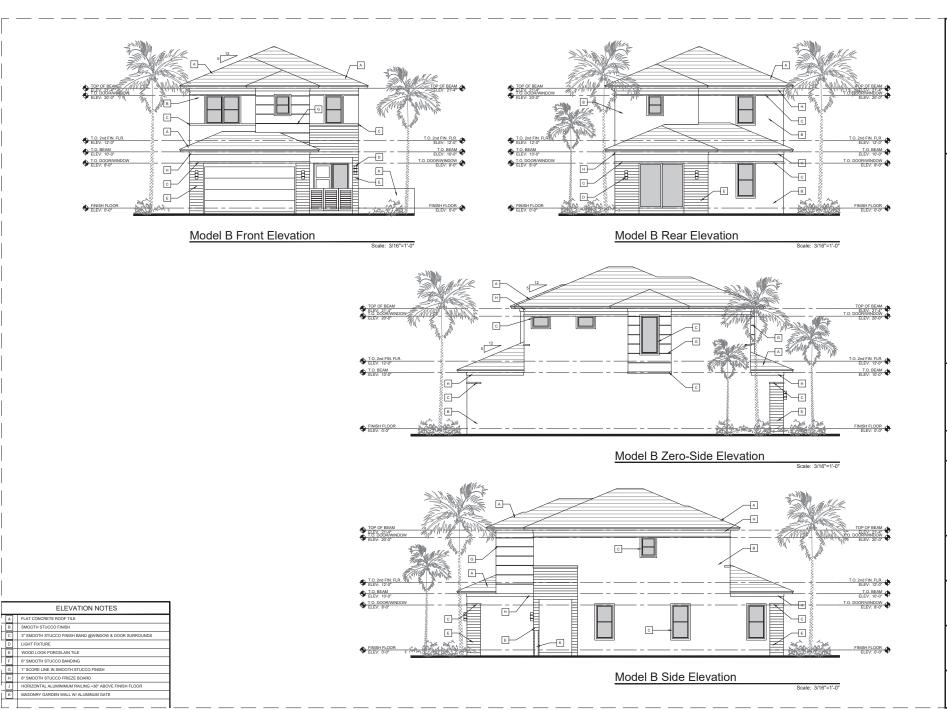

LIGHT FIXTURE

RICHARD JONES ARCHITECTURE 10 S.E. FIRST AVENUE | SUITE 10 DELRAY BEACH, FLORIDA 334 V 561.274.9186 | F 561.274.919 AA26001617 | IB26001056 Π BANYAN COURT BARWICK ROAD DELRAY BEACH, FLORIDA FLORIDA LICENSURI 山 COMMISSION # DRAWN BY: SUBMITTALS: ISSUE TO ZONING ADDRESS ZONING COMMENTS #2 ZONING COMMENTS MODEL B ELEVATIONS A-4

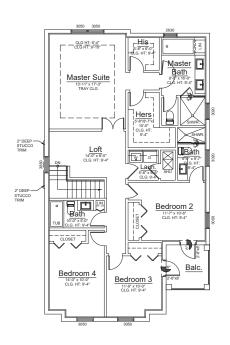

Second Floor Plan

Dining

OCA III. 1999

CA IIII

Ground Floor Plan


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	ARCHITEC 10 S.E. FRST AVENU DELRAY BEACH, FL V 5612749186 F AA26001617 IB	TURE E SUITE 102 RIDA 33444 561.274,9196 26001056	CTITEE
	BANYAN COURT BARWICK ROAD DELRAY BEACH, FLORIDA	STELLAR COMMUNITIES 2700 WEST CYPRESS CREEK ROAD, SUITE D-118 FORT LAUDERDALE, FL 33309	ATIHOAA
		26001056 18-059 RJ GsJ RJ 05.03.19 08.23.19	SANCI
	REVISIONS:	LC	HAPP.

FLOOR PLANS


A-5

MODEL C AREA CA	LCULATIONS
GROUND FLOOR A/C	992 SQ.FT.
SECOND FLOOR A/C	1,422 SQ.FT.
TOTAL A/C	2,414 SQ.FT.
GARAGE	451 SQ.FT.
COVERED ENTRY	65 SQ.FT.
BALCONY	65 SQ.FT.

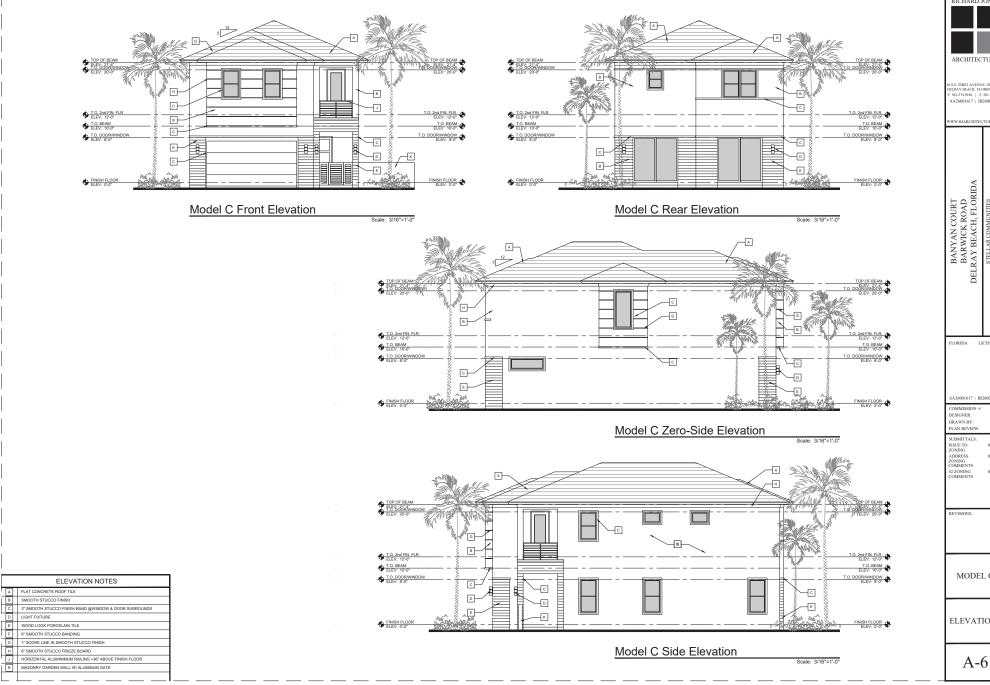

RICHARD JONES ARCHITECTURE 10 S.E. FIRST AVENUE | SUITE 10 DELRAY BEACH, FLORIDA 3344 V 561.274.9186 | F 561.274.919 AA26001617 | IB26001056 Щ BANYAN COURT BARWICK ROAD DELRAY BEACH, FLORIDA FLORIDA LICENSURI 山 COMMISSION # DRAWN BY: SUBMITTALS: ISSUE TO ZONING ADDRESS ZONING COMMENTS #2 ZONING COMMENTS MODEL C ELEVATIONS



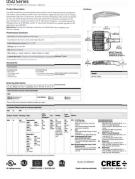

Light Head Detail





Ballard Detail
Scale: N.T.S

Conc. Light Pole Detail

Photometric Plan
Scale: 1"=40"

RICHARD JONES

ARCHITECTURE

S.E. FIRST AVENUE | SUITE 102 LRAY BEACH, FLORIDA 33444

A26001617 | IB26001056

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WW.RJARCHITECTURE.C

BANYAN COURT
BARWICK ROAD
DELRAY BEACH, FLORIDA
STELLAR COMMUNITIES
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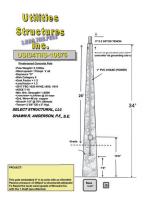
COMMISSION # 18-059
DESIGNER: R:
DRAWN BY: Gs:
PLAN REVIEW: R:
SUBMITTALS:

SUBMITTALS:
ISSUE TO 05.03.19
ZONING 05.03.19
ZONING COMMENTS
#2 ZONING 08.23.19
COMMENTS


VISIONS:

PHOTO-METRIC PLAN

PH-1



Conc. Light Pole Detail

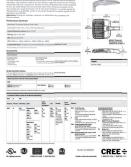





Light Head Detail

Ballard Detail



Photometric Plan
Scale: 1"=40"

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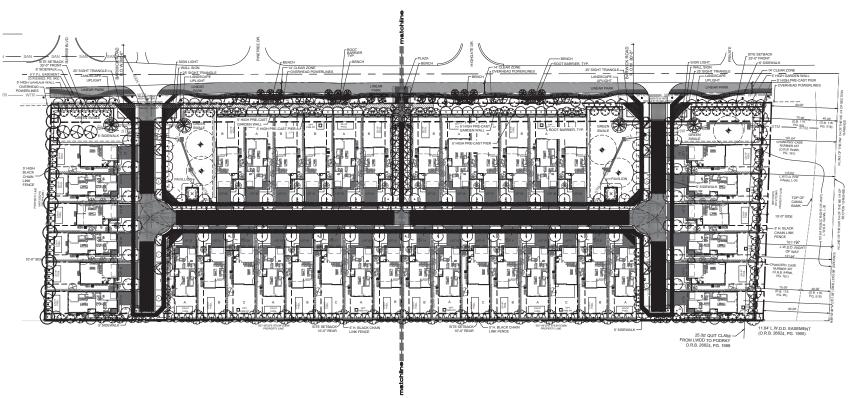
BANYAN COURT BARWICK ROAD DELRAY BEACH, FLORIDA

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DRAWN BY: PLAN REVIEW: SUBMITTALS: ISSUE TO ZONING ADDRESS ZONING COMMENTS #2 ZONING COMMENTS

PHOTO-METRIC PLAN

PH-1





dave bodker

banyan court

601 n. congress ave., suite 105-a delray beach, florida 33445 561-276-6311 #LA0000999

sheet title:

overall planting plan

date: scale: drawn by:

LOBBY BENCH


LODBY BENUE:
Manufacturer: Doly & Sons
Manufacturer: Doly & Sons
Detai: 72, 402bs
Concrete legs to have S86 finish (sandblast)
Seat to be 4 boards recycled plastic lumber (color is Gray RPL3)
Mount to concrete pads with anchor this item no. AK1010 (2 per lobby bench)




LITTER RECEPTACLES LITTER RECEPTACLES
Manufacture: Doly & Sons
Item No. LR3500
Detail: 16" square x 34.5" height
Standard sandblast finish (SB6)
Mount to concrete pads with anchor kits item no. AK1065 (1 per litter receptacle)



DOG BAG DISPENSER Manufacturer: Dog Waste Depot with ONEpul Bag System Depot-022-B Round Waste Can with lid Black powder coated

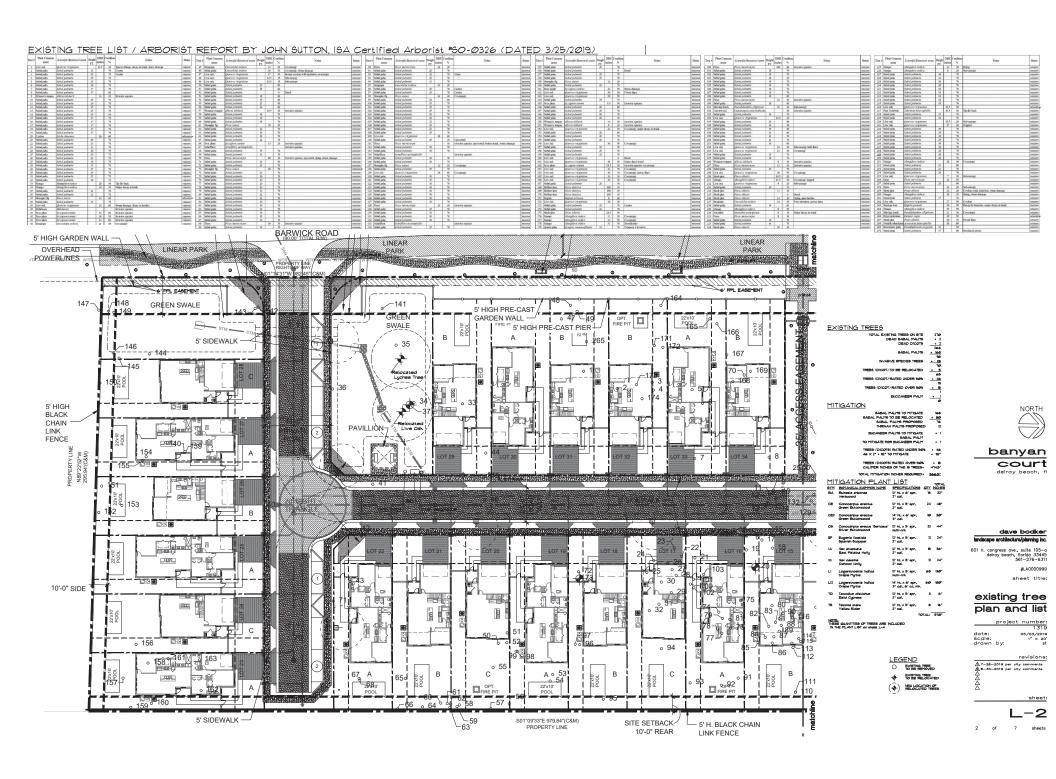

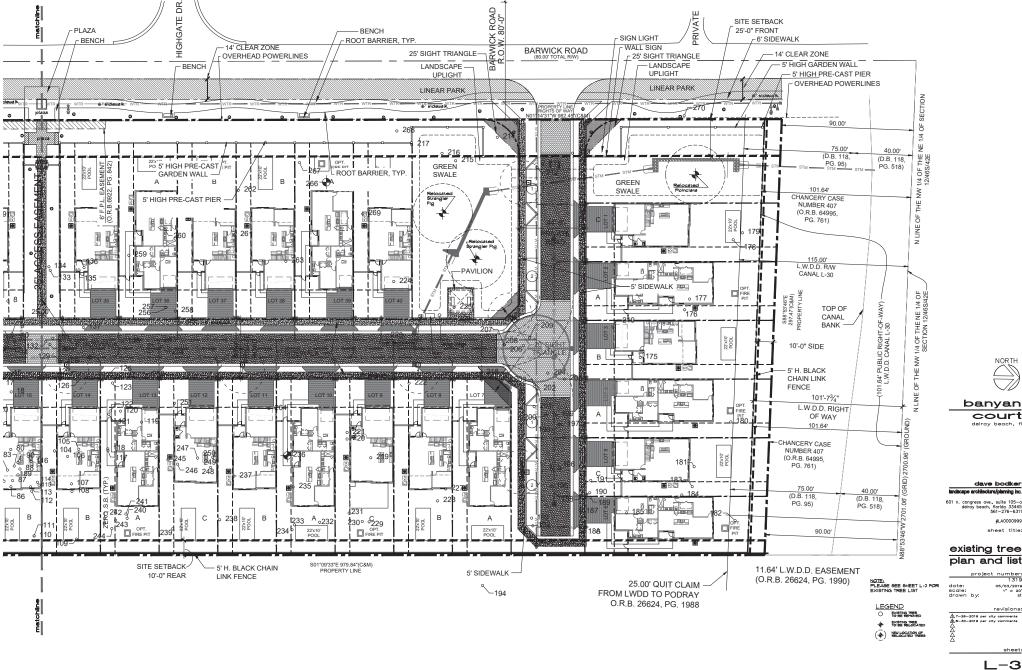

banyan court


dave bodker


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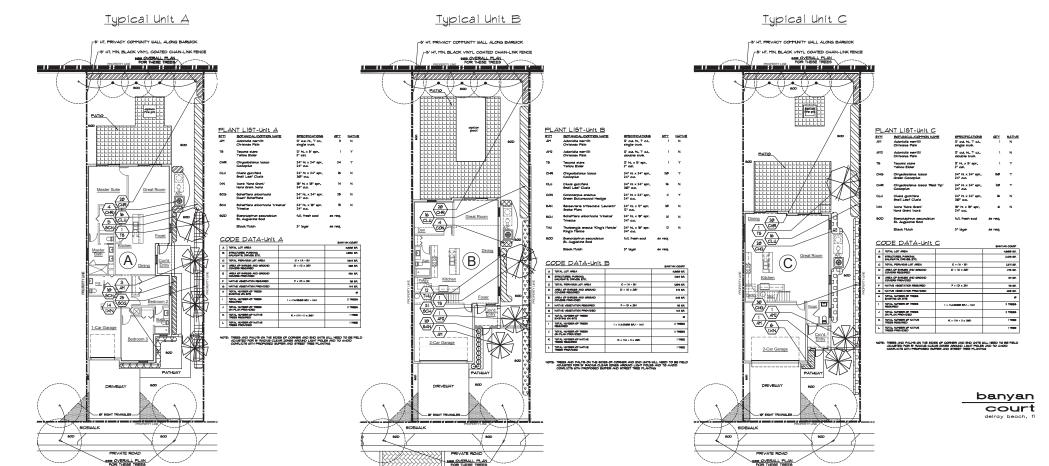
existing tree plan and list

A 7-26-2019 per city comments A 8-30-2019 per city comments

L-3



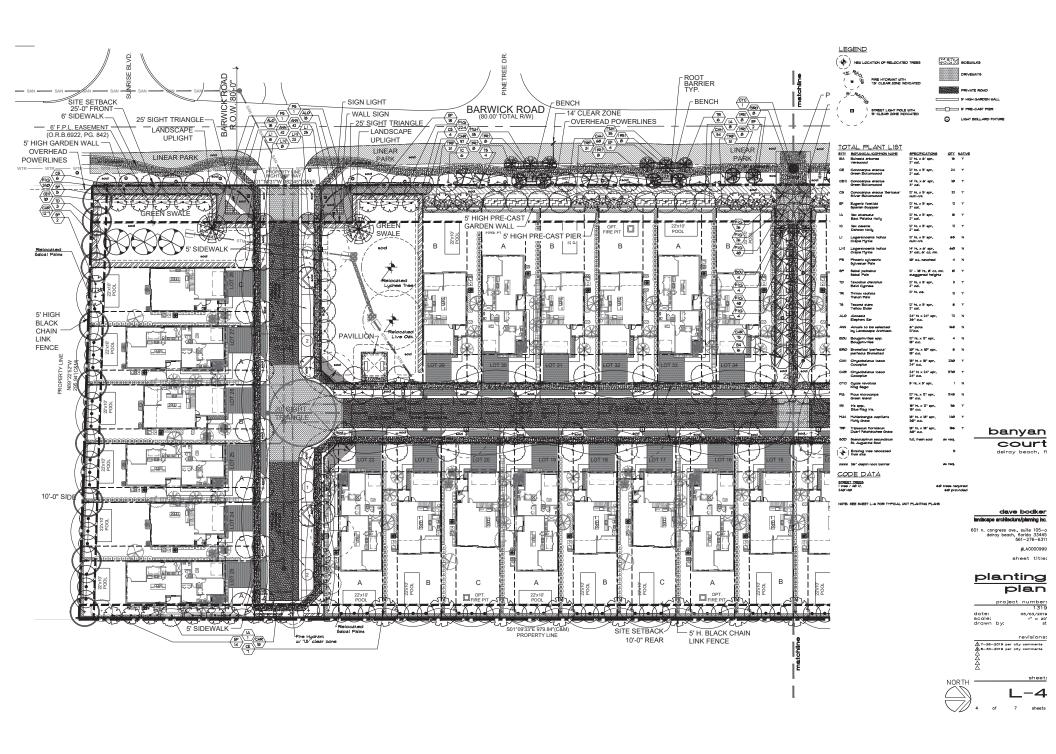


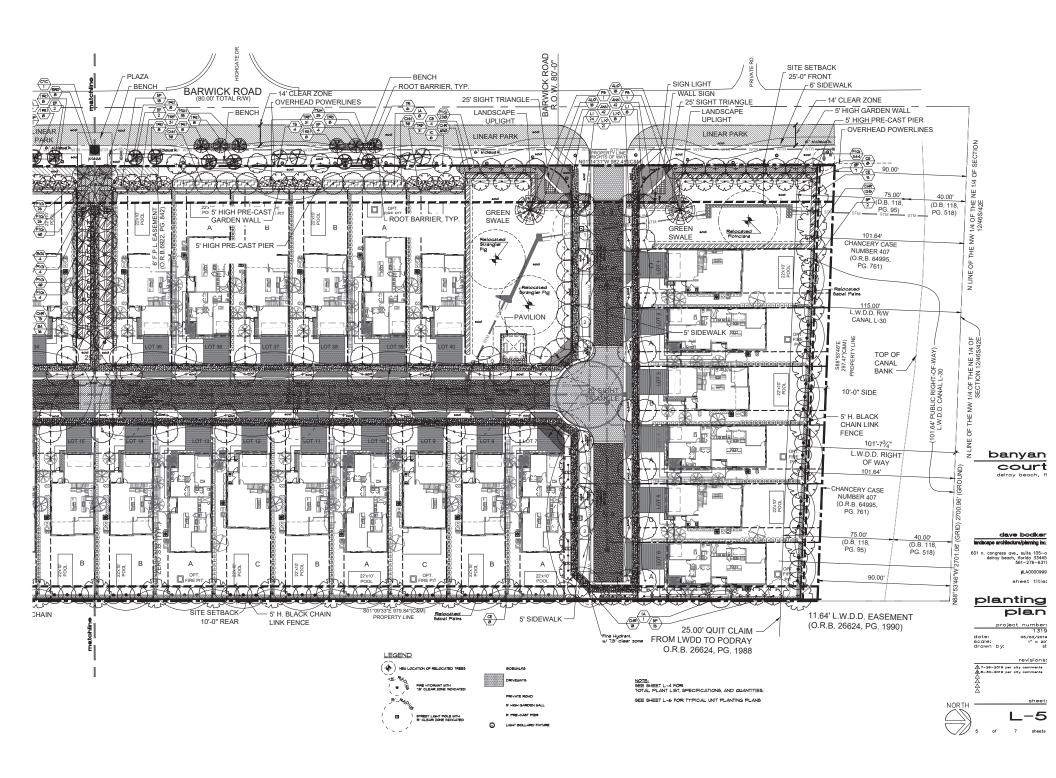



TYPICAL TREE WITH ROOT BARRIER LD 1.1

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dave bodker

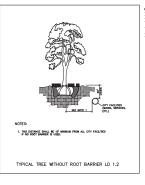 n. congress ave., suite 105-a delray beach, florida 33445 561-276-6311
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typical units planting plan

project numbe

131

date: 05/03/20
scole: 1° = 1
drawn by:

revision

\$\Delta 7 - 28 - 2019 per city comments

↑7-26-2019 per city comments
↑8-30-2019 per city comments
↑
↑
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L-6

6 of 7 sheets

P. Ten percent (18%) of the total contract price will be held as receiver for 90 days after final united acceptance.

The Landscape Contractor all coordinate Hs work with all other trades at the job elle.

Palms with mechanical damage, such as from catoles, chairs, explorent and raffs, shall be rejected.

1 - 15° 15 - 175° 15 - 27° 2 - 25° 25 - 35° 35 - 4° 4 - 45° 4 - 5° 5 - 16° 5 - 16°

(3) Root pruring shall be accomplished by oligging a trench completely around the plant about 10 hohes cloop, All exposed notice shall be out off smoothly.

A minute of good organic familizer and planting sof shall be used to rafill the trench.

Politicle, from mulcipal unior appriles or other sources with are approved by a public health department.

Nou and existing Strains, and dinoundesiven
 Pertition with 8-2-12 pale fertition with interceptations at a sale of in its per MSGO SF of area.

C. Anuals-Pertition with Ownerson - Stems bland H-H-H or approved equal.

(1) Movement of namery stock shall comply with all Recieral, States, and local laws, regulations, andhonous, codes, etc. (3) Protect during delivery to prevent desage to not bell or destocation of between. Remove unacceptable plant reservish trendisting from the jobs site. Herstein and protect with stored at the site.

The Contractor is responsible for the entire project prior to written acceptance.

If requested by the Ower or Landscape Architect, eathful a sample and analysis of all planting soil types for approval and analysis of all planting the natural is delivered.

easple and analysis of all planting soft types for approval by the Landiseppe Architect before the reterral to delivered and installed on the project.

asples and analysis of the rude for approval by the Landiseppe Architect, somit a landiseppe Architect, somit a

Buths three prists of shop drawing for all stabling and guiging methods to the used if the ones industries in these specifications and on the Plates are not to be implemented, salting and applies enthods before they are implemented in the The Landscape Architect all approve all they drawings of

K. Babels in unting any hindrance to the tinely completion of the testalistics. L. Submit and Certificate of Impaction of plant material as may be required by State , local or Pederal Authorities.

Aborations. As the re-operation prior, designation (1848, 1848, Co exact, upon grote, earling this querie; set of a standard to real to the laboration of the re-operation of the re-opera

(b) Edge and used 48 simbs, groundcover and flower bads once a seek.

a) Spraging and Dusting Contractor shall do all associations graphs and/or dusting of all planting, as needed, for complete contract of press and diseases. The interfals and methods shall be in accordance with the highest sharkful the highest precisions and are recommended by the County Agent, and approving lay the Landscapes Advistors, prior to Implementation.

(D) Processory or Year nearest shall be processed against temposing and cleaning. If any plants become cleanings and cleanings. If any plants become cleanings or righned, they shall be treased or explaced as and righned, they shall be treased or explaced as and additional costs. No use, which be done within or over planting areas or adjacem so plants which proper saftigated and processors.

(1) Keep aldesalts, curbs and gutters, chivesalps, parking areas, streams, sensors, decks, and powers free of plant cuttings, district and states.

D. Hitter's repeated during the course of communities shall be removed within 3 working days and replaced before an impossion for completion will as advantaged.

P. Mapticement. Replacement of plan extents shall be the respondeding of the Contractor facilities by possible replacement of plan enterties facilities the possible replacement of plan enterties relating their entervil by whith or vanishim or acts of registeres on the past of olders. All plan enterties lead to be above for gooding over the condition for each specific shall of plan as the time of final acceptance.

Reting: The neting of plant meterial according to Florida Grades and Standards shall be equal to or bester than collec-for on the Plans and in these Specifications at the time of

The guarantee shall not begin until the day first entition acceptance to given.

The guarantee shall be null and votal for plant miterial which to danaged or obse as a result of "Asia of God" listed to Intil, freeze, lightning, and shriss which receased harrisans forces, providing the plant use to a healthy ground condition prior to these "Asia of God".

(1) Not in a healthy growing condition and thus renders it. leafour the namum quality indicated in the Specifications. (2) There is a question to its ability to earnive after the end of the guarantee period that would render it below the strang quality indicated in the Specification.

C. Stan duality, and director

Plannars of plant holes shall be roughly optionable to shape out to the calculation of plant holes and the state appropriate and vertical. The Lambacape Antheories meanwas the right to adjust the stee and obspec of the plant hole and the booking of the plant, in the hole to components for userstippined structures or userstippined records the calculation.

PLANTING DETAILS



Groundcovers



NOTE, State all trees up to 2" cal. # 2 per tree. Guy all trees larger than 2" cal. All relative paramy tame / Statebox may be recovered from all relative

EXISTING TREE PROTECTION BARRIER DETAIL

Driptive of entiting tree

6 its stack feares poss driven into
graces 1 if of etc.

Ourge plasts seen feacing

Housever, If for some naison, the plant to be replaced is enailer than the stae originally specifies, the replacement shall be at least equal to the originally specifies dos.

(2) Replacements shall be guaranteed for a period or the originally spectrus guarantee. This guarantee period shall bends at time of accomplishe continue

The words "job shat", "propost shat", "job", "propost" and
"shat" shall be sprongrous with one another shan used in
these documents.

Safety On and Off the Job Stee. A. Is performing the acopes of work, all safety, on of off the job site shall be the sole respectivity of the Commission. The Landscape Architect shall not be responsible for safety on or off the job stee.

(2) All salest and queen pales ahalf the backfilled with clean thoroughly scanned in during the planting operation. S) lister Source. A 4-trich high vater couper shall be formed around the rim of each individual tree or palm pit and sanitatived in place.

(4) Plans natural of the shale category and smaller must be heated by the lest only. Plans natural to be large for hand handling. If moved by pulsarior or order, must be throughly processed has shall negate or eable took, shall negate the shall negate his breaking and any other clange that stigits occur by toproper handling or negatigation.

planting —

2' black miles mining grade

Straight Trunk Palms

Shrubs

a. Uniformly apply formule 8-8-8 fertilizer over the area at a rate of 20 pounds per LODD equate feet. is. Remove econes and foreign nation over two inches in planeter from the top two inches of soft.

Life of the second seco

TYPICAL
BACK OF CURE (TYP)
BACK OF CURE (TYP)
BACK AREA TO 10 A SETH OF 10"
UNI APPROVED PLANING SOL
COPPACING SOL
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COPPACING SOL

o. Grade the cod areas so that the top of the cod uffi be at frieled grade after rolling and temping.

EXCAVATION DETAIL/BACKFILL DETAIL THE CONTRACTOR PLAT ADHERE TO THE POLICIANG

 NO SUBSTITUTIONS ULL BE ACCEPTED UTHOUT PROPERUITIES.
 APPROVAL BY THE LANDSCAPE ARCHITECT. APPROVALET THE LANGISCHE ARCHITECT.

ALL LANGISCHED AREAS TO PROCEED BYS REPORTATION CO-VERNAGE
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CONTRACTOR IS TREPONISHEE FOR RUPRISHES ALL HATERIALS, TOCKS BOUPFEST, LISON, AND INJURIES RECEIVED FOR THE PROPIER PLANTING OF ALL TRIES, BHRUSE BROUNDOWNS, AND GRASS AS SHOULD LANDSCAFE AND INJURIED IN PLANTING PLANT.

10. ALL PLANT MATERIAL TO SEE SACRIFILED WITH BUS CLEAN MUCK AND 50% SAND AND SEE FERTILE, AND PRIVABLE. IL GROUNDOMER AND SHRUBS TO BE LAID OUT IN A UNFORM AND CONSISTENT PATTERN.

NOTE:
AREAS ADJACENT TO VEHICULAR USE AREAS, SHALL BE EXCAVATED DOWN TO A DEPTH OF 50° BELOW EXISTING GRADE, EXCEPT FOR A 0° EMPTER PROVI THE NINDE OF CARD OF PARENEWS. PIEC EXP. ASSISTATION, THIS LARGE SHALL BE PROSENT.

(I) Trees, Shubs, and Groundcovers

B. Dra-Book and Leef Drops, priors reserved showing signs of chabitack of leef-drop off not be accepted and must be removed from the project meetinetie for on disnosed by the Leekespe Architect. Therefore, any plan resterful oils resoluted to a consideration of the project of the consideration sound leef-shop or del-book must be not provided explanately to provide a count relation of hist roots prior to relicable.

Wh of da. 6th of da.

G. An inspections at the growing else close not preclude the right of rejection at the project else.

D. The fact that the Landscape Architect has not need on early on the observation or inspections to discover fishing with or work onlined, or work performed within to not in accordance with the common respirations, will not be the Landscape Architect from advancemently rejecting such work at a later their.

G. Habit of Growth All plain material shall have a habit of growth that is normal for that species and shall be cound, habiting vigorous and free from treeds, plain cleases and labeles.

is timer and every day for a period of times upole e. Fertitae sed three weds after planting with 0 pounds of 8-8-8 fertilizer per 1800 equine feet of law.

d. No soil shall be used which is not certified as being heat of the imported fire ant. Before any soil is simulated to the site, funds a unition certification of clasmoon from pers control officials of either Buse or Rederel Department of Agriculture.

(3) Hernerone of Sect A. It shall be the responsibility of the Contractor to replace any areas of end that are not in healthy growing condition.

 The Contractor shall completely mintain the acci until that acceptance by noting or spraying as necessary. D. Marsing Beder

(I) Spread six inches of topsof minute uniformly over the extine planting area. (2) Spread BSN, organic fertition at a rate of 4 pounds per MSN source feet uniformly over the provisionous area.

(3) Rotor etc. or by other approved nethod, to a depth of testing indice.

(8) Transighty water and the the plants has the coll strains.

E. BLACK Mach.

(U Areas to its mildred shall have existing weeds and vegetation renoved, including nost systems, before applying milds.

C3) Grades are to be willow. Grade areas which are rough and uneven. Pit to votde and holes with planting set or other approved fit reterial.

GENERAL NOTES

partially partially

2. THE CONTRACTOR SHALL LAY OUT ON THE ORDARD THE LOCATION FOR THE FLATE AND DUTLINGS OF AREAS TO BE PLANED. THE CONTRACTOR HALL CRITICAL APPRICAL RIGHT THE LABOLANT ARCHITECT REPORTS (DICTAN APPRICAL THEO THE PROPERTY HAY ADJUST THE LOCATION OF REPORTS OF LANDSCAPE ARCHITECT HAY ADJUST THE LOCATION OF REPORTS OF LANDSCAPE ARCHITECT HAY ADJUST THE

b. TREES, PALMS, 6-RISES AND GROUNDGOVERS TO BE GUARANTEED TO BE GUARANTEED FOR ONE (IV TEAR AFTER FINAL METTER ACCEPTAGE IS SAVES TO GUEST OR LAND CARRIECT, CONTRACTOR IS RESPONSELS FOR PLANT MANIENANCE INTL. THE THE OF METTER ACCEPTAGES. IL LANDSCAPING IN SAFE DISTANCE TRANSLES SHALL SE HAINTAINED TO PROVIDE UNDSKRUCTED VISIBILITY AT A LEVEL SETIES IT AND 8' ABOVE PRIMARY GRADES.

IS. ALL EXISTING AND NEWLY CREATED PLANTING SEEDS TO BE CLEANED AND THESE OF MEEDS AND DESIRES AND EXCLUSIVED AS REQUIRED TO REPLE PLANTING SOIL REQUIREMENTS OF THE PLANTING DETAILS.

IS, ALL PLANTING BEDS THAT ARE ADJACENT TO PRIVING ARE TO BE LOWER THAN THE ADJACENT PRIVING SO THAT RANGE (BLACK MLCH, BOLL) HIGH THE BID DEED FIND THE HOTO DE SAUCHER FORMS.

ALL II ALVINO SELECIO SINON THE PRINCIPLO (27 AD LICENTE ASSESSED CONTROL SELECIO SELECIO SELECIO SINON THE PRINCIPLO SELECIO SELEC

20, ALL PLASTIC NARBORY TAPE TO BE REPOYED FROM TREE TRANS OF NELLY PLANTED TREES. IF IT IS NECESSARY TO TE TREE TRANS TO A STATE BODDISPADABLE ATT IS TO SE USED.

21, THESE PLANTED IN PARKING SELANDS OR AROUND VEHICLEAR USE AREAS SHALL NOT SE PLANTED SHERE THEY OSSICIRE SIGNS.

revisions: A 7-26-2019 per city comments

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banyan court

dave bodker landscape architecture/planning inc.

601 n. congress ave., suite 105-c delray beach, florida 33445 561-276-631 #LA0000999


sheet title

specifications details, notes project number:

date: scale: drawn by: 05/03/2019

sheet:

7 of 7 sheets

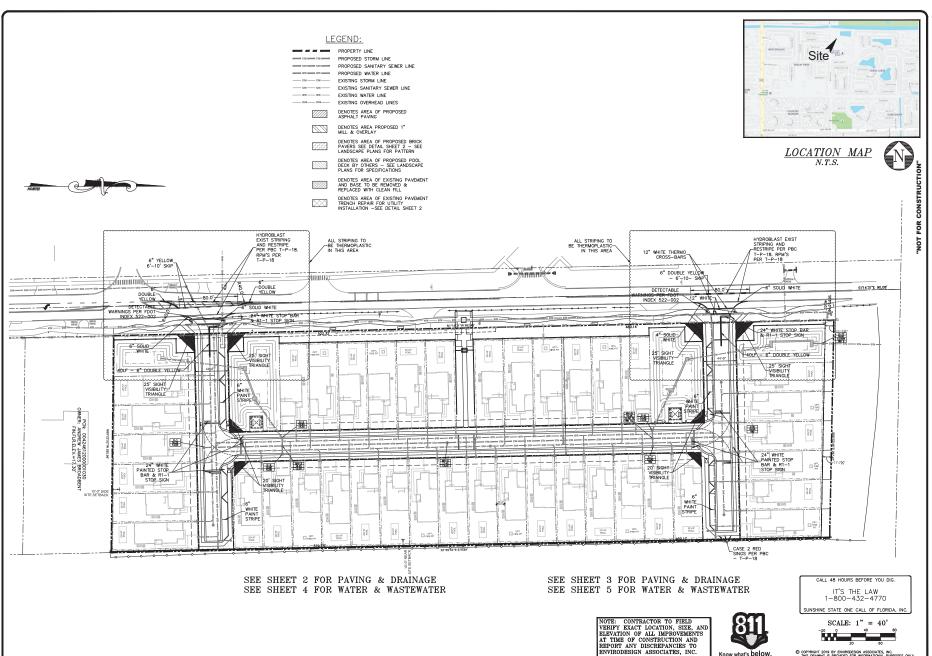

CVIL SITE IMPROVEMENTS KEY I
BANYAN COURT
BARWICK ROAD
DELRAY BEACH, FLORIDA EnviroDesign Associates In. DRAWN: B.A.B.

CHECKED:

9/12/19

JOB NO. 19007-ENG

SHEET NO. 1 OF 14

J.A.P.

DATE:

Know what's below. Call before you dig.

FLORIDA


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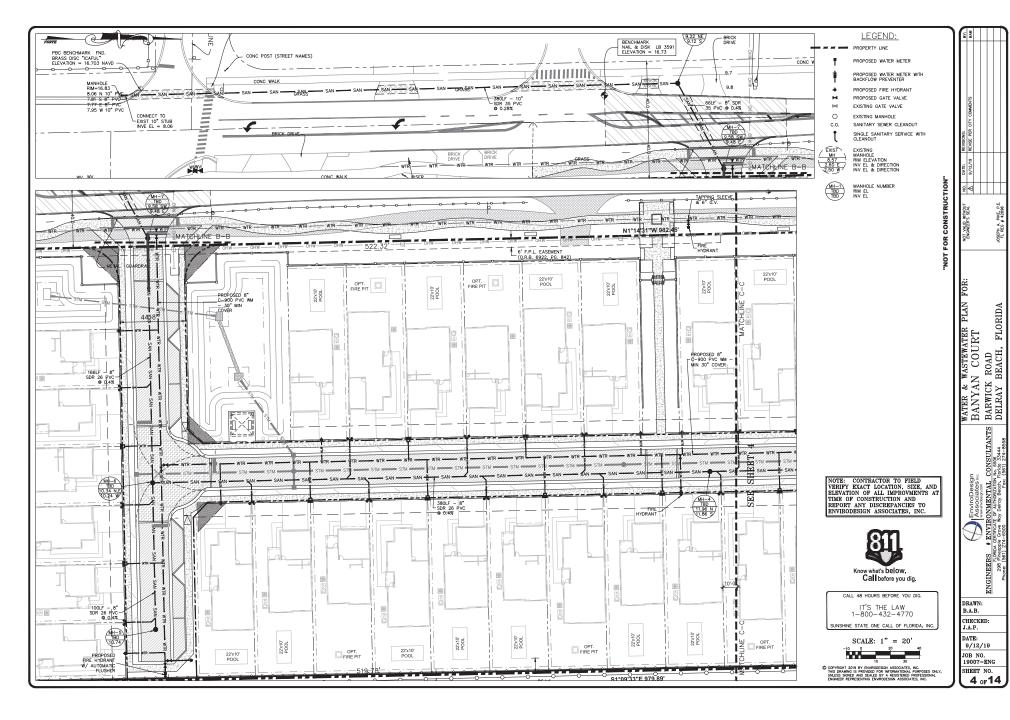
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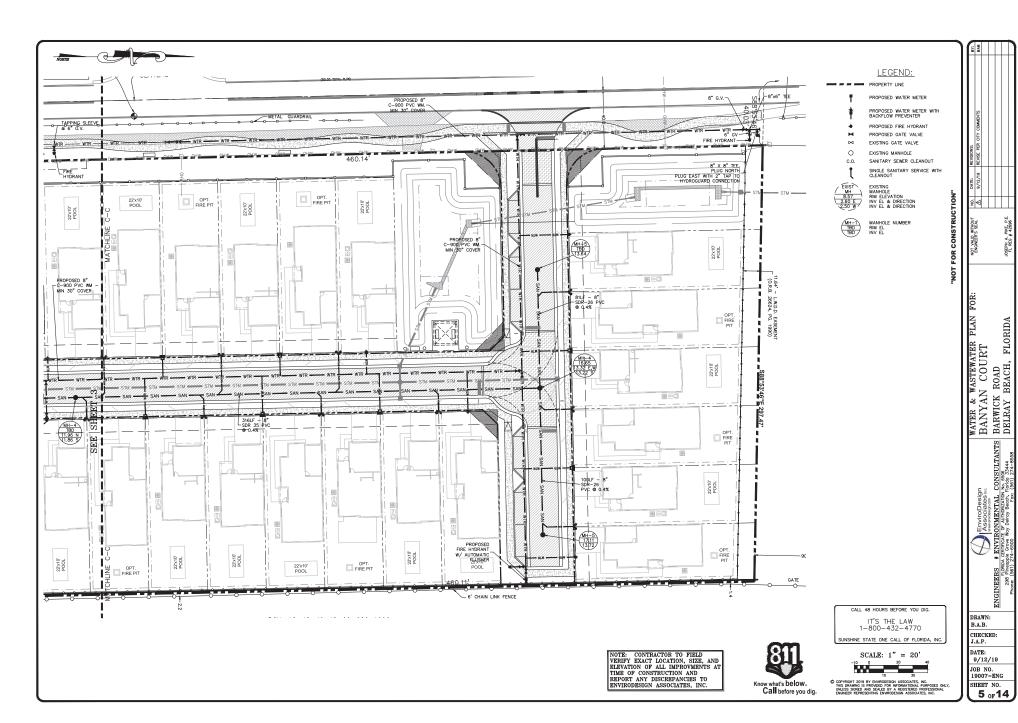
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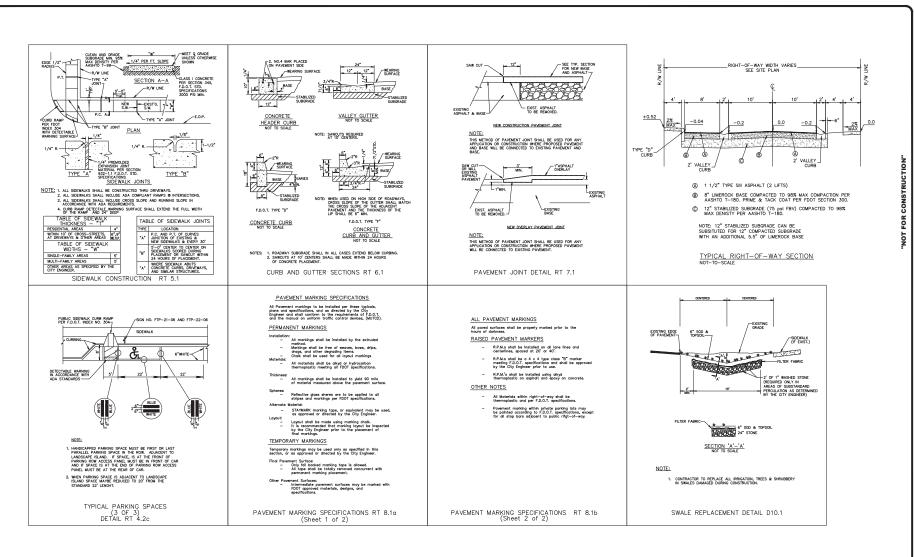
.. . \$019/1907-Bancer Court-Banyon Estates—Stelar-Bann/DWC/19077-EWGdes, 9/12/2019 8:58:34 AM, 4RCH full bleed 1) (24.00 x 36.00 inches)



O-VORM (1907) - Reviet Court - Brown Fatches - Station-Brown/MEX (1907) - FM day 077, 2010 8-10-06. All LBCH full haad 10 (24.00 v. 16.00 behav)



0/2010/1007=Remise Courte-Remon Fetches=Spaler=Branch DDC/10072=FIG.dm 0 /19/2010 R-50.43 AM 3RCH full blass In (24.00 v. 36.00 herbas)

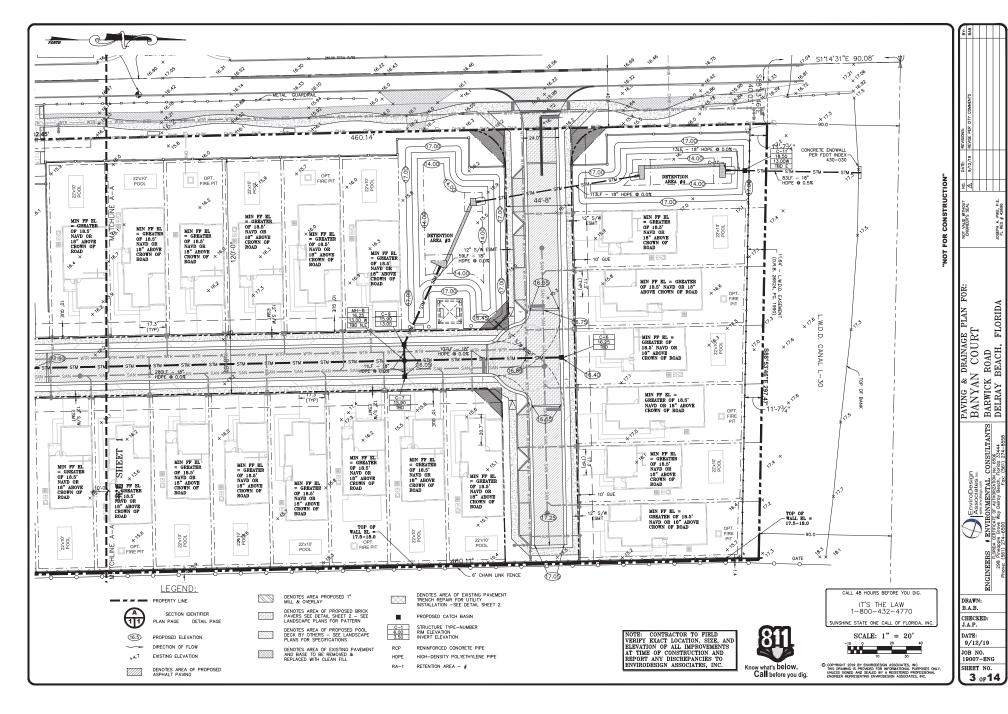



CALL 48 HOURS REFORE YOU DIG. IT'S THE LAW 1-800-432-4770 SUNSHINE STATE ONE CALL OF FLORIDA. INC.


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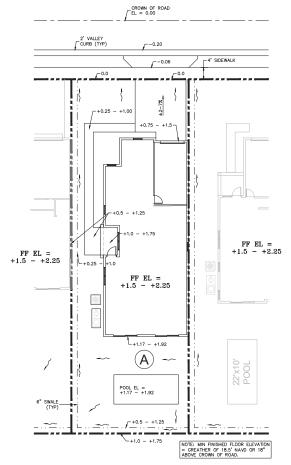
FLORIDA DRAINAGE D ROAD BEACH. PAVING & BANYAN BARWICK DELRAY B CONSULTANTS

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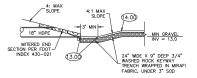
J.A.P. DATE: 7/25/19 JOB NO.

19007-DTL SHEET NO. 6 of 14



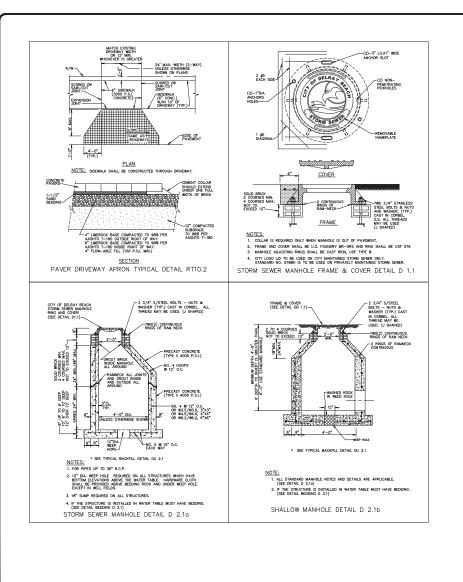

TYPICAL LOT GRADING PLAN



MITERED ENDWALL/KEYWAY GRAVEL DITCH DETAIL NOT-TO-SCALE



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JNSHINE STATE ONE CALL OF FLORIDA, IN

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PAVING & DRAINAGE DETAILS
BANYAN COURT
BARWICK ROAD
DELRAY BEACH, FLORIDA

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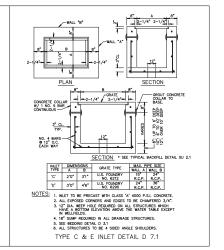
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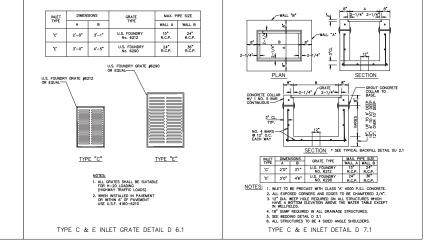
CHECKED: J.A.P.

J.A.P. DATE: 7/23/19

JOB NO. 19007-DTL SHEET NO.

7 of 14





NOTES:

BEDDING DEPTH SHALL BE 10" UNDER DRAINAGE STRUCTURES AND 18" UNDER SANITARY STRUCTURES.

ROCK SHALL BE WRAPPED IN FILTER FABRIC THAT MEETS THE REQUIREMENTS OF F.D.O.T. SPECIFICATION SECTION 985.

STANDARD BEDDING D 3.1

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ENVIRONMENTALINE
 ENVIRONMENTALINE
 CONSULTANTS
 CONTRICTOR
 CON

DRAWN:

JOSEPH A. PIKE, P.E. Fl. REG # 42696

PAVING & DRAINAGE DETAILS FOR:
BANYAN COURT
BARWICK ROAD
DELRAY BEACH, FLORIDA

B.A.B. CHECKED:

J.A.P. DATE:

7/23/19 JOB NO. 19007-DTL

SHEET NO. 8 of 14

PAVING, GRADING AND DRAINAGE NOTES

- ALL PAVING AND DRAINAGE WORK IN THE PALM BEACH COUNTY (PBC) RIGHT-OF-WAY SHALL BE CONSTRUCTED IN FULL ACCORDANCE WITH THE PBC LATEST STANDARDS. ALL PAVING AND DRAINAGE WORK IN THE FLORDA DEPAR OF TRANSPORTATION (FDDT) RIGHT-OF-WAY SHALL BE CONSTRUCTED IN FULL ACCORDANCE WITH THE FDDT LATEST STANDARD.
- COMPACTED SUBGRADE SHALL BE COMPACTED NO MEET THE DENSITY REQUIREMENTS AS DETERMINED BY THE ARSHTO T—180 SPECIFICATIONS SUBGRADE REQUIREMENTS AS DETERMINED BY THE ARSHTO T—180 SPECIFICATIONS SUBGRADE REVOND VALLEY QUITER, TYPE "C USE & QUITER TOPE" COURS SUBGRADE SHALL BE 12 INCHES THICK COMPACTED TO 88% ACCORDING TO AASHTO T—180. ALL MUCK, STUDIES, ROOTIS OF OHER DELETEROUS WAITER PROVIDENTED IN THE ALL MUCK, STUDIES, ROOTIS OF OHER DELETEROUS WAITER PROVIDENTED IN THE CONTROL OF THE ROOMWAY TO A WORTH OF TEN FEET BEYOND THE EDGE OF PAYMENT IF, BUSGRADE IS REQUIRED TO BE STRANGED. THE TOP OF THE TOP OF THE PROVIDENCE DEARNING THE STORY OF THE TOP OF T
- SHELLROCK BASE SHALL BE CONSTRUCTED IN ACCORDANCE WITH SECTION 250 OF THE FLORIA DEPARTEMENT OF TRANSPORATION STANDARD SPECIFICATIONS FOR ROAD HIE LEURGA DEFARLEMENT OF TRANSPORATION STANDARD SPECIFICATIONS FOR ROAD AND BRIDGE CONSTRUCTION, LETEST EDITION. THE THICKNESS OF THE SHELLROCK BASE SHALL BE AS SHOWN ON THE DETAIL DRAWINGS AND SHALL BE COMPACTED TO A SINSTLY OF 98% OF THE MAXIMUM DENSITY AS DETERMINED BY ASHIFT T-180. THE SHELLROCK SHALL HAVE A MINIMUM OF 40% CARBONATES OF CALCIUM AND MAGNESSUM IN THE MATERIAL.
- LIMEROCK BASE SHALL BE CONSTRUCTED IN ACCORDANCE WITH SECTION 200 OF DIRECTIVADO BASE, STALL BE CONSTRUCTED IN ACCORDANCE WITH SECTION 200 OF THE FOOT STANDARD SPECIFICATIONS FOR ROAD AND BRIDGE CONSTRUCTION, LATEST EDITION. THE THICKNESS OF THE LIMERCOCK BASE SHALL BE AS SHOWN ON THE DETAILED DRAWINGS AND SHALL BE COMPACTED TO A DENSITY OF 98% OF THE MAXIMUM DENSITY AS DETERMINED BY AASHTO T-180.
- MUCK AND PEAT IF MUCK AND/OR PEAT ARE ENCOUNTERED IN THE ROAD OR PARRINGS AREA, THEY MULL BE REMOVED COMPLETELY TO A WOTH OF TEN FEET MATTER. IT IS A WOTH OF TEN FEET WATER AND THE PARRING TO A WOTH OF TWO FEET AT THE SWALE INVERT AND REPLACED WITH GRANULAR MATERIAL.
- WHERE SOD IS DESIRED, LOWER THE GRADE 2 INCHES BELOW THE FINISHED GRADE TO ALLOW FOR THE THICKNESS OF THE SOD.
- CLEARING AND GRUBBING WITHIN THE LIMITS OF CONSTRUCTION ALL VEGETATION AND ROOT MATERIAL SHALL BE REMOVED.
- GUMBO WHERE GUMBO OR OTHER PLASTIC CLAYS ARE ENCOUNTERED, THEY SHALL BE REMOVED WITHIN THE ROADWAY AND PARKING AREAS ONE FOOT BELOW THE SUBGRADE EXTENDING HORIZONTALLY TO THE OUTSIDE EDGE OF THE SHOULDER AREA.
- FRIME COAT SYALL BE IN ACCORDANCE WITH SECTION SCO. OF THE FROT STANDARD SPECIFICATION FOR FROM AND BRONCE CONSTRUCTION, LATEST EDITION, PRIME COAT SHALL BE RO-70 OR ASPHALT EMILISON PRIME (EAP), PRIME COAT SHALL BE ARE OF APPLICATION NOT LESS THAN 0.10 GALLONS PER SOURCE YARD FOR LIMEROCK BASES AND NOT LESS THAN 0.15 GALLONS PER SOURCE YARD FOR SHELL ROCK OR COQUINA SHELL BASES.
- TACK COAT BITUMINOUS TACK COAT SHALL CONFORM WITH THE REQUIREMENTS OF THE FDOT SPECIFICATIONS, LATEST EDITION AND SHALL BE APPUED AT THE RATE OF 0.08 GALLONS PER SQUARE YARD, UNLESS A VARIATION IS APPROVED BY THE ENGINEET.

- ASPHALTIC CONCRETE SURFACE COURSE SHALL BE IN ACCORDANCE WITH SECTION 334 OF THE FOOT STANDARD SPECIFICATIONS FOR ROAD AND BRIDGE CONSTRUCTION, LATEST ADDITION. THE THICKNESS OF THE SURFACE COURSE SHALL BE AS SHOWN ON THE DETAILED DRAWINGS.
- ALL CONCRETE SHALL DEVELOP 2500 p.s.i. (MINIMUM) 28 DAY COMPRESSIVE STRENGTH OR GREATER WHERE NOTED ON PLANS. CLASS I CONCRETE SHALL CONFORM WITH THE FOOT SPECIFICATIONS, LATEST EDITION. CLASS I CONCRETE USED AS PANING SHALL DEVELOP 3000 p.s.i. (MINIMUM) 28 DAYS. COMPRESSIVE STRENGTH.
- PAVEMENT TRAFFIC STRIPES AND MARKINGS SHALL BE IN ACCORDANCE WITH CITY OF DELRAY BEACH CURRENT STANDARDS AND/OR MANUAL ON UNIFORM TRAFFIC CONTOL DEVICES FOR STREETS AND HIGHWAYS, AND/OR PALM BEACH COUNTY TRAFFIC DEPARTMENT TYPICAL T-P-17, WHERE APPLICABLE.
- SEQUENCE OF CONSTRUCTION THE SEQUENCE OF CONSTRUCTION SHALL BE SUCH THAT ALL INDERGROUND INSTALLATIONS OF EVERY KIND THAT ARE BENEATH THE PAVEMENT, SHALL BE IN PLACE AND HAVE PROPER DENSITY PRIOR TO THE CONSTRUCTION AND COMPACTION OF THE SIGNERADE. CONSTRUCTION AND COMPACTION OF THE SUBGRADE.
- INLETS AND MANHOLES ALL INLETS AND MANHOLES SHALL BE CONSTRUCTED IN ACCORDANCE WITH THE FDOT SPECIFICATIONS, LATEST EDITION, AND ROADWAY AND TRAFFIC DESIGN STANDARDS, LATEST EDITION, AND PBC STANDARDS LATEST EDITION, WHERE APPLICABLE.
- GRATE ELEVATIONS REFER TO THE FLOWLINE OF THE GRATE.
- 17 GRADES SHOWN ARE FINISHED GRADES
- 18. MINIMUM ROAD CROWN ELEVATION SHALL BE EL. 14.50' N.A.V.D.
- REINFORCED CONCRETE PIPE THE PIPE SHALL CONFORM WITH THE REQUIREMENTS OF CLASS III OF ASTM C-76 AND WITH THE FDOT SPECIFICATIONS, LATEST EDITION. THE FIRST JOINT OF PIPE ENTERING OR LEAVING A MANHOLE OR INLET SHALL BE WRAPPED WITH FILTER FABRIC PER FDOT SPECIFICATIONS.
- CORRUGATED ALUMINUM PIPE SHALL MEET THE REQUIREMENTS OF AASHTO M196 AND SECTIONS 125, 430 AND 943 OF THE FDOT STANDARD SPECIFICATIONS FOR ROAD AND BRIDGE CONSTRUCTION, LATEST EDITION.
- MEASUREMENT OF THE LENGTH OF PIPE SHALL BE FROM THE CENTER OF THE STRUCTURE TO THE CENTER OF THE STRUCTURE.
- PIPE BACKFILL REQUIREMENTS FOR PIPE BACKFILL CROSSING ROADS OR PARKING AREAS SHALL BE DEFINED IN THE FDOT SPECIFICATIONS, LATEST EDITION, PIPELINE BACKFILL SHALL BE PLACED IN SIX INCH LIFTS AND COMPACTED TO 100% OF THE STANDARD PROCTOR (AASHTO) T-99 SPECIFICATIONS. 22
- THE CONTRACTOR SHALL SUBMIT TO THE ENGINEER THREE (3) CERTIFIED COPIES OF A CHEMICAL AND SIEVE ANALYSIS OF THE SHELL ROCK BY A STATE OF FLORIDA CERTIFIED LAB WHEN CONSTRUCTING A SHELL ROCK BASE FOR ROADWAY.
- PRIOR TO CERTIFICATION OF THE DRAINAGE SYSTEM, THE CONTRACTOR MUST PUMP DOWN AND LAMP THE DRAINAGE SYSTEM FOR INSPECTION BY THE ENGINEER AFTER FINISHED ROOK FOR THE ROADWAYS HAS BEEN INSTALLED.

GENERAL NOTES

- CONTRACTOR SHALL PROTECT ALL PERMANENT REFERENCE MONIJIENTS AND TAKE ALL PRECAUTIONS NECESSARY TO AVIOD SURVEY MARKERS DURING CONSTRUCTION. CONTRACTOR SHALL BE RESPONSIBLE FOR REPLACEMENT OF PERMANENT REFERENCE MONIJIENTS DISTURBED DURING CONSTRUCTION, AT NO ADDITIONAL COST TO THE OWNER.
- CONTRACTOR SHALL BE RESPONSIBLE FOR THE PROTECTION OF ALL EXISTING UNDERGROUND UTILITIES WHETHER OR NOT SHOWN ON THE PLANS. UTILITIES SHOWN ON THE PLANS. UTILITIES SHOWN ON THE PLANS ARE FOR REFERENCE CNLY AND MAY NOT DEPICT ACTUAL LOCATIONS. CONTRACTOR SHALL NOTIFY ALL UTILITY COMPANIES FOR LOCATION AND DEPTH OF THEIR LUNES PRIOR TO CONSTRUCTION.
- CONTRACTOR SHALL BE RESPONSIBLE TO COORDINATE AND PAY FOR THE DEENERGIZING OF POWER LINES AND/OR HOLDING POWER POLES DURING CONSTRUCTION AT NO ADDITIONAL COST TO THE OWNER.
- CONTRACTOR SHALL BE RESPONSIBLE TO COORDINATE AND PAY FOR THE REPLACEMENT OF TRAFFIC LOOPS IF DAMAGED DURING CONSTRUCTION AT NO ADDITIONAL COAST TO THE OWNER.
- ALL ELEVATIONS REFER TO N.A.V.D. 1988. MINIMUM FINISHED FLOOR ELEVATION FOR ANY RESIDENTIAL STRUCTURE SHALL BE SET AT OR ABOVE ELEVATION 18.50 (WHICH IS ABOVE THE 100-15 AFFEQUENCY STORM).
- SHOP DRAWINGS SHALL BE SUBMITTED TO THE ENGINEER FOR REVIEW PRIOR TO CONSTRUCTION OR INSTALLATION AS REQUIRED BY THE ENGINEER OR BY THE APPROPRIATE GOVERNING AGENCIES.
- CONTRACTOR SHALL BE RESPONSIBLE TO SECURE AND PAY FOR, AT NO ADDITIONAL COST TO THE OWNER, ALL NECESSARY PERMITS, FEES AND LICENSES.
- CONTRACTOR SHALL BE RESPONSIBLE FOR GIVING THE REQUIRED NOTICES AND COMPLYING WITH ALL PERMIT(S) CONDITIONS.
- CONTRACTOR SHALL BE RESPONSIBLE TO COORDINATE AND PAY FOR THE HOLDING OF OTHER UTILITY POLES DURING CONSTRUCTION AT NO ADDITIONAL COST TO THE OWNER.
- 10. ALL CONCRETE SHALL DEVELOP 2500 p.s.: (MINIMUM) 28 DAY COMPRESSIVE STRENGTH OR GREATER WHERE NOTED ON PLANS, CLASS I CONCRETE SHALL CONFORM WITH THE FDOT SPECIFICATIONS, LATEST EDITION, CLASS I CONCRETE USED AS PAVING SHALL DEVELOP 3000 p.s.i. (MINIMUM) 28 DAYS COMPRESSIVE STRENGTH

- ALL UTILITY CONSTRUCTION SHALL BE IN ACCORDANCE WITH THE REQUIREMENTS OF THE LOCAL UTILITY.
- ENVIRODESIGN ASSOC. INC. SHALL NOT BE RESPONSIBLE FOR THE SAFETY OF THE WORKERS OR THE GENERAL PUBLIC. CONTRACTOR SHALL BE RESPONSIBLE FOR PROVIDING SAFETY TO THE WORKERS IN ACCORDANCE WITH OCCUPATIONAL SAFETY & HEALTH ADMINISTRATIONS (OSHA) REQUIREMENTS AND THE SAFETY OF THE GENERAL PUBLIC.
- ALL MATERIALS AND WORKMANSHIP MUST BE IN ACCORDANCE WITH THE LOCAL UTILITY STANDARDS AND SPECIFICATIONS.
- THE CONTRACTOR SHALL CALL SUNSHINE 1-800-432-4770 48 HOURS BEFORE DIGGING FOR FIELD LOCATIONS OF UNDERGROUND UTILITIES.
- CORRUGATED ALUMINUM PIPE USED BENEATH PAVEMENT SHALL BE IN CONFORMANCE WITH SEC. 8,24.E.5.i
- ALL CONSTRUCTION ACTIVITY, INCLUDING TRENCHING, IS TO BE A MINIMUM OF SIX FEET FROM THE BASE OF ANY TREE THAT IS DESIGNATED TO REMAIN.
- ALL LIMEROCK AND BASE MATERIALS SHALL BE REMOVED FROM THE PLANTER AREAS/ISLANDS AND REPLACED WITH APPROPRIATE PLANTING SOIL PRIOR TOT THE LANDSCAPING OF THE SITE.
- 18. THE REMOVAL OF ANY TREE ON THE SITE IS PROHIBITED WITHOUT THE REQUIRED
- ALL MATERIALS AND CONSTRUCTION WITHIN THE FDOT RIGHT-OF-WAY SHALL CONFORM TO THE FDOT DESIGN STANDARDS FOR DESIGN, CONSTRUCTION, MAINTENANCE AND UTILITY OPERATIONS ON THE STATE HIGHWAY SYSTEM (LATEST
- LANE CLOSURES WITHIN THE FDOT RIGHT-OF-WAY SHALL BE LIMITED TO THE HOURS OF 9AM-39M, MONDAY-FRIDAY EXCLUDING GOVERNMENTAL HOLIDAYS. MAINTENANCE OF TRAFFIC SHALL BE PROVIDED IN ACCORDANCE WITH INDEX 613 OF THE FDOT DESIGN STANDARDS (LATEST ED.)

CITY OF DELRAY BEACH GENERAL NOTES

DEFINITIONS 1. CITY - THE CITY OF DELRAY BEACH

- 2. CONTRACTOR UTILITY CONTRACTOR AND ALL UTILITY SUBCONTRACTORS
- 3. ENGINEER ENGINEER RESPONSIBLE FOR INSPECTION AND CERTIFICATION

- PROCEDURE

 1. A PRE-CONSTRUCTION MEETING IS TO BE HELD PRIOR TO DELIVERY OF MATERIALS AND INITIATION OF ANY WATER AND SEMEN CONSTRUCTION. THE MEETING SHALL BE ATTENDED BY THE CITY, CONTRACTOR, SUBCONTRACTORS, ENGINEER AND OTHER INTERESTED PARTIES.
- ANY REVISIONS TO THE APPROVED PLANS MUST BE APPROVED BY THE CITY PRIOR TO THE PRE-CONSTRUCTION MEETING.
- A MINIMUM OF THREE (3) COPIES OF THE CURRENT APPROVED PRODUCT LIST AND ALL NECESSARY SHOP DRAWINGS SHALL BE SUBMITTED FOR APPROVAL PRIOR TO SCHEDULING THE PRE-CONSTRUCTION MEETING. ALL PIPE MANUFACTHERS SHALL SUBMIT THREE (3) COPIES OF AN APPIDANT THAT THE PIPE AND COATINGS WERE MANUFACTURED IN ACCORDANCE WITH AWAR C151/ACS15-91.
- ALL APPLICABLE PERMITS MUST BE OBTAINED WITH COPIES PROVIDED TO THE CITY PRIOR TO COMMENCEMENT OF CONSTRUCTION.
- THE CONTRACTOR SHALL MAINTAIN A CURRENT APPROVED SET OF CONSTRUCTION DOCUMENTS ON SITE AT ALL TIMES.
- ALL MATERIALS SUPPLIED SHALL CONFORM TO PRODUCT LIST AND SHOP DRAWINGS AS APPROVED BY THE CITY PRIOR TO CONSTRUCTION. ALL REQUESTS FOR MATERIAL SUBSTITUTION SHALL BE APPROVED PRIOR TO DELIVERY OF THESE MATERIALS TO THE JOB STIE.
- THE LOCATION OF THE EXISTING UTILITIES AS SHOWN ON THE PLANS ARE APPROXIMATE. CILLY, THE EXECUTIONATION AND TO CONSTRUCTION. THE EXECUTION AND THE CONSTRUCTION. SHOWN ON THE PLANS DEST WHITH HE AREA OF CONSTRUCTION. SHOULD THERE BY UTILITY CONFLICTS, THE CONFRACTOR SHALL INFORM THE CITY AND NOTIFY THE RESPECTIVE UTILITY CONFLICTS. THE CONFRACTOR SHALL INFORM THE CITY AND NOTIFY THE RESPECTIVE UTILITY OWNER TO RESOLVE THE UTILITY CONFLICTS. AND THE UTILITY ADMINISTRATE AS REQUIRED.
- THE CONTRACTOR SHALL BE RESPONSIBLE AT ALL TIMES THROUGHOUT THE DURATION OF CONSTRUCTION FOR THE PROTECTION OF EXISTING AND NETW. INSTALLED UTILISES FROM DAMAGE OR DISSUPPLING OF SERVICE. THE CONTRACTOR SHALL BE RESPONSIBLE FOR TAKING SUCH MEASURES AS NECESSARY TO PROTECT THE HEALTH, SAFETY, AND WELFARE OF THOSE PRESONS HANDAN ACCESS TO THE WORK STE.
- THE CONTRACTOR SHALL BE RESPONSIBLE FOR OBTAINING LOCATIONS OF ALL OTHER UTILITY FACILITIES.
- THE CONTRACTOR SHALL SCHEDULE INSPECTIONS AND TESTS WITH THE CITY A MINIMUM OF 24
 HOURS IN ADVANCE.
- CONTRACTOR SHALL NOT DISTURB EXISTING CITY MAINS OR STRUCTURES WITHOUT THE PRESENCE OF A CITY UNILITY SYSTEM VALVES AND APPURIENANCES MAY ONLY BE OPERATED BY CITY PERSONNEL.
- FACILITIES PROPOSED HEREIN SHALL BE CONSTRUCTED IN ACCORDANCE WITH THE APPROVED PLANS. DEVIATIONS FROM THE APPROVED PLANS MUST BE APPROVED IN ADVANCE BY THE
- UPON COMPLETION OF CONSTRUCTION AND PRIOR TO FINAL ACCEPTANCE OF THE WORK, A FINAL INSPECTION SHALL VERIFY PROPER ADHERENCE TO ALL FACETS OF THE PLANS AND SPECIFICATIONS.
- 14. PAVING, DRAINAGE AND TRAFFIC CONSTRUCTION SHALL CONFORM TO FLORIDA. DEPARTMENT OF TRANSPORTATION RODINEY AND DESIGN STANDARDS, STANDARD SPECIFICATIONS FOR ROAD AND BRIDGE CONSTRUCTION, MANUAL ON UNIFORM TRAFFIC CONTROL DEVICES (MUTCO) AND PAUM BEACH COUNTY TRIPICA. T—P—17 (LATEST REVISION) UNLESS SHOWN OTHERISES.
- AS-BUILT DRAWINGS SHALL BE PREPARED BY A REGISTERED LAND SURVEYOR, REGISTERED IN THE STATE OF FLORIDA, AND SUBMITTED BY THE CONTRACTOR TO THE CITY.
- PRIOR TO COMMENCEMENT OF ANY EXCAVATION, THE CONTRACTOR SHALL COMPLY WITH FLORIDA STATUTE 553-851 FOR PROTECTION OF UNDERGROUND GAS PIPE LINES.
- 17. CONTRACTOR SHALL NOTIFY SUNSHINE STATE ONE (1-800-432-4770) 48 HOURS IN ADVANCE OF CONSTRUCTION.

- GRADES SHOWN ON PLANS ARE FINISHED GRADES. THE CONTRACTOR SHALL BE REQUIRED TO ADJUST EXISTING SANITARY SEWER MANHOLE TOPS AND VALVE BOX. COVERS TO FINISHED GRADE.
- EXISTING BASE MATERIAL THAT IS REMOVED DURING CONSTRUCTION SHALL NOT BE USED IN THE CONSTRUCTION OF NEW INFRICK RASE.
- ALL VEGETATION, DEBRIS, CONCRETE OR OTHER UNSUITABLE MATERIAL SHALL BE LEGALLY DISPOSED OF OFF-SITE IN AN AREA AT THE CONTRACTORS EXPENSE.
- 22. CONTRACTOR SHALL UTILIZE CONSTRUCTION METHODS AND DEVICES, SUCH AS TURBIDITY SCREENS, CURTAINS AND FLOATING SULT BARRIERS WHERE NECESSARY IN ORDER TO COMPLY WITH ALL STATE AND LOCAL WATER QUALITY STANDARDS.
- 23. ALL REINFORCED CONCRETE STORM SEWER PIPE SHALL BE CLASS III, UNLESS OTHERWISE NOTED.
- 24. ALL PAVED SURFACES SHALL BE PROPERLY MARKED PRIOR TO HOURS OF DARKNESS.
 PERMANENT PAVEMENT MARKING STALLS SHALL BE LAID OUT USING MARKING CHALK.
 LAYOUT
 TO BE REVIEWED BY THE CITY PRIOR TO PLAGEINGT OF FINAL MARKING.
- 25. EMBANMAINT (FIL.) AND EXCESS MATERIAL REQUIRED FOR ROADWAY RECONSTRUCTION AND UTILITY INSTALLATIONS SHALL BE SUPPLIED AND/OR DISPOSED OF BY THE CONTRACTOR. ALL COSTS ASSOCIATED WITH LEARNINGER REQUIREDATES TO COMPLET
- 26. CONTINUITY OF WATER AND SEWER SERVICE TO CITY UTILITY CUSTOMERS SHALL BE. MAINT THROUGHOUT THE DURATION OF THIS PROJECT. IF A BEAR IN SERVICE IS UNAVOIDED ACCOMMODATE CONNECTION OF NEW FACULITES, IT SHALL BE. SCHEDULED FOR OFF PEAK WITH THE CITY. DETERMINATION OF SERVICE BREAK REQUIREMENT WILL BE MADE BY
- 27. SITE INFORMATION BASED ON A SURVEY PREPARED BY: CAULFIELD & WHEELER, INC.
- 28. THE EXTENT OF ROAD CONSTRUCTION WORK TO BE COMPLETED BY THE CONTRACTOR, WITHIN THE
- 29. RELOCATION OF UTILITY POLES AND GAS PIPE LINES SHALL BE COORDINATED BY THE CONTRACTOR WITH FLORIDA POWER AND LIGHT, AND FLORIDA PUBLIC UTILITIES, RESPECTIVELY, EACH UTILITY HAS BEEN NOTIFIED THAT THEY WILL BE REQUIRED TO RELOCATE THEIR UTILITIES.
- ALL CITY OF DELRAY BEACH STANDARD DETAILS INCLUDED IN THE CIVIL PLANS PREPARED BY ENVIRODESIGN ASSOCIATES, INC. HAVE NOT BEEN MODIFIED FROM THEIR ORIGINAL CONTENT.
- 31. CONTRACTOR TO FIELD VERIFY EXACT LOCATION, SIZE, AND DEPTH OF ALL EXISTING UTILITIES PRIOR TO CONSTRUCTION AND REPORT ANY DISCREPANCIES TO ENVIRODESIGN ASSOCIATES, INC.
- 32. NO PROPOSED IMPROVEMENTS, BUILDINGS OR ANY KIND OF CONSTRUCTION CAN BE PLACED ON OR WITHIN ANY WATER, SEWER OR DRAINAGE EASEMENTS, UNLESS APPROVED BY THE CITY OF DELRAY BEACH CITY CHONEER.
- 33. NO PROPOSED STRUCTURES SHALL BE INSTALLED WITHIN A HORIZONTAL DISTANCE OF 10-FEET FROM ANY EXISTING OR PROPOSED WATER, SEWER OR DRAINAGE FAGILITIES, UNLESS APPROVED BY THE CITY OF DELRAY BEACH CITY ENDINER.
- NOTE: ANY TREES OR SHRUBS PLACED WITHIN WATER, SEWER OR DRAINAGE EASEMENTS, THEY SHALL CONFORM TO THE CITY OF DELRAY BEACH STANDARD DETAILS: LD 1.1 & LD 1.2
- 35. ALL SIDEWALKS TO BE CONSTRUCTED IN ACCORDANCE WITH ADA REQUIREMENTS. ALL SIDEWALKS NOT TO EXCEED 1:48 CROSS—SLOPE AND 1:20 RUNNING SLOPES. ALL RAMPS NOT TO EXCEED 1:40 CROSS—SLOPE AND 1:12 RUNNING SLOPES WITH MAJAMAM RISE AND RUNN PER ADA REQUIREMENTS WITH RAULINGS METER RECEIPED. LANGINGS WITH 1:46 CROSS—AND RECORDED AND RECORDED AND FOR THE RAMPS.
- CITY OF DELRAY BEACH UTILITY DIVISION MUST BE CONTACTED AT LEAST 48 HOURS PRIOR TO ANY SHUTDOWN AND/OR REMOVAL OF EXISTING WATER MAIN OR SANITARY SEWER LINES AT 561-243-7312.
- THE EXISTING SANITARY SEWER LINE MUST BE TELEVISED PRIOR TO AND AFTER ANY SANITARY SEWER SERVICE CONNECTION, REMOVAL AND/OR ABANDONMENT.
- 38, UPON APPROVAL AND RECIEPT OF PERMIT, THE CONTRACTOR SHALL CONTACT THE CITY OF DELRAY BEACH DEPUTY DIRECTOR OF CONSTRUCTION AT 561-243-7320 TO SCHEDULE A PRECONSTRUCTION MEETING PRIOR TO STARTING ANY SITE WORK.
- 39. ALL WATER METER SIZES TO BE DETERMINED BY PLUMBING ENGINEERING OF RECORD AND SHALL BE CHECKED AND AUTHORIZED BY CITY OF DELPAY BEACH UTILITIES DIVISION.
- ALL CITY OF DELRAY BEACH 2016 STANDARD DETAILS INCLUDED IN THIS SET OF PLANS AND DETAILS HAVE NOT BEEN MODIFIED FROM THEIR ORIGINAL CONTENT.

DRAWN: B.A.B. CHECKED:

Call before you dig.

IT'S THE LAW 1-800-432-4770 SUNSHINE STATE ONE CALL OF FLORIDA, INC.

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ENGINEER REPRESENTING ENWRODESIGN ASSOCIATES, INC.

CALL 48 HOURS REFORE YOU DIG

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FLORIDA



WATER & WASTEWATER I
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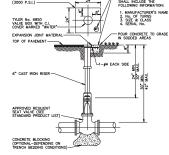
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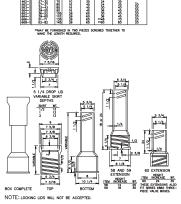
PECES PER PKG. CONCRETE COLLAR (3000 P.S.I.) **MAY BE FURNISHED IN TWO PIECES SCREWED TOGETHER TO MAKE THE LENGTH REQUIRED. POUR CONCRETE TO GRADE IN SODDED AREAS




NOTES:

- WHEN VALVE IS DEEPER THAN 30" AN EXTENSION WITH UNIVERSAL JOINT SHALL BE REQUIRED TO BRING OPERATING NUT 24"-30" BELOW FINISHED GRADE EXTENSION BOLTS & NUTS SHALL BE 316 STANLESS STEEL. A 316 STAINLESS STEEL CENTERING PLATE SHALL ALSO BE REQUIRED.
- AT DEAD END OR WHERE MAIN LINES CHANGE DIRECTION, VALVES SHALL BE RESTRAINED USING MECHANICAL JOINT RESTRAINTS, TIERODS, OR OTHER APPROVED RESTRAINT.

TYPICAL GATE VALVE DETAIL 4" THRU 12" PW 3.1



CAST IRON VALVE BOXES, TWO-PIECE PW 3.2

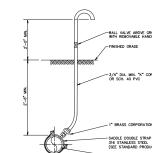

HYDRANT SHALL BE INSTALLED PLUMB AND TRUE IN UNOBSTRUCTED LOCATION. (7.5' CLEARANCE ON THREE SIDES, 4' CLEARANCE AT REAR, WITH 3' ACCESS LANE)

NO BARREL EXTENSION SHALL BE PERMITTED WITHOUT PRIOR CONSENT OF CITY ENGINEER. OF CITY ENGINEER.

VALVE SHALL BE PLACED ADJACENT TO MAIN, TIED TO TEE.

ANCHOR TEES AND FITTINGS ARE PERMITTED.

100-1-1

-EXIST. WATER MAIN

-NEW WATER MAIL VALVE No.2

BOTH VALVES SHALL BE KEPT CLOSED UNTIL FILLING, FLUSHING, AND BACTERIOLOGICAL TESTING IS COMPLETED AND APPROVED. AND BACTERIOLOGICAL TESTING IS COMPLETED AND APPROVED. GAUGE AND RISER TO BE REMOVED AFFER PRESSURE TEST. CITY SHALL BE NOTHED BEFORE FILING AND FLUSHING. AFTER RELEASE FROM THE HEALTH DEPARTMENT, BOTH VALVES TO BE LEFT OPEN WITH VALVE BOX INSTALLED ON BOTH VALVES.

PRESSURE TEST PUMP MAY CONNECT TO SERVICE LINE, FIRE HYDRANTS OR BLOWOFF. NO EXTRA TAPS ARE PERMITTED SOLELY FOR TESTING PURPOSES UNLESS PRECEEDING ARE NOT PRESENT IN TEST SECTION.

REQUIRED ON EXISING MAIN.

SETUP FOR ALL DOUBLE VALVE CONNECTIONS TO INCLUDE ATMOSPHERE VENTS AS SHOWN ABOVE.

OUTLET ON VENT TO ATMOSPHERE A MINIMUM 24* ABOVE EXISTING GRADE.

3'MN.

USE MECHANICAL RESTRAINTS JOINT

TAPPING SADDLE OR SLEEVE (PER CURRENT CITY PRODUCT LIST) IS REQUIRED ON EXISTING MAIN.

FILL & FLUSH DETAIL PW 1.1

VARIES (12' MAX.)
OR AS INDICATED ON DRAWINGS

4-1/2" PUMPER NOZZLE FACING R/W & (2) 2-1/

PLAN

PANTED SILVERY

(SEE DETAIL WALVE SETTING

(SEE DETAIL WALVE

6" D.I.P.

6" D.I.P.

100

VALVE No.1

POTABLE WATER SUPPLY

NOTES:

THRUST BLOCK-

18"MIN. OR DIA. OF PIPE WHICHEVER IS GREATER-

GROUND OR PAVEMENT SURFACE

6 MIL VINYL PLASTIC BETWEEN FITTINGS & CONC.(TYP.)

CONC. VALVE SUPPORT-

-VENT TO ATMOSPHERE

-VALVE No.2

SERVICE SADDLE AND C.C. CORPORATION STOP REQUIRED

MUELLER 1" 825008 MUELLER 1 1/2" = 2" 825008 FORD 1" F1000 FORD 1 1/2" - 2" FB1000

CONTRACTOR SHALL PROVIDE CERTIFICATION THAT GAUGES AND METERS ARE PROPERLY CAUBRATED AND ACCURATE.

FILL AND FLUSH HERE

- HYDRANT SHALL BE MUELLER CENTURION, AMERICAN B-84B, CLOW MEDALION OR KENNEDY K81A WITH TRAFFIC BREAKAWAY FLANGE AND 5-1/4" VALVE.
- ON RUNS LONGER THAN 20 FEET A SECOND VALVE IS REQUIRED AT THE HYDRANT
- ALL HYDRANT INSTALLATION SHALL BE IN ACCORDANCE WITH CITY OF DELRAY BEACH FIRE PREVENTION CODE SEC. 96.05.
- IN CERTAIN SITUATIONS, PROTECTIVE BOLLARDS MAY BE REQUIRED AS DIRECTED BY THE ENGINEERING DEPT. (SEE BOLLARD DETAIL PW 5.2)
- FIRE HYDRANTS INSTALLED BUT NOT YET IN SERVICE SHALL BE COVERED WITH A BURLAP, OR PLASTIC SACK, OR HAVE OUT OF SERVICE RING IN PLACE
- ALL HYDRANT LEADS GREATER THAN 20—FEET MUST HAVE AUTOMATIC FLUSHER INSTALLED AT HYDRANT END (HYDROGUARD HG-1 STANDARD).
- TYPICAL FIRE HYDRANT INSTALLATION PW 5.1

BALL VALVE ABOVE GROUND WITH REMOVABLE HANDLE. -3/4" DIA. MIN. "K" COPPER OR SCH. 40 PVC

20" D.I.P. MIN 10'-0'

1. THE WAR AND DANTANY SERIES CROSSING LINES WHITE MANS SHALL BE LUD TO PROVIDE A MAN WHITE ALL STATES THE WARTER TO THE PROVIDE A MANNEW APPEAL DATE OF THE LORSE PIPE. MADE THIS MANNEW STRAND THE LORSE PIPE MADE THIS MANNEW STRAND THE LORSE AND MAN AND THE LORSE PIPE AND THE CONTROL OF THE LORSE AND THE

MAINTAIN (10) FEET HORIZONTAL DISTANCE BETWEEN WATER MAIN AND STORM OR SANITARY SEWER MAIN, AS A MINIMUM.

3. FORCE MAIN CROSSING WATER MAIN SHALL BE LAID TO PROVIDE A MINIMUM VERTICAL DISTANCE OF 18 INCHES BETWEEN THE OUTSIDE OF THE FORCE MAIN AND THE OUTSIDE OF THE WATER MAIN WITH WATER MAIN CROSSING OVER FORCE MAIN.

4. SEMER SERVICE LATERALS SHALL CROSS UNDER WATERANNS WITH A MINIMUM VERTICAL SEPARATION OF EIGHTEEN (16) NOHES. IF EIGHTEEN (18) INCHES VERTICAL SEPARATION CANNOT BE MANTANED. THE MATERAN SHALL BE LICE AND THE MATERAL C-900 SORTS OR BETTER AND THE MINIMUM SEPARATION SHALL BE SX (6) NOHES.


WHEN IT IS NOT POSSIBLE FOR THE WATER MAIN TO CROSS OVER THE SEMER SERVICE LITERALS, MUNICIAL SPETICAL, SEPTICAL SERVICE, SPETICAL SERVICES WASTE BY SHALL SEE D.P. AND THE STREET LITERAL SHALL BE C.D.P. AND THE STREET LITERAL SHALL BE C.D.P. AND THE STREET LITERAL SHALL BE C.P. WATER MAIN & SEWER CONFLICT DETAIL PW 2.1

SANITARY/STORM SEWER MAIN-

NOTES:

1. SAMPLE POINT SHOULD BE AT SERVICE LINE OR FIRE HYDRANT IF POSSIBLE

- IF SAMPLE POINT IS NOT AT SERVICE LINE OR FIRE HYDRANT, CORP. STOP SHALL BE SHUT OFF AT MAIN AND ALL TUBING SHALL BE REMOVED, AND CORP. STOP SHALL HAVE A BRASS PLUIG OR CAP INSTALLED AFTER RELEASE OF WATER MAIN BY PALM BEACH COUNTY HEALTH DEPARTMENT.
- IF AT ALL POSSIBLE SAMPLE POINT SHALL NOT BE LOCATED IN A TRAFFIC AREA.
- SAMPLE POINTS SHALL KEEP RUNNING UNTIL HEALTH DEPT. RELEASE AND ALL MAIN LINE VALVES ARE OPENED. TYPICAL SAMPLE POINT PW 7.1

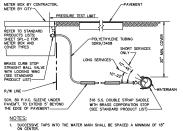

- SERVICE LINES SHALL NOT BE PLACED UNDER DRIVEWAYS.
- ALL METERS REQUIRE A LOCKING BRASS CURB STOP WITH LOCK WING (1"MIN.).
 NO FITTINGS BETWEEN CORPORATION STOP AND BRANCH ASSEMBLY.
- 5. MAXIMUM SERVICE LENGTH IS 100° TO METER.
- . CASING PIPE I.D. SHALL BE SERVICE O.D. PLUS 1" MINIMUM
- MINIMUM BEND RADIUS ON SERVICES SHALL BE 14" ON ALL SERVICES BEHIND METER.
- METER SIZE WILL BE DETERMINED BY PUBLIC UTILITIES DEPT. UPON APPLICATION FOR SERVICE. 9. ALL VALVES TO BE BALL VALVES.
- IO. METER BOX SHALL BE PROVIDED AND INSTALLED BY CONTRACTOR
- ALL SERVICES UNDER ROADWAYS ARE TO BE INSTALLED BY TRENCHLESS METHOD, UNLESS OTHERWISE APPROVED.
- ALL EXISTING SERVICES TO BE FIELD VERIFIED BY BUILDER/CONTRACTOR/DEVELOPER; IF EXISTING SERVICE IS GALVANIZED, BUILDER/CONTRACTOR/DEVELOPER SHALL REPLACE WITH POLYETHYLENE PIPING FROM MAIN TO THE METER. TYPICAL SERVICE CONNECTION PW 9.1a

PRESSURE PIPE NOTES:

- THERE SHALL BE 30" MINIMUM COVER FROM FINISHED GRADE TO TOP OF PIPE. FOR PIPE SIZE 10" AND LARGER THERE SHALL BE 36" MINIMUM COVER.
- DUCTILE IRON PIPE (DIP) FOR FORCE MAINS SHALL BE CLASS 350 EPOXY LINED IN ACCORDANCE WITH AWWA C550.
- 2.b. DUCTILE IRON PIPE (DIP) FOR WATER MAINS SHALL BE CLASS 350 IN ACCORDANCE WITH AWWA C151 (ANSI A21.51), AND SHALL HAVE AN INTERNAL LINING OF CEMENT MORTAR IN ACCORDANCE WITH AWWA C104/ A21.4.
- C-900 PVC PRESSURE PIPE MAY BE USED IN LIEU OF DIP WATER MAIN METAL TAPE ABOVE C-900
- ALL FITTINGS SHALL BE CLASS 350 DUCTILE IRON WITH MECHANICAL JOINTS AND EPOXY LINING.
- WATER MAN AND SEMACE FORCE MAIN VALVES 12 INCHES AND SMALLER SHALL BE RESULENT WEDGE GATE VALVES IN ACCORDANCE WITH AWAY C509. WATER MAN VALVES LARGER THAN 12 INCHES SHALL BE BUTTERFLY VALVES IN ACCORDANCE WITH AWAY C504. SEWAGE FORCE MAIN VALVES LARGER THAN 12 INCHES SHALL BE RESULENT REDUCE GATE VALVES IN ACCORDANCE WITH AWAY C515.
- ALL TRENCHING, PIPE-LAYING, BACKFILL, PRESSURE TESTING, AND DISINFECTION MUST COMPLY WITH CITY AND HEALTH DEPARTMENT STANDARDS
- WATER AND FORCE MAINS SHALL BE PICKED, AS WELL AS, PRESSURE TESTED FOR A PERIOD OF NOT LESS THAN TWO HOURS AT 150 PSI IN ACCORDANCE WITH ANSI/AWMS COOL LATEST STANDARDS. ALLOWABLE LEAKAGE SHALL BE DETERMINED AS FOLLOWS:

$L = \frac{(S)(D)(P)^{0.50}}{X(.50)}$

- L = ALLOWABLE LEAKAGE (GALLONS PER HOUR) S = PIPE LENGTH (FEET) D = NOMINAL DIAMETER OF PIPE (INCHES) P = AVERAGE TEST PRESSURE (PS)
- PRIOR TO ANY TESTING UNDER FUTURE PAVEMENT, ROCK SHALL BE FINISHED & PRIMED OR 1ST LIFT OF ASPHALT PLACED.
- PIG SIZE SHALL BE PIPE DIA, PLUS 2" OR NEXT LARGER DIA,
- NO PROPOSED STRUCTURES SHALL BE INSTALLED WITHIN A HORIZONTAL DISTANCE OF 10-FEET FROM ANY EXISTING OR PROPOSED WATER MAINS, OR FORCE MAINS.
- LINE STOPS SHALL BE INSTALLED A MINIMUM OF 3 PIPE LENGHTS FROM LOCATION OF PIPE REMOVED, OTHERWISE, PROVIDE NECESSARY JOINT RESTRAINTS

PRESSURE PIPE NOTES PP 1.1

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GOOD FOR 16" AND LARGER HANDLE TO TANGE CLOSURE

BLIND FLANGE CLOSURE

GOOD FOR 6" THUR 16"

WYE EXIT

PIG LAUNCHER DETAIL PP 5.1

HINGED CLOSURE

WYE ENTRY

PRESSURE GAUGE

SOLID RED BRICK (MIN. 2 COURSE MAX. 4 COURSE) NOT TO EXCEED 12* RESILIENT PIPE CONNECTOR (LOCK JOINT FLEXIBLE SLEEVE ELASTOME EPPM OR EQUAL) - 8" MIN. THICKNESS POUR ALL AROUND

* SEE TYPICAL BACKFILL DETAIL GU 2.1

NOTES:

- ALL DETAILS AND SPECIFICATIONS FOR STANDARD MANHOLES ARE APPLICABLE EXCEPT FOR REFERENCES TO DROP ASSEMBLY.
- DROP CONNECTIONS SHALL BE REQUIRED WHENEVER AN INFLUENT INVERT IS LOCATED 2.0 FEET OR MORE ABOVE THE MAIN INVERT CHANNEL.

DROP MANHOLE DETAIL WW 2.3

	R	EST	RAI	NEC)				
FITTING TYPE		PIPE SIZE							
		4"	6*	8"	10"	12"	16"	20"	24"
90, H	RIZ. BEND	14	20	25	30	35	45	54	62
45° H	RIZ. BEND	6	8	11	13	15	19	22	26
22.5° H	ORIZ. BEND	3	4	5	6	7	9	11	12
11.25° F	IORIZ. BEND	1	2	3	3	4	4	5	6
90° VERT.	UPPER BEND	55	79	103	125	147	189	228	266
OFFSET	LOWER BEND	22	38	49	59	69	88	106	123
45" VERT.	UPPER BEND	22	32	42	51	60	77	93	109
OFFSET	LOWER BEND	10	14	19	23	28	35	43	50
22.5" VERT.	UPPER BEND	7	12	17	21	26	34	42	49
OFFSET	LOWER BEND	2	4	6	8	10	14	17	21
11,25° VERT.	UPPER BEND	3	4	6	9	11	15	19	22
OFFSET	LOWER BEND	1	1	1	2	3	5	7	8
PLUG (DEAD END)		32	45	59	70	83	107	129	151
INLIN	E VALVE	32	45	59	70	83	107	129	151
	4*X0	23							
	6*X0	21	35						
	8*X0	18	34	47					
TEE (BRANCH	10*X0	16	32	46	58				
RESTRAINT)	12*X0	13	30	44	57	69			
,	16"X0	7	26	41	55	67	90		
	20"X0	1	21	38	52	65	88	109	
	24 X0	1	16	34	49	62	86	108	129
	6°X0	23							
	8*X0	38	25						
REDUCER	10*X0	57	43	24					
LARGER PIPE	12*X0	72	60	44	41				
RESTRAINT)	16*X0	99	90	78	75	45			
	20"X0	123	116	107	105	81	45		
	24"X0	146	140	132	131	111	82	45	

PIPE RESTRAINT TABLE FOR PRESSURE PIPE PP 2.1A (SHEET 1 OF 2)

- GRAVITY SEWER NOTES

 1. MANHOLES SHALL BE INSPECTED BY THE ENGINEER BEFORE PLACEMENT AND SUPFACE TREATMENT.
- ALL OPENINGS IN PRECAST MANHOLES SHALL BE CAST AT TIME OF MANUFACTURE. CONNECTIONS TO EXISTING MANHOLES SHALL BE CORE ENTRY ONLY.
- CONNECTIONS TO EXISTENCE MANDICES STATE BE COVER ENTITY ONLY.

 ALL MANHOLES SHALL BE SET PLUMB TO LINE AND GRADE.

 (PVC) GRAVITY SEWER PIPE SHALL CONFORM TO ASTM D 3034, SDR 35, LATEST REVISIONS, WITH PUSH ON RUBBER GASKET JOINTS.
- REVISIONS, WITH PUSH ON RUBBER CASKET JOINTS.

 (DP) CRANTY SEWER PIES SHALL BE CLASS 305, EPOXY UNED OR AS OTHERWISE APPROVED BY ENVIRONMENTAL SERVICES DEPARTMENT.

 NO SERVICE CONNECTIONS, WYES, SERVICES OR VALVES WILL BE PERMITTED IN RESIDENTIAL DRIVEWAYS.
- NESIDENTIAL DRIVEWAYS.

 MANHOLE FRAMES SHALL BE ATTACHED TO THE PRECAST STRUCTURE WITH A MINIMUM OF TWO 3/4" 316 STAINLESS STEEL BOLTS, NUTS AND WASHERS, FRAMES SHALL BE SEALED WITH A MINIMUM OF TWO 1/2" BEADS OF RAM-NEK CAULKING.

- MIL NOT SE ALLOWED DUTIL REPORTED BY THE DISINEER.

 IN ADMITTANT OF STEER MAN AND LINES SHALL METTER ADMITTANT OF THE ADMITTA
- 12. WHERE SEWER IS NOT WITHIN PUBLIC R/W, IT IS TO BE LOCATED IN A 12' UTILITY EASEMENT, CITY MAINTENANCE RESPONSBILITY IS MANHOLE TO MANHOLE ONLY.
- EXECUTE OIL MANITONICE REPORTED TO MANICATE OF MANICATE OF MANICATE ON THE BOOK MANICATE ON THE BOOK MANICATE OF THE MANICATE
- 16. AT THE END OF THE ONE (1) YEAR WARRANTY PERIOD THE DEVELOPER/CONTRACTOR WILL T.V. INSPECT, AIR TEST EVERY JOINT, AND CHECK MANHOLE JOINTS AND CONNECTIONS TO DETERMINE IF REPAIRS ARE NECESSARY BEFORE THE WARRANTY BOND IS RELEASED.
- NO PROPOSED STRUCTURES SHALL BE INSTALLED WITHIN A HORIZONTAL DISTANCE OF 10-FEET FROM ANY EXISTING OR PROPOSED SANITARY SEWER FACILITY.
- ANY PIPE INTRODUCED INTO AN EXISTING MANHOLE MUST HAVE CARROLINE BITUMASTIC SOON OR APPROVED EQUAL APPLIED EXTERNALLY MITTHIN AUMINIM 2—FOOT ADJUS OF OPENING AND THE ENTIRE MANHOLE MUST HAVE SEWPER COAT OR APPROVED EQUAL APPLIED INTERNALLY.
- ANY REHABILITATION TO AN EXISTING MANHOLE MUST BE INTERNALLY STRIPPED AND LINED WITH SEWPER COAT OR APPROVED EQUAL. GRAVITY SEWER NOTES WW 1.1

FRAME & COVER (SEE DETAIL WW 2.5) TWO 3/4" 316 S/S
BOLTS NUTS & WASHERS
(TYP.) CAST IN CORBEL
ALL THREAD ROD MAY
BE USED (J SHAPED) 2 COURSES SOLID BRICK 4 MAX. W/ MORTAR FINISH NOT TO EXCEED 12" /SLOPE 3/4"/FT. 60 -HOLE DIAMETER APPROPRIATE FOR SIZE OF PIPE (SEE NOTE 7) 8" UP TO 6' DEEP 10" 6' TO 10' DEEP 12" OVER 10' DEEP

PIPE RESTRAINT TABLE FOR PRESSURE PIPE PP 2.1B (SHEET 2 OF 2)

1. THE DATA IN THE PREVIOUS TABLE ARE BASED UPON THE FOLLOWING INSTALLATION CONDITIONS:

2. THE RESTRAINED PIPE LENGTHS APPLY TO DUCTILE IRON PIPE AND PVC PIPE. 3. ALL JOINTS BETWEEN UPPER AND LOWER BENDS SHALL BE RESTRAINED. RESTRAINED PIPE LENGTHS FOR VALVES APPLY TO PIPE ON BOTH SIDES OF VALVES THE PREVIOUS TABLE SHALL SERVICE AS A GENERAL DESIGN GUIDE ONLY. IT IS THE ENGINEER OF RECORD'S RESPONSIBILITY TO JUSTIEV AND DOCUMENT ANY DEVIATIONS FROM THE PIPE LENGTHS SPECIFIED IN THE PREVIOUS TABLE.

SOURCES: EBAA IRON RESTRAINT LENGTH CALCULATION PROGRAM FOR PVC PIPE, RELEASE 3.1 AND DIPRA THRUST RESTRAINT FOR DUCTILE IRON PIPE, RELEASE 3.2.


7. RESTRAIND JOINTS SHALL EXTEND ONE JOINT BEYOND MIN, LENGTH REQUIRED.

150 PSI, 200 PSI FOR PIPES LARGER THAN 24"

NOTES:

- * SEE TYPICAL BACKFILL DETAIL GU 2.1 PRECAST CONCRETE TYPE II 4000 P.S.I.
 RAMNECK AT ALL RISER JOINTS WITH GROUT ON INSIDE AND OUTSIDE AT ALL RISER
- ALL OPENINGS SHALL BE SEALED WITH A WATERPROOF NON-SHRINKING GROUT.
- 4. FLOW CHANNELS SHALL BE CONSTRUCTED TO DIRECT INFLUENT INTO FLOW STREAM. 5. LIFT HOLES SHALL BE FILLED WITH EXPANDABLE GROUT
- ALL PIPE HOLES SHALL BE PRECAST.
- CAST IN PLACE FLEXIBLE PIPE—TO MANHOLE CONNECTOR (LOCK JOINT FLEXIBLE SLEEVE ELASTOMER EPDM OR RUBBER GASKET WITH GLASS FIBER REINFORCED NYLON 6/6 INTERNAL EXPANSION RING) INSTALLED PER MANUFACTURED.
- PAINT MANHOLE INSIDE AND OUTSIDE WITH ONE (1) COAT RED CARBOLINE BITUMASTIC 300M THEN ONE (1) COAT BLACK OR APPROVED EQUAL, to 8-10 MILS D.F.T/COAT, FIRST COAT RED THEN BLACK.
- 9. MANHOLE FABRICATION SHALL BE IN ACCORDANCE W/ ASTM C-478. LATEST STANDARD
- IF THE STRUCTURE IS INSTALLED IN WATER TABLE MUST HAVE BEDDING. (SEE DETAIL BEDDING WW6.1)

STANDARD MANHOLE DETAIL WW 2.1

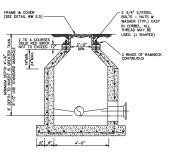

FINISHED GRADE

FITTING TYPE

0

DEFLECTION TYPE

 THERE SHALL BE IN ALL CASES A MINIMUM OF 18" VERTICAL SEPARATION BETWEEN WATER MAINS AND FORCE MAINS. WHEREVER POSSIBLE WATER MAINS SHALL PASS OVER FORCE MAINS OR STORM SEWERS. 3. FITTINGS SHALL BE RESTRAINED WITH MECHANICAL JOINT RESTRAINTS.

PRESSURE PIPE CONFLICT DETAIL PP 3.1

4. THE DEFLECTION TYPE CROSSING IS PREFERRED. DO NOT EXCEED 75% OF MANUFACTURERS RECOMMENDED MAXIMUM JOINT DEFLECTION. 6. REFER TO TYPICAL RESTRAINING DETAIL PP 2.1

CONFLICT PIPE SLOPE UP TO

DUCTILE IRON PRESSURE PIPE

NOTES:

SEE NOTE NO. 5 FOR ACCEPTABLE DEFLECTION-

* SEE TYPICAL BACKFILL DETAIL GU 2.1

ALL STANDARD MANHOLE NOTES AND DETAILS ARE APPLICABLE (DETAIL WW 2.1).

SHALLOW MANHOLE DETAIL WW 2.2

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PIKE, P.E 7 42696

DETAILS FLORIDA WATER & WASTEWATER I
BANYAN COURT
BARWICK ROAD
DELRAY BEACH, FLOF


CONSULTANTS ENVIRONMENTAL

DRAWN: B.A.B.

CHECKED: J.A.P.


DATE: 7/23/19 JOB NO.

19007-DTL SHEET NO. 11_{0F}14

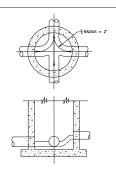

NOTES:

- ALL INVERT CHANNELS ARE TO BE CONSTRUCTED FOR SMOOTH FLOW WITHOUT OBSTRUCTION OR TURBULENCE.
- PROPERLY SHAPED SPILLWAYS SHALL BE CONSTRUCTED BETWEEN PIPES WITH DIFFERENT INVERT ELEVATIONS TO PROVIDE FOR SMOOTH FLOWS.
- 3. SERVICE LATERALS SHALL NOT ENTER MANHOLES.
- 4. 2500 PSI CONCRETE ONLY PERMITTED AS FLOW CHANNEL BUILDUP

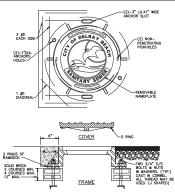


NOTES:

1. COLLAR IS REQUIRED ONLY WHEN MANHOLE IS OUT OF PAVEMENT.

2. COVER SHALL BE U.S. MR-CRS AND RING SHALL BE USF 576 RING WITH BITUARSTIC COAL TAR. 3. MANHOLE ADJUSTING RINGS SHALL BE CAST IRON, USF TYPE B.

SANITARY SEWER MANHOLE FRAME AND COVER WW 2.5

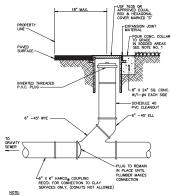


NOTE:

1. INVERTED BRASS CAP SHALL BE USED IN GRASS AREAS IN LIEU OF CASTING AND CONE COLLAR.

2. MINIMUM DEPTH OF SERVICE LATERAL SHALL BE 3 FEET.

TYPICAL COMMERCIAL CLEANOUT WW 5.2

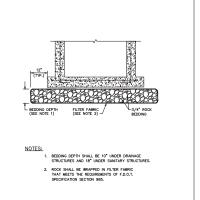

STANDARD BEDDING DETAIL

INVERT FLOW CHANNELS WW 2.4 / EXISTING HYDRO-GUARD BASE (BY OTHERS) 2" SCH. 80 PVC 90" ELBOW -2" BRASS CORPORATION STOP MUELLER H9968, FORD FB500-ELEV. NOTES:

1. GALVANEZD PPING AND FITTINGS SHALL NOT BE USED.

2. JOHN RESTRANTS TO BE INSTALLED MR. TWO JOHN'S BETONE DEAD DID.

3. HORDO-GUANG IS TO BE USED AT ALL PERMANENT DEAD BUGS.

TYPICAL 2" TERMINIAN EL BLOW—OFF

FOR PERMANENT DEAD ENDS PW 6.1b

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DETAILS WATER & WASTEWATER DETAIL:
BANYAN COURT
BARWICK ROAD
DELRAY BEACH, FLORIDA

DRAWN: B.A.B.

CHECKED: J.A.P.

DATE: 7/23/19

JOB NO. 19007-DTL SHEET NO. 12_{0F}14 REPLACEMENT BASE TO BE AT MIN.
 12" THICK.

4. ALL DISTURBED PAVEMENT MARKINGS SHALL BE RESTORED IN ACCORDANCE WITH CITY STANDARDS.

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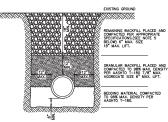
 BASE MATERIAL SHALL BE PLACED IN TWO LIFTS AND EACH LIFT COMPACTED TO 98% MAXIMUM DENSITY PER AASHTO T-180 (MAX. LIFT THICKNESS = 6°).

 SURFACE MATERIAL SHALL BE F.D.O. TYPE S-I OR S-III ASPHALTIC CONC. (MIN. THICKNESS 1 1/2").

2b. 12" EXCAVATABLE FLOWABLE FILL 6. ANY PAN MIN. 100 P.S.I. MAY BE USED IN LIEU PATCHED OF 12" BASE. 6. ANY PAN DAY TO DAY TO TRAFFIC

 ASPHALT CONCRETE PAVEMENT JOINTS SHALL BE MECHANICALLY

PAVEMENT REPAIR DETAIL GU 1.1




NOTES:

UNSUITABLE IN-SITU MATERIALS SUCH AS MUCK, DEBRIS AND LARGE ROCKS SHALL BE REMOVED; BEDDING MATERIAL AND BACKFILL CONSISTING OF WASHED AND GRADED LIMEROCK 3/8*

- THE PIPE AND/OR STRUCTURE SHALL BE FULLY SUPPORTED FOR IT:
 ENTIRE LENGTH WITH APPROPRIATE COMPACTION UNDER THE PIPE.
- 3. THE PIPE AND/OR STRUCTURE SHALL BE PLACED IN A DRY TRENG
- BACKFILL SHALL BE FREE OF UNSUITABLE MATERIAL SUCH AS LARGE ROCK, MUCK, AND DEBRIS.
- TO 95% DENSITY ELSEWHERE. (AASHTO T-180)

 6. COMPACTION AND DENSITY TESTS SHALL BE COMPLETED DURI
 BANKELL OPERATIONS CONTRACTORS NOT FOLLOWING THIS

TYPICAL BACKFILL DETAIL GU 2.1

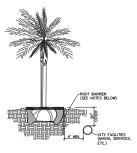


NOTES:

- ALL ROOT BARRIERS SHALL BE 4' MINIMUM FROM ALL CITY FACILITIES.
 THE INSTALLATION OF ROOT BARRIERS SHALL BE COORDINATED WITH CITY AND INSPECIED BY CITY PRIOR TO BACKFILLING. ALL ROOT BARRIERS SHALL EXTEND UP TO TINNENED GRADE.
- ROOT BARRIERS SHALL BE MINIMUM 36" DEEP, APPROVED PRODUCTS INCLUDE "DEEP ROOT" AND "ROOT SOLUTIONS". FLEXIBLE BARRIERS SHALL BE 36" PANELS MANUFACTURED BY BIOGRAFIER.
- MANUFACTURED BY BIOBARRIER.

 4. ALL ROOT BARRIERS SHALL BE INSTALLED IN ACCORDANCE WITH MANUFACTURERS

TYPICAL TREE WITH ROOT BARRIER LD 1.1

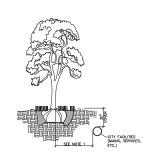

NOTES:

 THIS DISTANCE SHALL BE 10" MINIMUM FROM ALL CITY FACILITIES IF NO ROOT BARRIER IS USED.

TYPICAL TREE WITHOUT ROOT BARRIER LD 1.2

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WATER & WASTEWATER DETAILS FOR:
BANYAN COURT
BARWICK ROAD
DELRAY BEACH, FLORIDA

| Environment | BANYA | Associates see | BANYA | Environment | BANYA | Environment | E

ENGINEERS • I

DRAWN: B.A.B. CHECKED: J.A.P.

J.A.P.

DATE:

DATE: 7/23/19 JOB NO. 19007-DTL

SHEET NO. 13₀F14 2. CONTRACTOR TO REMOVE FABRIC JUST PRIOR TO PAVING.

STORM WATTER WILL REACH THE SEDMENT TRAP VIA CURE CUTS ADJUSTED TO EACH SDE OF THE INLET STRUCTURE. THESE OPENINGS SHALL BE AT LEAST 12 INCHES IN LICHOTH, STORM WATER MAY ASSO, BEACH THE BASH NA OFCREMED FOR UNAN AREA BEHIND THE CURE. THE CURE CUTS SHALL BE REPARED WHEN THE SEDMENT TRAP IS REMOVED.

INLET FILTER DETAIL D 8.1

KEEP DUST WITHIN TOLERABLE LIMITS BY SPRINKLING OR OTHER ACCEPTABLE MEANS.

 ADDITIONAL EROSION AND SECHMENT CONTROL MEASURES MAY BE REQUIRED IF DEEMED NECESSARY BY ONSITE INSPECTION. FAILURE TO PROPERLY INSTALL AND MAINTAIN EROSION CONTROL PRACTICES SHALL RESULT IN CONSTRUCTION BEING HALTED.

NALT PROTECTION CETAL.

A NAY ACCESS ROUTES TO SITE SHALL BE BASED WITH CRUSHED STONE, WHERE PRACTICAL.


B. RODGING CONTROL MEDISES ARE TO BE MAINTAINED UNTIL PERMANENT (MAINTAINED CONTROL MEDISED.)

TO HONOLOGY PETABLE, MATURAL WESTATION SHALL BE RETAINED AND PROTECTED.

MILLS MORK IS TO BE IN COMPLANCE WITH THE RULES AND REQULATIONS SET FORTH BY THE STATE OF FLORDA, DEPARTMENT OF ENVIRONMENTAL PROTECTION AND THE CITY OF DELRAY BEACH.

DISCHARGE FROM DEWATERING OPERATIONS SHALL BE RETAINED ONSITE IN A CONTAINMENT AREA.

EROSION CONTROL NOTES DETAIL D9.1

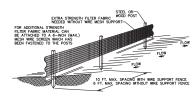

NOTES:

1. THE HEIGHT OF A SILT FENCE SHALL NOT EXCEED 36 INCHES (90 CM). THE FILTER FABRIC SHALL BE PURCHASED IN A CONTINUOUS ROLL CUT TO THE LENGTH OF THE BARRIER TO AVOID THE USE OF JOINTS.


OF THE IMPREST TO ANDO THE USE OF JOINTS.

PORTS SHALL BE SPACED A MANDAM OF 10 FEET (S) A JOHANT AT THE BRINGSPEET LOCATION AND DRIVEN SECURISTY WITH THE GROUND A WIRMAN OF 12 MORES (D) GAU, WENT DETAY AND DRIVEN SECURISTY OF THE WIRE SPACED OF THE THE CONTROL AND SHALL NOT DEVELOPED A CHARLE TO CONTROL THE WIRE SPACED AND THE CONTROL SECURISTY OF THE WIRE SPACED OF THE POSTS URGINE AND A MORE SHOWN AND SHOWN AND THE THE CONTROL SECURISTY OF THE WIRE SPACED SECURISTY OF THE WIRE SPACED SHOWN AND SHALL NOT EXTENDED SECURISTY OF THE WIRE SPACED SHALL SHOW AND SHALL SHOULD SHALL SHOW AND SHALL SHAL

8. ALL PROJECTS REQUIRE SUBMITTAL OF POLLUTION PREVENTION PLAN (PPP).

9. ALL PROJECTS 1 AC. OR MORE MUST SUBMIT NOTICE OF INTENT (NOI) TO FDEP

SILT FENCE INSTALLATION DETAIL D 9.1a Sheet 1 of 2

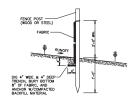


SILT FENCE SECTION NOT TO SCALE



ATTACHING TWO SILT FENCES

SILT FENCE INSTALLATION DETAIL D 9.1b Sheet 2 of 2

CONSTRUCTION ENTRANCE LOCATION TO BE DETERMINED BY CONTRACTOR AS NEEDED 5174'31"E 90.08" FLOATING TURBIDITY BARRIER TEMPORARY SILT TEMPORARY SILT FENCING (TYPICAL) FENCING (TYPICAL) PCN: 12-42-46-12-00-000-1090 OWNER: SCHOOL BOARD OF PALM BEACH COUNTY FL PLANNING & REAL ESTATE SERVICES

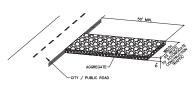

STABILIZED CONSTRUCTION ENTRANCE DETAIL D9.1C

CALL 48 HOURS BEFORE YOU DIG. IT'S THE LAW 1-800-432-4770 UNSHINE STATE ONE CALL OF FLORIDA, INC.



SCALE: 1" = 50'


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ROAD BEACH, FLORIDA PREVENTION COURT POLLUTION F BANYAN BARWICK R DELRAY BE ENVIRONMENTAL CONSULTANTS
ERRIFICATE OF AUTHORIZATION NO. 6506
6 Grove Way Delicy Beach Florida 334 EnviroDesign Associates Inc.

CHECKED: J.A.P. DATE: 9/12/19 JOB NO. 19007-ENG

DRAWN: B.A.B.

SHEET NO. 14_{0F}14

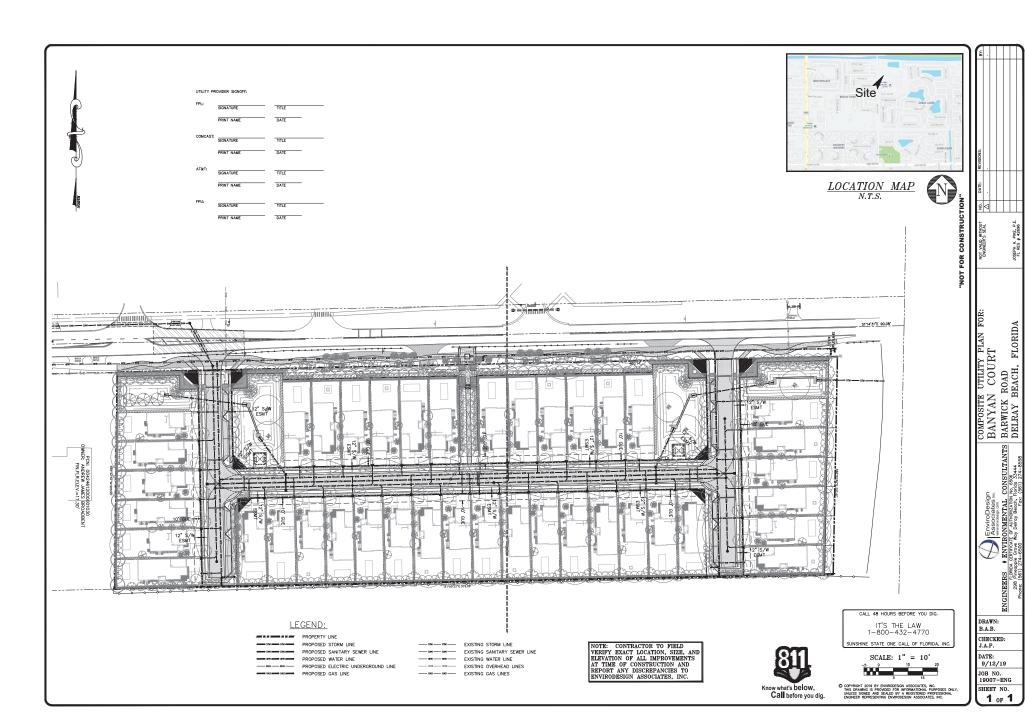

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