

DRAWING INDEX

ARCHITECTURAL

SP-1 SITE PLAN

CVR COVER SHEET

A-1.1 GROUND FLOOR PLAN
A-1.2 SECOND FLOOR PLAN

A-1.3 THIRD FLOOR PLAN
A-1.4 ROOF TERRACE PLAN

A-2 UPPER ROOF PLAN

A-3.1 EAST AND NORTH ELEVATIONS
A-3.2 WEST AND SOUTH ELEVATIONS

100 GLEASON STREET

DELRAY BEACH, FLORIDA

RICHARD JONES AA26001617 | IB26001056 WWW.RJARCHITECTURE.CO FLORIDA LICENSURE AA26001617 | IB26001056 COMMISSION # DESIGNER: DRAWN BY: PLAN REVIEW SUBMITTALS: CLASS V SPECIAL SITE SUBMITTAL **REVISIONS:**



LOCATION MAP

--- LOCATION

OWNER

JOHN DELEONIBUS 100 GLEASON STREET DELRAY BEACH, FL 33483

CIVIL ENGINEER

REVIEWED FOR SHEAR WALL REQUIREMENTS X YES NO (IF NO, INDICATE REASON)

MUST BE INDICATED ON CONSTRUCTION PLANS.

SOIL BEARING CAPACITY 2500 PSF

CODE RESEARCH

NFPA 1 UFC FLORIDA 2015 EDITION, NFPA 101 LSC FLORIDA 2018 ED.

PROVIDED:

X SEC. R301.2.1.4.3 5th EDITION (2014) FLORIDA RESIDENTIAL CODE

SIDE INTERIOR SETBACK = 15'-0"/30'-0" SIDE INTERIOR =15'-0 1/4"/30'-0"

= 25'-0"/30'-0" FRONT SETBACK = 25'-0"/30'-0"

= 25'-0"/30'-0" SIDE STREET = 25'-0"/ 30'-0"

REAR SETBACK = 15'-0 3/4"

PROPOSED PROJECT: 3 STORY DUPLEX WITH (2) CAR GARAGE AND ROOF TOP

GOVERNING CODE: FBC RESIDENTIAL 6th EDITION (2017), FFPC 6th EDITION (2017),

35'-0" TO BASE BUILDING ELEVATION

170 MPH ULTIMATE WIND SPEED

TYPE VB SPRINKLERED FOR 3-STORY UNITS

DESIGN PARAMETERS

BUILDING HEIGHT X ≤ 60 FT. (MAY USE LOW RISE PROVISIONS OF THE 5th EDITION (2014) FLORIDA RESIDENTIAL CODE)

5th EDITION (2014) FLORIDA RESIDENTIAL CODE- ULTIMATE WIND SPEED 170 (3 SECOND GUST) BASIC VELOCITY PRESSURE

NOTE: ACTUAL DESIGN PRESSURES FOR ALL EXTERIOR WINDOWS, DOORS, GARAGE DOORS, AND SIMILAR ENVELOPE ELEMENTS

BUILDING DESIGNED AS PARTIALLY ENCLOSED X ENCLOSED OPEN TESTED (WIND TUNNEL)

ASCE 7-10 CH 26- WIND SPEED NA (3 SECOND GUST) BASIC VELOCITY PRESSURE NA PSF

ROOF DEAD LOAD (ACTUAL DEAD LOAD OF MATERIAL USED FOR DETERMINING UPLIFT REACTIONS) 5 PSF

APPURTENANCE

ENCLOSED

ORDINARY HAZARD

MEAN ROOF HEIGHT 35'-0" TO BASE BUILDING ELEVATION X ASCE 7-10 CHAPTER 26

FRONT SETBACK

REAR SETBACK

ZONING DISTRICT: RM-MEDIUM HIGH DENSITY

BUILDING HEIGHT:

CONSTRUCTION:

BLDG. DESIGNED:

CLASSIFICATION:

REQ'D. SETBACKS:

WIND SPEED:

EXPOSURE:

HAZARD

TYPE OF

ENVIRODESIGN ASSOCIATES, INC. 298 NE 2ND AVENUE DELRAY BEACH, FL 33444 TELEPHONE: 561-274-6500

FAX: 561-274-8558

ARCHITECT

RICHARD JONES ARCHITECTURE 10 S.E. FIRST AVENUE, SUITE 102 DELRAY BEACH, FL. 33444 TELEPHONE: 561-274-9186

STRUCTURAL

ENGINEERING PLUS 19528 SEDGEFIELD TERRACE BOCA RATON, FL 33498 TELEPHONE: 561-756 4106


LANDSCAPE

DAVE BODKER LANDSCAPE
PLANNING
601 N CONGRESS AVE SUITE 105-A
DELRAY BEACH, FL 33445
TELEPHONE: 561-276-6311

COVER SHEET

CVR

NORTH

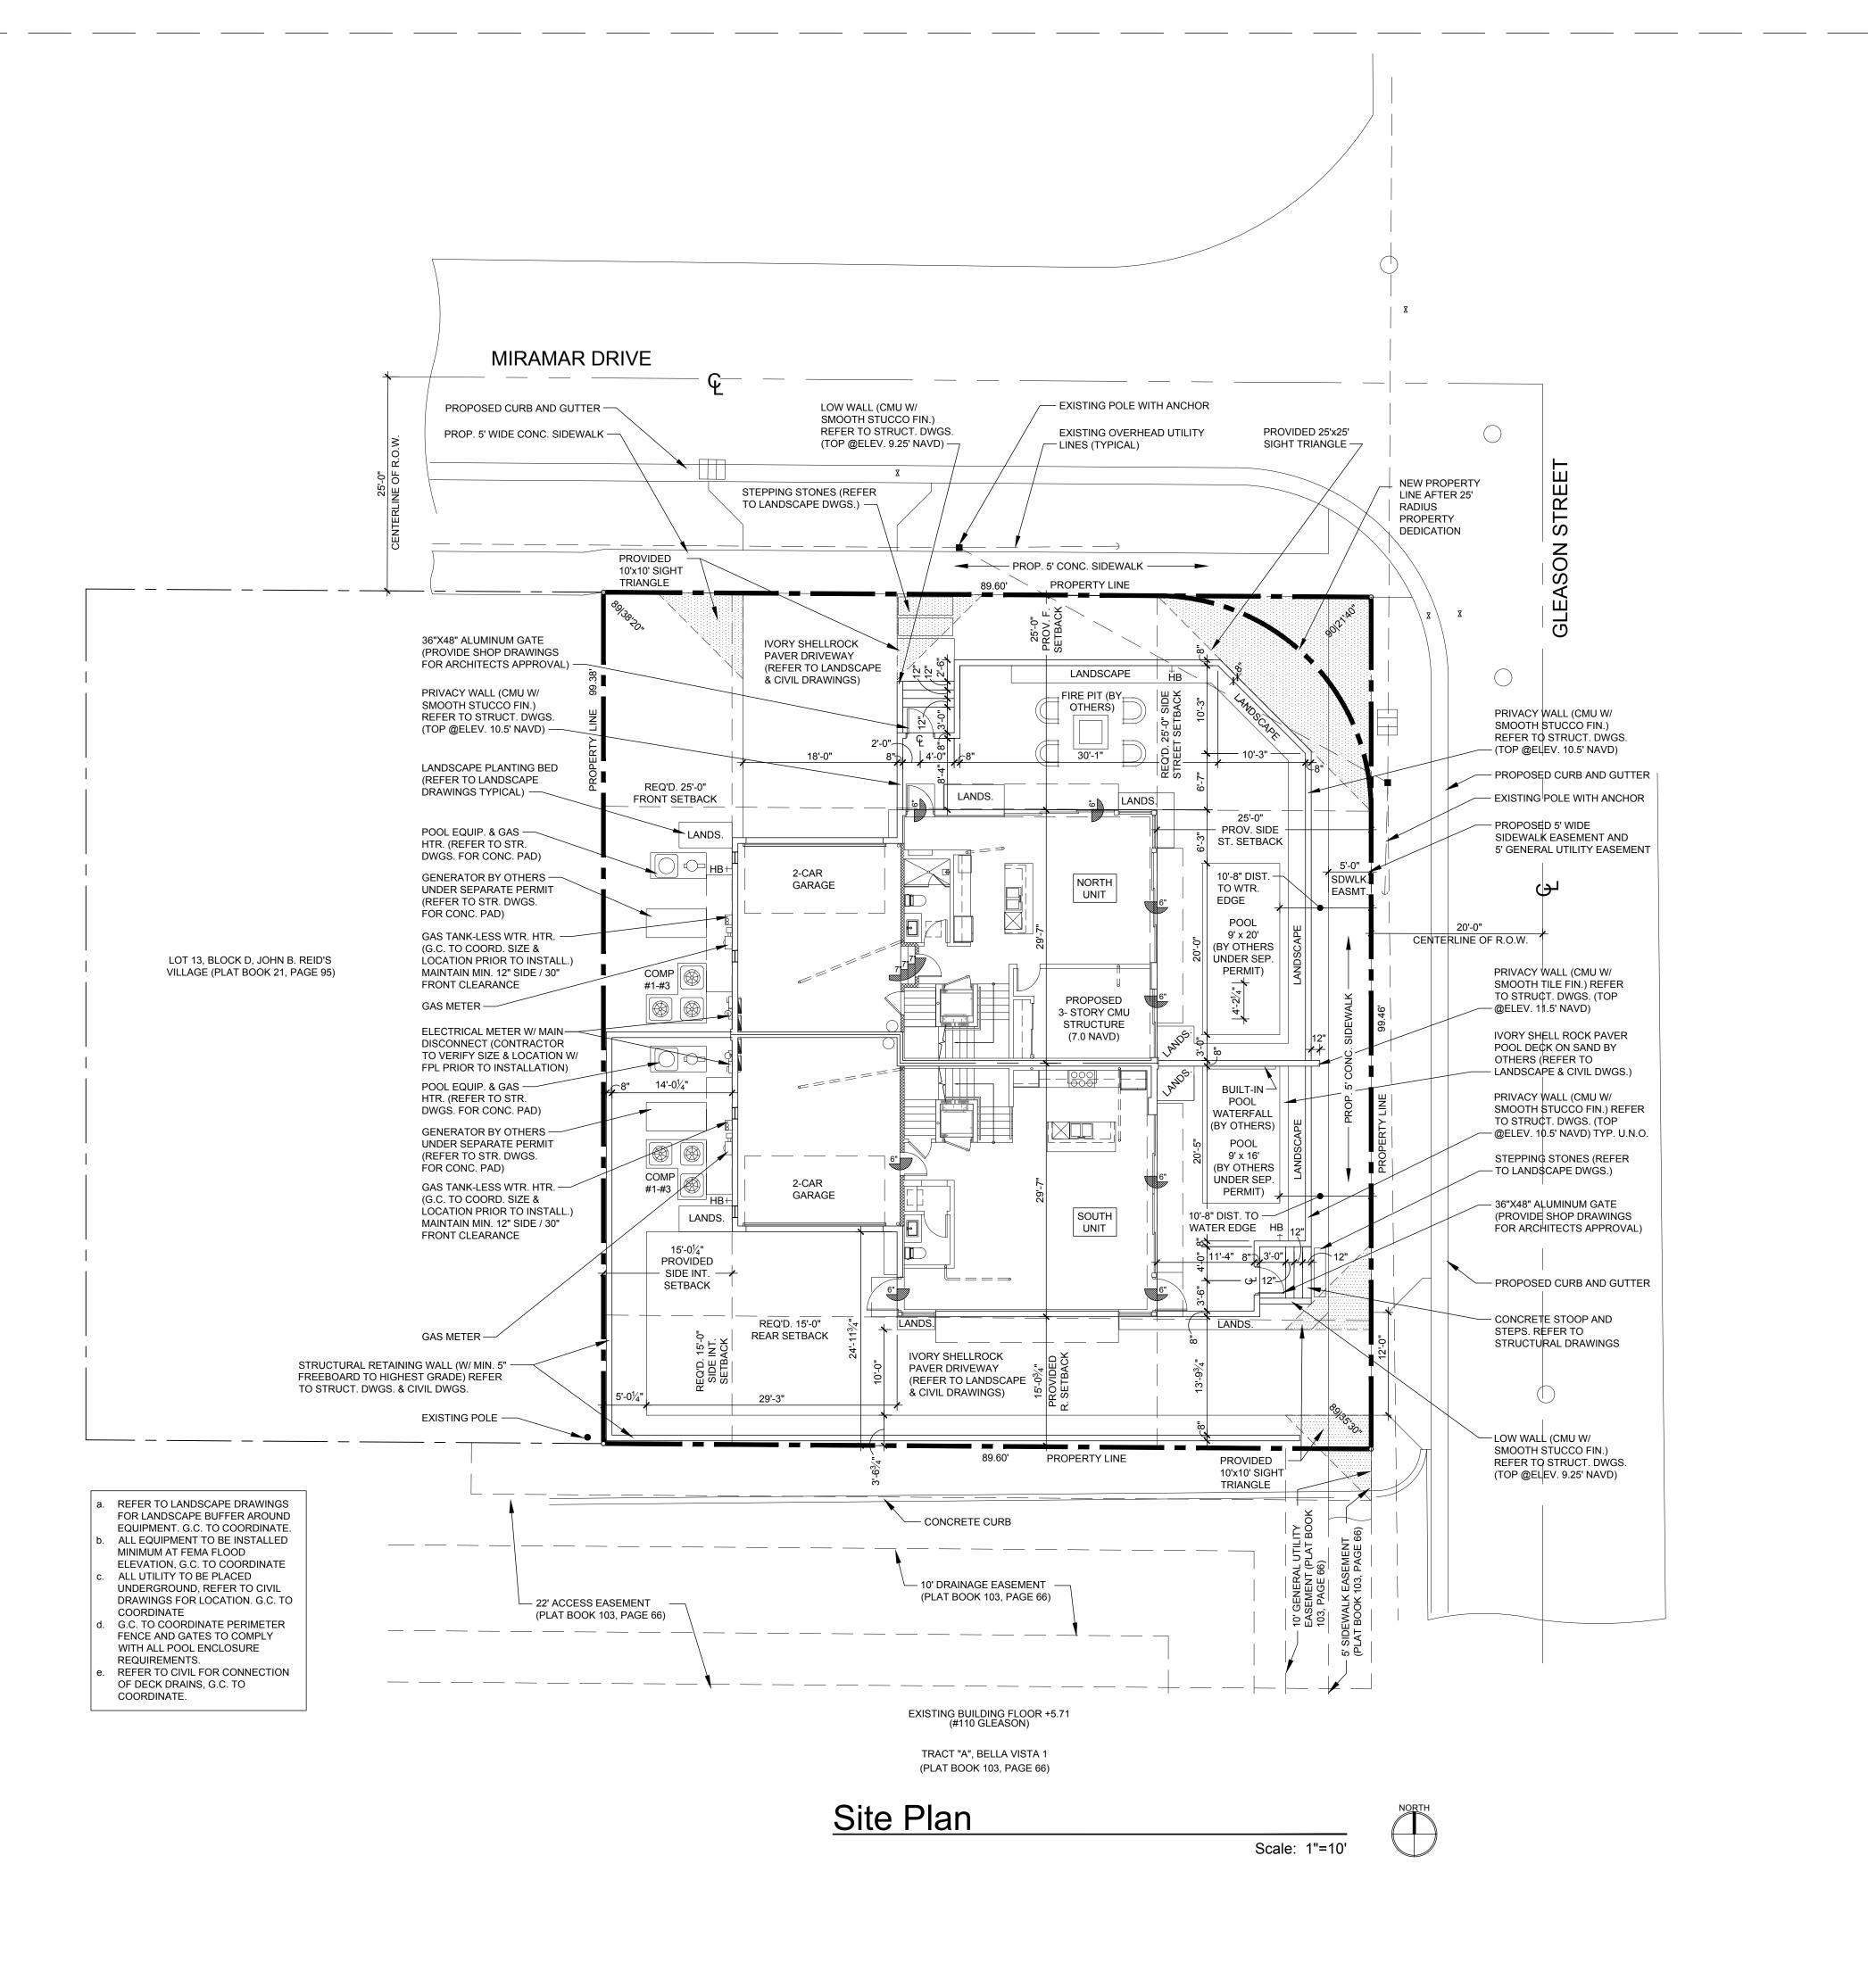

ARCHITECTURE 10 S.E. FIRST AVENUE | SUITE 102 DELRAY BEACH, FLORIDA 33444 V 561.274.9186 | F 561.274.9196 AA26001617 | IB26001056 WWW.RJARCHITECTURE.CC FLORIDA LICENSURE AA26001617 | IB26001056 COMMISSION # 17-05 DESIGNER: DRAWN BY: PLAN REVIEW: SUBMITTALS: CLASS V 10.25.19 SPECIAL SITE PLAN SUBMITTAL **REVISIONS: 5**P-1 35'-0" (FROM C. OF R.)

RICHARD JONES

LEGAL DESCRIPTION

THE EAST 89.6 FEET OF LOT 13, BLOCK D, JOHN B. REID'S VILLAGE, ACCORDING TO THE PLAT THEREOF, RECORDED IN PLAT BOOK 21, PAGE 95, OF THE PUBLIC RECORDS OF PALM BEACH COUNTY, FLORIDA.

BUILDING SETBACKS

	Required	Provided
Front Setback (North)	25'-0"	25'-0"
Rear Setback (South)	15'-0"	15'-0 3/4"
Side Interior Setback (West)	15'-0"	15'-0 1/4"
Side Street Setback (East)	25'-0"	25'-0"

Lot Frontage =

Building Height =

SITE DATA CHART

89.60'

35'-0"

	PROVIDED	REQUIRED	
Bldg Footprint =	2,680 SQ.FT.		
Imprevious Area =			
Pervious Area =			
Total Site Area =	8,908 SQ.FT.		SITE PLAN
Lot Coverage =	30%	40%	SIIE PLAN
% Impervious =			
% Pervious =			
%Open Space =		25% Non-Vehicular	
Lot Width =	89.60']
Lot Depth =	99.46'		I CD 1

KEY NOTES 48" REFRIGERATOR/FREEZER (REFER TO I.D. DRAWINGS). DOUBLE BOWL SINK w/ DISPOSAL (REFER TO I.D. DRAWINGS). 48" GAS RANGE w/ HOOD (REFER TO I.D. DRAWINGS). UNDER COUNTER MICROWAVE DRAWER (REFER TO ID DRAWINGS). 19'-3" DISHWASHER (REFER TO ID DRAWINGS). ELECTRIC CAR CHARGING STATION W/ DEDICATED CIRCUIT (G.C. TO COORD. W/ OWNER) $22'-10\frac{1}{2}"$ KITCHEN ISLAND w/ KNEE SPACE - COUNTER +36" A.F.F. (REFER TO I.D. DWGS.) 2" STRUCTURAL BUMP -- 2" STRUCTURAL BUMP 8. HOSE BIB (ALSO REFER TO SHEET SP-1 SITE PLAN FOR ADDITIONAL LOCATIONS). OUT @DEMISING WALL OUT @DEMISING WALL 9. WASHING MACHINE (REFER TO I.D. DRAWINGS). 10. DRYER - VENT TO EXTERIOR (REFER TO I.D. DRAWINGS). 11. UNDER COUNTER REFRIGERATOR (REFER TO I.D. DRAWINGS). 12. FLAT HEADER +8'-0" ABOVE FINISH FLOOR. 13. LAUNDRY SINK (REFER TO I.D. DRAWINGS). 14. LAVATORY (REFER TO I.D. DRAWINGS). 15. WATER CLOSET (REFER TO I.D. DRAWINGS) 16. MASONRY PARAPET +42" ABOVE FINISH ROOF DECK. 17. AIR HANDLER UNIT #1 W/ DUAL CONDENSATE OVERFLOW EMERG. SHUT OFF SENSORS. 18. AIR HANDLER UNIT #2 W/ DUAL CONDENSATE OVERFLOW EMERG. SHUT OFF SENSORS. 19. AIR HANDLER UNIT #3 W/ DUAL CONDENSATE OVERFLOW EMERG. SHUT OFF SENSORS. 20. FLOOR DRAIN. VERIFY LOCATION IN FIELD. SLOPE FLR. TO DRAIN 21. CONCRETE STEPS (REFER TO STRUCTURAL DRAWINGS). 22. R-11 INSULATION AND TYPE 'X' GYPSUM BOARD AT GARAGE CEILING. 23. R-11 INSULATION AT GARAGE WALL. 24. TEMP. GLS. SHWR. ENCLOS. (W/ TEMP. GLS. DOOR WHERE APPLICABLE) SEE I.D. DRAWINGS. 25. INTERIOR STAIR WITH RAILING SYSTEM - SEE ENLARGED STAIR DETAILS SHEET A-7.1 (REFER TO I.D. DRAWINGS) PROVIDE SHOP DRAWINGS FOR ARCHITECT'S REVIEW & APPROVAL. NOTE: SEE CAB. SHOP 26. PANTRY BUILT-IN (BY OTHERS - REFER TO I.D. DRAWINGS). DWGS. FOR FINAL CABINET NOTE: (2) VENT BLOCKS 27. BUILT-IN (BY OTHERS) SEE CABINET SHOP DRAWINGS FOR DIMENSIONS. STACKED VERTICALLY DIMENSIONS AND LAYOUT 28. ELECTRICAL PANEL IN G.W.B BUILT OUT (REFER TO ELEC. SHEETS E-1 THRU E-4). 29. DASHED LINE INDICATES BALCONY ABOVE. FINISH FLOOR 30. CANTILEVERED CONCRETE EYEBROW BELOW - SLOPE MAXIMUM 1/8" PER FOOT. 31. STRUCTURAL COLUMN (REFER TO STRUCTURAL DRAWINGS). 32. GAS METER. (5) 33. 6' PEDESTAL TUB (REFER TO I.D. DRAWINGS). 13'-10" 34. SHOWER (REFER TO I.D. DRAWINGS). 35. WET BAR SINK (REFER TO I.D. DRAWINGS). 36. POURED CONCRETE COLUMN. **NORTH** 37. 42" H. ALUM, RAILING SYSTEM W/ 3/4" SQ. HORIZ, TUBING W/ RECESSED MOUNTED POSTS SILVER POWDER COATED (PROVIDE SHOP DWGS. FOR ARCHITECT'S REVIEW & APPROVAL). 38. 12" VENTILATED WIRE SHELVING AND HANGING ROD. 39. 2" GARAGE DOOR RAIN RECESS (TYPICAL). 2-Car NOTE: 443 S.F. 40. NOMINAL STORM DRAIN ROUTE AT THIS FLOOR LEVEL. AREA SERVED Garage 41. FIRE SPRINKLER RISER LOCATION. BY (3) FLOOD Club Room 42. TANK-LESS GAS WATER HEATER (G.C. TO SIZE ACCORDINGLY). 19'-0" x 22'-0" **VENT BLOCKS** 43. NOMINAL STORM DRAIN ROUTE IN CEILING PLENUM FROM FLOOR ABOVE (DASHED LINE). CLG. HT: 11'-0" 22'-11" x 17'-2" 44. COUNTER +36" A.F.F. (REFER TO INTERIOR DESIGNER DRAWINGS). CLG. HT: 9'-4" 45. TERRACE / BALCONY WATER PROOFING & FLASHING SYSTEM - WATERPROOF CLEAR SEALER OVER TILE WITH THIN SET "LATICRETE" EPOXY GROUT OVER TREMCO 350/351 SYSTEM (OR EQUAL) SLOPE MINIMUM 1/8" PER FOOT (INSTALL PER MANUFACTURER'S SPECIFICATIONS) UNDERSIDE OF DECK MINIMUM 3" ICYNENE PRO SEAL INSULATION (AVG. R-19 INSULATION ENTIRE ASSEMBLY) WHERE TERRACE / BALCONY ENCLOSES A/C SPACE BELOW. Bedroom 46. 42" H. TEMP, SAFETY GLASS RAILING SYSTEM W/ ALUM, FRAME (TO REJECT 4" SPHERE) SILVER POWDER COATED (PROV. SHOP DWGS. FOR ARCHITECTS REVIEW & APPROVAL). 47. ELEC. METER W/ MAIN DISC. (G.C. TO VERIFY LOCATION W/ FPL PRIOR TO INSTALLATION) 13'-6" x 10'-6" COMP #2 COMP #1 CLG. HT: 9'-4" 48. 28" H. ALUM. RAILING SYSTEM W/ 3/4" SQ. HORIZ. TUBING W/ RECESSED MOUNTED POSTS ON 14" H. CONC. LOW WALL (PROVIDE SHOP DWGS. FOR ARCHITECT'S REVIEW & APPROVAL). 49. 22"x36" ACCESS PANEL (FOR EMERGENCY ACCESS TO ELEVATOR MOTOR). 13'-8" 50. SMART VENT FLOOD VENT BLOCKS (VENT MUST BE INSTALLED 0" TO 12" A.F.F. ENTIRE VENT MUST BE BELOW BASE FLOOD ELEVATION / DESIGN FLOOD ELEVATION). 51. 2" STRUCTURAL BUMP OUT. 52. NOMINAL ROUTE OF HVAC SUPPLY FROM AHU #1 ABOVE AT SECOND FLOOR. 53. 2-HOUR DEMISING WALL. 54. NOMINAL ROUTE OF HVAC SUPPLY FROM AHU #3 ABOVE AT APPURTENANCE FLOOR. 55. 13" HIGH MASONRY PARAPET. 56. ROOF DECK WATER DRAIN. **DEMISING WALL** 57. MASONRY KNEE WALL +42" ABOVE FINISH DECK. 58. MASONRY PRIVACY WALL +6'-4" ABOVE FINISH DECK. 59. FLUSH PANEL METAL GARAGE DOOR W/ PAINTED FINISH (PROVIDE SHOP DRAWINGS FOR ARCHITECT'S REVIEW & APPROVAL) REFER TO DOOR SCHEDULE. 60. MASONRY PRIVACY WALL +7'-2" ABV. FIN. DECK W/ COLOR COORD. ALUM. DRIP EDGE CAP. 61. ALUM. GATE (SEE SITE PLAN & DTL.) PROV. SHOP DWGS. FOR ARCH'S. REVIEW & APPROVAL. 62. PRE-FAB GAS FIRE PIT (BY OTHERS) G.C. TO COORD. W/ OWNER (REFER TO I.D. DRAWINGS). 15'-9" 63. OPTIONAL FREE STANDING SPA (BY OTHERS) G.C. TO COORDINATE W/ OWNER. 64. TRACTION ELEVATOR (BY OTHERS). 65. CENTRAL VACUUM SYSTEM (BY OTHERS) G.C. TO COORDINATE W/ OWNER 15'-8" x 9'-6" 66. 4" WIDE x 2" HIGH EMERGENCY OVERFLOW SCUPPER. CLG. HT: 9'-4" 67. DASHED LINE INDICATES EYEBROW ABOVE. 68. TERRACE / AMENITY DECK WATER DRAIN. 69. GENERATOR (BY OTHERS UNDER SEPARATE PERMIT) G.C. TO COORDINATE SIZING REQ'S. NOTE: 418 S.F. Garage AREA SERVED 70. EPOXY PAINT FINISH ON GARAGE FLOOR (G.C. TO COORDINATE W/ OWNER / I.D. DWGS.). 71. T.V. NICHE 4" INSET FROM FACE OF MASONRY WALL (G.C. TO COORD. SIZING W/ ELEC. SUB). BY (3) FLOOD 19'-0" x 22'-0" 72. 48" ELECTRIC / INDUCTION RANGE w/ HOOD (REFER TO I.D. DRAWINGS). VENT BLOCKS CLG. HT: 9'-10" (13) 73. GAS BARBECUE. 74. RAYNOR GLASS OVER HEAD DOOR (PROVIDE NOA AND SHOP DWGS. FOR ARCH'S. REVIEW & 07 04 APPROVAL) REFER TO DOOR SCHEDULE. 75. APPLIED PORCELAIN TILE OVER WATER PROOFING ON MASONRY WALL (G.C. TO COORDINATE FINISH SELECTION WITH OWNER) TYP. @2ND FLR. BALCONY END BUMP-OUTS. COMP #2 76. FASCIA BOARD CONCEALED DRAPERY POCKET (REFER TO I.D. DRAWINGS). 77. STRUCT. COL. CLAD IN CLEAR ANODIZED ALUM. TO MATCH WINDOW (SEE STRUCT. DWGS.). NOTE: SEE CAB. SHOP 78. SHOWER SEAT +22" A.F.F. (REFER TO INTERIOR DRAWINGS). DWGS. FOR FINAL CABINE Dining **DIMENSIONS AND LAYOUT** NOTES CLG. HT: 9'-4" 23'-0" ALL FINISHES AND PAINT COLORS SHALL BE SELECTED BY INTERIOR DESIGNER. NOTE: (2) VENT BLOCKS 59 5/8" THICK DENS-SHIELD SHALL BE INSTALLED IN LIEU OF GYPSUM BD. @ ALL WET AREAS. 50 STACKED VERTICALLY **Great Room** MIRRORS SHALL BE INSTALLED OVER ALL VANITIES. HEIGHT & WIDTH SHALL BE DETERMINED BY INTERIOR DESIGNER. 22'-11" x 18'-8" 4. ALL EXPOSED GYP. BD. WALLS AND CEILING SHALL RECEIVE 2 COATS OF FLAT LATEX PAINT CLG. HT: 9'-4" (3) AS MANUF. BY SHERWIN WILLIAMS OR EQUAL. ALL INTERIOR WOOD, DOORS, BASE OR TRIM SHALL RECEIVE 2 COATS OF SEMI-GLOSS CLG. HT: LATEX PAINT AS MANUF. BY SHERWIN WILLIAMS OR EQUAL. SOUTH FINISH FOR CLOSETS SHALL BE SAME AS FINISH OF ROOM CLOSET IS IN (U.O.N.). ALL KITCHEN, LAUNDRY ROOM, FINISHED BATHROOMS & POWDER ROOMS SHALL HAVE UNIT IMPERVIOUS FLOORING & BASE. NOTE: ALL WINDOWS NOTED AS EGRESS WINDOWS SHALL COMPLY WITH F.B.C. SILL HEIGHT SHALL NOT EXCEED 44' A.F.F. MIN. OPG. HT. SHALL BE 24" AND MIN OPG. WIDTH SHALL BE 20". MIN. CLEAR OPEN AREA SHALL BE 5.7 SQ. FT. (5.0 SQ FT. @ 1ST FLOOR) WALL HATCH SCHEDULE Foyer FINISH FLOOR ELEV: 0'-0" CLG. HT: 9'-4" DENOTES SOUND ATTENUATION INSULATION WITHIN WALL DENOTES R-11 BATT INSULATION WITHIN WALL NORTH UNIT BUILDING AREA CALCULATIONS GROUND FLOOR A/C 886 SQ.F1 SECOND FLOOR A/C 1,322 SQ.FT THIRD FLOOR A/C 694 SQ.FT APPURTENANCE A/C 145 SQ.FT TOTAL A/C 3,047 SQ.FT 2" STRUCTURAL BUMP 2" STRUCTURAL BUMP GARAGE 452 SQ.FT OUT @DEMISING WALL — OUT @DEMISING WALL 19'-3" BALCONIES 560 SQ.FT **TERRACE** 472 SQ.FT 19'-3" 30'-4" 4,531 SQ.FT TOTAL BUILDING FLOOR AREA SOUTH UNIT BUILDING AREA CALCULATIONS 49'-11" O.A. BLDG GROUND FLOOR A/C SECOND FLOOR A/C 1,324 SQ.FT THIRD FLOOR A/C 680 SQ.FT APPURTENANCE A/C 175 SQ.FT. TOTAL A/C Ground Floor Plan 3,068 SQ.FT


452 SQ.FT

565 SQ.FT

427 SQ.FT. 4,512 SQ.FT.

GARAGE BALCONIES

TERRACE

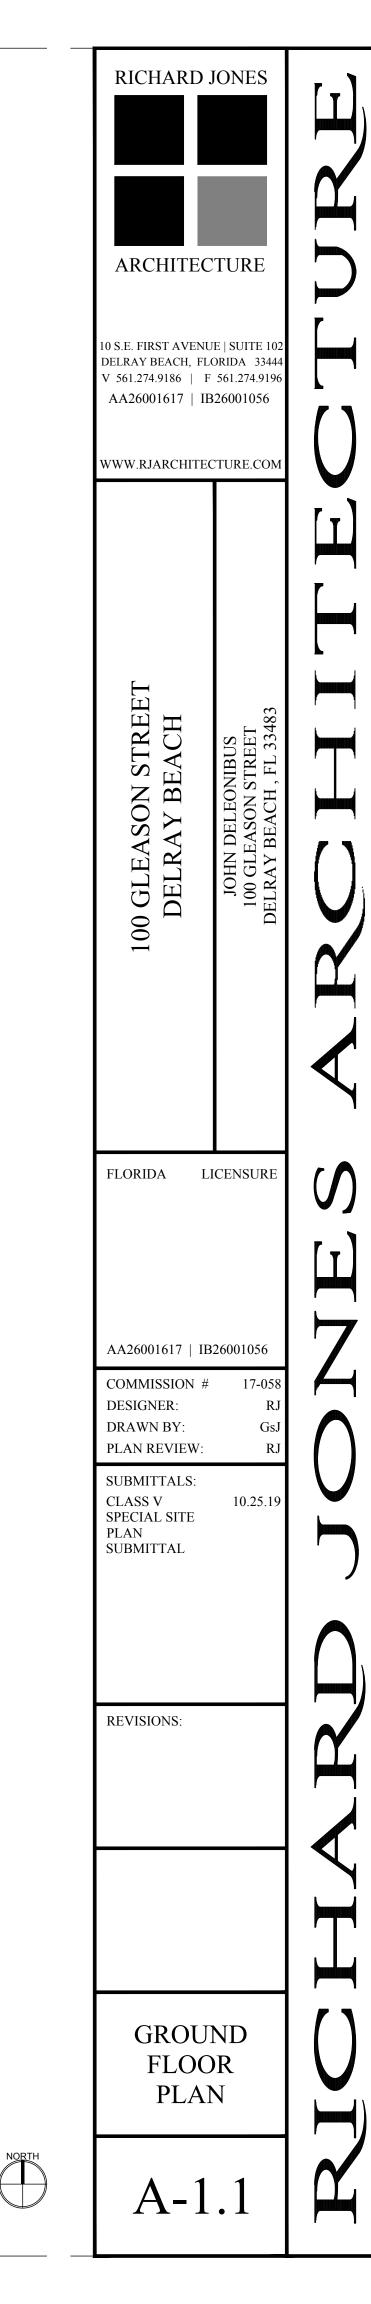

KEY NOTES 48" REFRIGERATOR/FREEZER (REFER TO I.D. DRAWINGS). DOUBLE BOWL SINK w/ DISPOSAL (REFER TO I.D. DRAWINGS). 48" GAS RANGE w/ HOOD (REFER TO I.D. DRAWINGS). UNDER COUNTER MICROWAVE DRAWER (REFER TO ID DRAWINGS). DISHWASHER (REFER TO ID DRAWINGS). ELECTRIC CAR CHARGING STATION W/ DEDICATED CIRCUIT (G.C. TO COORD. W/ OWNER) KITCHEN ISLAND w/ KNEE SPACE - COUNTER +36" A.F.F. (REFER TO I.D. DWGS.) HOSE BIB (ALSO REFER TO SHEET SP-1 SITE PLAN FOR ADDITIONAL LOCATIONS). 9. WASHING MACHINE (REFER TO I.D. DRAWINGS). 10. DRYER - VENT TO EXTERIOR (REFER TO I.D. DRAWINGS). 11. UNDER COUNTER REFRIGERATOR (REFER TO I.D. DRAWINGS). 12. FLAT HEADER +8'-0" ABOVE FINISH FLOOR. 13. LAUNDRY SINK (REFER TO I.D. DRAWINGS). 14. LAVATORY (REFER TO I.D. DRAWINGS). 15. WATER CLOSET (REFER TO I.D. DRAWINGS) 16. MASONRY PARAPET +42" ABOVE FINISH ROOF DECK. 17. AIR HANDLER UNIT #1 W/ DUAL CONDENSATE OVERFLOW EMERG. SHUT OFF SENSORS. 18. AIR HANDLER UNIT #2 W/ DUAL CONDENSATE OVERFLOW EMERG. SHUT OFF SENSORS. 19. AIR HANDLER UNIT #3 W/ DUAL CONDENSATE OVERFLOW EMERG. SHUT OFF SENSORS. 20. FLOOR DRAIN. VERIFY LOCATION IN FIELD. SLOPE FLR. TO DRAIN 21. CONCRETE STEPS (REFER TO STRUCTURAL DRAWINGS). 22. R-11 INSULATION AND TYPE 'X' GYPSUM BOARD AT GARAGE CEILING. 23. R-11 INSULATION AT GARAGE WALL. 24. TEMP. GLS. SHWR. ENCLOS. (W/ TEMP. GLS. DOOR WHERE APPLICABLE) SEE I.D. DRAWINGS. 25. INTERIOR STAIR WITH RAILING SYSTEM - SEE ENLARGED STAIR DETAILS SHEET A-7.1 (REFER TO I.D. DRAWINGS) PROVIDE SHOP DRAWINGS FOR ARCHITECT'S REVIEW & APPROVAL. 26. PANTRY BUILT-IN (BY OTHERS - REFER TO I.D. DRAWINGS). 27. BUILT-IN (BY OTHERS) SEE CABINET SHOP DRAWINGS FOR DIMENSIONS. 28. ELECTRICAL PANEL IN G.W.B BUILT OUT (REFER TO ELEC. SHEETS E-1 THRU E-4). 29. DASHED LINE INDICATES BALCONY ABOVE. 30. CANTILEVERED CONCRETE EYEBROW BELOW - SLOPE MAXIMUM 1/8" PER FOOT. 31. STRUCTURAL COLUMN (REFER TO STRUCTURAL DRAWINGS). 32. GAS METER. 33. 6' PEDESTAL TUB (REFER TO I.D. DRAWINGS). 34. SHOWER (REFER TO I.D. DRAWINGS). 35. WET BAR SINK (REFER TO I.D. DRAWINGS). 36. POURED CONCRETE COLUMN. 37. 42" H. ALUM. RAILING SYSTEM W/ 3/4" SQ. HORIZ. TUBING W/ RECESSED MOUNTED POSTS 38. 12" VENTILATED WIRE SHELVING AND HANGING ROD. 39. 2" GARAGE DOOR RAIN RECESS (TYPICAL).

SILVER POWDER COATED (PROVIDE SHOP DWGS. FOR ARCHITECT'S REVIEW & APPROVAL).

40. NOMINAL STORM DRAIN ROUTE AT THIS FLOOR LEVEL. 41. FIRE SPRINKLER RISER LOCATION. 42. TANK-LESS GAS WATER HEATER (G.C. TO SIZE ACCORDINGLY). 43. NOMINAL STORM DRAIN ROUTE IN CEILING PLENUM FROM FLOOR ABOVE (DASHED LINE).

44. COUNTER +36" A.F.F. (REFER TO INTERIOR DESIGNER DRAWINGS).

45. TERRACE / BALCONY WATER PROOFING & FLASHING SYSTEM - WATERPROOF CLEAR SEALER OVER TILE WITH THIN SET "LATICRETE" EPOXY GROUT OVER TREMCO 350/351 SYSTEM (OR EQUAL) SLOPE MINIMUM 1/8" PER FOOT (INSTALL PER MANUFACTURER'S SPECIFICATIONS) UNDERSIDE OF DECK MINIMUM 3" ICYNENE PRO SEAL INSULATION (AVG. R-19 INSULATION ENTIRE ASSEMBLY) WHERE TERRACE / BALCONY ENCLOSES A/C SPACE BELOW. 46. 42" H. TEMP. SAFETY GLASS RAILING SYSTEM W/ ALUM. FRAME (TO REJECT 4" SPHERE)

SILVER POWDER COATED (PROV. SHOP DWGS. FOR ARCHITECTS REVIEW & APPROVAL).
47. ELEC. METER W/ MAIN DISC. (G.C. TO VERIFY LOCATION W/ FPL PRIOR TO INSTALLATION) 48. 28" H. ALUM. RAILING SYSTEM W/ 3/4" SQ. HORIZ. TUBING W/ RECESSED MOUNTED POSTS ON 14" H. CONC. LOW WALL (PROVIDE SHOP DWGS. FOR ARCHITECT'S REVIEW & APPROVAL).

49. 22"x36" ACCESS PANEL (FOR EMERGENCY ACCESS TO ELEVATOR MOTOR). 50. SMART VENT FLOOD VENT BLOCKS (VENT MUST BE INSTALLED 0" TO 12" A.F.F. ENTIRE VENT MUST BE BELOW BASE FLOOD ELEVATION / DESIGN FLOOD ELEVATION). 51. 2" STRUCTURAL BUMP OUT.

52. NOMINAL ROUTE OF HVAC SUPPLY FROM AHU #1 ABOVE AT SECOND FLOOR. 53. 2-HOUR DEMISING WALL.

54. NOMINAL ROUTE OF HVAC SUPPLY FROM AHU #3 ABOVE AT APPURTENANCE FLOOR. 55. 13" HIGH MASONRY PARAPET.

56. ROOF DECK WATER DRAIN.

57. MASONRY KNEE WALL +42" ABOVE FINISH DECK. 58. MASONRY PRIVACY WALL +6'-4" ABOVE FINISH DECK.

59. FLUSH PANEL METAL GARAGE DOOR W/ PAINTED FINISH (PROVIDE SHOP

DRAWINGS FOR ARCHITECT'S REVIEW & APPROVAL) REFER TO DOOR SCHEDULE. 60. MASONRY PRIVACY WALL +7'-2" ABV. FIN. DECK W/ COLOR COORD. ALUM. DRIP EDGE CAP.

61. ALUM. GATE (SEE SITE PLAN & DTL.) PROV. SHOP DWGS. FOR ARCH'S. REVIEW & APPROVAL. 62. PRE-FAB GAS FIRE PIT (BY OTHERS) G.C. TO COORD. W/ OWNER (REFER TO I.D. DRAWINGS).

63. OPTIONAL FREE STANDING SPA (BY OTHERS) G.C. TO COORDINATE W/ OWNER. 64. TRACTION ELEVATOR (BY OTHERS). 65. CENTRAL VACUUM SYSTEM (BY OTHERS) G.C. TO COORDINATE W/ OWNER.

66. 4" WIDE x 2" HIGH EMERGENCY OVERFLOW SCUPPER. 67. DASHED LINE INDICATES EYEBROW ABOVE.

68. TERRACE / AMENITY DECK WATER DRAIN.

69. GENERATOR (BY OTHERS UNDER SEPARATE PERMIT) G.C. TO COORDINATE SIZING REQ'S. 70. EPOXY PAINT FINISH ON GARAGE FLOOR (G.C. TO COORDINATE W/ OWNER / I.D. DWGS.).

71. T.V. NICHE 4" INSET FROM FACE OF MASONRY WALL (G.C. TO COORD. SIZING W/ ELEC. SUB). 72. 48" ELECTRIC / INDUCTION RANGE w/ HOOD (REFER TO I.D. DRAWINGS). 73. GAS BARBECUE.

APPROVAL) REFER TO DOOR SCHEDULE.

74. RAYNOR GLASS OVER HEAD DOOR (PROVIDE NOA AND SHOP DWGS. FOR ARCH'S. REVIEW & 75. APPLIED PORCELAIN TILE OVER WATER PROOFING ON MASONRY WALL (G.C. TO

COORDINATE FINISH SELECTION WITH OWNER) TYP. @2ND FLR. BALCONY END BUMP-OUTS. 76. FASCIA BOARD CONCEALED DRAPERY POCKET (REFER TO I.D. DRAWINGS). 77. STRUCT. COL. CLAD IN CLEAR ANODIZED ALUM. TO MATCH WINDOW (SEE STRUCT. DWGS.).

78. SHOWER SEAT +22" A.F.F. (REFER TO INTERIOR DRAWINGS).

NOTES

ALL FINISHES AND PAINT COLORS SHALL BE SELECTED BY INTERIOR DESIGNER. 5/8" THICK DENS-SHIELD SHALL BE INSTALLED IN LIEU OF GYPSUM BD. @ ALL WET AREAS. MIRRORS SHALL BE INSTALLED OVER ALL VANITIES. HEIGHT & WIDTH SHALL BE DETERMINED BY INTERIOR DESIGNER.

4. ALL EXPOSED GYP. BD. WALLS AND CEILING SHALL RECEIVE 2 COATS OF FLAT LATEX PAINT AS MANUF. BY SHERWIN WILLIAMS OR EQUAL.

5. ALL INTERIOR WOOD, DOORS, BASE OR TRIM SHALL RECEIVE 2 COATS OF SEMI-GLOSS LATEX PAINT AS MANUF. BY SHERWIN WILLIAMS OR EQUAL.

FINISH FOR CLOSETS SHALL BE SAME AS FINISH OF ROOM CLOSET IS IN (U.O.N.). ALL KITCHEN, LAUNDRY ROOM, FINISHED BATHROOMS & POWDER ROOMS SHALL HAVE IMPERVIOUS FLOORING & BASE.

NOTE: ALL WINDOWS NOTED AS EGRESS WINDOWS SHALL COMPLY WITH F.B.C. SILL HEIGHT SHALL NOT EXCEED 44' A.F.F. MIN. OPG. HT. SHALL BE 24" AND MIN OPG. WIDTH SHALL BE 20". MIN. CLEAR OPEN AREA SHALL BE 5.7 SQ. FT. (5.0 SQ FT. @ 1ST FLOOR)


WALL HATCH SCHEDULE

DENOTES SOUND ATTENUATION INSULATION WITHIN WALL

DENOTES R-11 BATT INSULATION WITHIN WALL

NORTH UNIT BUILDING AREA CALCULATIONS

GROUND FLOOR A/C	886 SQ.F
SECOND FLOOR A/C	1,322 SQ.F
THIRD FLOOR A/C	694 SQ.F
APPURTENANCE A/C	145 SQ.F
TOTAL A/C	3,047 SQ.F
GARAGE	452 SQ.F
BALCONIES	560 SQ.F
TERRACE	472 SQ.F
TOTAL BUILDING FLOOR AREA	4,531 SQ.F
SOUTH UNIT BUILDING AR	EA CALCULATIONS
GROUND FLOOR A/C	889 SQ.F
SECOND FLOOR A/C	1,324 SQ.F
THIRD FLOOR A/C	680 SQ.F
APPURTENANCE A/C	175 SQ.F
TOTAL A/C	3,068 SQ.F
GARAGE	452 SQ.F
BALCONIES	565 SQ.F
TERRACE	427 SQ.F
TOTAL BUILDING ELOOP AREA	4.540.00.5

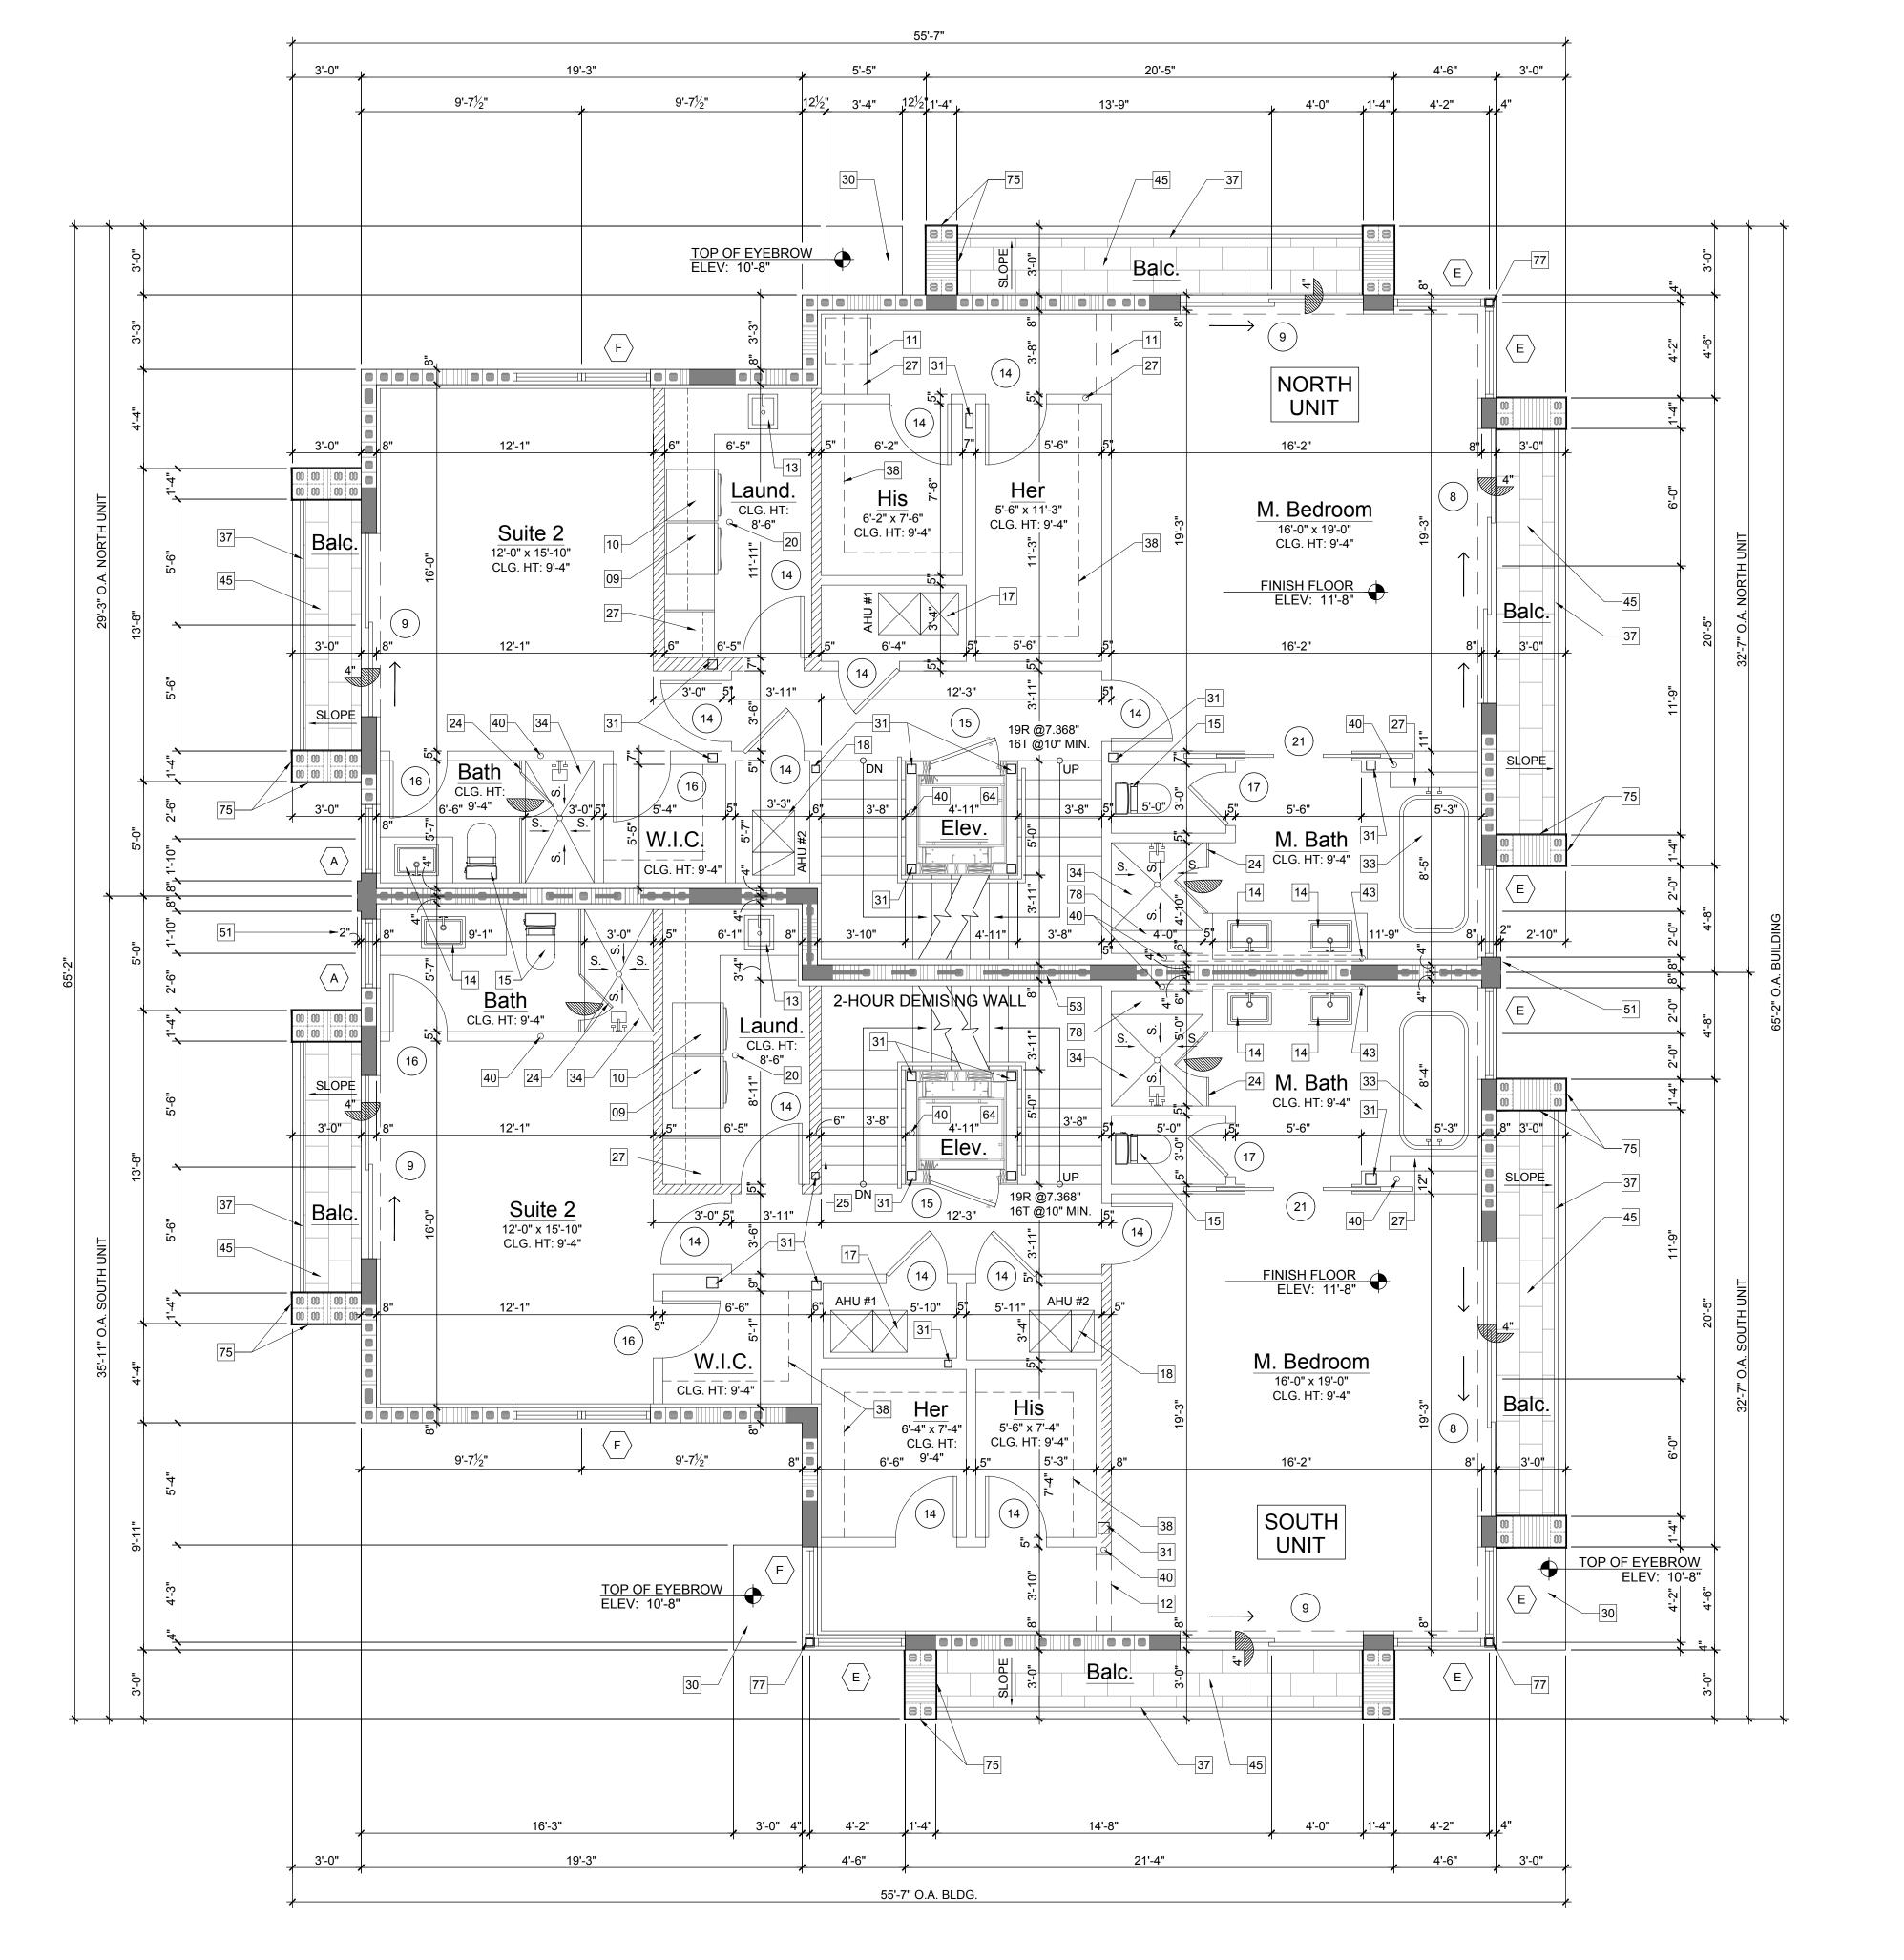

Second Floor Plan

AA26001617 | IB26001056 COMMISSION # DESIGNER: DRAWN BY: PLAN REVIEW: SUBMITTALS: CLASS V SPECIAL SITE PLAN SUBMITTAL **REVISIONS: SECOND FLOOR PLAN A-**]

RICHARD JONES

ARCHITECTURE

10 S.E. FIRST AVENUE | SUITE 102

DELRAY BEACH, FLORIDA 3344

/ 561.274.9186 | F 561.274.9190

AA26001617 | IB26001056

WWW.RJARCHITECTURE.CC

GLEASON ST DELRAY BEA

FLORIDA LICENSURI

KEY NOTES 48" REFRIGERATOR/FREEZER (REFER TO I.D. DRAWINGS). DOUBLE BOWL SINK w/ DISPOSAL (REFER TO I.D. DRAWINGS). 48" GAS RANGE w/ HOOD (REFER TO I.D. DRAWINGS). UNDER COUNTER MICROWAVE DRAWER (REFER TO ID DRAWINGS). DISHWASHER (REFER TO ID DRAWINGS). ELECTRIC CAR CHARGING STATION W/ DEDICATED CIRCUIT (G.C. TO COORD. W/ OWNER) KITCHEN ISLAND w/ KNEE SPACE - COUNTER +36" A.F.F. (REFER TO I.D. DWGS.) HOSE BIB (ALSO REFER TO SHEET SP-1 SITE PLAN FOR ADDITIONAL LOCATIONS). 9. WASHING MACHINE (REFER TO I.D. DRAWINGS). 10. DRYER - VENT TO EXTERIOR (REFER TO I.D. DRAWINGS). 11. UNDER COUNTER REFRIGERATOR (REFER TO I.D. DRAWINGS). 12. FLAT HEADER +8'-0" ABOVE FINISH FLOOR. 13. LAUNDRY SINK (REFER TO I.D. DRAWINGS). 14. LAVATORY (REFER TO I.D. DRAWINGS). 15. WATER CLOSET (REFER TO I.D. DRAWINGS) 16. MASONRY PARAPET +42" ABOVE FINISH ROOF DECK. 17. AIR HANDLER UNIT #1 W/ DUAL CONDENSATE OVERFLOW EMERG. SHUT OFF SENSORS. 18. AIR HANDLER UNIT #2 W/ DUAL CONDENSATE OVERFLOW EMERG. SHUT OFF SENSORS. 19. AIR HANDLER UNIT #3 W/ DUAL CONDENSATE OVERFLOW EMERG. SHUT OFF SENSORS. 20. FLOOR DRAIN. VERIFY LOCATION IN FIELD. SLOPE FLR. TO DRAIN 21. CONCRETE STEPS (REFER TO STRUCTURAL DRAWINGS). 22. R-11 INSULATION AND TYPE 'X' GYPSUM BOARD AT GARAGE CEILING. 23. R-11 INSULATION AT GARAGE WALL. 24. TEMP. GLS. SHWR. ENCLOS. (W/ TEMP. GLS. DOOR WHERE APPLICABLE) SEE I.D. DRAWINGS. 25. INTERIOR STAIR WITH RAILING SYSTEM - SEE ENLARGED STAIR DETAILS SHEET A-7.1 (REFER TO I.D. DRAWINGS) PROVIDE SHOP DRAWINGS FOR ARCHITECT'S REVIEW & APPROVAL.

26. PANTRY BUILT-IN (BY OTHERS - REFER TO I.D. DRAWINGS)

31. STRUCTURAL COLUMN (REFER TO STRUCTURAL DRAWINGS).

29. DASHED LINE INDICATES BALCONY ABOVE.

33. 6' PEDESTAL TUB (REFER TO I.D. DRAWINGS).

39. 2" GARAGE DOOR RAIN RECESS (TYPICAL).

38. 12" VENTILATED WIRE SHELVING AND HANGING ROD.

40. NOMINAL STORM DRAIN ROUTE AT THIS FLOOR LEVEL.

42. TANK-LESS GAS WATER HEATER (G.C. TO SIZE ACCORDINGLY).

44. COUNTER +36" A.F.F. (REFER TO INTERIOR DESIGNER DRAWINGS).

34. SHOWER (REFER TO I.D. DRAWINGS).
35. WET BAR SINK (REFER TO I.D. DRAWINGS).

41. FIRE SPRINKLER RISER LOCATION.

51. 2" STRUCTURAL BUMP OUT.

55. 13" HIGH MASONRY PARAPET.

64. TRACTION ELEVATOR (BY OTHERS).

67. DASHED LINE INDICATES EYEBROW ABOVE.68. TERRACE / AMENITY DECK WATER DRAIN.

APPROVAL) REFER TO DOOR SCHEDULE.

57. MASONRY KNEE WALL +42" ABOVE FINISH DECK.58. MASONRY PRIVACY WALL +6'-4" ABOVE FINISH DECK.

66. 4" WIDE x 2" HIGH EMERGENCY OVERFLOW SCUPPER.

56. ROOF DECK WATER DRAIN.

73. GAS BARBECUE.

53. 2-HOUR DEMISING WALL

36. POURED CONCRETE COLUMN.

32. GAS METER.

27. BUILT-IN (BY OTHERS) SEE CABINET SHOP DRAWINGS FOR DIMENSIONS.

28. ELECTRICAL PANEL IN G.W.B BUILT OUT (REFER TO ELEC. SHEETS E-1 THRU E-4).

30. CANTILEVERED CONCRETE EYEBROW BELOW - SLOPE MAXIMUM 1/8" PER FOOT.

37. 42" H. ALUM. RAILING SYSTEM W/ 3/4" SQ. HORIZ. TUBING W/ RECESSED MOUNTED POSTS SILVER POWDER COATED (PROVIDE SHOP DWGS. FOR ARCHITECT'S REVIEW & APPROVAL).

43. NOMINAL STORM DRAIN ROUTE IN CEILING PLENUM FROM FLOOR ABOVE (DASHED LINE).

ENTIRE ASSEMBLY) WHERE TERRACE / BALCONY ENCLOSES A/C SPACE BELOW.

46. 42" H. TEMP. SAFETY GLASS RAILING SYSTEM W/ ALUM. FRAME (TO REJECT 4" SPHERE)
SILVER POWDER COATED (PROV. SHOP DWGS. FOR ARCHITECTS REVIEW & APPROVAL).

47. ELEC. METER W/ MAIN DISC. (G.C. TO VERIFY LOCATION W/ FPL PRIOR TO INSTALLATION)

49. 22"x36" ACCESS PANEL (FOR EMERGENCY ACCESS TO ELEVATOR MOTOR).

MUST BE BELOW BASE FLOOD ELEVATION / DESIGN FLOOD ELEVATION).

52. NOMINAL ROUTE OF HVAC SUPPLY FROM AHU #1 ABOVE AT SECOND FLOOR.

59. FLUSH PANEL METAL GARAGE DOOR W/ PAINTED FINISH (PROVIDE SHOP

54. NOMINAL ROUTE OF HVAC SUPPLY FROM AHU #3 ABOVE AT APPURTENANCE FLOOR.

DRAWINGS FOR ARCHITECT'S REVIEW & APPROVAL) REFER TO DOOR SCHEDULE.

63. OPTIONAL FREE STANDING SPA (BY OTHERS) G.C. TO COORDINATE W/ OWNER.

75. APPLIED PORCELAIN TILE OVER WATER PROOFING ON MASONRY WALL (G.C. TO

76. FASCIA BOARD CONCEALED DRAPERY POCKET (REFER TO I.D. DRAWINGS).

65. CENTRAL VACUUM SYSTEM (BY OTHERS) G.C. TO COORDINATE W/ OWNER.

72. 48" ELECTRIC / INDUCTION RANGE w/ HOOD (REFER TO I.D. DRAWINGS).

60. MASONRY PRIVACY WALL +7'-2" ABV. FIN. DECK W/ COLOR COORD. ALUM. DRIP EDGE CAP.

69. GENERATOR (BY OTHERS UNDER SEPARATE PERMIT) G.C. TO COORDINATE SIZING REQ'S.
70. EPOXY PAINT FINISH ON GARAGE FLOOR (G.C. TO COORDINATE W/ OWNER / I.D. DWGS.).
71. T.V. NICHE 4" INSET FROM FACE OF MASONRY WALL (G.C. TO COORD. SIZING W/ ELEC. SUB).

74. RAYNOR GLASS OVER HEAD DOOR (PROVIDE NOA AND SHOP DWGS. FOR ARCH'S. REVIEW &

COORDINATE FINISH SELECTION WITH OWNER) TYP. @2ND FLR. BALCONY END BUMP-OUTS.

61. ALUM. GATE (SEE SITE PLAN & DTL.) PROV. SHOP DWGS. FOR ARCH'S. REVIEW & APPROVAL. 62. PRE-FAB GAS FIRE PIT (BY OTHERS) G.C. TO COORD. W/ OWNER (REFER TO I.D. DRAWINGS).

45. TERRACE / BALCONY WATER PROOFING & FLASHING SYSTEM - WATERPROOF CLEAR SEALER

OVER TILE WITH THIN SET "LATICRETE" EPOXY GROUT OVER TREMCO 350/351 SYSTEM (OR EQUAL) SLOPE MINIMUM 1/8" PER FOOT (INSTALL PER MANUFACTURER'S SPECIFICATIONS) UNDERSIDE OF DECK MINIMUM 3" ICYNENE PRO SEAL INSULATION (AVG. R-19 INSULATION

48. 28" H. ALUM. RAILING SYSTEM W/ 3/4" SQ. HORIZ. TUBING W/ RECESSED MOUNTED POSTS ON

14" H. CONC. LOW WALL (PROVIDE SHOP DWGS. FOR ARCHITECT'S REVIEW & APPROVAL).

50. SMART VENT FLOOD VENT BLOCKS (VENT MUST BE INSTALLED 0" TO 12" A.F.F. ENTIRE VENT

77. STRUCT. COL. CLAD IN CLEAR ANODIZED ALUM. TO MATCH WINDOW (SEE STRUCT. DWGS.).
78. SHOWER SEAT +22" A.F.F. (REFER TO INTERIOR DRAWINGS).

NOTES

ALL FINISHES AND PAINT COLORS SHALL BE SELECTED BY INTERIOR DESIGNER.
 5/8" THICK DENS-SHIELD SHALL BE INSTALLED IN LIEU OF GYPSUM BD. @ ALL WET AREAS.
 MIRRORS SHALL BE INSTALLED OVER ALL VANITIES. HEIGHT & WIDTH SHALL BE DETERMINED BY INTERIOR DESIGNER.
 ALL EXPOSED GYP. BD. WALLS AND CEILING SHALL RECEIVE 2 COATS OF FLAT LATEX PAINT

AS MANUF. BY SHERWIN WILLIAMS OR EQUAL.

5. ALL INTERIOR WOOD, DOORS, BASE OR TRIM SHALL RECEIVE 2 COATS OF SEMI-GLOSS LATEX PAINT AS MANUF. BY SHERWIN WILLIAMS OR EQUAL.

 FINISH FOR CLOSETS SHALL BE SAME AS FINISH OF ROOM CLOSET IS IN (U.O.N.).
 ALL KITCHEN, LAUNDRY ROOM, FINISHED BATHROOMS & POWDER ROOMS SHALL HAVE IMPERVIOUS FLOORING & BASE.

NOTE: ALL WINDOWS NOTED AS EGRESS WINDOWS SHALL COMPLY WITH F.B.C. SILL HEIGHT SHALL NOT EXCEED 44' A.F.F. MIN. OPG. HT. SHALL BE 24" AND MIN OPG. WIDTH SHALL BE 20". MIN. CLEAR OPEN AREA SHALL BE 5.7 SQ. FT. (5.0 SQ FT. @ 1ST FLOOR)

WALL HATCH SCHEDULE

DENOTES SOUND ATTENUATION INSULATION WITHIN WALL

DENOTES R-11 BATT INSULATION WITHIN WALL

	DENOTES R-11 BATT INSOLATION WITHIN WALL	
NORTH UNIT BUILDING AREA CALCULATIONS		
GROUND FLOOR A/C	886 SQ.F	
SECOND FLOOR A/C	1,322 SQ.F	
THIRD FLOOR A/C	694 SQ.F	
APPURTENANCE A/C	145 SQ.F	
TOTAL A/C	3,047 SQ.F	
GARAGE	452 SQ.F	
BALCONIES	560 SQ.F	
TERRACE	472 SQ.F	
TOTAL BUILDING FLOOR A	REA 4,531 SQ.F	
SOUTH UNIT BUILDING AREA CALCULATIONS		
GROUND FLOOR A/C	889 SQ.F	

BALCONIES	560 SQ.F		
TERRACE	472 SQ.F		
TOTAL BUILDING FLOOR AREA	4,531 SQ.F		
SOUTH UNIT BUILDING AREA CALCULATIONS			
GROUND FLOOR A/C	889 SQ.F		
SECOND FLOOR A/C	1,324 SQ.F		
THIRD FLOOR A/C	680 SQ.F		
APPURTENANCE A/C	175 SQ.F		
ΓΟΤAL A/C	3,068 SQ.F		
GARAGE	452 SQ.F		
BALCONIES	565 SQ.F		
TERRACE	427 SQ.F		
TOTAL BUILDING FLOOR AREA	4,512 SQ.F		

Balc. 3'-11" 12'-7½" TOP OF KNEE WALL |ELEV: 26'-6" SLOPE FINISH FLOOR ELEV: 23'-4" 11'-1"x10'-6" CLG. HT: Terrace UNIT Great Room 15'-10"x23'-2" CLG. HT: SLOPE ලි 9'-4" TOP OF PARAPET ELEV: 26'-6" Dining CLG. HT: 9'-4" 2-HOUR **DEMISING WALL** ະ¦ິ£ 14'-4" SLOPE TOP OF KNEE WALL SLOPE Club Rm. 10'-8" x 17'-9" CLG. HT: 9'-4" ELEV: 23'-4" 3'-0" SOUTH UNIT TOP OF KNEE WALL 3'-0" 4'-6" 4'-6" 3'-0" 3'-0"


ARCHITECTURE 10 S.E. FIRST AVENUE | SUITE 102 DELRAY BEACH, FLORIDA 3344 V 561.274.9186 | F 561.274.9190 AA26001617 | IB26001056 WWW.RJARCHITECTURE.CO GLEASON ST DELRAY BEA FLORIDA LICENSURI AA26001617 | IB26001056 COMMISSION # DESIGNER: DRAWN BY: PLAN REVIEW: SUBMITTALS: CLASS V SPECIAL SITE PLAN SUBMITTAL **REVISIONS: THIRD** FLOOR **PLAN** A-1.3

RICHARD JONES

NORTH

Third Floor Plan

Scale: 1/4"=1'-0"

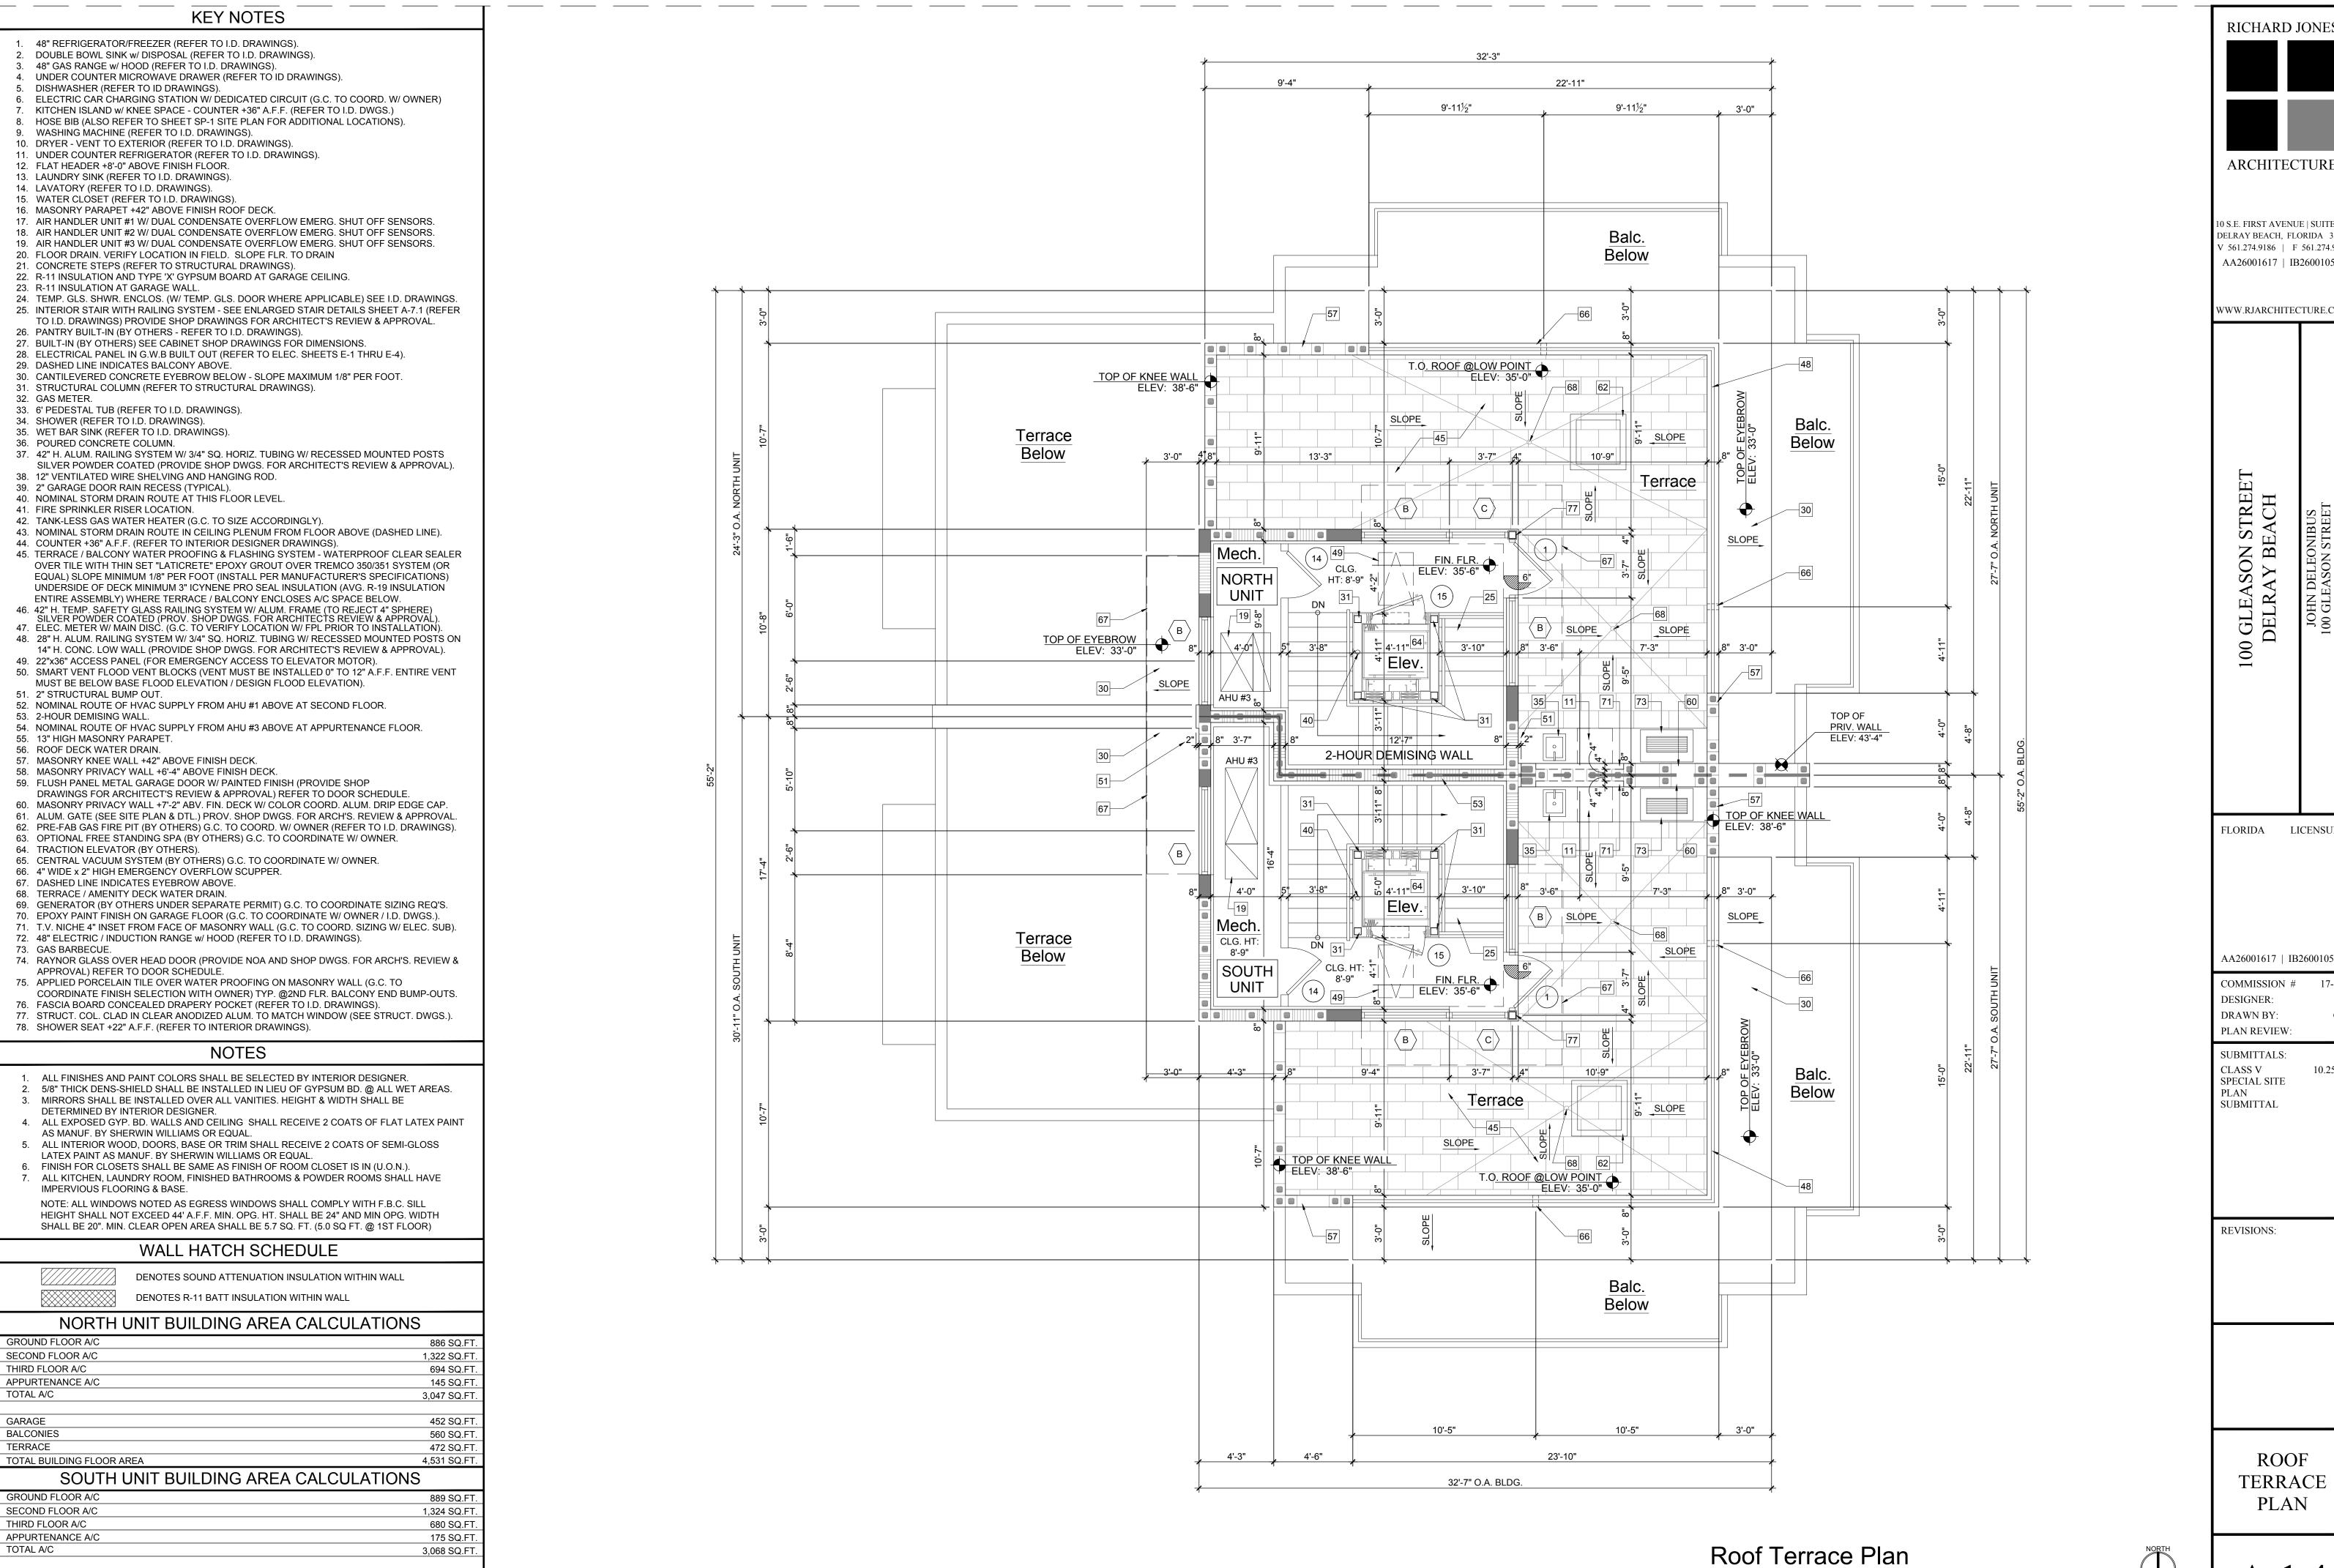

452 SQ.FT


565 SQ.FT


427 SQ.FT. 4,512 SQ.FT.


GARAGE BALCONIES


TERRACE


ARCHITECTURE 10 S.E. FIRST AVENUE | SUITE 102 DELRAY BEACH, FLORIDA 3344 V 561.274.9186 | F 561.274.9190 AA26001617 | IB26001056 WWW.RJARCHITECTURE.CO FLORIDA LICENSURI AA26001617 | IB26001056 COMMISSION # PLAN REVIEW: 10.25.19 **ROOF** TERRACE **PLAN**

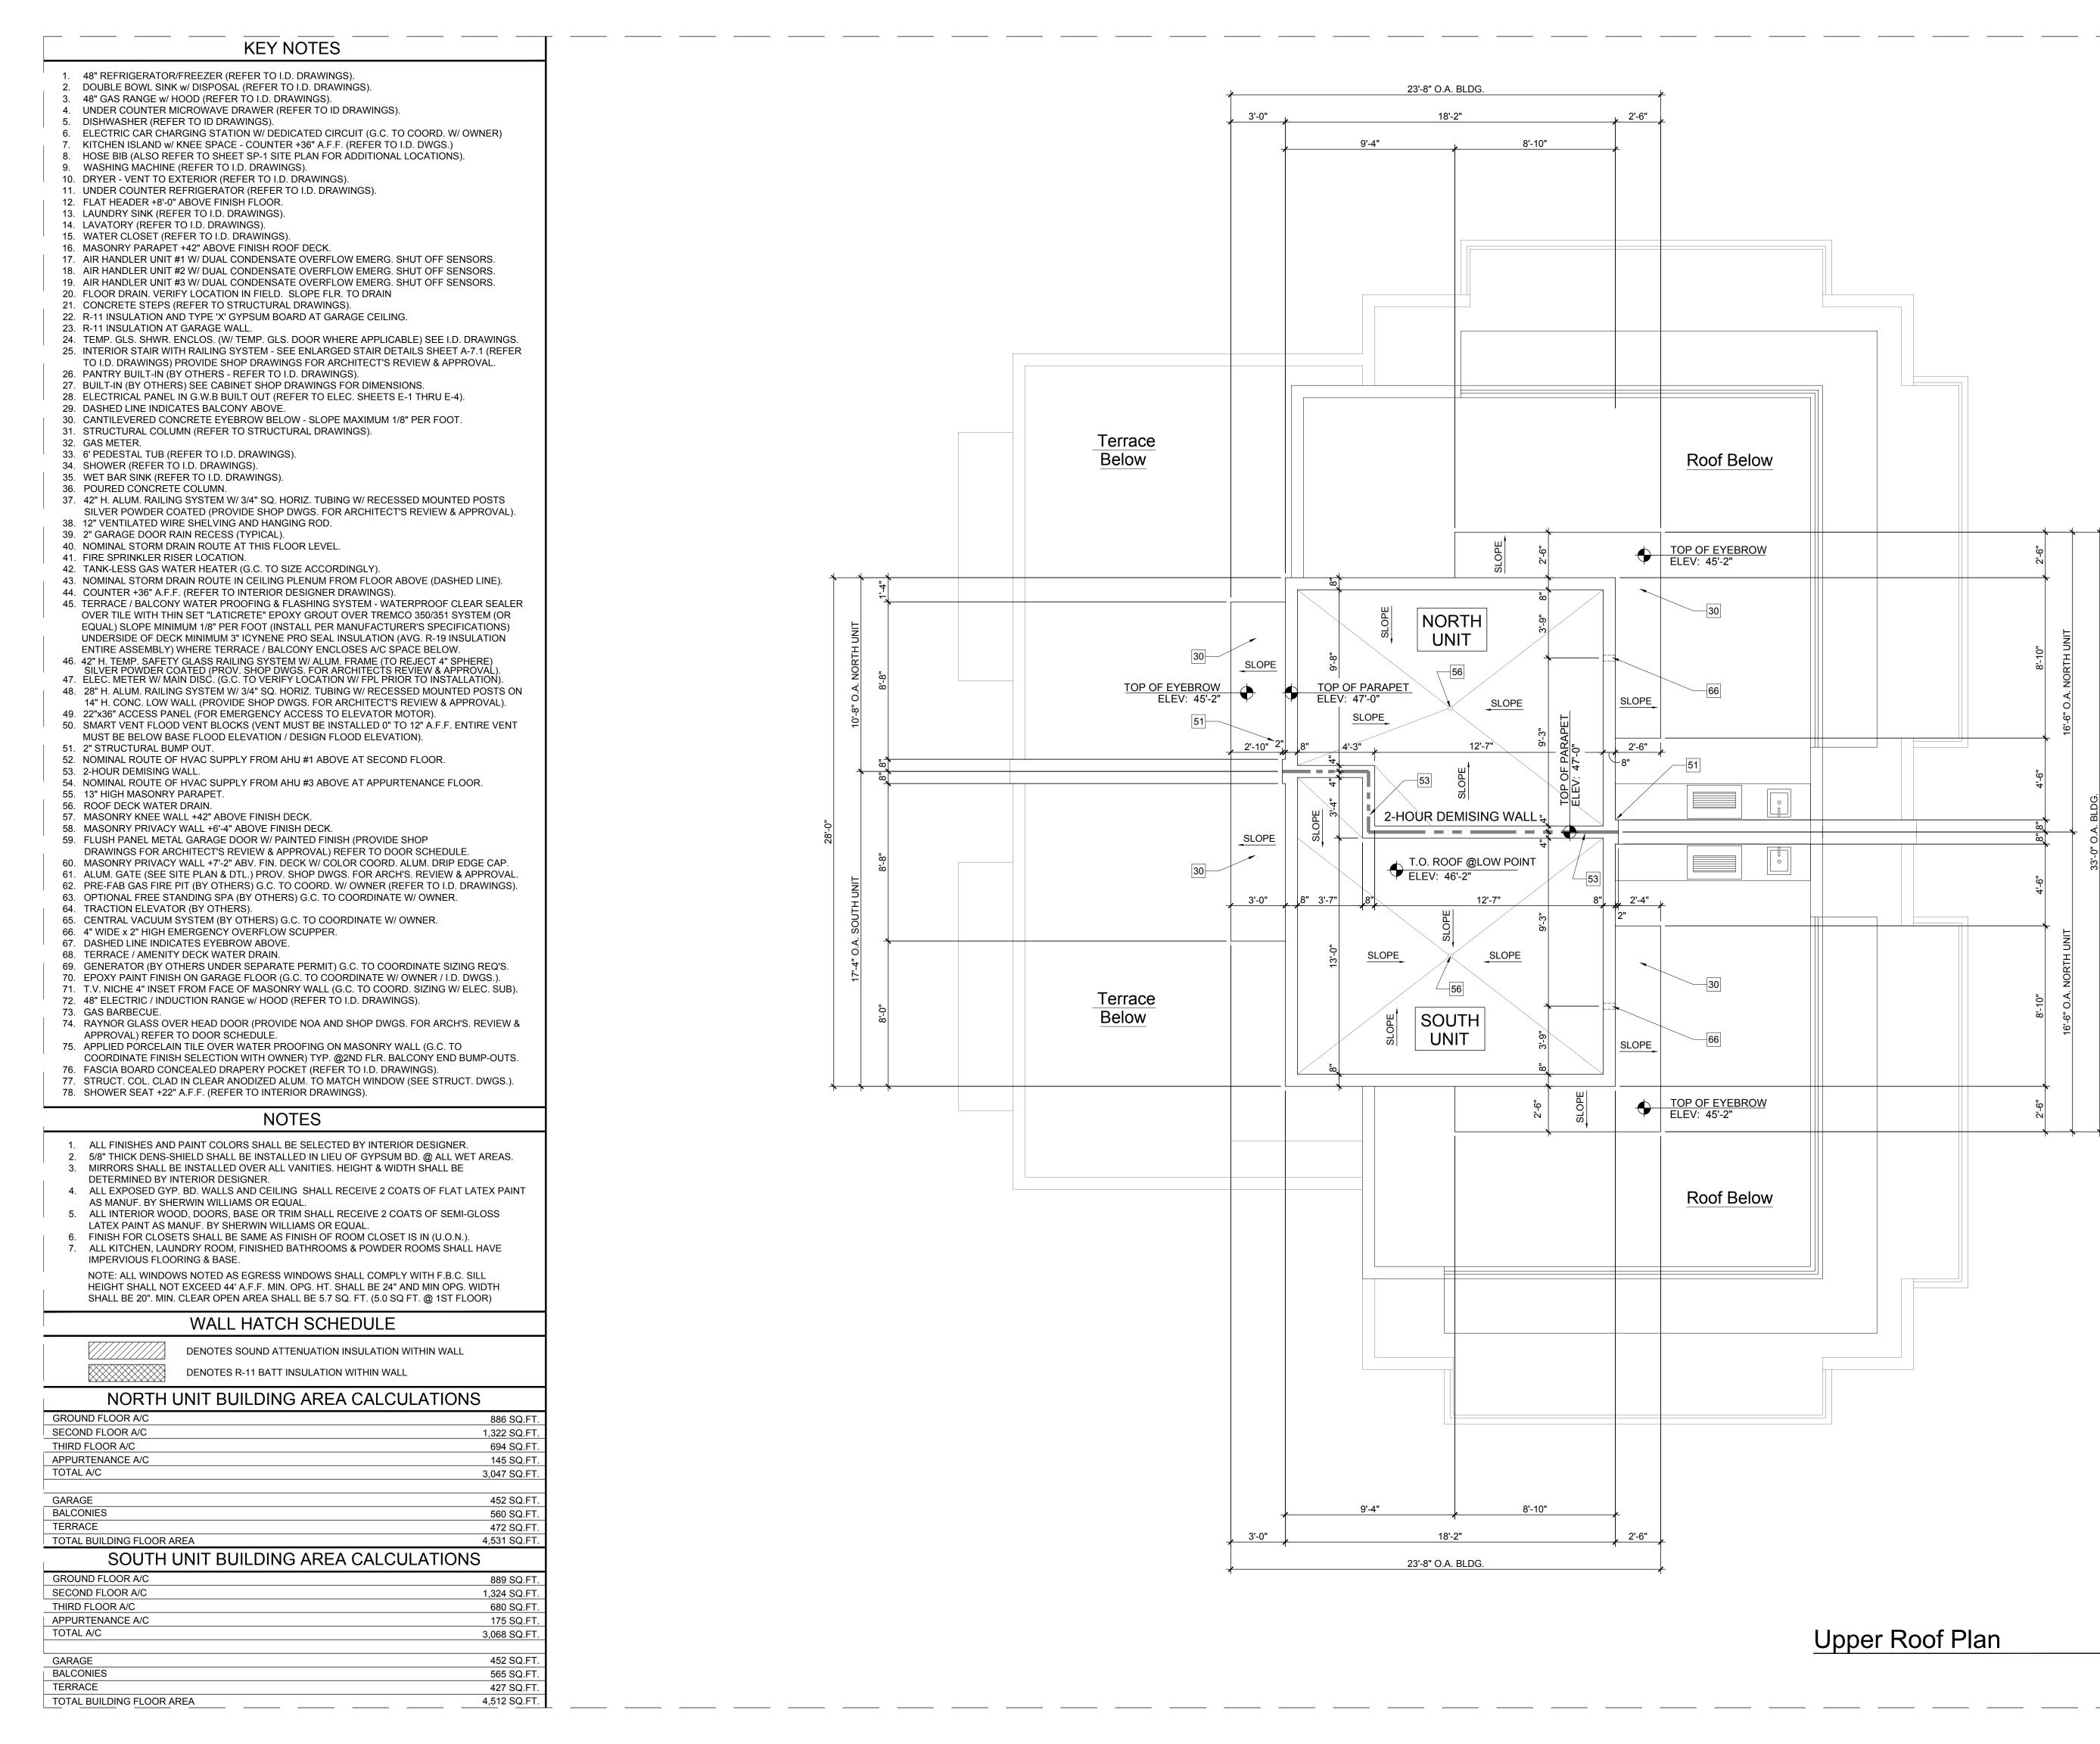

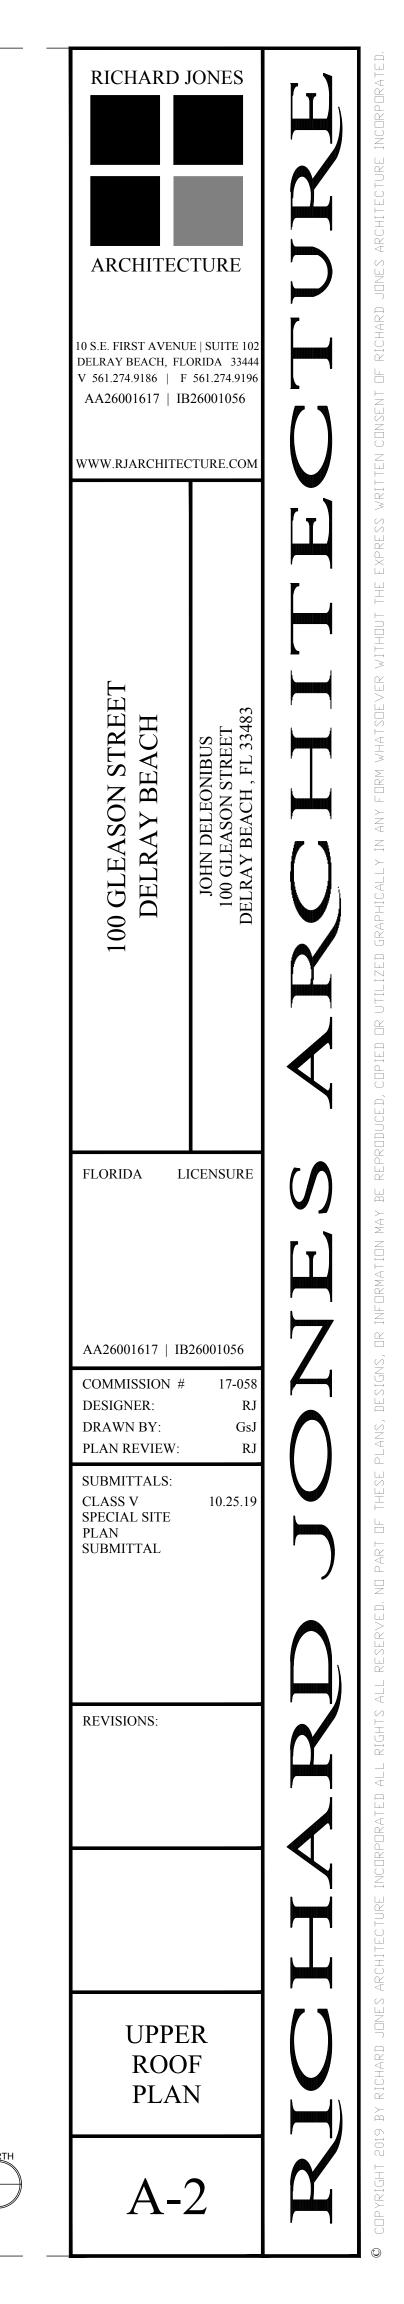

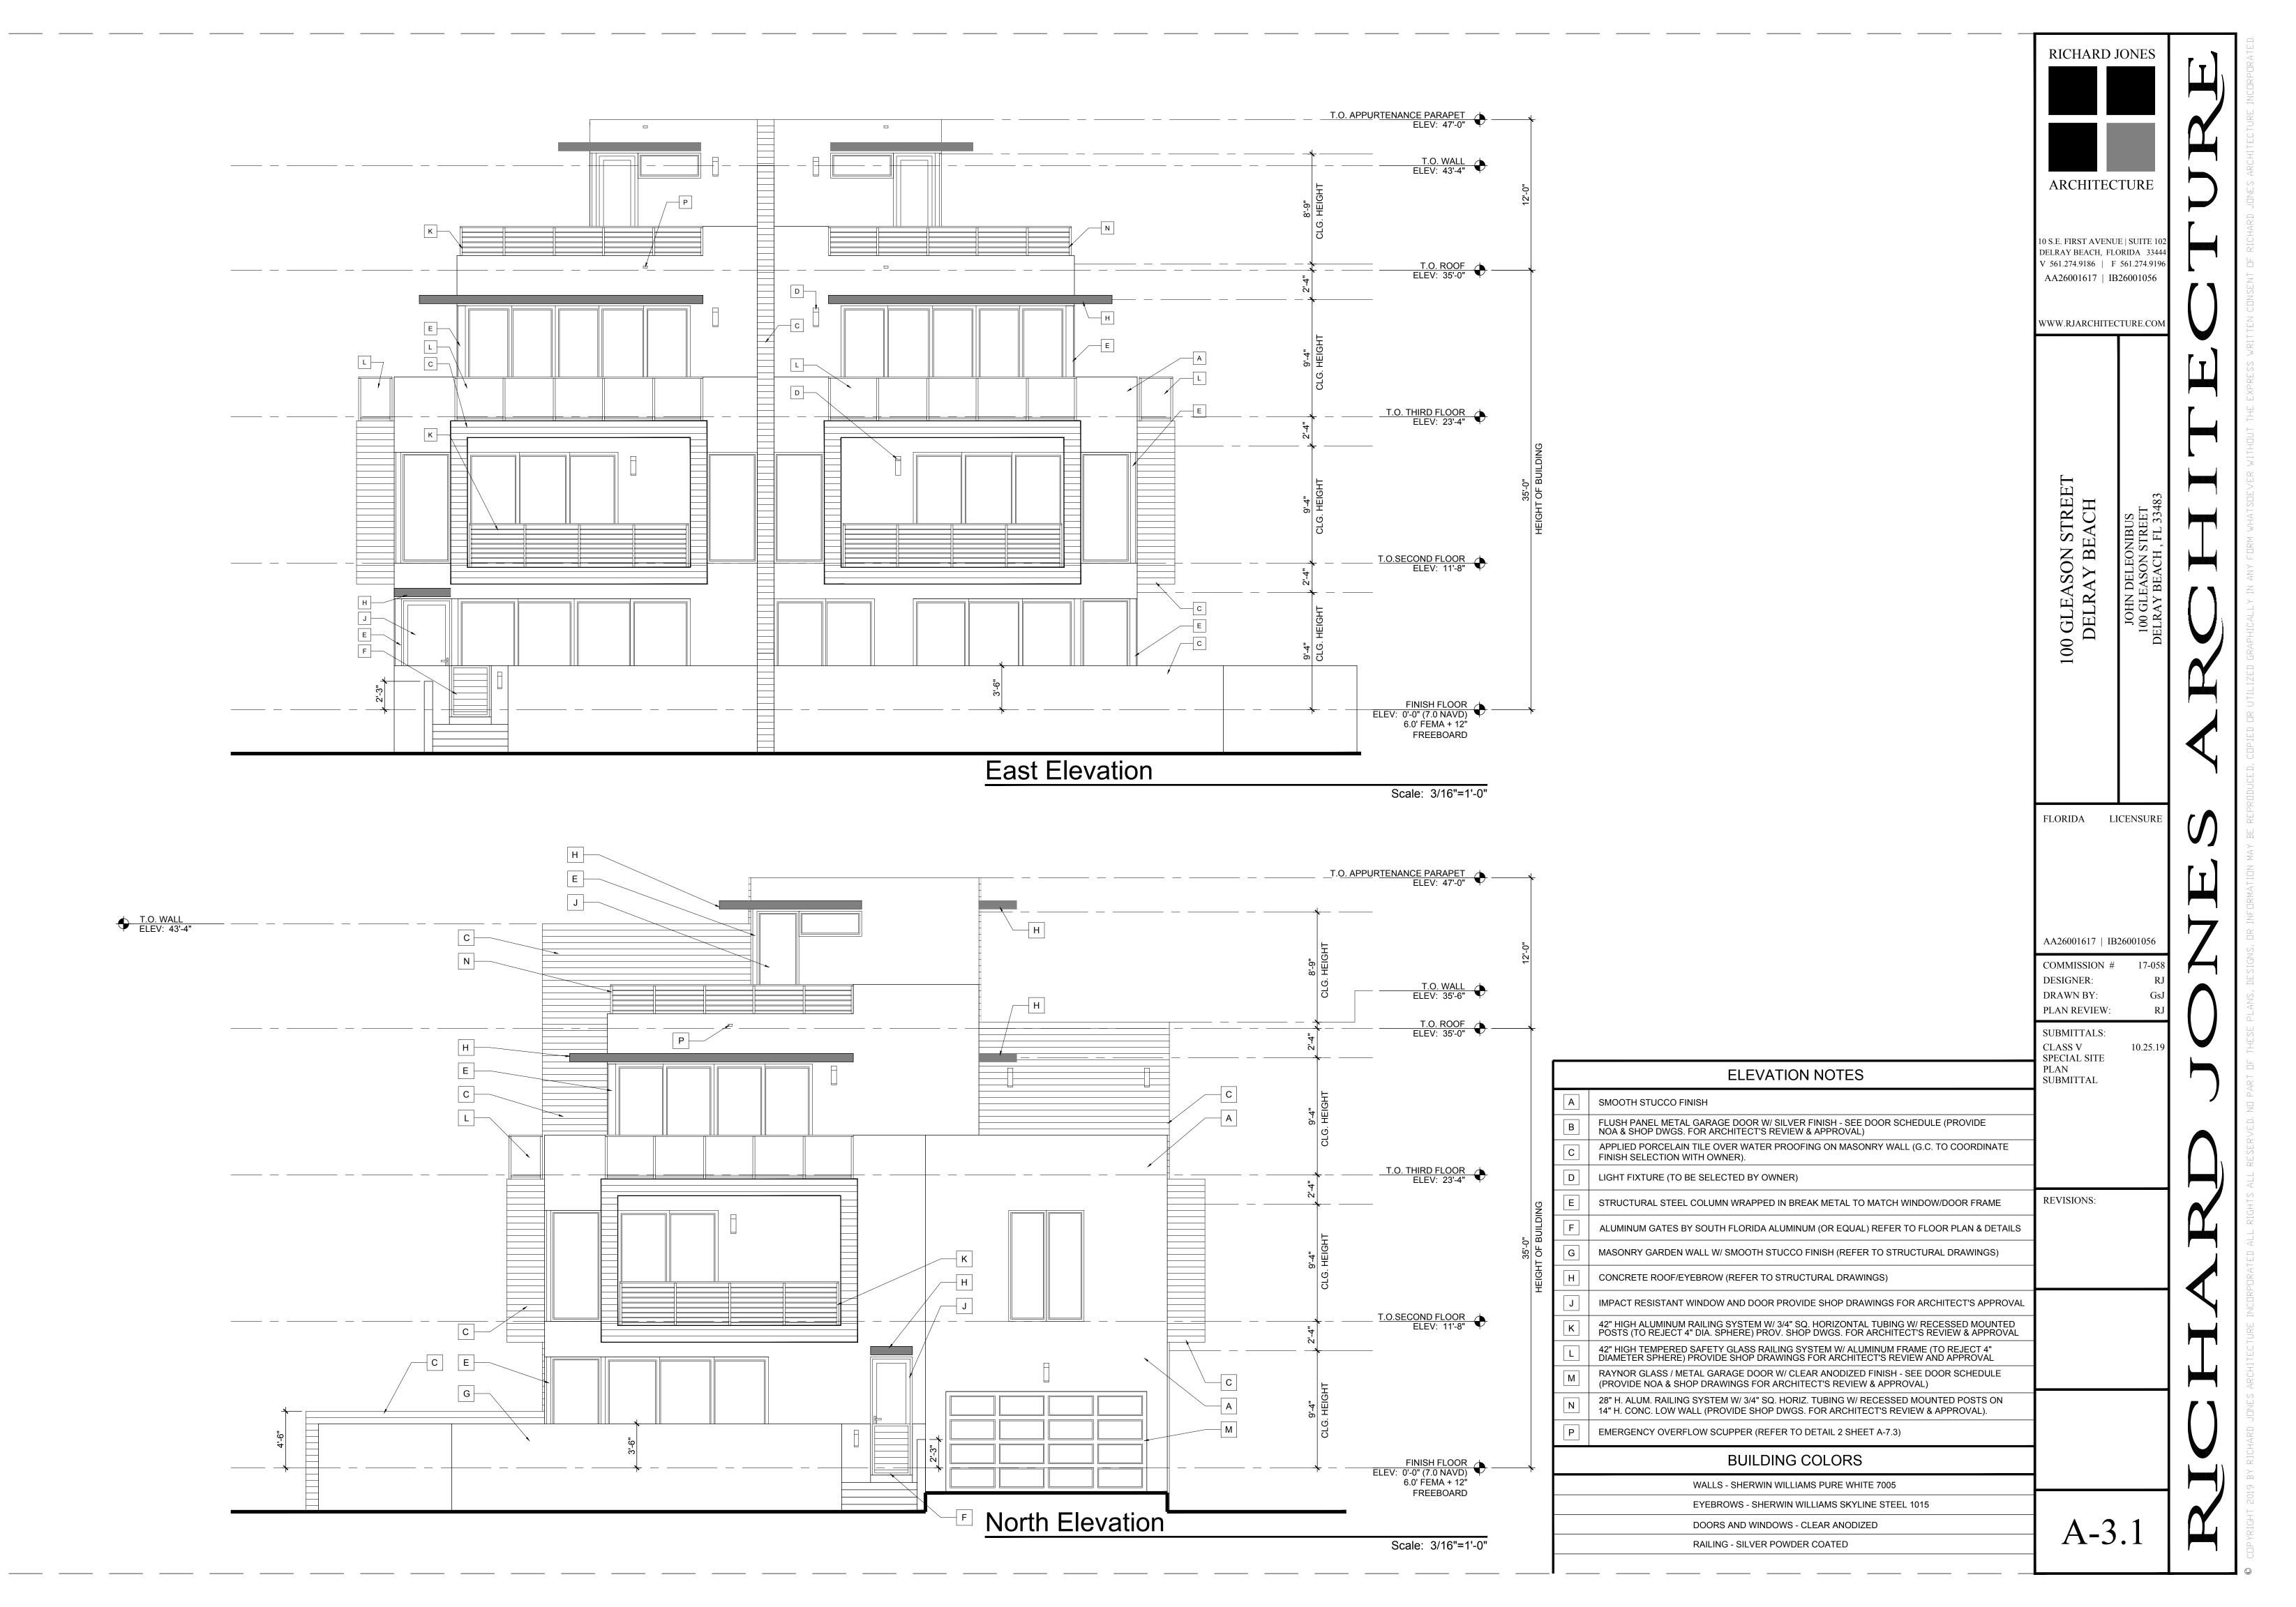

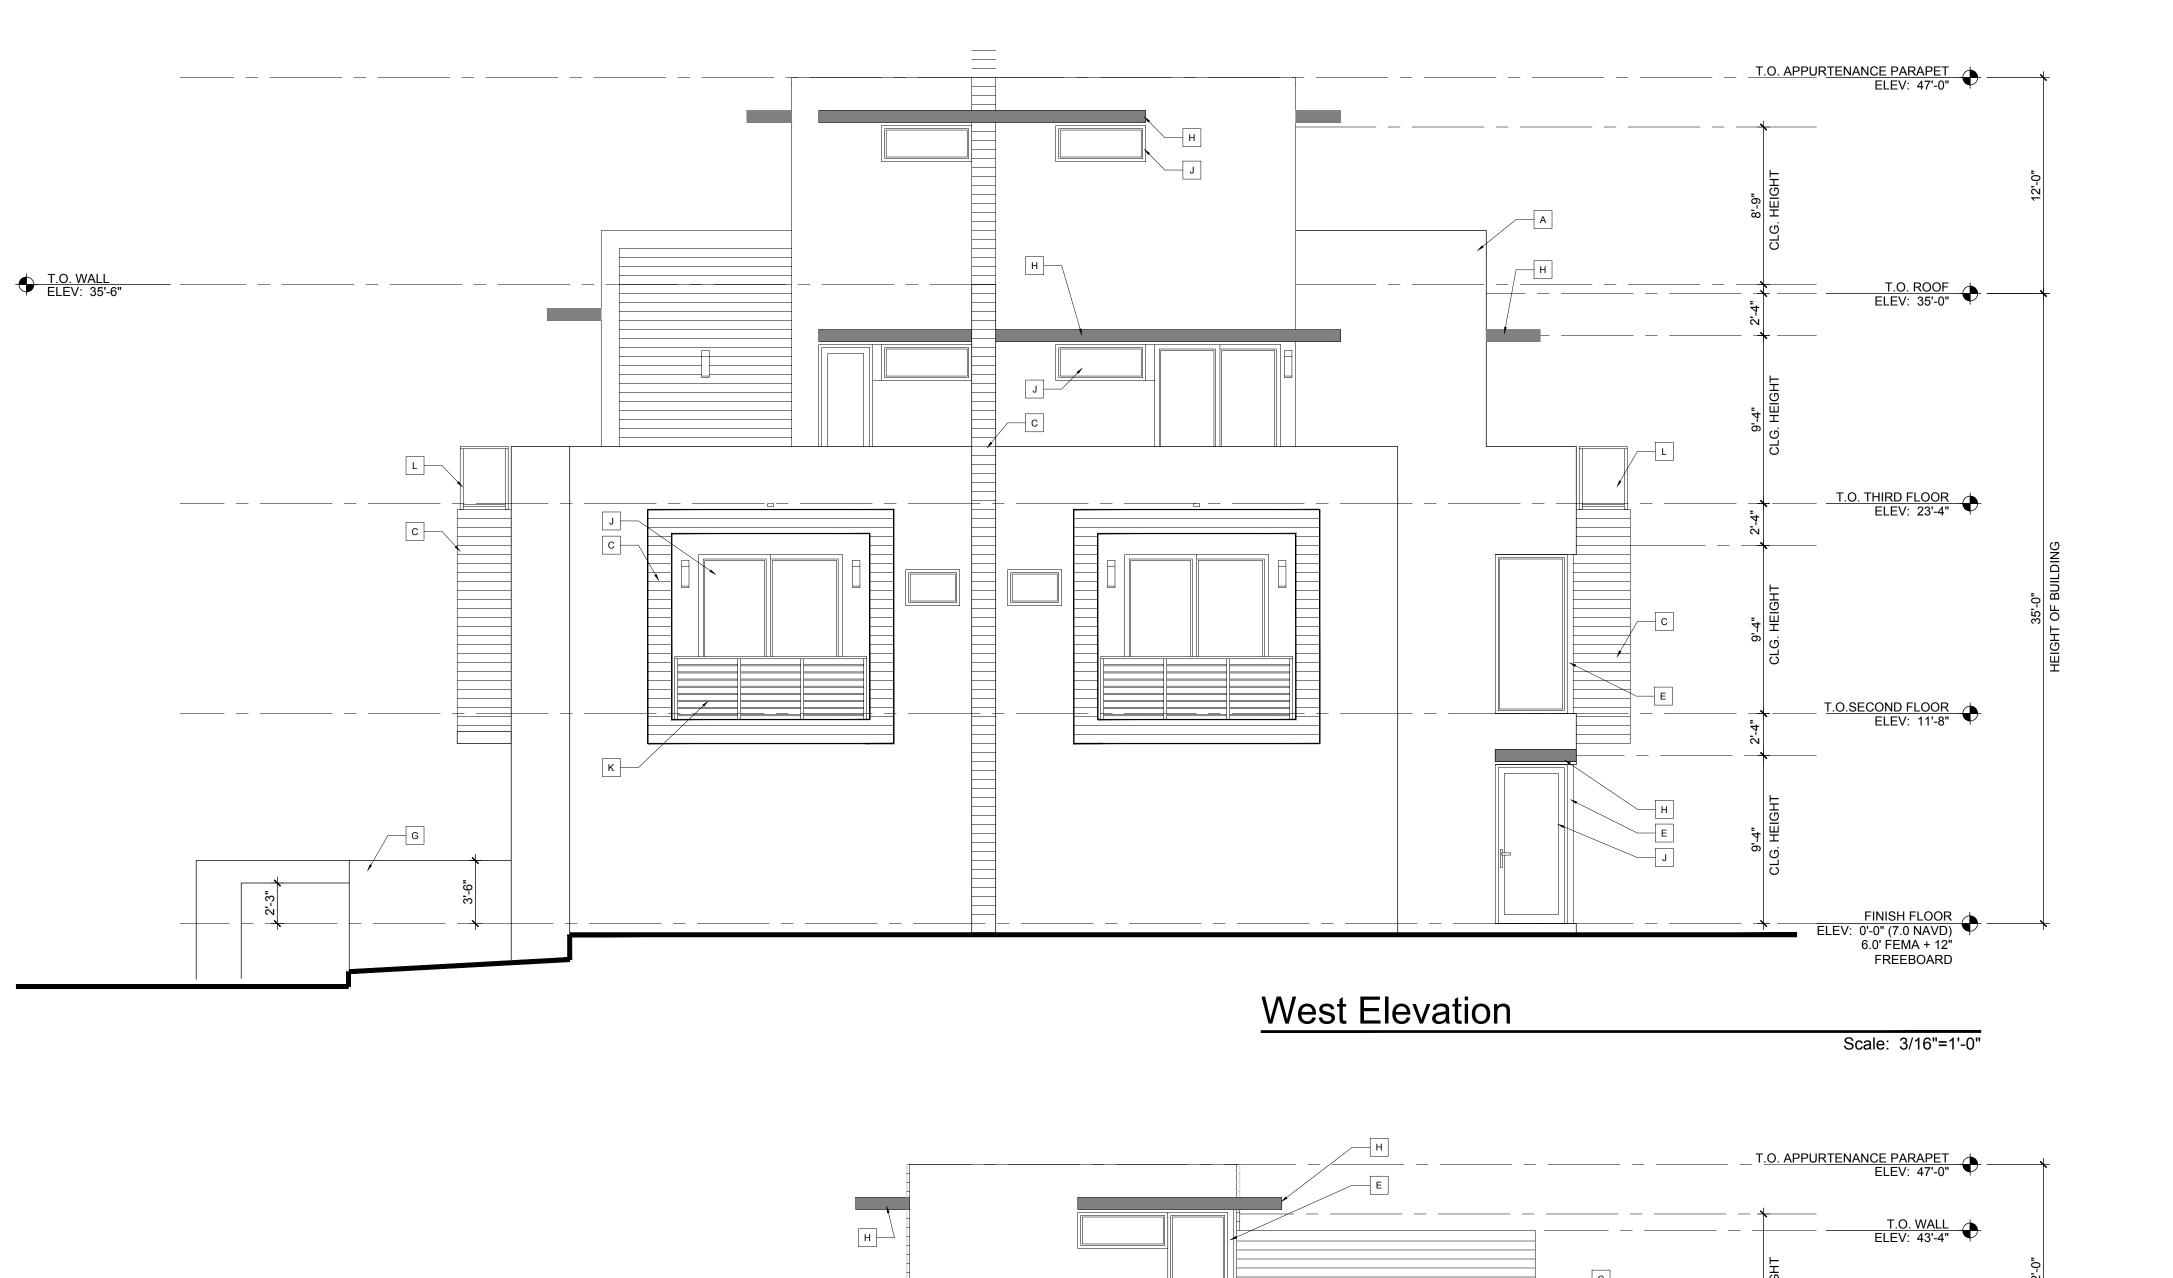

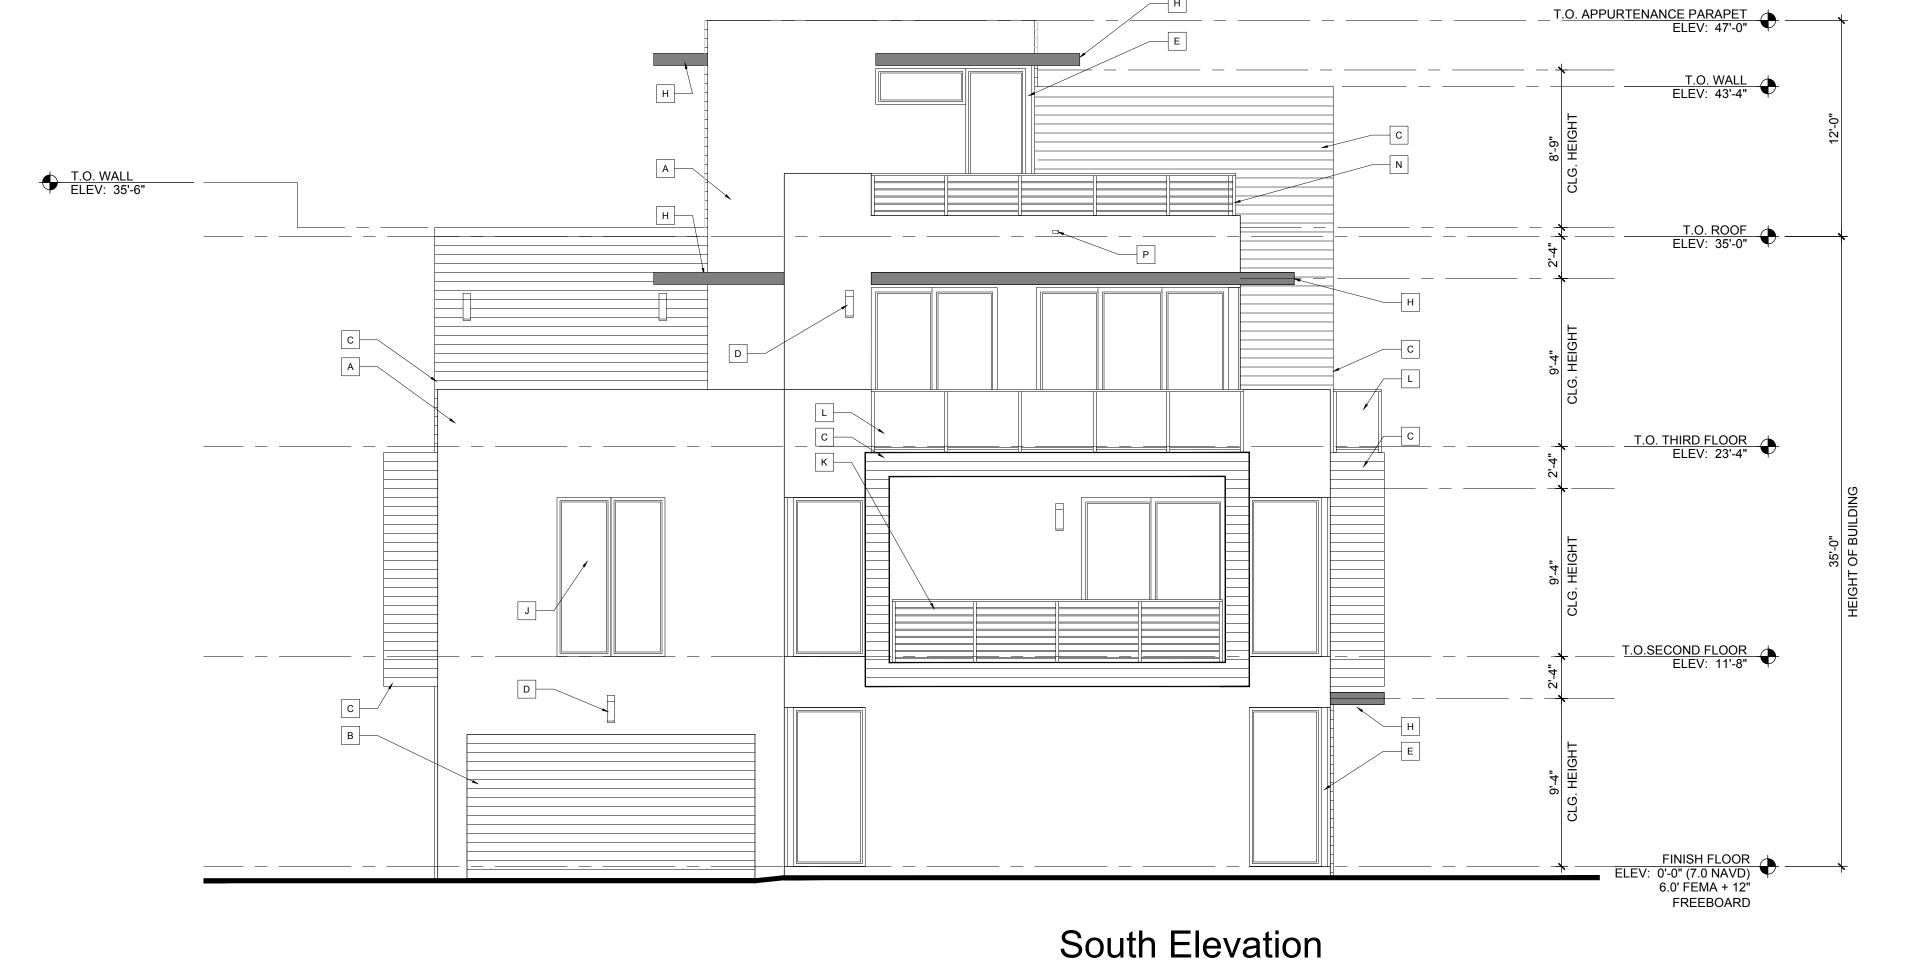

Scale: 3/16"=1'-0"

FLORIDA LICENSURE AA26001617 | IB26001056 COMMISSION # DESIGNER: DRAWN BY: PLAN REVIEW: SUBMITTALS: CLASS V SPECIAL SITE PLAN **ELEVATION NOTES** SUBMITTAL A SMOOTH STUCCO FINISH FLUSH PANEL METAL GARAGE DOOR W/ SILVER FINISH - SEE DOOR SCHEDULE (PROVIDE NOA & SHOP DWGS. FOR ARCHITECT'S REVIEW & APPROVAL) APPLIED PORCELAIN TILE OVER WATER PROOFING ON MASONRY WALL (G.C. TO COORDINATE FINISH SELECTION WITH OWNER). D | LIGHT FIXTURE (TO BE SELECTED BY OWNER) REVISIONS: E STRUCTURAL STEEL COLUMN WRAPPED IN BREAK METAL TO MATCH WINDOW/DOOR FRAME ALUMINUM GATES BY SOUTH FLORIDA ALUMINUM (OR EQUAL) REFER TO FLOOR PLAN & DETAILS G | MASONRY GARDEN WALL W/ SMOOTH STUCCO FINISH (REFER TO STRUCTURAL DRAWINGS) H CONCRETE ROOF/EYEBROW (REFER TO STRUCTURAL DRAWINGS) IMPACT RESISTANT WINDOW AND DOOR PROVIDE SHOP DRAWINGS FOR ARCHITECT'S APPROVAL 42" HIGH ALUMINUM RAILING SYSTEM W/ 3/4" SQ. HORIZONTAL TUBING W/ RECESSED MOUNTED POSTS (TO REJECT 4" DIA. SPHERE) PROV. SHOP DWGS. FOR ARCHITECT'S REVIEW & APPROVAL 42" HIGH TEMPERED SAFETY GLASS RAILING SYSTEM W/ ALUMINUM FRAME (TO REJECT 4" DIAMETER SPHERE) PROVIDE SHOP DRAWINGS FOR ARCHITECT'S REVIEW AND APPROVAL RAYNOR GLASS / METAL GARAGE DOOR W/ CLEAR ANODIZED FINISH - SEE DOOR SCHEDULE (PROVIDE NOA & SHOP DRAWINGS FOR ARCHITECT'S REVIEW & APPROVAL) 28" H. ALUM. RAILING SYSTEM W/ 3/4" SQ. HORIZ. TUBING W/ RECESSED MOUNTED POSTS ON 14" H. CONC. LOW WALL (PROVIDE SHOP DWGS. FOR ARCHITECT'S REVIEW & APPROVAL). WEST AND P EMERGENCY OVERFLOW SCUPPER (REFER TO DETAIL 2 SHEET A-7.3) SOUTH **BUILDING COLORS ELEVATION** WALLS - SHERWIN WILLIAMS PURE WHITE 7005 EYEBROWS - SHERWIN WILLIAMS SKYLINE STEEL 1015 A-3.2DOORS AND WINDOWS - CLEAR ANODIZED RAILING - SILVER POWDER COATED

RICHARD JONES ARCHITECTURE 10 S.E. FIRST AVENUE | SUITE 102 DELRAY BEACH, FLORIDA 33444 V 561.274.9186 | F 561.274.9196 AA26001617 | IB26001056 WWW.RJARCHITECTURE.CO 100 GLEASON STREET DELRAY BEACH