

DRAWING INDEX

GROUND FLOOR, SECOND FLOOR AND ROOF PLAN

EAST & SOUTH BUILDING ELEVATIONS

WEST & NORTH BUILDING ELEVATIONS


SITE & SIDE ELEVATION SETBACK DIAGRAM

WINDOW & DOOR SCHEDULES

150 MARINE WAY

150 MARINE WAY DELRAY BEACH, FLORIDA

LOCATION MAP

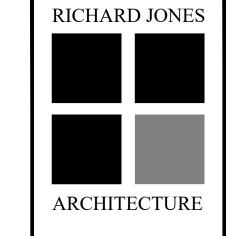

0 S.E. FIRST AVENUE | SUITE 10 561.274.9186 | F 561.274.919 AA26001617 | IB26001056

WWW.RJARCHITECTURE.C

AA26001617 | IB26001056

■■■ SITE LOCATION FLORIDA LICENSUR PLAN REVIEW SUBMITTALS: TAC COMMENTS:

OWNER

CVR COVER SHEET

S-1 SURVEY

ARCHITECTURAL

SP-1 SITE PLAN

STREET SCAPE

A-7 COMPOSITE OVERLAY PLAN

AZURE 150 MARINE LLC 290 SE 6TH AVENUE SUITE 5 DELRAY BEACH, FL 33483

ARCHITECT

RICHARD JONES ARCHITECTURE 10 S.E. FIRST AVENUE, SUITE 102 DELRAY BEACH, FL. 33444 TELEPHONE: 561-274-9186

STRUCTURAL

FBC 2017 ULTIMATE WIND SPEED 170 (3 SECOND GUST)

PROPOSED PROJECT:

GOVERNING CODE:

MEAN ROOF HEIGHT:

BUILDING DESIGNED:

WIND SPEED:

EXPOSURE:

SETBACKS:

ZONING DISTRICT

CODE RESEARCH

RM - HISTORIC DISTRICT - CITY OF DELRAY BEACH

DESIGN PARAMETERS

PARTIALLY ENCLOSED X ENCLOSED OPEN TESTED (WIND TUNNEL)

BUILDING HEIGHT X < 60 FT. (MAY USE LOW RISE PROVISIONS OF THE 6th EDITION (2017) FLORIDA RESIDENTIAL CODE)

X ASCE 7-10 CHAPTER 26

PROVIDED:

X SEC. R301.2.1.4.3 6th EDITION (2017) FLORIDA RESIDENTIAL CODE

(EAST) FRONT SETBACK = 36'-4 1/2" (WEST) REAR SETBACK = 10'-2 1/2"

(NORTH) SIDE SETBACK = 7'-6"

(SOUTH) SIDE SETBACK = 7'-6"

> 60 FT. (ASCE 7-10 CHAPTER 26)

FBC 6th EDITION (2017), FFPC 6th EDITION (2017), NFPA 1 UFC

FLORIDA 2015 EDITION, NFPA 101 LSC FLORIDA 2018 EDITION

SINGLE FAMILY-RESIDENTIAL

26'-1" (ABOVE B.B.E. = 7.00' NAVD)

170 MPH ULTIMATE WIND SPEED

GROUP R

ENCLOSED

REQUIRED:

FRONT SETBACK = 25'-0"

SIDE INTERIOR SETBACK= 7'-6"

REAR SETBACK = 10'-0"

26'-1" (ABOVE B.B.E.)

REFER TO 6th EDITION (2017) FLORIDA RESIDENTIAL CODE OR ASCE 7-10 CHAPTER 26)

ROOF DEAD LOAD (ACTUAL DEAD LOAD OF MATERIAL USED FOR DETERMINING UPLIFT REACTIONS)

REVIEWED FOR SHEAR WALL REQUIREMENTS X YES NO (IF NO, INDICATE REASON)

TYPE OF CONSTRUCTION: TYPE V UNSPRINKLERED

OCCUPANCY (SINGLE FAMILY, DUPLEX, MULTI-FAMILY,

COMMERCIAL, INDUSTRIAL - DESCRIBE

EXPOSURE CONDITION

SOIL BEARING CAPACITY

MEAN ROOF HEIGHT

ENGINEERING PLUS 19528 SEDGEFIELD TERRACE BOCA RATON, FL 33498 CELL: 561-756 4106 FAX: 561-479 3743

LANDSCAPE

PLA DESIGN STUDIO, PLLC LANDSCAPE ARCHITECTURE 2385 NW EXECUTIVE CENTER DR SUITE 240 BOCA RATON FL, 33431 561-904-1556 PHONE:


CIVIL ENGINEER

ENVIRODESIGN ASSOCIATES, INC. 298 NE 2ND AVENUE DELRAY BEACH, FL 33444 TELEPHONE: 561-274-6500 FAX: 561-274-8558

LAND SURVEYOR

O'BRIEN, SUITER & O'BRIEN 955 NW 17TH AVENUE SUITE K-1 DELRAY BEACH FL. 33445 TELEPHONE: 561-276-4501 FAX: 561-276-2390

COVER SHEET

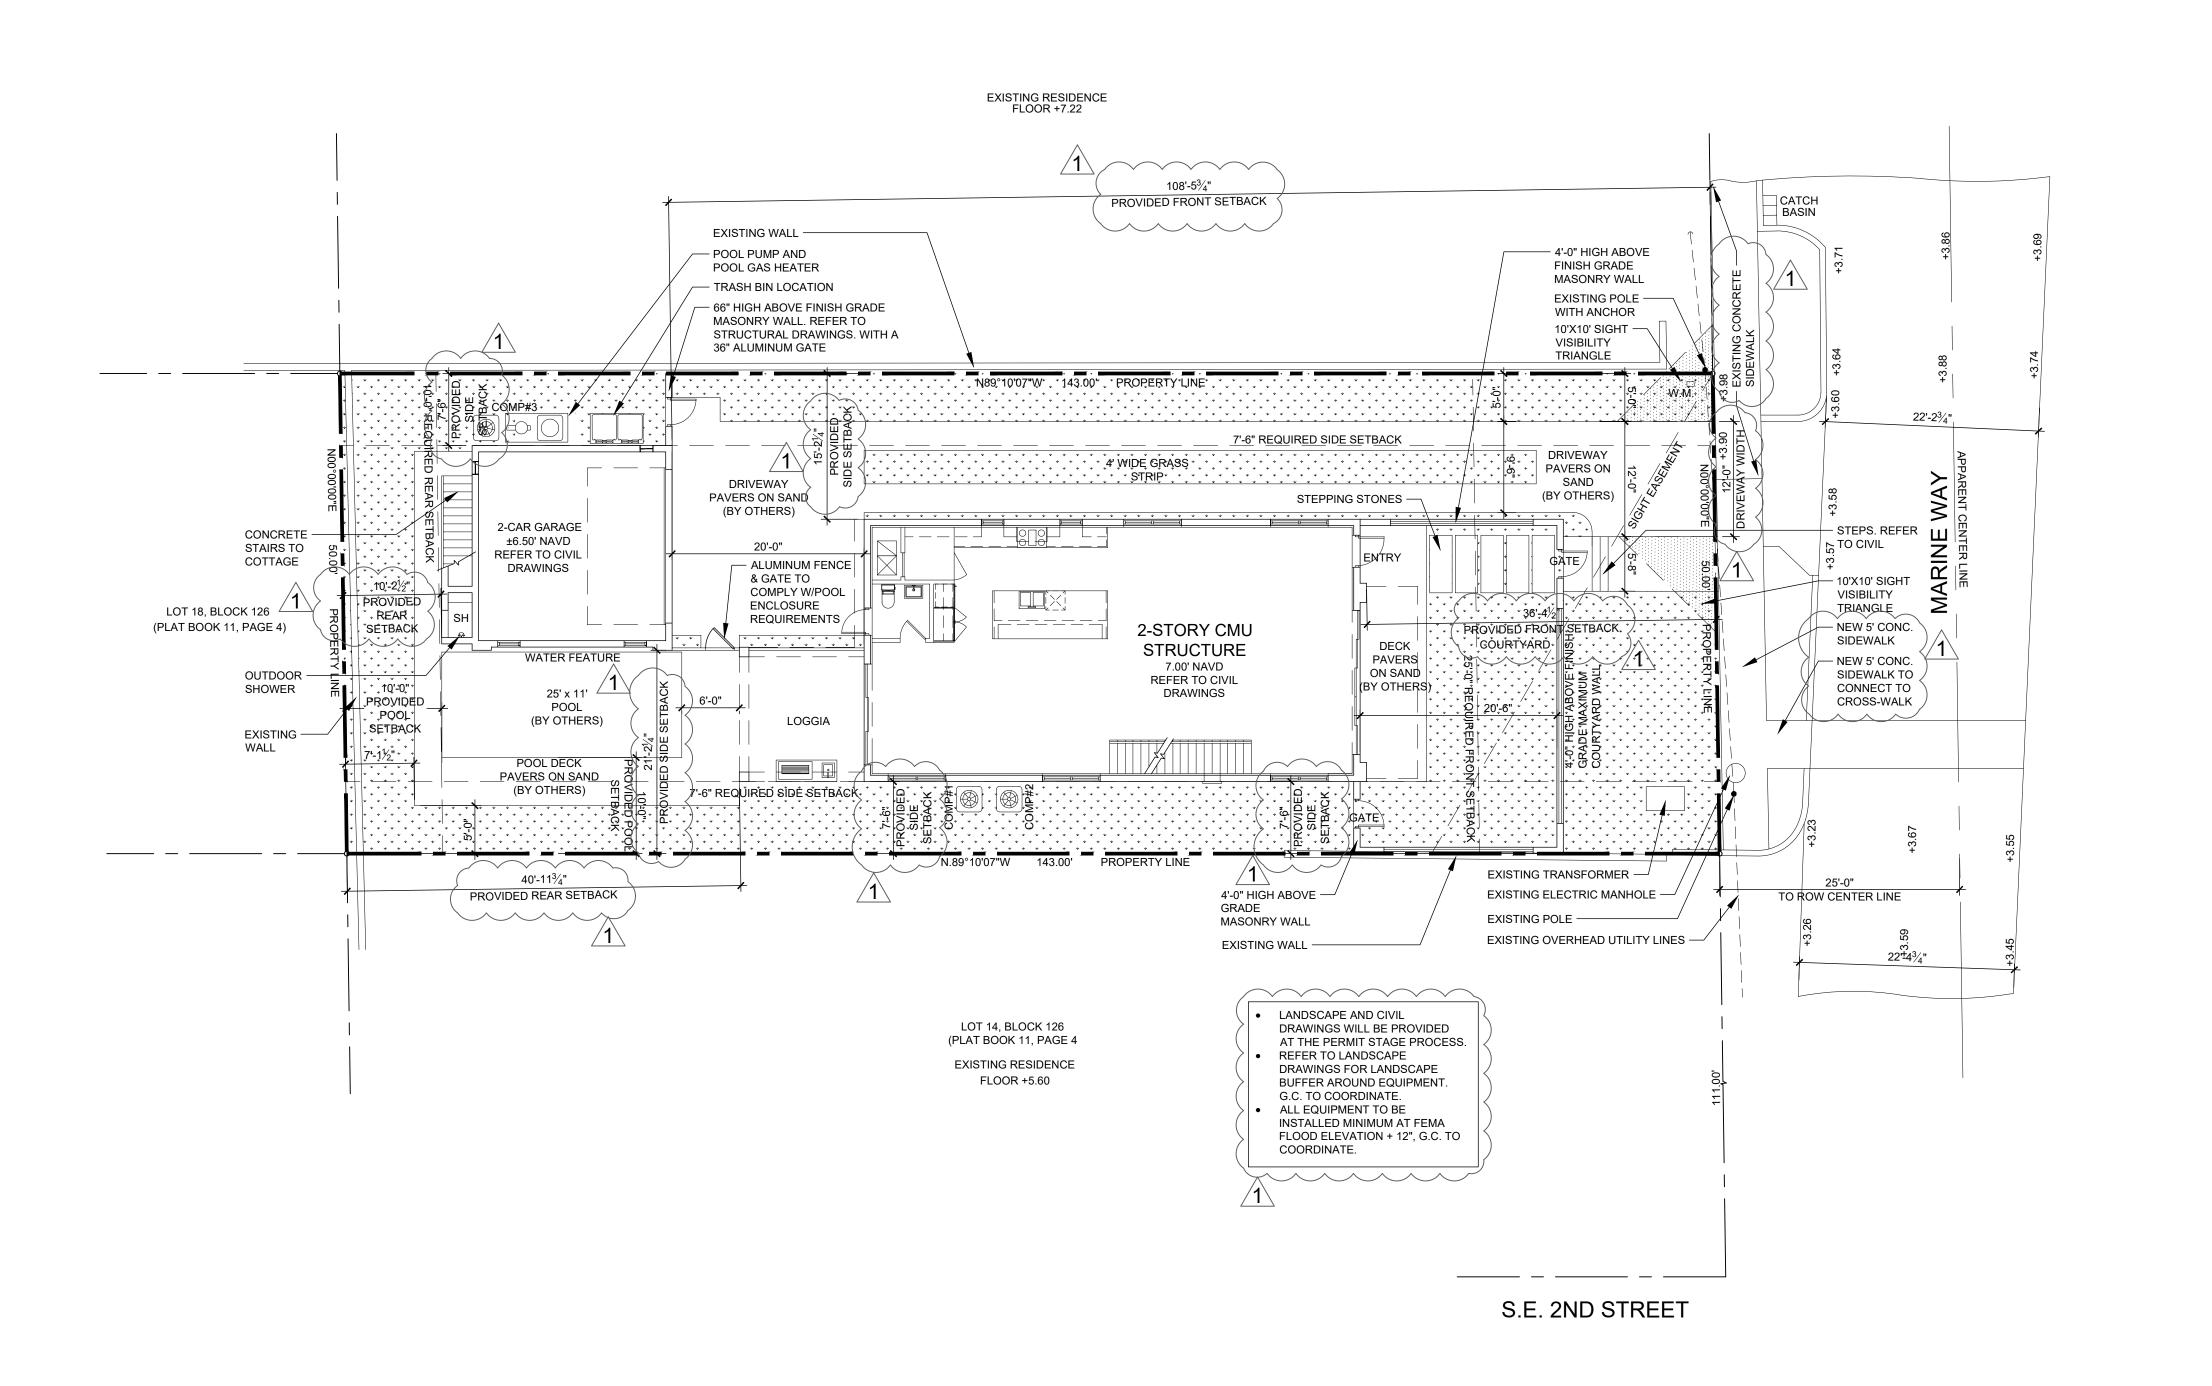


Site Plan


RICHARD JONE LOT 13, BLOCK 126, A SUBDIVISION OF BLOCK 126, ACCORDING TO THE PLAT THEREOF AS RECORDED IN PLAT BOOK 11, PAGE 4, PUBLIC RECORDS OF PALM BEACH COUNTY, FLORIDA. Zoning District RM - (Historic District) Future Land Use MD - (Historic District) Architectural Style Vernacular ARCHITECTURE **BUILDING SETBACKS** REQUIRED PROVIDED PRINCIPAL STRUCTURE 0,S.E. FIRST AVENUE | SUITE 102 Front Setback (East) 36'-4 1/2" 40'-2" DELRAY BEACH, FLORIDA 33444 10'-0" 40'-11 3/4" 63'-7 1/2" V*)*561.274.9186 | F 561.274.9196 Rear Setback (West) Side Interior Setback (South) 7'-6" 16'-2 1/2" AA26001617 | IB26001056 6'-11" Side Interior Setback (North) 15'-2 1/4" ACCESSORY STRUCTURE WWW.RJARCHITECTURE.CO Front Setback (East) 25'-0" 108'-5 3/4" 40'-2" 10'-0" 10'-2 1/2" 63'-7 1/2" Rear Setback (West) 16'-2 1/2" Side Interior Setback (South) 21'-2 1/4" 7'-6" 6'-11" Side Interior Setback (North) SITE DATA CHART (BOTH BUILDINGS) PROVIDED Bldg Footprint = 2,041 SQ.FT. 1,042 SQ.FT. 1,308 SQ.FT. 4,240 SQ.FT. Imprevious Area = 2,912 SQ.FT. 5,844 SQ.FT. N/A Pervious Area = Total Site Area = 7,500 SQ.FT. 7,152 SQ.FT. Lot Coverage = N/A 28.9% N/A 11.7% 59.3% % Impervious = N/A N/A 40.7% 88.3% % Pervious = 25% Non-Vehicular 40.7% 88.3% Lot Width = 60'/80' 50.0' 50.0' Lot Depth = 143.0' 143.0' Lot Frontage = 60'/80' 50.0' 50.0' Total Building Floor Area = 1,000 SQ.FT. 4,183 SQ.FT. 2,110 SQ.FT. Finish Floor Elevation (FFE) 7.00' NAVD 7.00' NAVD 7.27' NAVD Base Flood Elevation (BFE) Base Building Elevation (BBE) (12" above BFE (No Freeboard) 7.00' NAVD Building Mean Roof Height | 35'-0" (Above BBE) 26'-1" ± 23'-0" Average Crown Of Road (ACR) | Used for BHP elevation point 3.75' NAVD AREA CALCULATIONS PROVIDED EXISTING FLORIDA LICENSURE PRINCIPAL STRUCTURE GROUND FLOOR AIR CONDITIONED AREA 1,415 SQ.FT. 783 SQ.FT. 1,282 SQ.FT. 1,037 SQ.FT. SECOND FLOOR AIR CONDITIONED AREA TOTAL FLOOR AIR CONDITIONED AREA 2,697 SQ.FT. 1,820 SQ.FT. 182 SQ.FT. 252 SQ.FT. COVERED 2ND FLOOR TERRACE 0 SQ.FT. 311 SQ.FT. COVERED ENTRY 7 SQ.FT. A26001617 | IB26001056 3,190 SQ.FT. TOTAL UNDER ROOF AREA 2,079 SQ.FT. COMMISSION # 19-019 2ND FLOOR OPEN AIR BALCONY 106 SQ.FT. 31 SQ.FT. DESIGNER: **DRAWN BY:** TOTAL PRINCIPAL BUILDING AREA 3,296 SQ.FT. 2,110 SQ.FT. PLAN REVIEW: ACCESSORY STRUCTURE **SUBMITTALS:** GROUND FLOOR AIR CONDITIONED AREA 0 SQ.FT. N/A JSSUE TO 357 SQ.FT. SECOND FLOOR AIR CONDITIONED AREA 07.21.20 N/A TOTAL FLOOR AIR CONDITIONED AREA 357 SQ.FT. N/A 444 SQ.FT. N/A N/A COVERED 2ND FLOOR COTTAGE BALCONY 86 SQ.FT. TOTAL UNDER ROOF AREA 887 SQ.FT. N/A REVISIONS: TAC COMMENTS: 09.15.2 TOTAL ACCESSORY BUILDING AREA 887 SQ.FT. N/A TOTAL BOTH BUILDINGS AREA 4,183 SQ.FT. 2,110 SQ.FT. HARDSCAPE DATA PROVIDED 4,240 SQ.FT. (NO HATCH) IMPERVIOUS AREA 2,912 SQ.FT. PERVIOUS AREA

LEGAL DESCRIPTION


SITE PLAN


SP-1

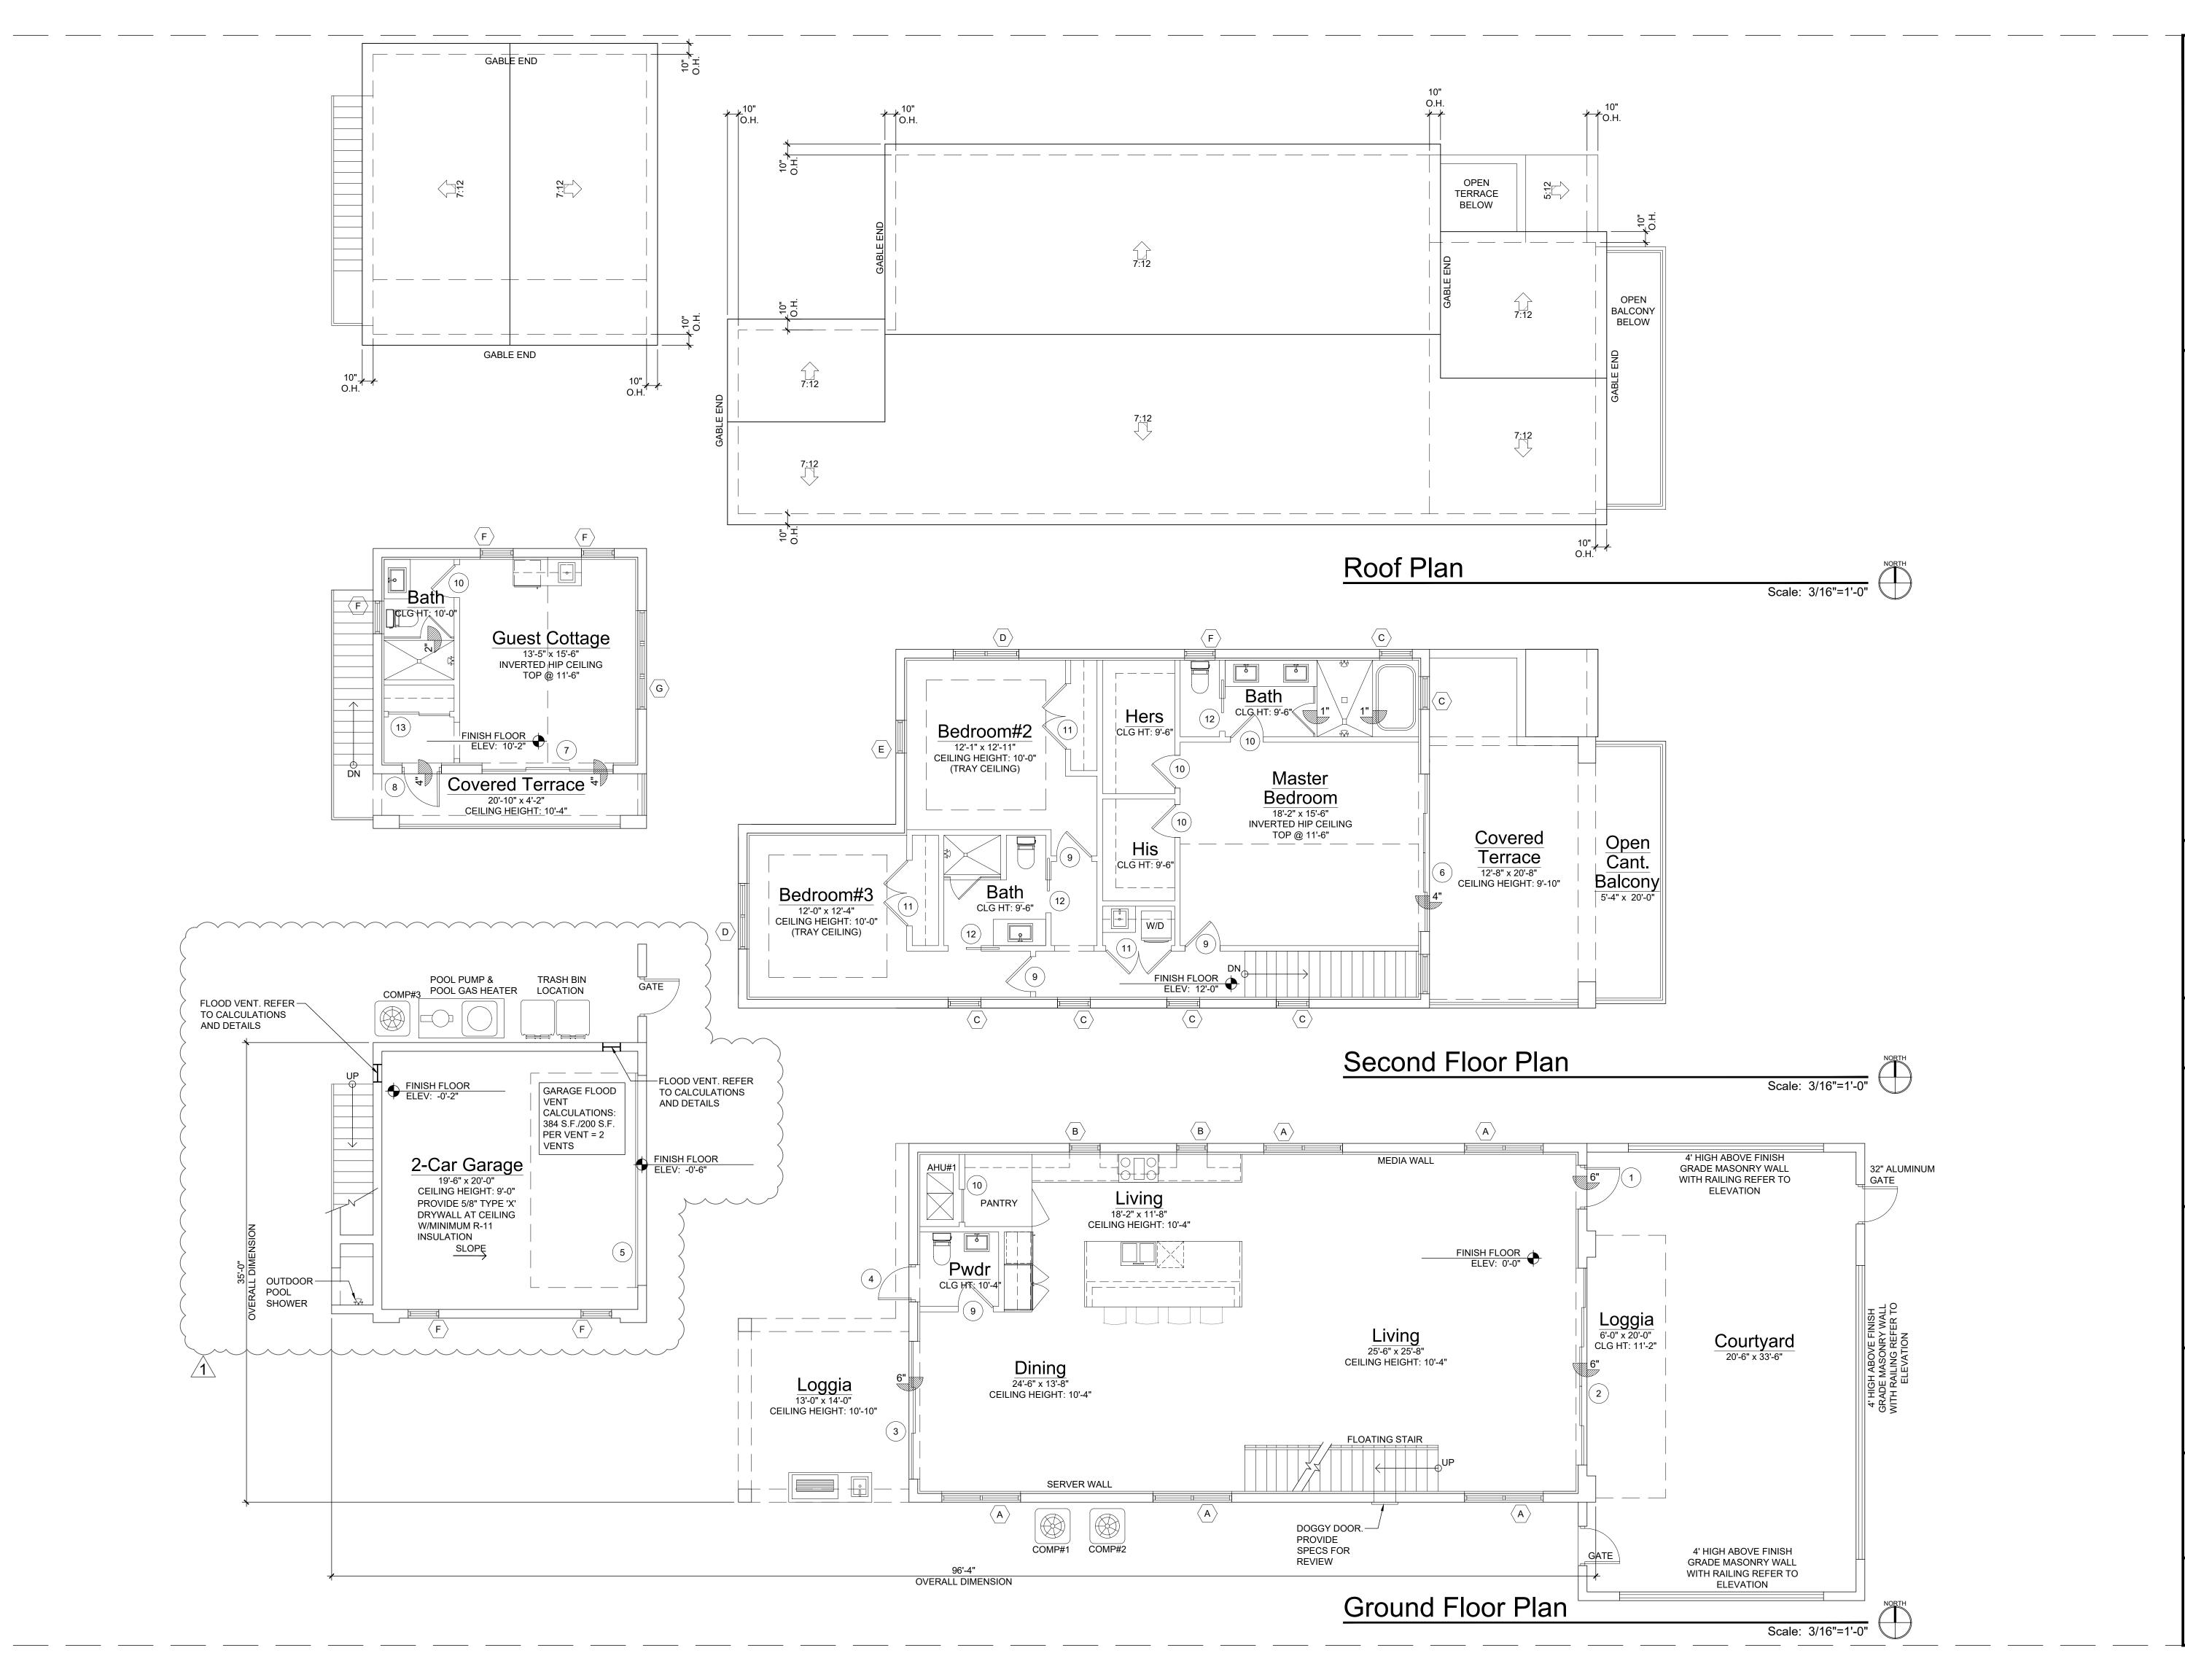


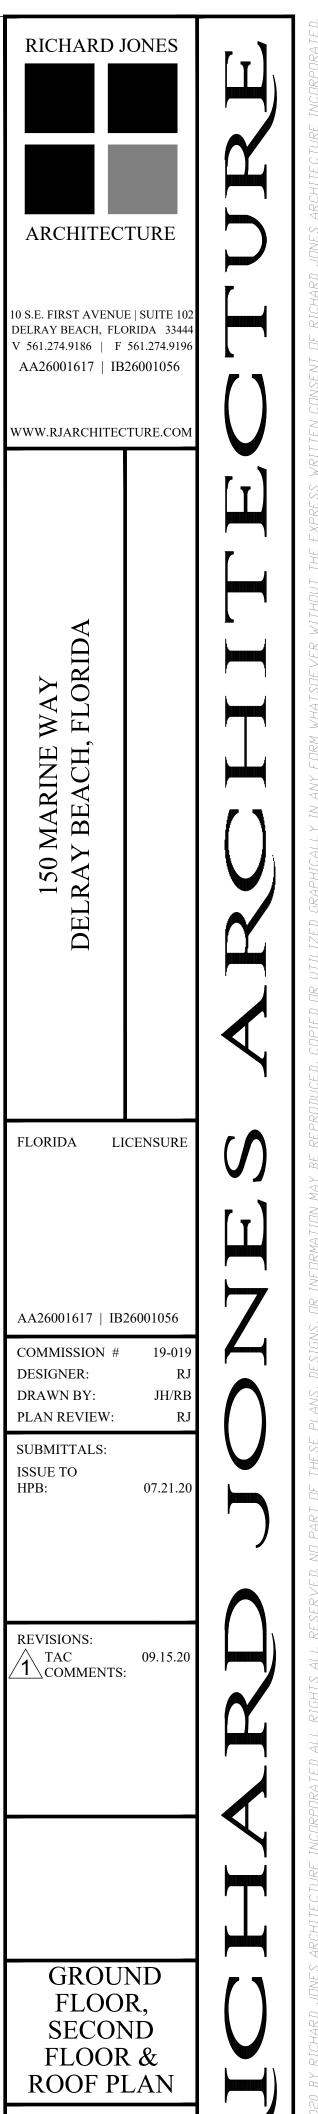

A-1

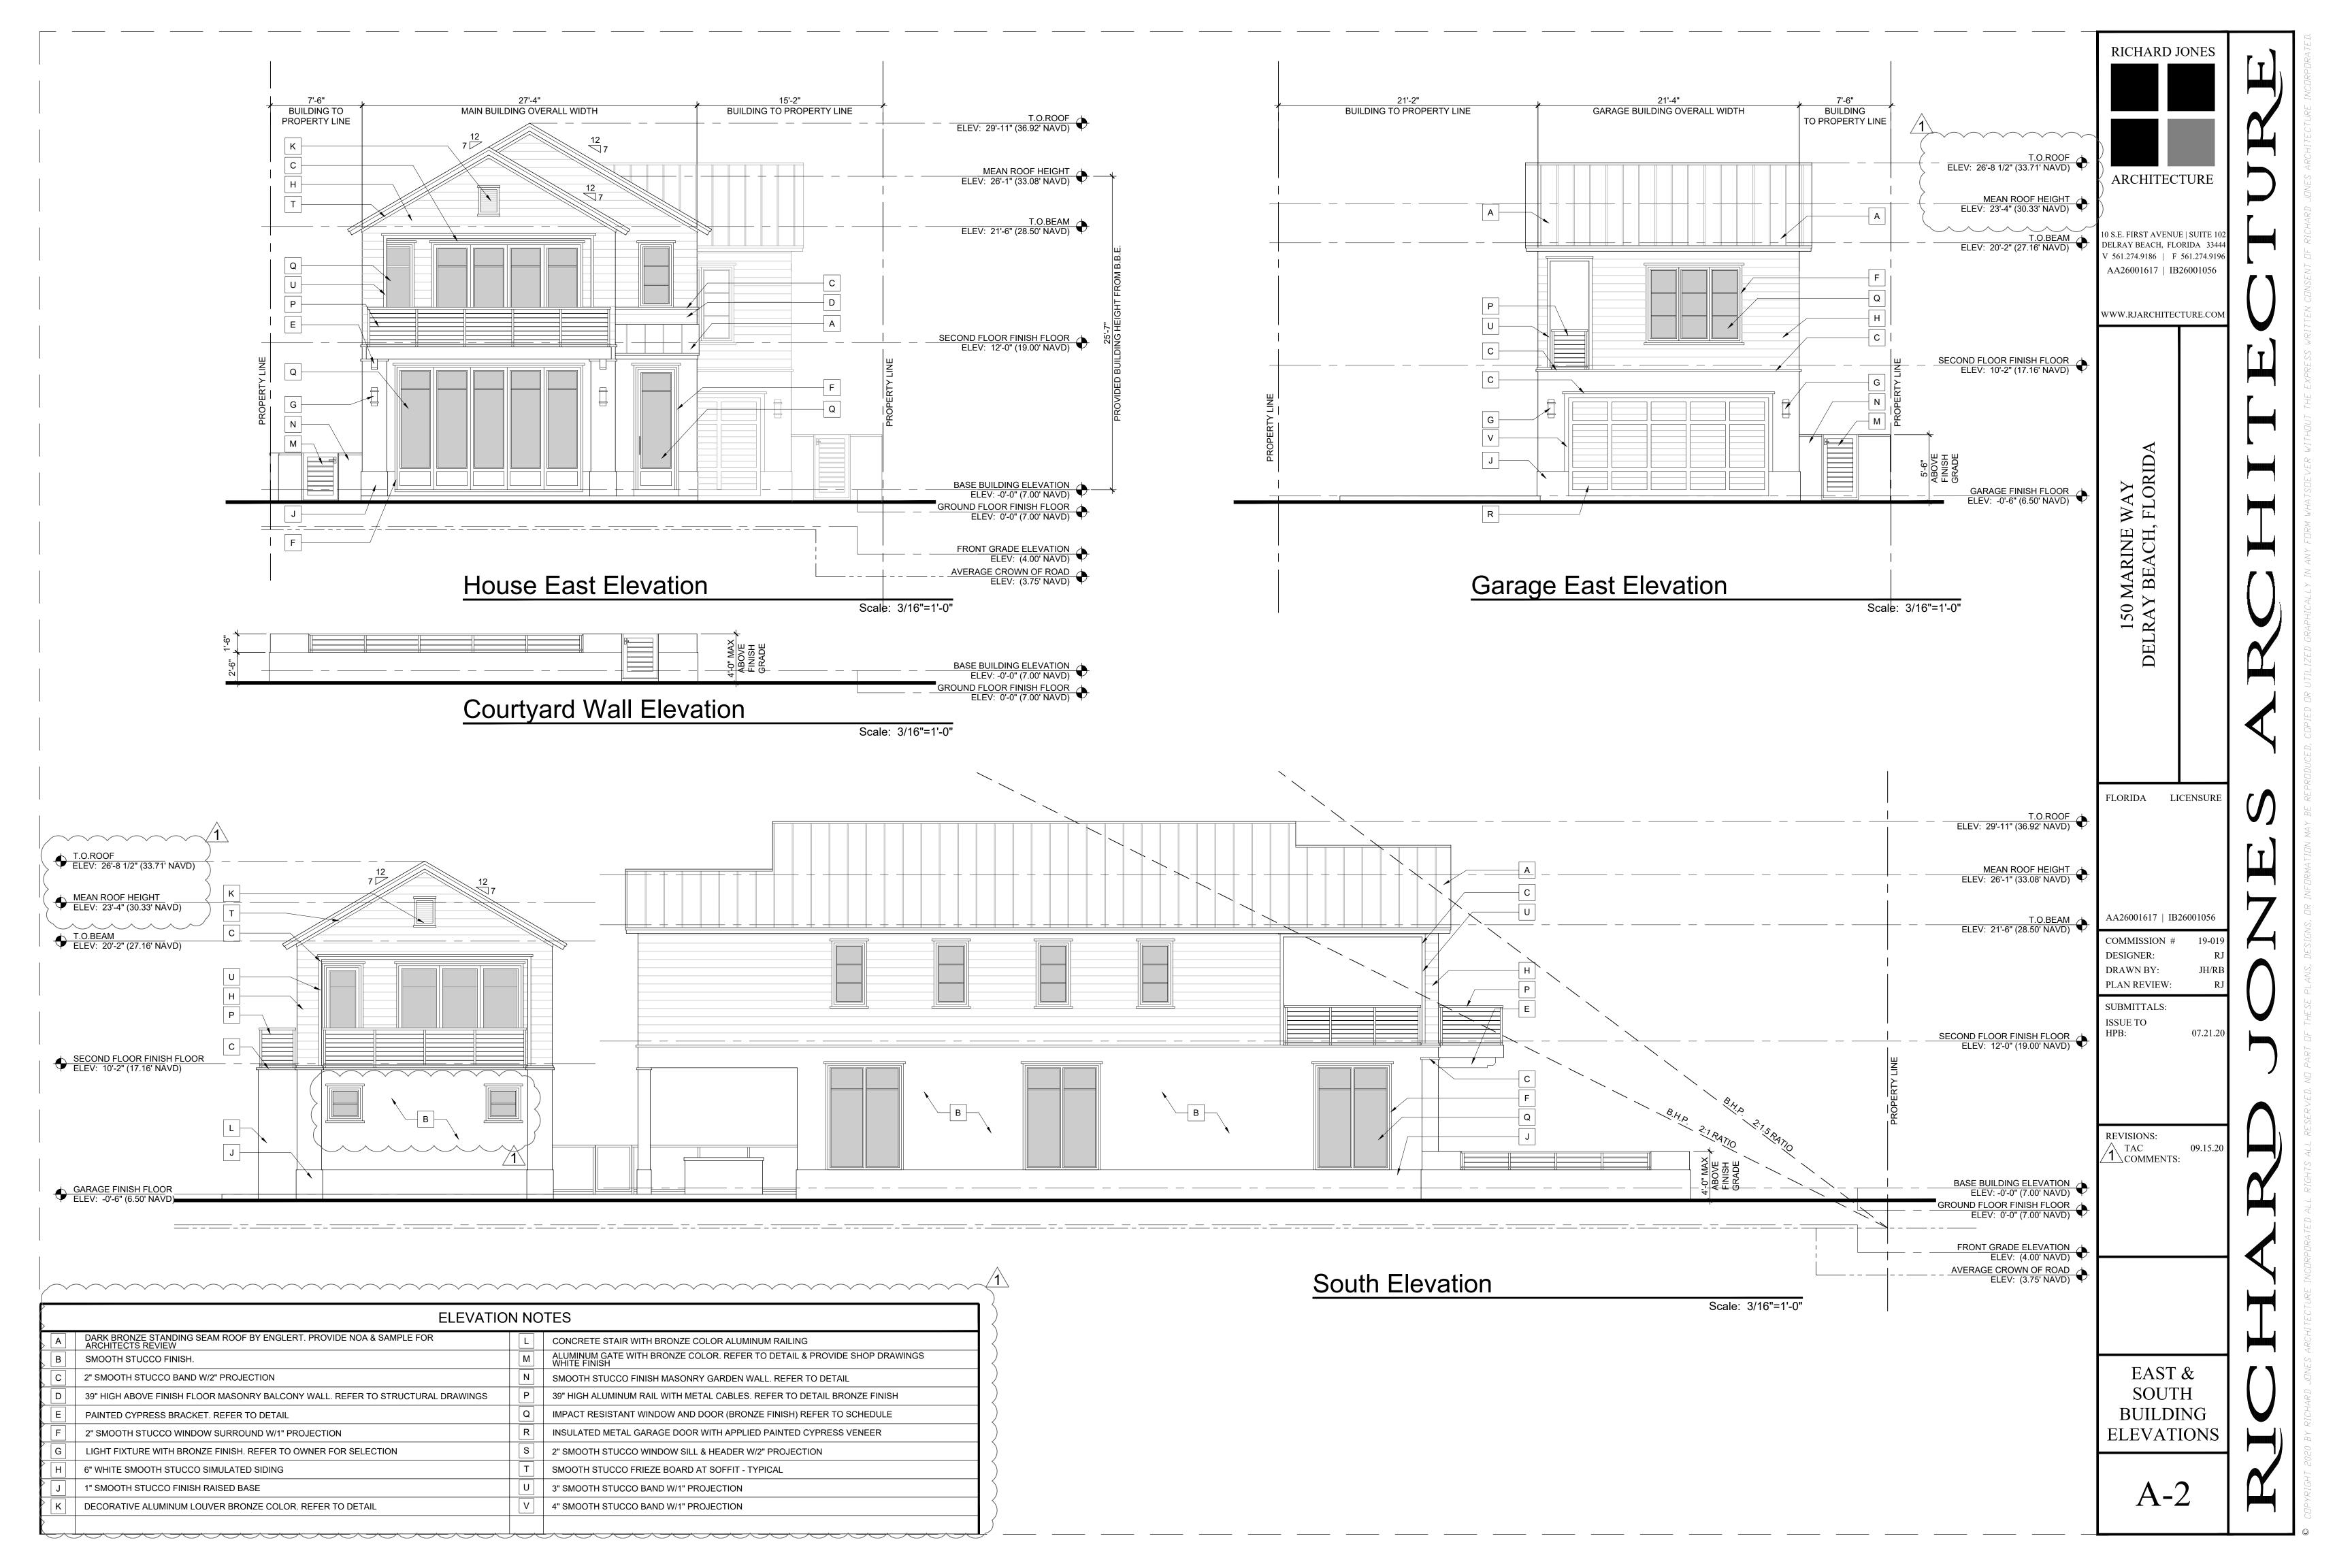


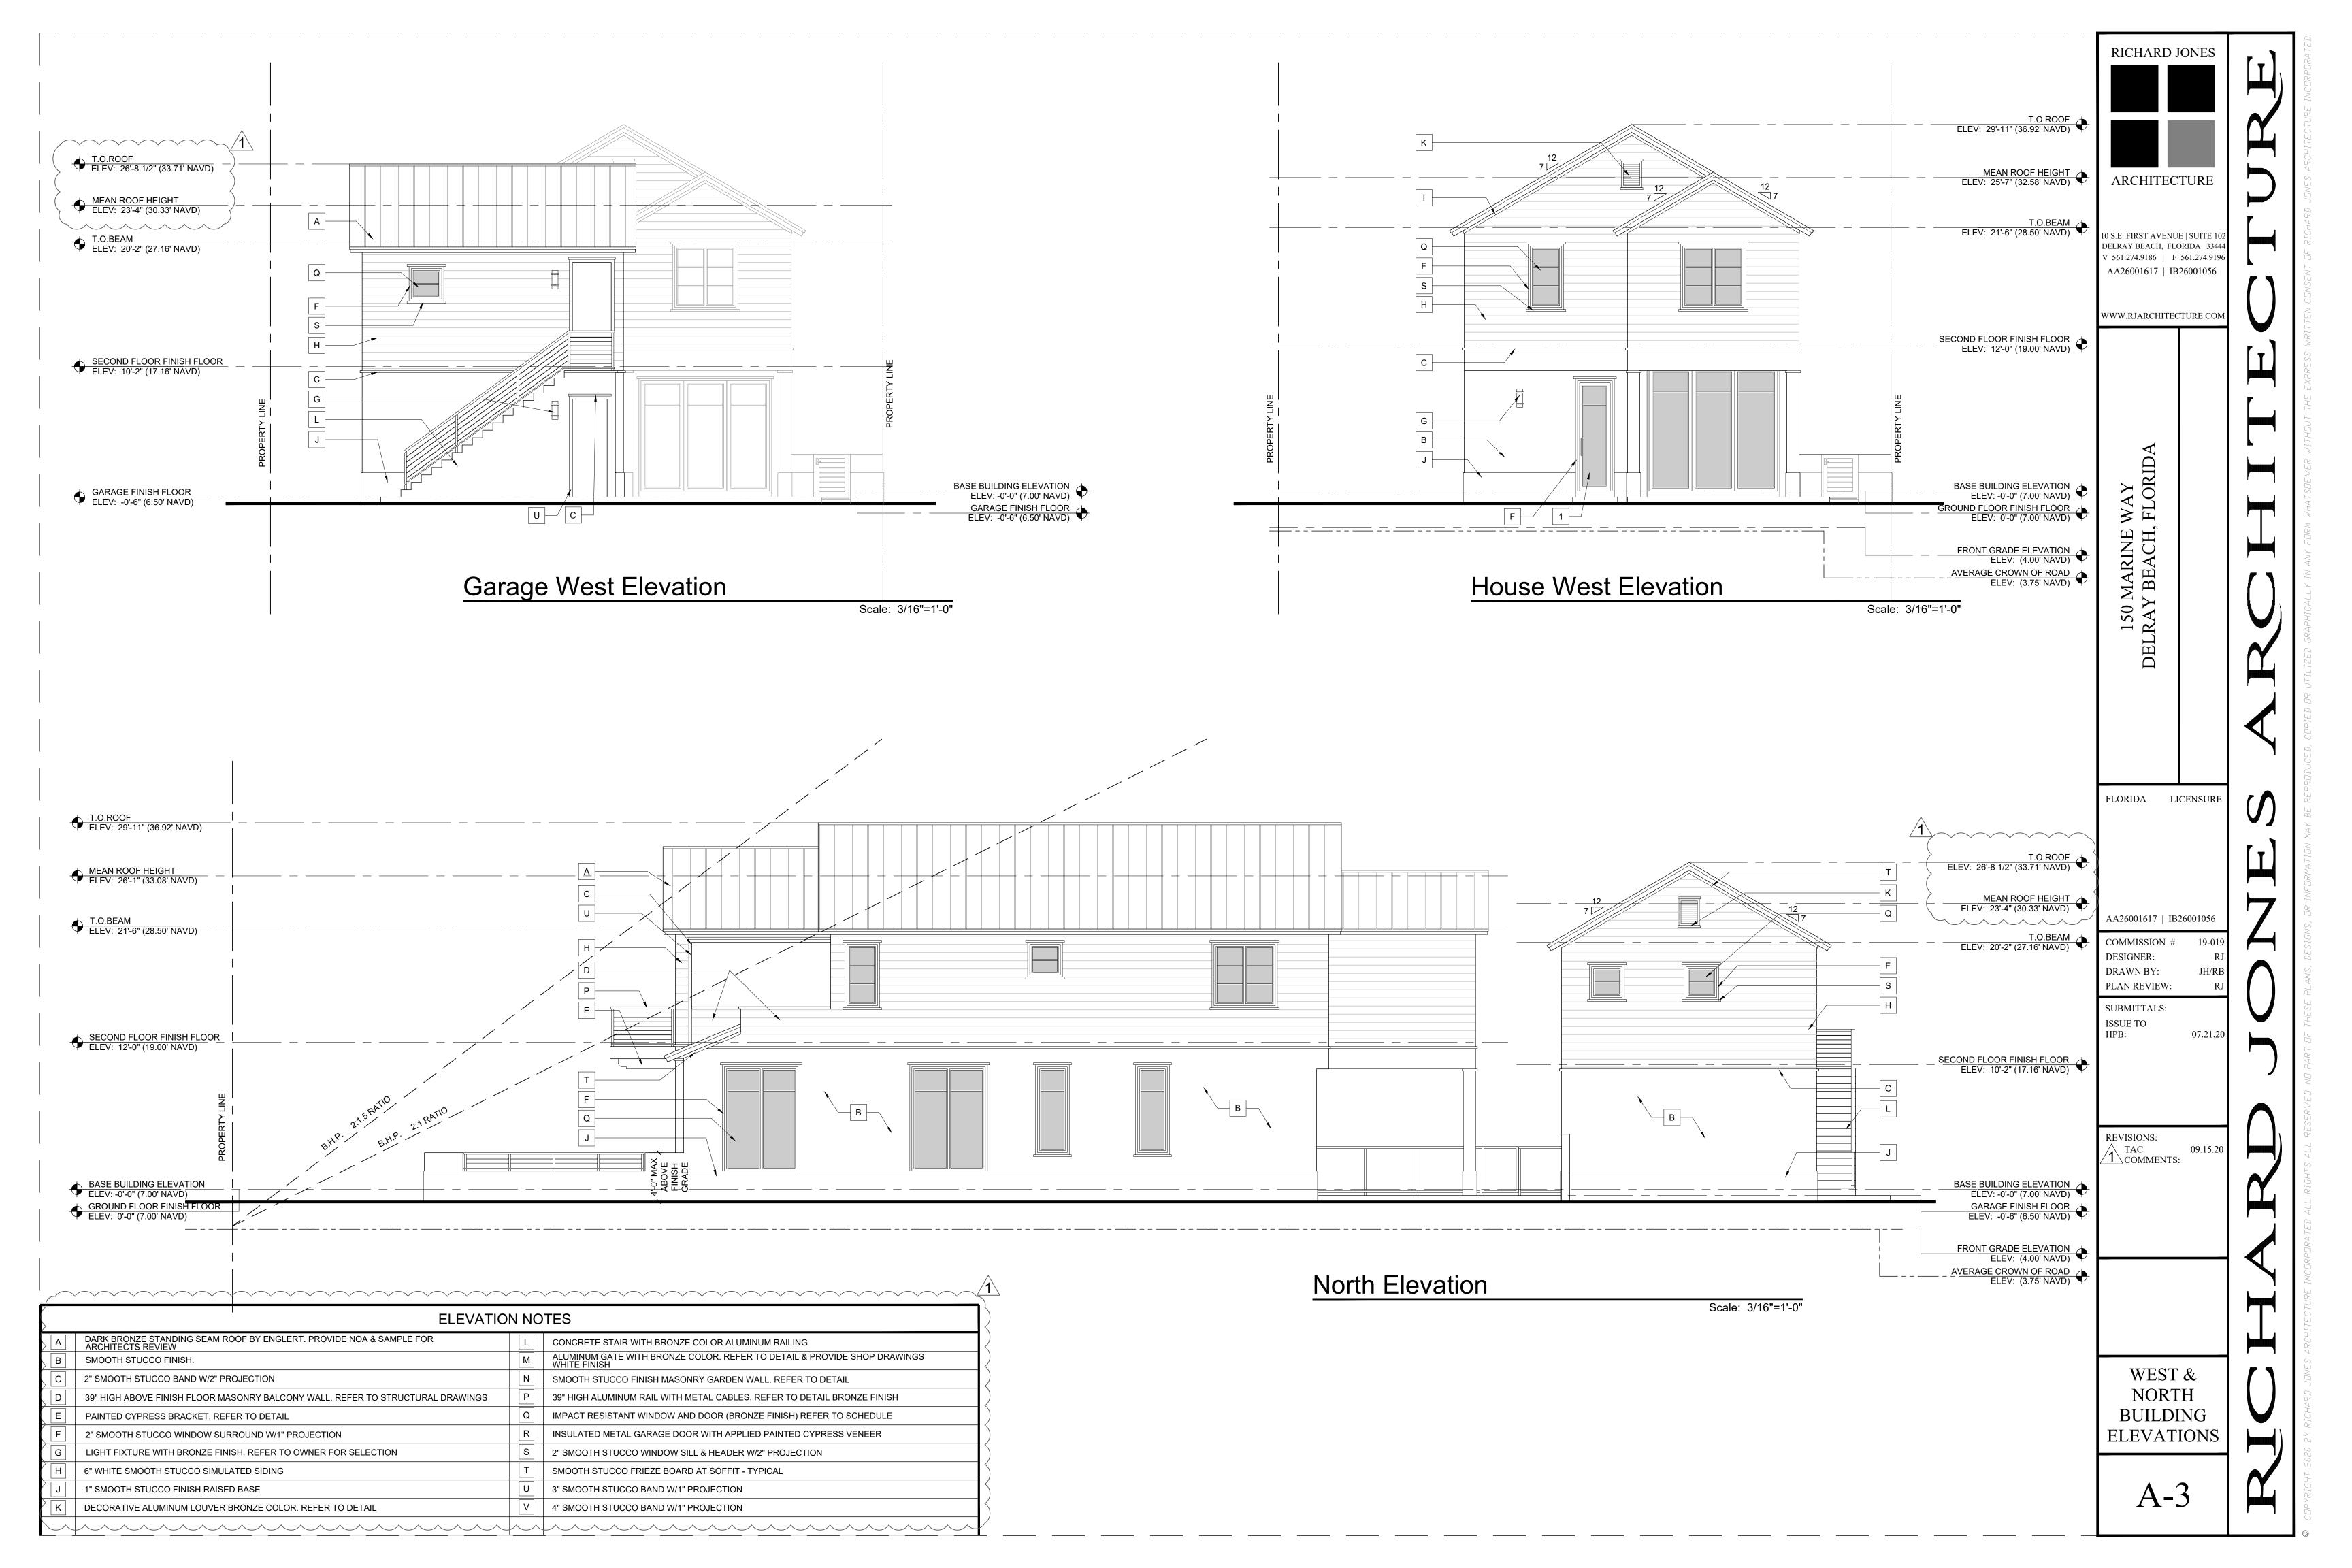

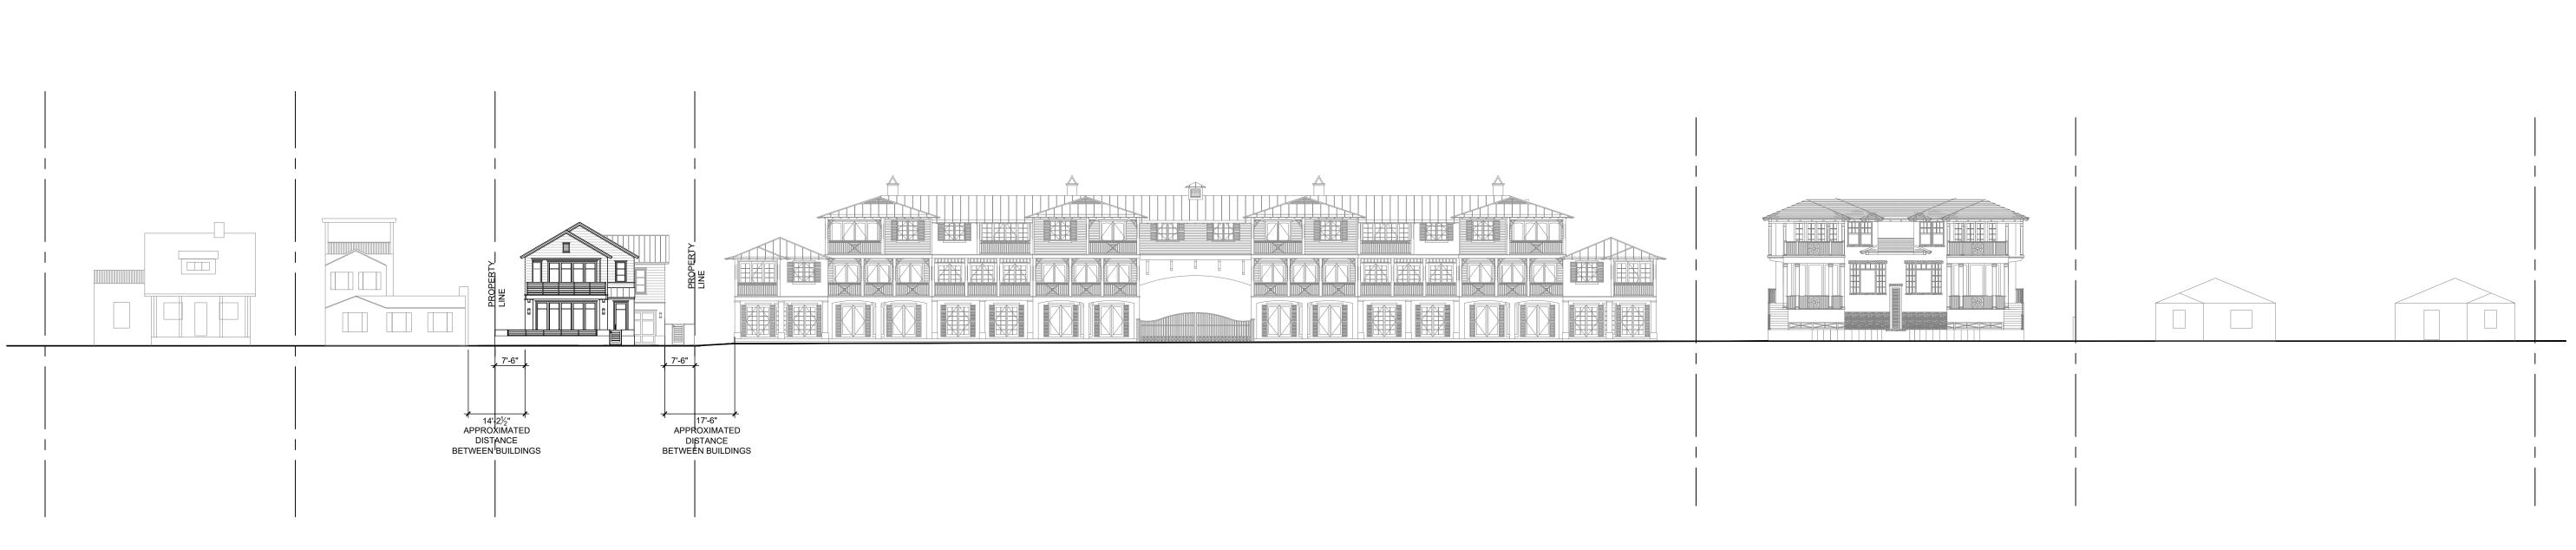


East Side Street Elevation


Scale: n.t.s.

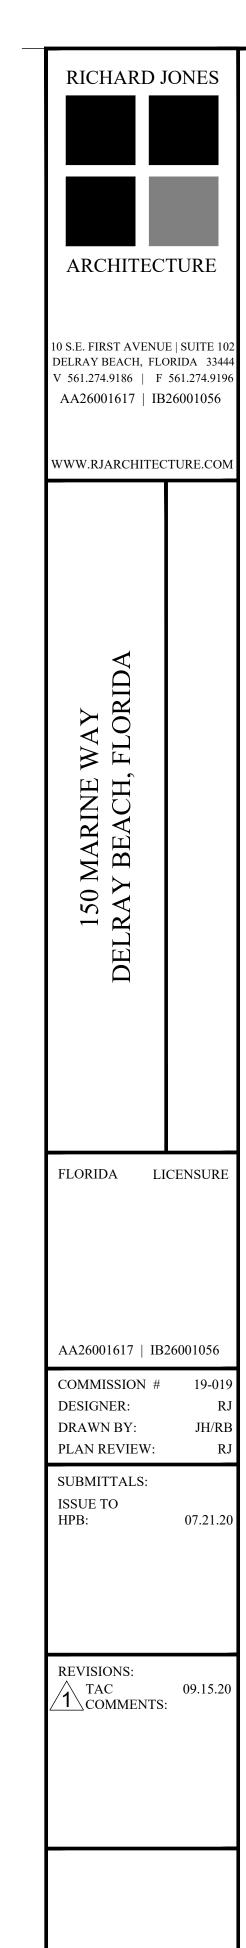


STREET

SCAPE

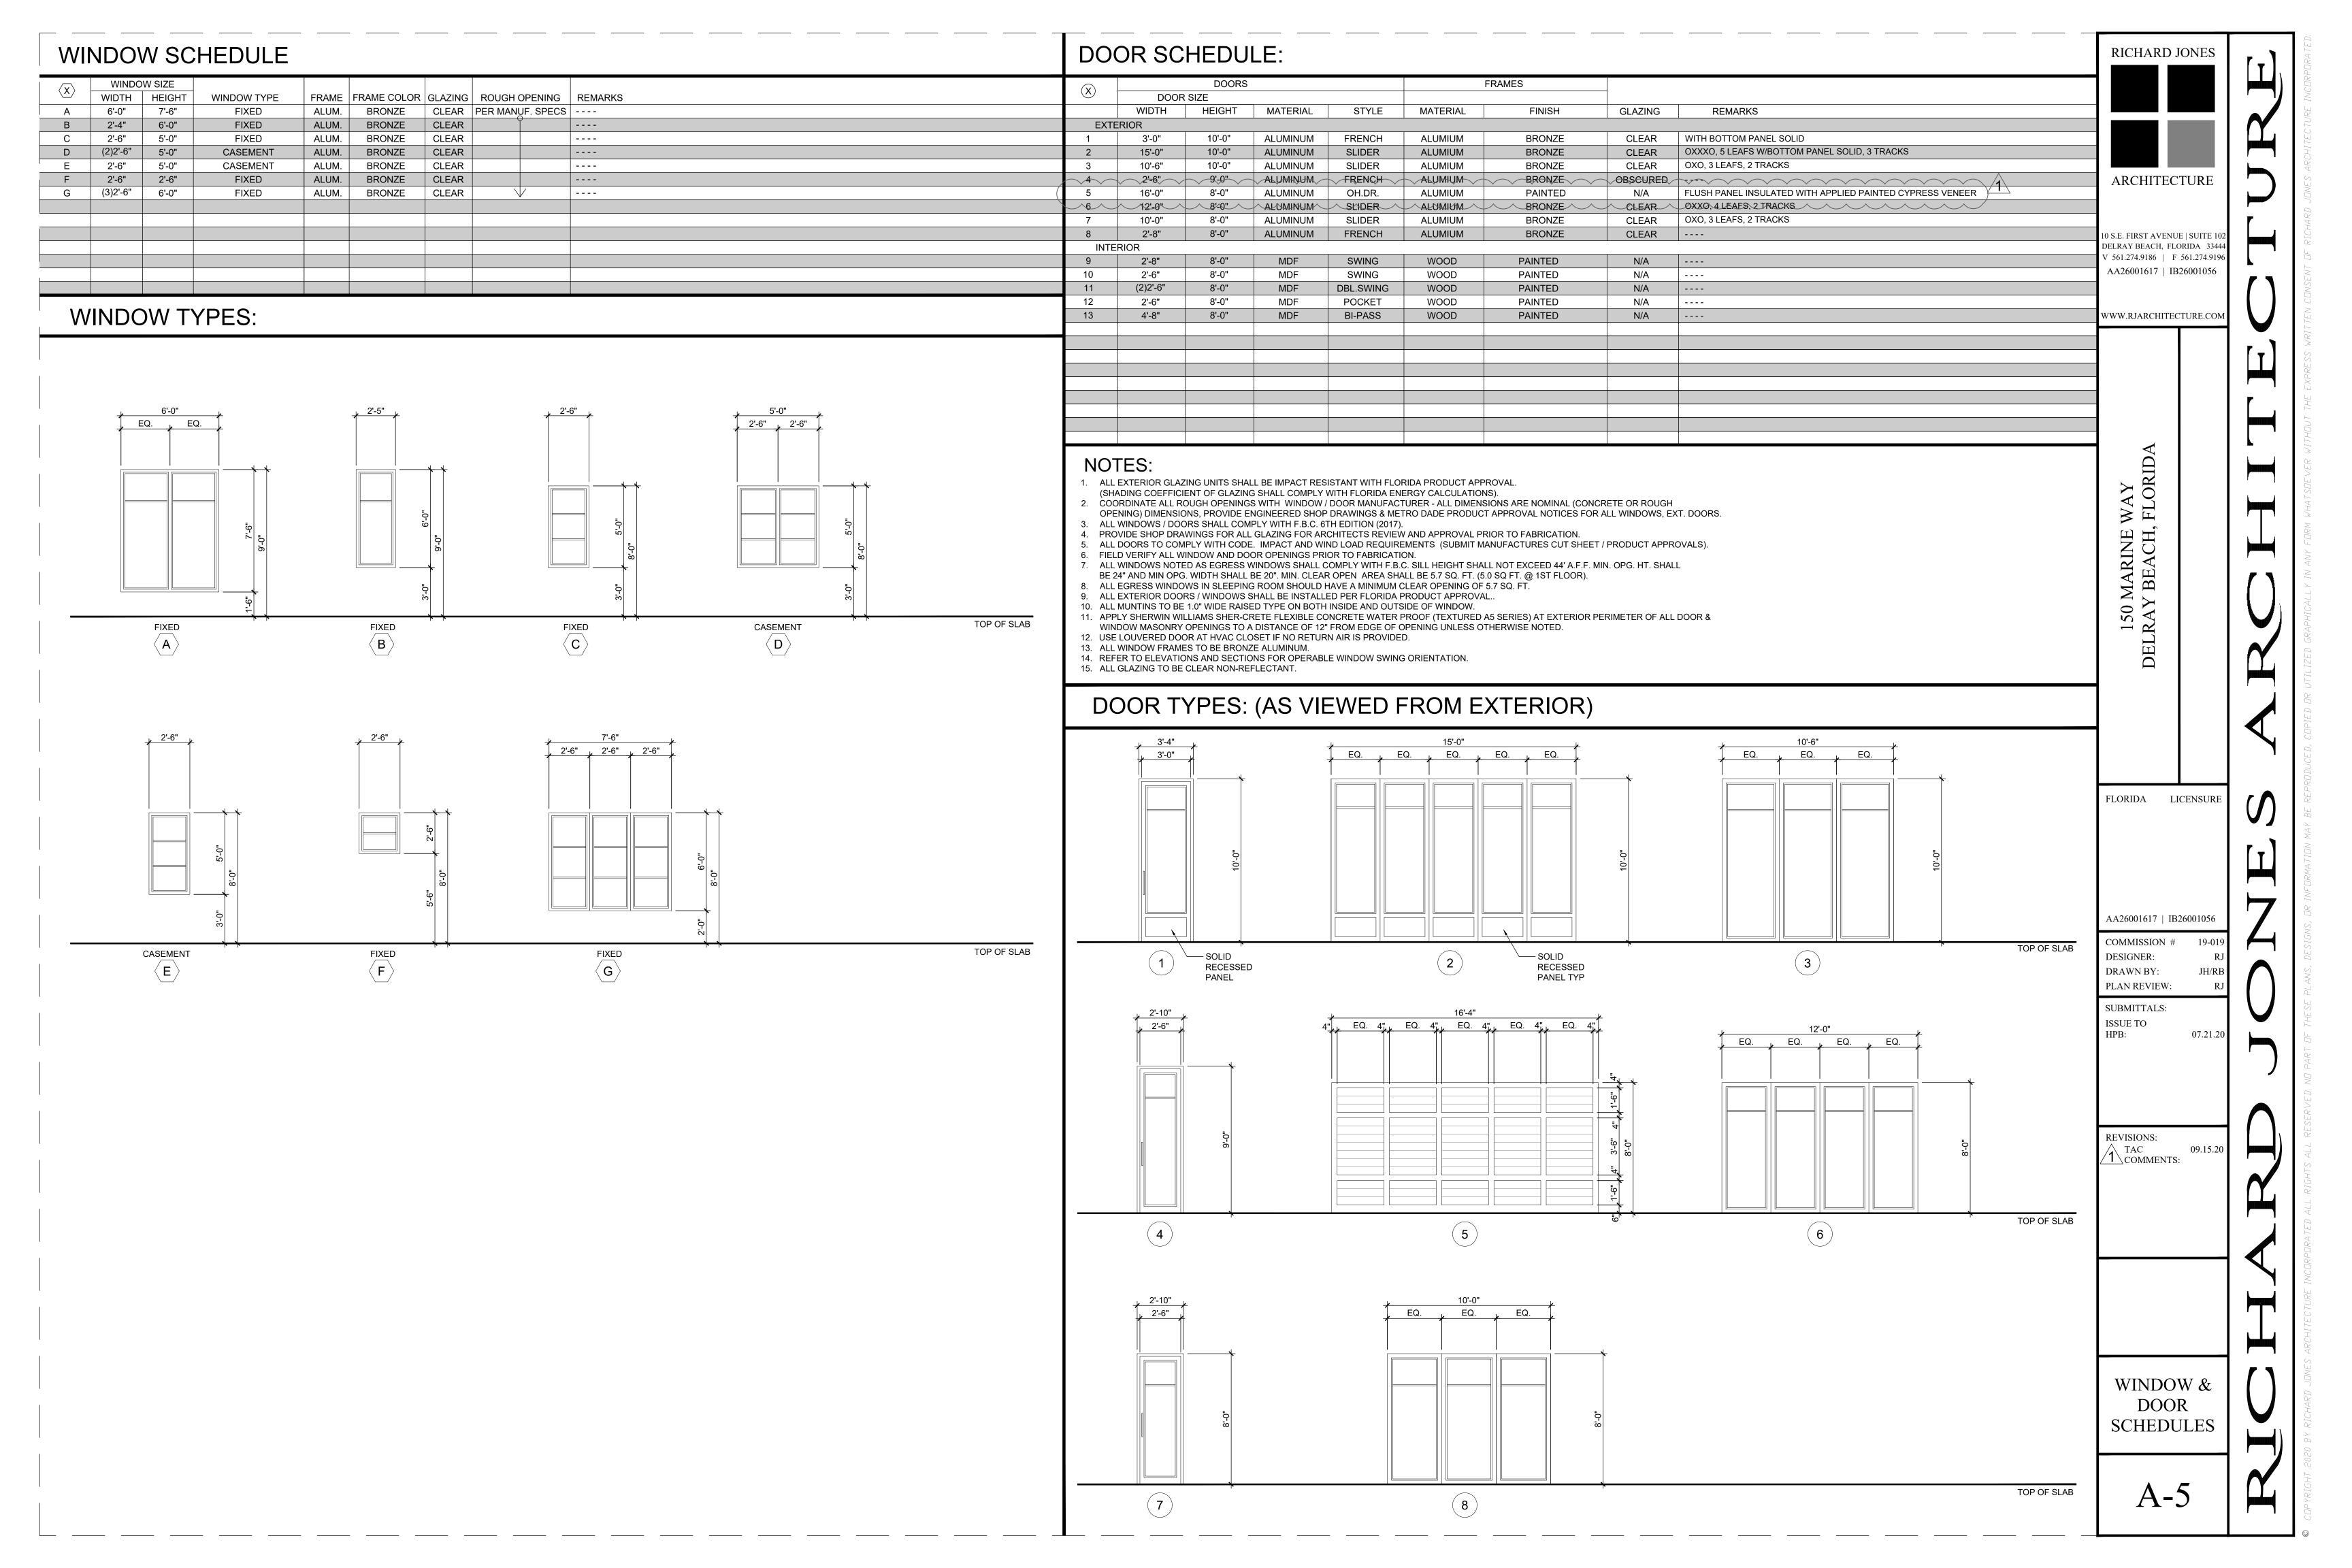

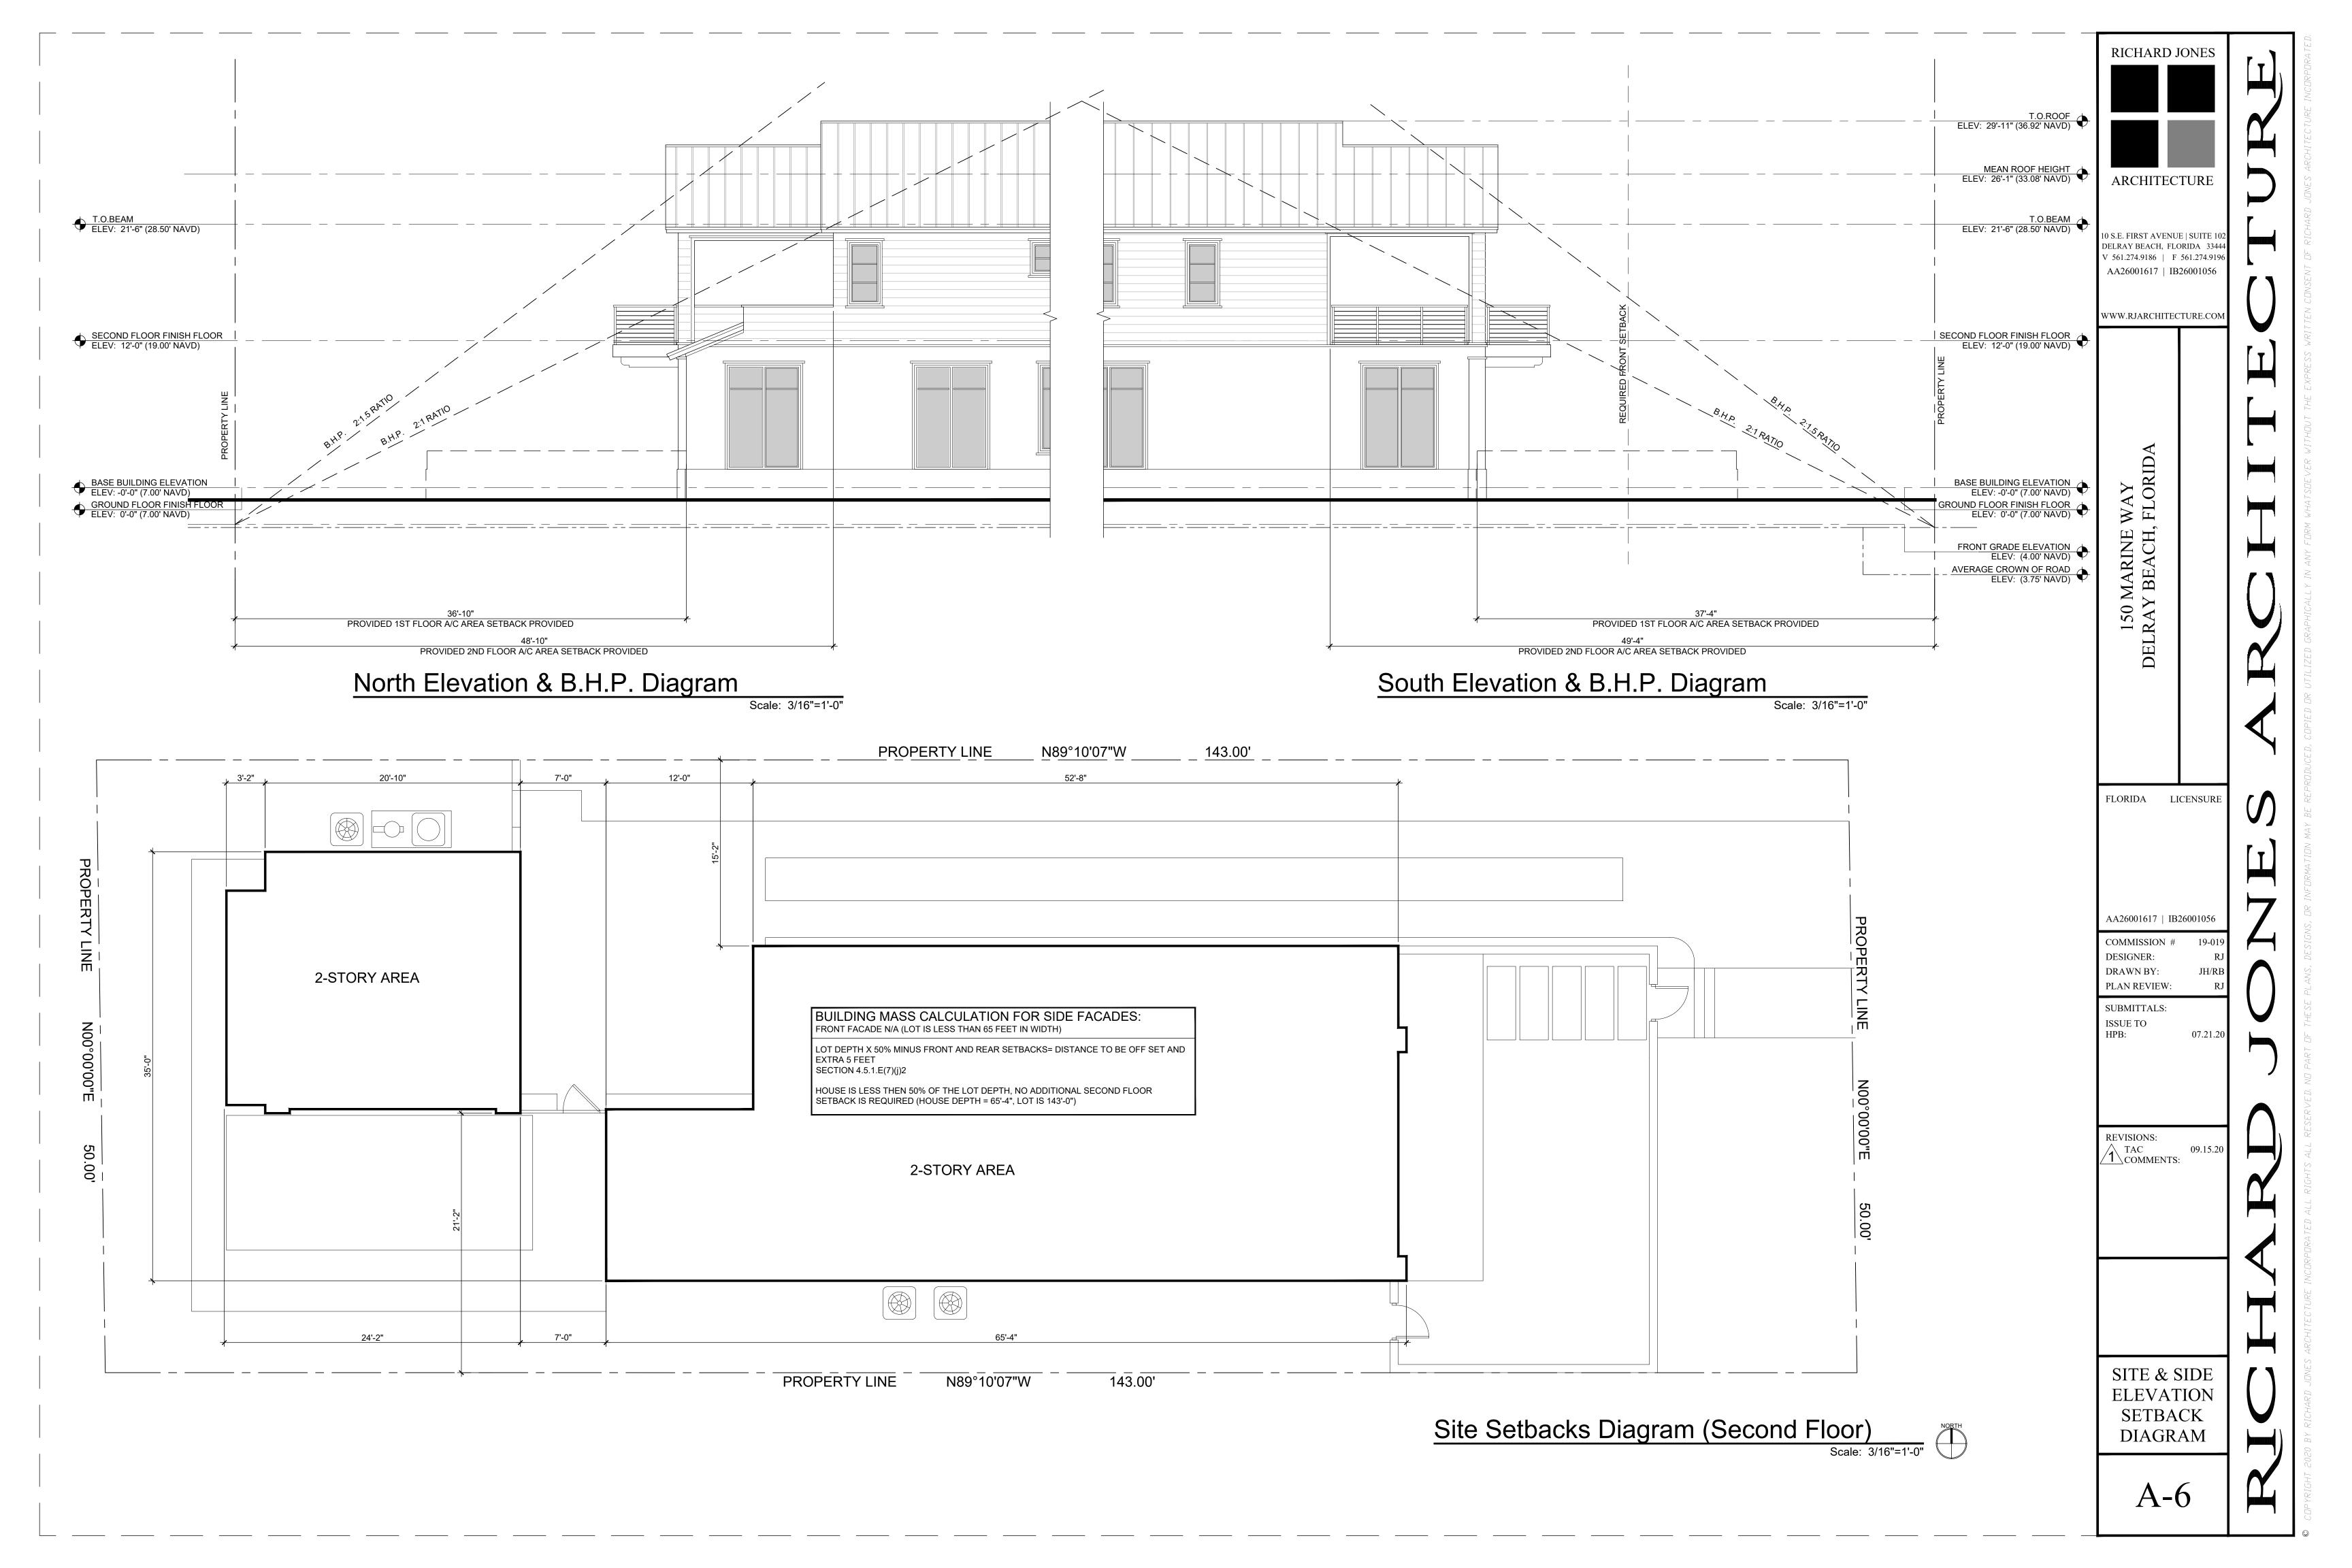

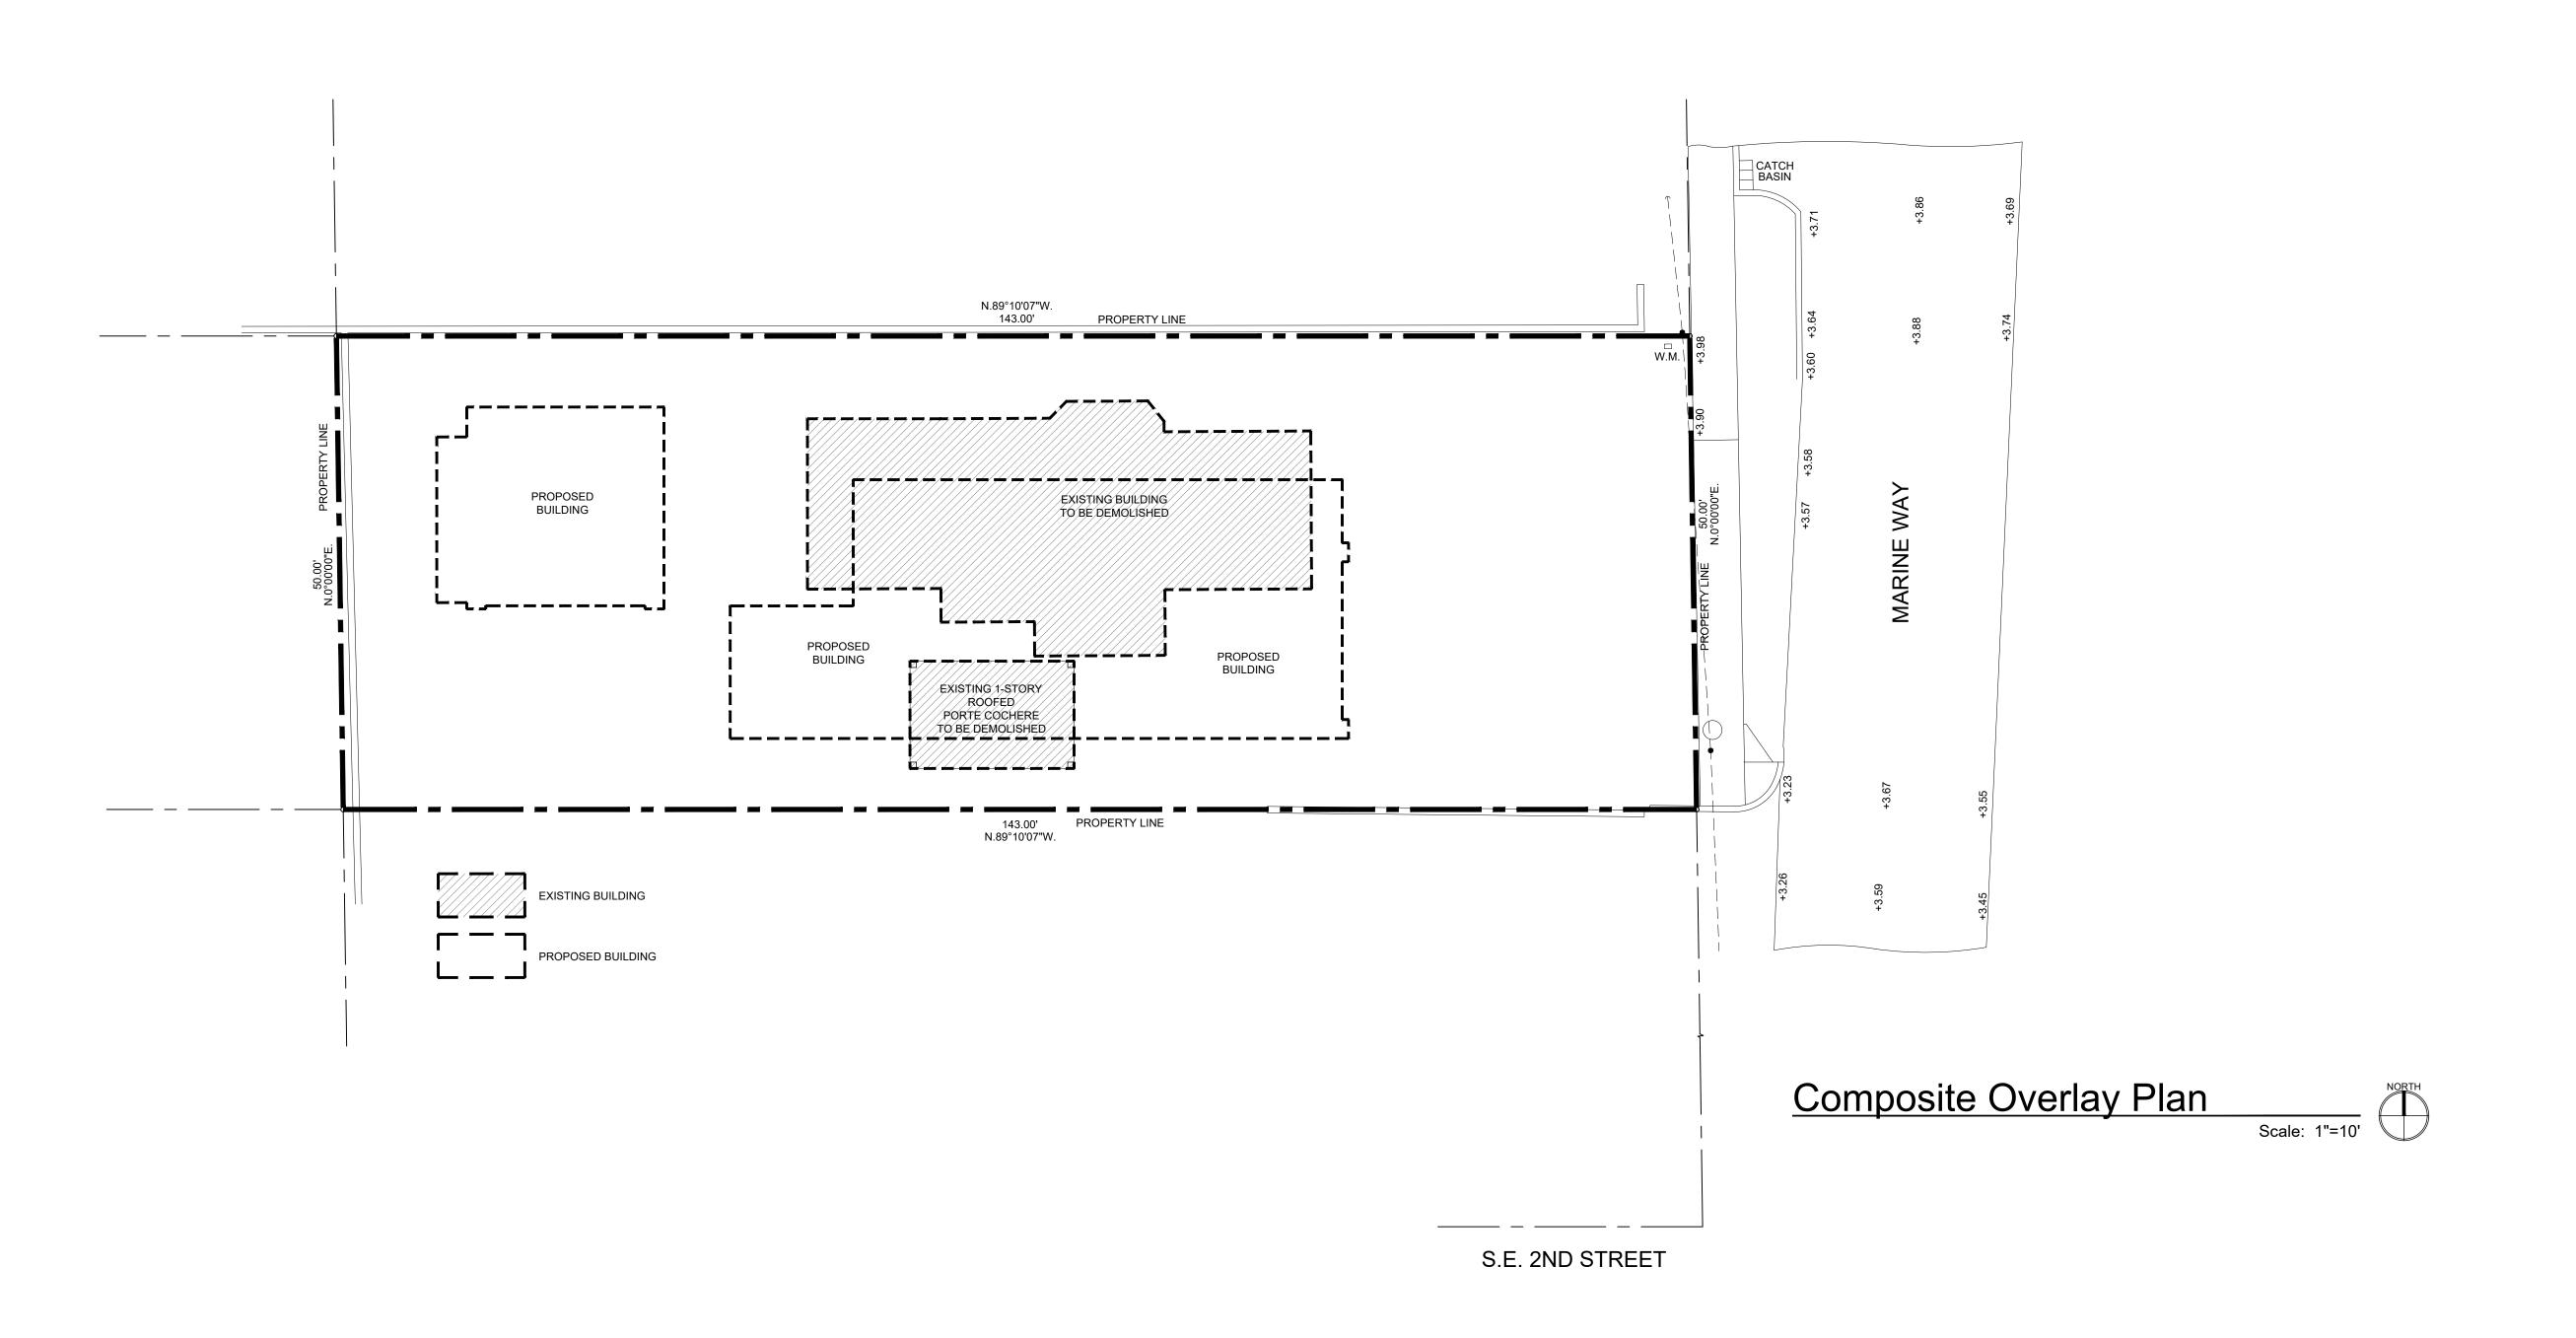












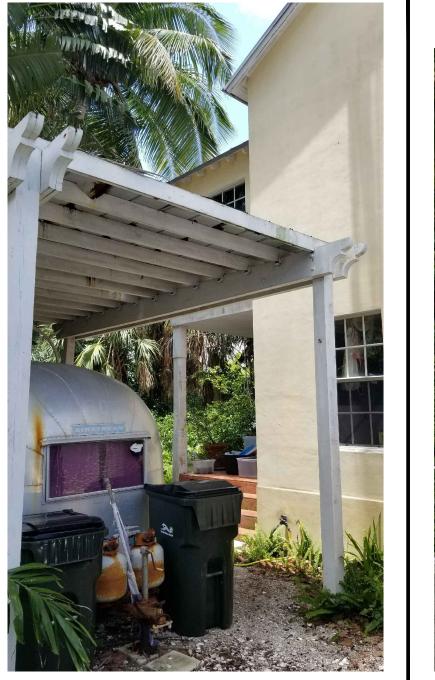



AJACENT PROPERTY TO NORTH

RICHARD JONES ARCHITECTURE

> 10 S.E. FIRST AVENUE | SUITE 102 DELRAY BEACH, FLORIDA 33444 V 561.274.9186 | F 561.274.9196 AA26001617 | IB26001056

WWW.RJARCHITECTURE.COM

150 MARINE V DELRAY BEACH, I

FLORIDA LICENSURE

AA26001617 | IB26001056

PLAN REVIEW

REVISIONS:

TAC
COMMENTS:

COMPOSITE OVERLAY PLAN

A-7

EXISTING PROPERTY

SURVEYOR'S REPORT/LEGEND:

 $\varphi = CENTERLINE$

W.M. = WATER METER

U.B. = UTILITY BOX

A/C = CONCRETE A/C PAD

FLOOD ZONE: AE (EL 6) COMMUNITY PANEL NO. 125102 MAPENN: 12099C0979

MAY AFFECT SUBJECT PARCEL

O.R.B. = OFFICIAL RECORDS BOOK

T.P. = CONCRETE TRANSFORMER PAD

LOT 13, BLOCK 126, A SUBDIVISION OF BLOCK 126, ACCORDING TO THE PLAT THEREOF AS RECORDED IN PLAT BOOK 11, PAGE 4, PUBLIC RECORDS OF PALM BEACH COUNTY, FLORIDA.

CERTIFIED TO:

AZURE 150 MARINE, LLC LAW FIRM OF JOHN C. PRIMEAU, P.A. OLD REPUBLIC NATIONAL TITLE INSURANCE COMPANY SEACOAST NATIONAL BANK, ISAOA/ATIMA WARD DAMON, PL

MAP OF AS-BUILT SURVEY SITE ADDRESS: 150 MARINE WAY, DELRAY BEACH, FLORIDA 33483 PARCEL CONTROL NO. 12-43-46-16-01-126-0130

I HEREBY CERTIFY THAT THIS SURVEY WAS MADE UNDER MY RESPONSIBLE CHARGE AND MEETS THE STANDARDS OF PRACTICE AS SET FORTH BY THE FLORIDA BOARD OF PROFESSIONAL SURVEYORS AND MAPPERS IN CHAPTER 5J—17, FLORIDA ADMINISTRATIVE CODE, PURSUANT TO SECTION 472.027, FLORIDA STATUTES.

O'BRIEN, SUITER & O'BRIEN, INC.

LAND SURVEYORS CERTIFICATE OF AUTHORIZATION #LB353
SURVEYOR AND MAPPER IN RESPONSIBLE CHARGE: PAUL D. ENGLE
955 N.W. 17TH AVENUE, SUITE K-1, DELRAY BEACH, FLORIDA 33445
(561) 276-4501 732-3279 FAX 276-2390

DATE OF SURVEY SEPT. 15, 2020 FIELD BOOK PAGE NO. D.320

1" = 10' ORDER NO.: 19–15db

