E	XISTI	NG TREE LIST	
TREE#	NAME/ DI	AME/ DIAMETER/ CONDITION	
1	Qvt	Quercus virginiana/ Live oak tree - 15" calip	RU
2	Qvt	Quercus virginiana/ Live oak tree - 12" calip	RU
3	Qvt	Quercus virginiana/ Live oak tree - 18" calip	RU
4	Qvt	Quercus virginiana/ Live oak tree - 20" calip	RU
5	Sp	Sabal palm 8" calip	RU
6	Cnp	Cocos nucifera palm / Coconut palm 18" calip	RU
7	Sp	Sabal palm 20' o.a.	RU
8	Ficus	Ficus benjamina / Ficus	RU
9	Sp	Sabal palm 16' o.a.	RU
10	Amp-18	Adonidia merrillii / Christmas palm 18' o.a.	RU
11	Amp-18	Adonidia merrillii / Christmas palm 18' o.a.	RU
12	Qvt	Quercus virginiana/ Live oak tree - 12" calip	RU
חבו ח	EL OO ATE		<u> </u>

REL = RELOCATE

TBR = TO BE REMOVED RU = REMAIN UNCHANGED

**- (See Mitigation Chart Landscape Plan)

RELOCATION NOTES:

1. All canopy tree's designated as relocated on the plans, are to be root-pruned for a minimum of 3 months prior to the relocation process.

2. The root ball size for each tree will depend on the caliper of the individual tree to be relocated. The size of the root ball shall be adequate to support & sustain the viability

3. All root cuts shall be ""clean cuts"", and the back fill material shall be well drained planting soils, or pre-approved equal. All road rock, and undesirable fill materials shall be removed from root-prune trench.

4. Temporary irrigation shall be provided to all root-pruned trees during the root-pruning process, and after the tree's have been relocated to their location for a minimum of 4 months, or as necessary to insure their survivability.

5. The canopies of all tree's shall be reduced by a minimum of 20% at time of root

6. All tree's shall be relocated with machinery (I.e., crane, front-end loader, tree spade, or equal) capable of handling the material without damaging any portion of the tree. The Landscape Architect will pre-approve all methods utilized for the relocation

7. All relocation work shall comply with the National Arborists Standards.

REMOVAL NOTES:

1. All tree's to be removed shall be completely removed from the site.

2. The root systems, of the removals, shall be removed in such a manner to facilitate the installation of new tree's, or palms. Root system removal shall be a minimum of 24"" depth, and a 6 foot diameter around the trunk.

3. TREE REMOVAL PERMITS WILL BE REQUIRED BY THE GOVERNING MUNICIPALITY, AND IT SHALL BE THE CONTRACTORS RESPONSIBILITY TO OBTAIN ALL NECESSARY PERMITS.

ALL UNDERGROUND UTILITIES SHALL BE LOCATED PRIOR TO COMMENCING ANY WORK ON THE SITE, PER FLORIDA LAW.

New Materials To conform To City Of Ft. Lauderdale Requirements. All Tree Replacements Shall Also Replace Said Tree's Caliper Inches So As To Maintain Caliper Sizes. All Tree Replacements Shall Be Florida #1 Grade.


All undeveloped portions of a parcel of land shall be left undisturbed or planted with ground cover, or lawn, as to leave no exposed soils in order to prevent dust or soil erosion, as per ULDR 47-21.9.M

Trees To Be Relocated

Trees To Be Removed Due To

Trees To Be Removed Due
Poor Condition, Branching
Structure. Low Crotch Or Damaged Trunk Structures

Remove All Exotic Nuisance Species, Including But Not Limited To (Fl. Holly, Australian Pine, Melaleuca, etc.) Per State and Local Zoning & Landscape Code(s).

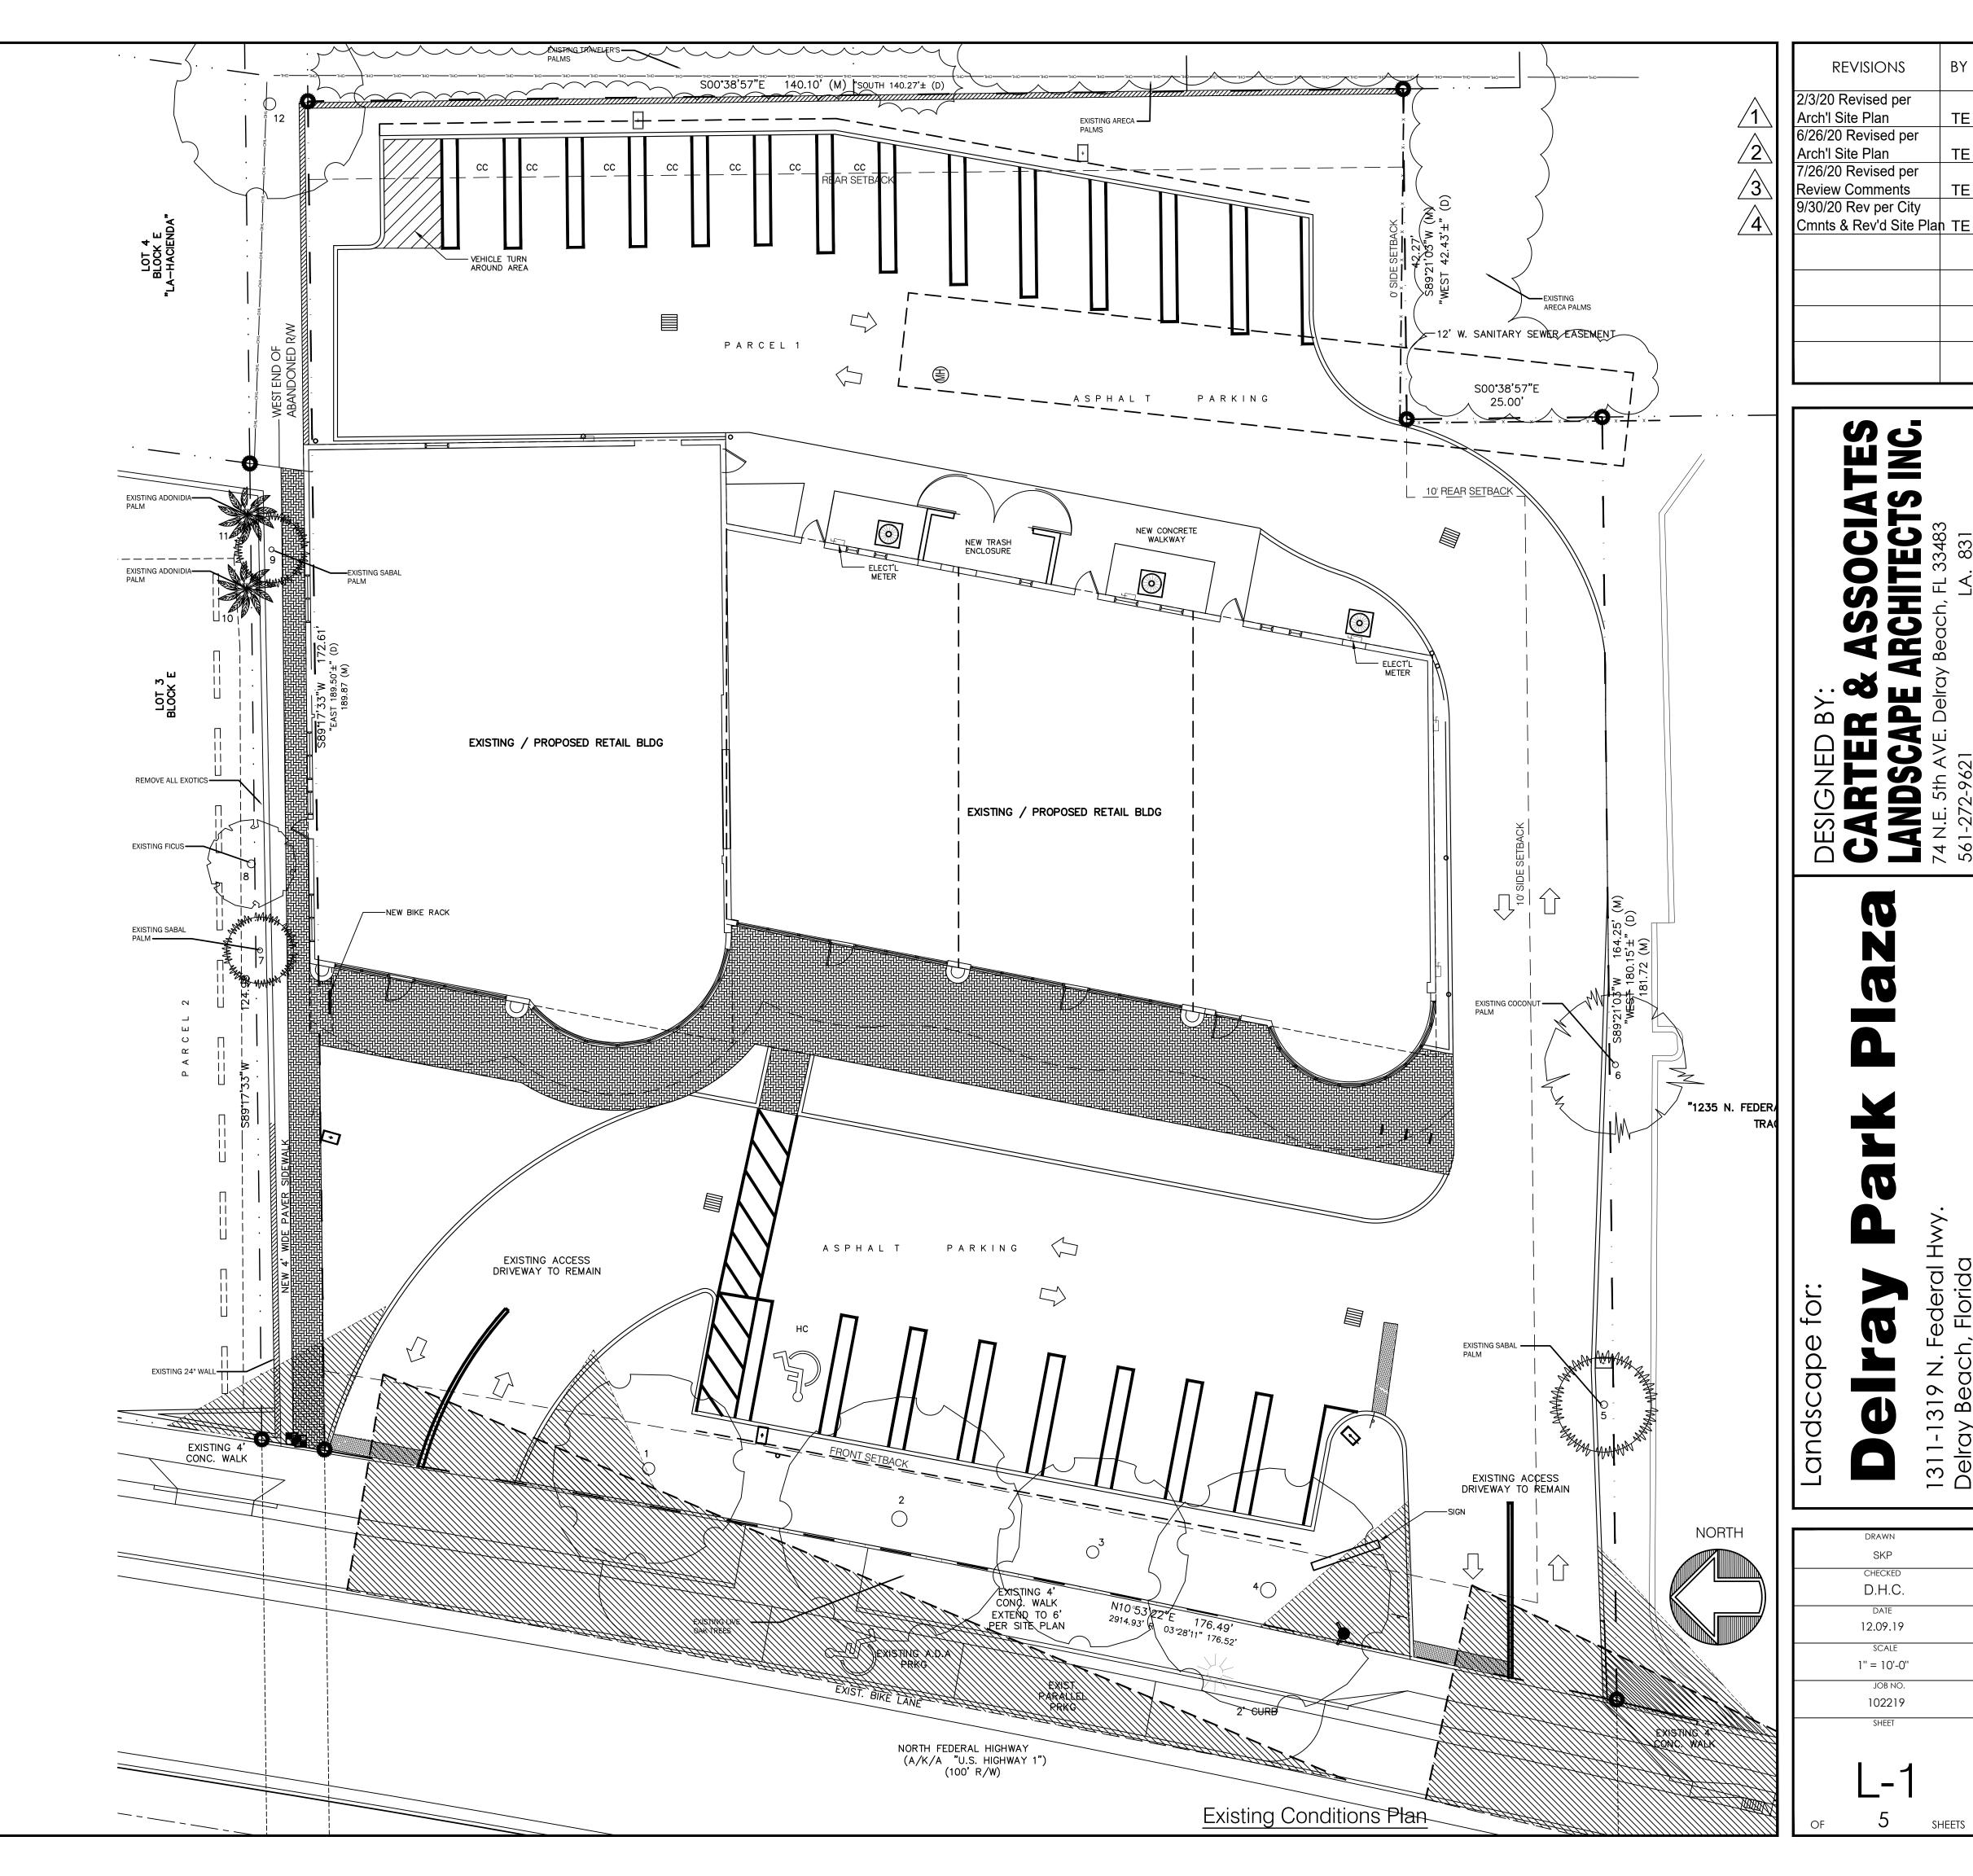


SKP

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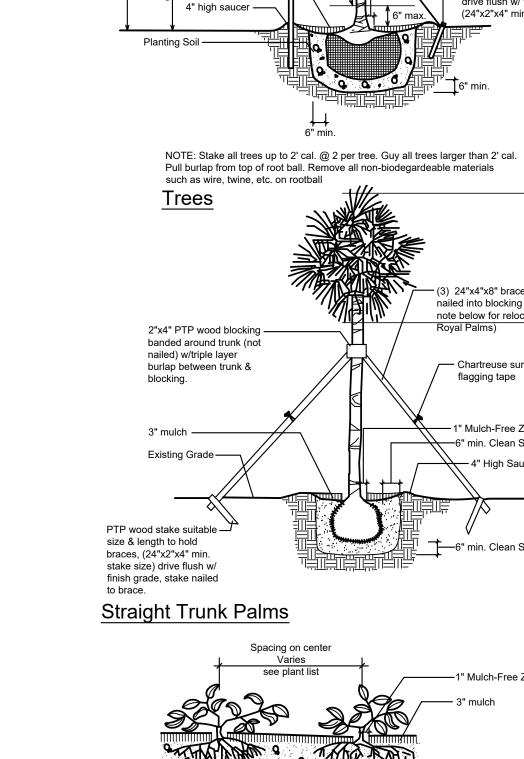
D.H.C.

12.09.19

1'' = 10'-0'' JOB NO. 102219

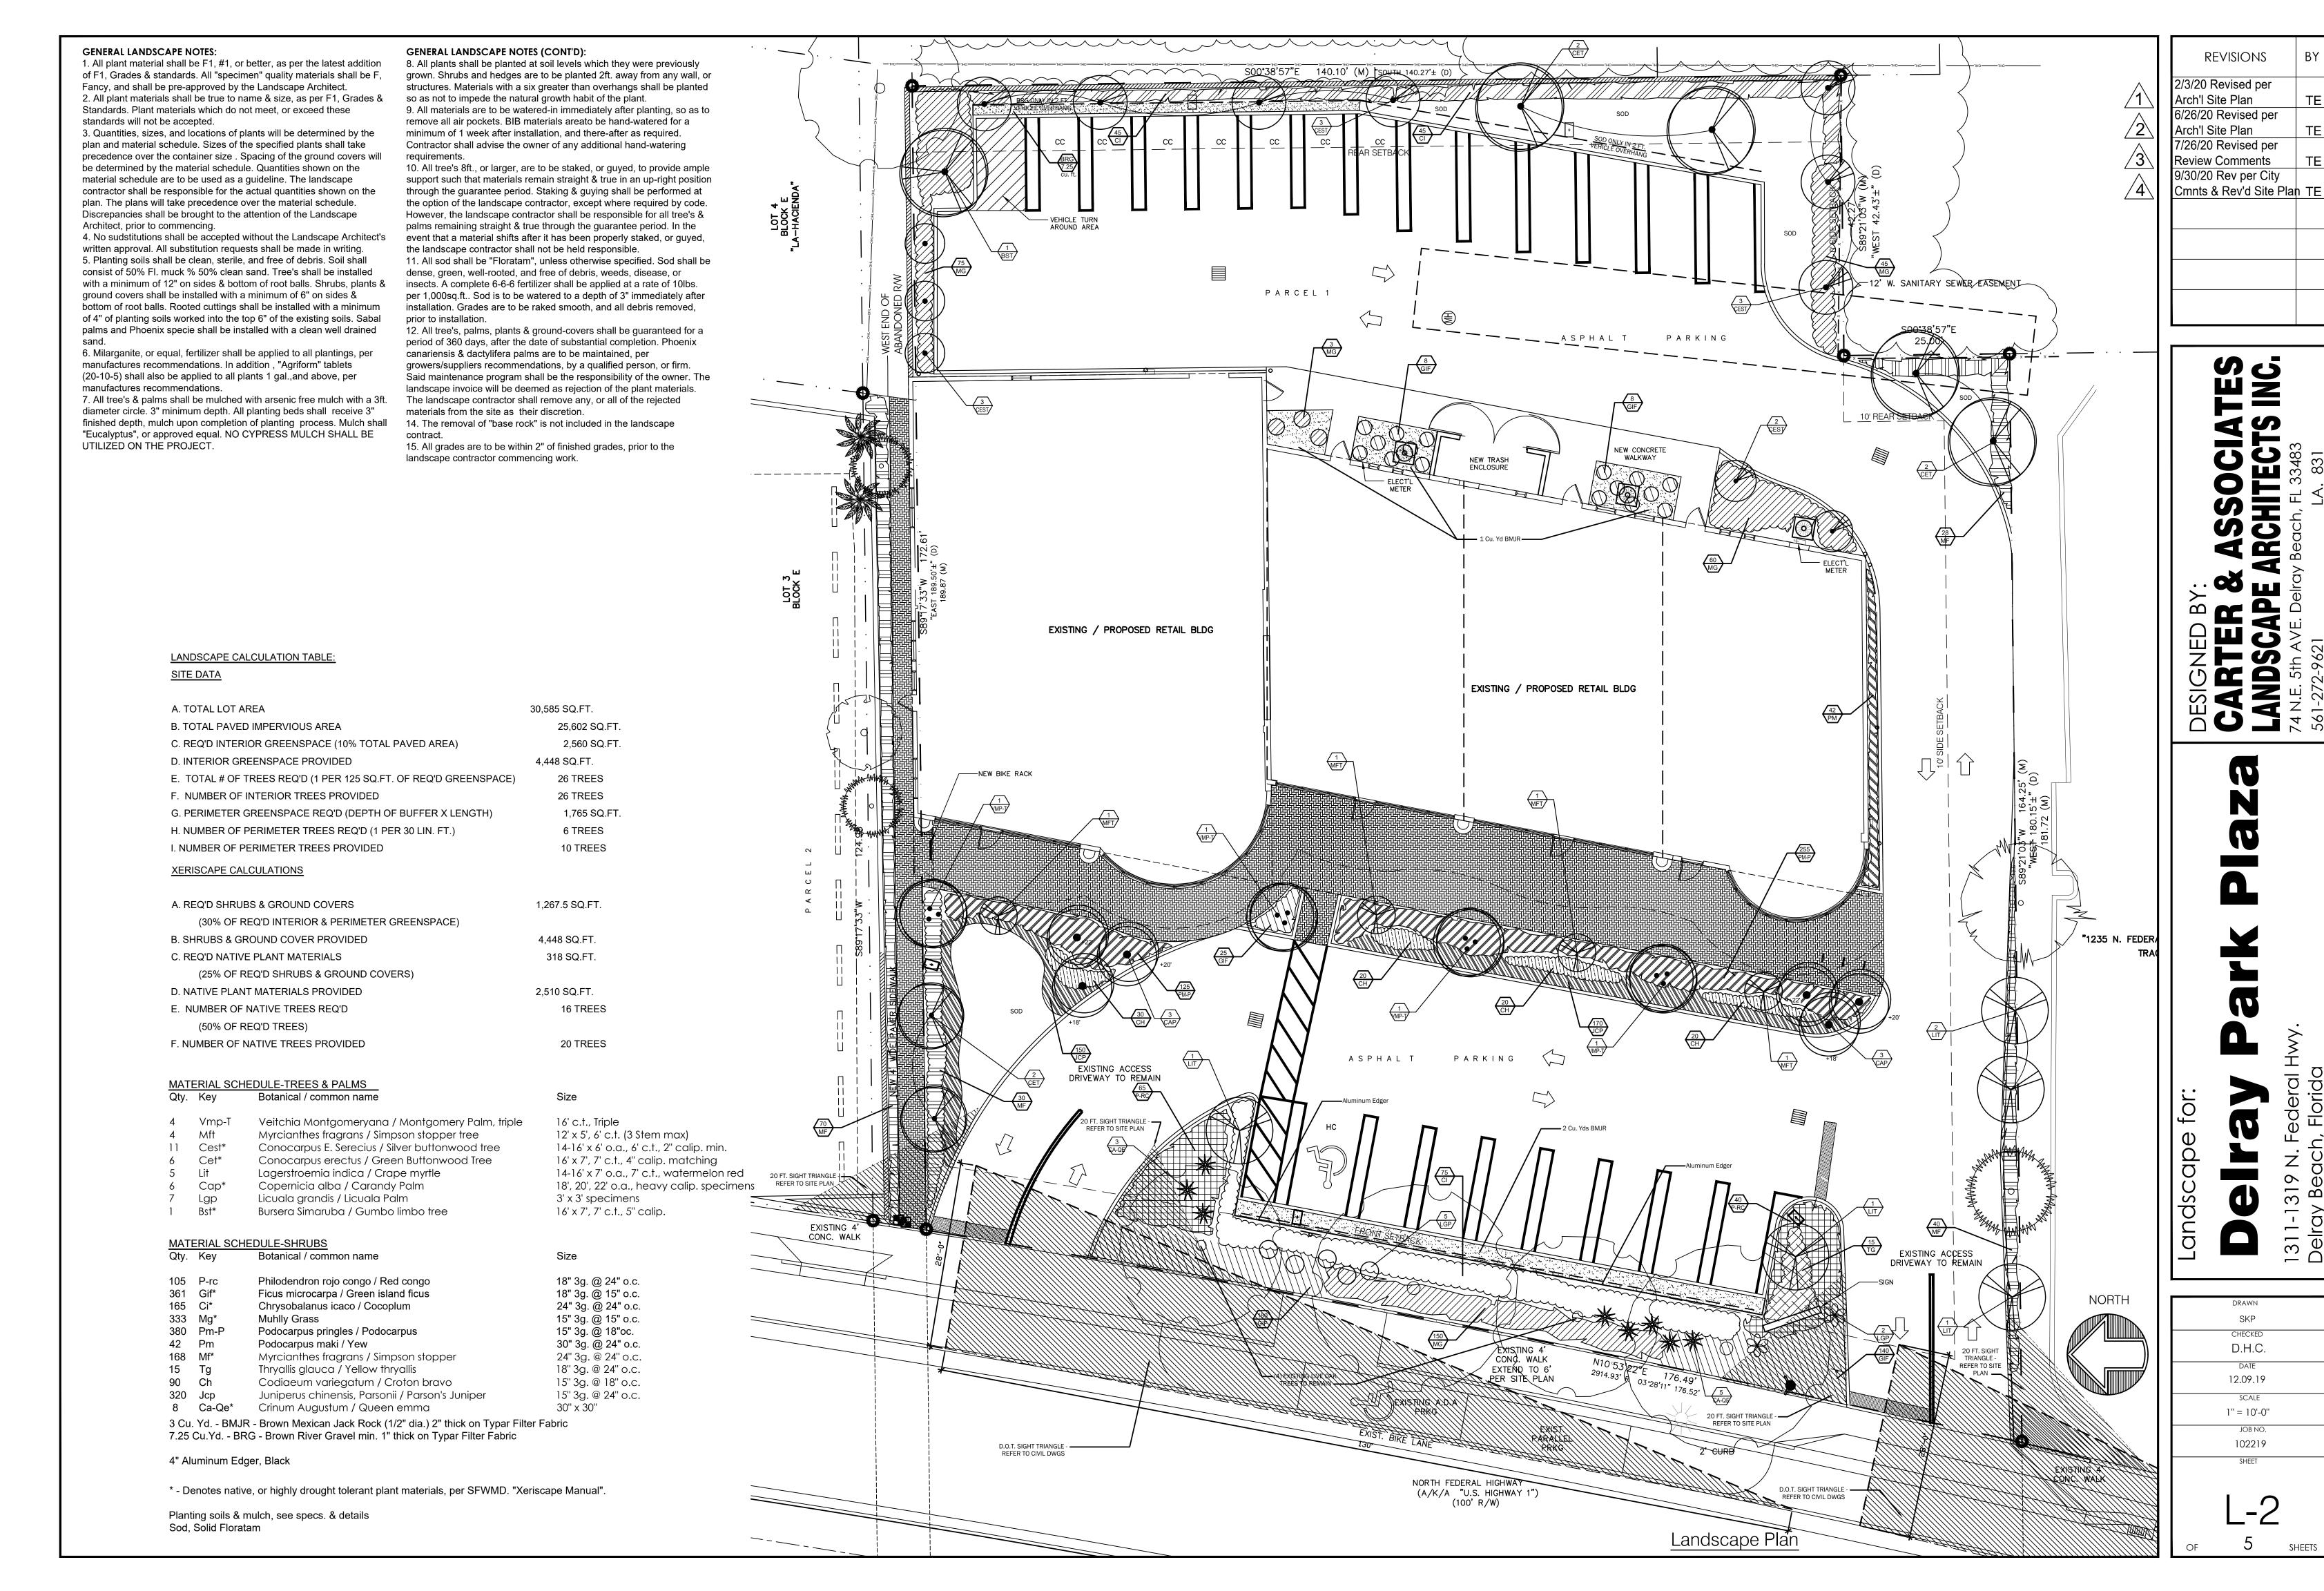

Delro



otherwise noted

2"x2"x8' PTP stake ———

Chartreuse survey -

3" mulch -----

flagging tape

Vehicular Use Landscape Strip Excavation Detail


1'-0"

BACK OF CURB (TYP.)

-EXCAVATION AREA (30" DEPTH)

-COMPACTED SOIL (12" WIDE)

Existing native soil within all landscape inslands, interior landscape strips and perimeter landscape strips, adjacent to vehicular use areas, shall be excavated down to a depth of thirty (30) inches below existing grade, except for a 12" buffer from the inside of curb or pavement (see detail). A suitable planting soil mixture of fifty/fifty (50/50), sixty/forty (60/40) (sand / planting soil) shall eith be backfilled in place of the native soil or efficiently mixed with the native soil create an optimum environment for successful root development. If native soil is to be mixed, it shall first be screened to remove rocks and debris larger than one-half (1/2) inch in diameter prior to mixing. All properties under this section shall be required to have an open landscape bed inspection prior to backfilling to insure the thrity (30) inch depth has been met.

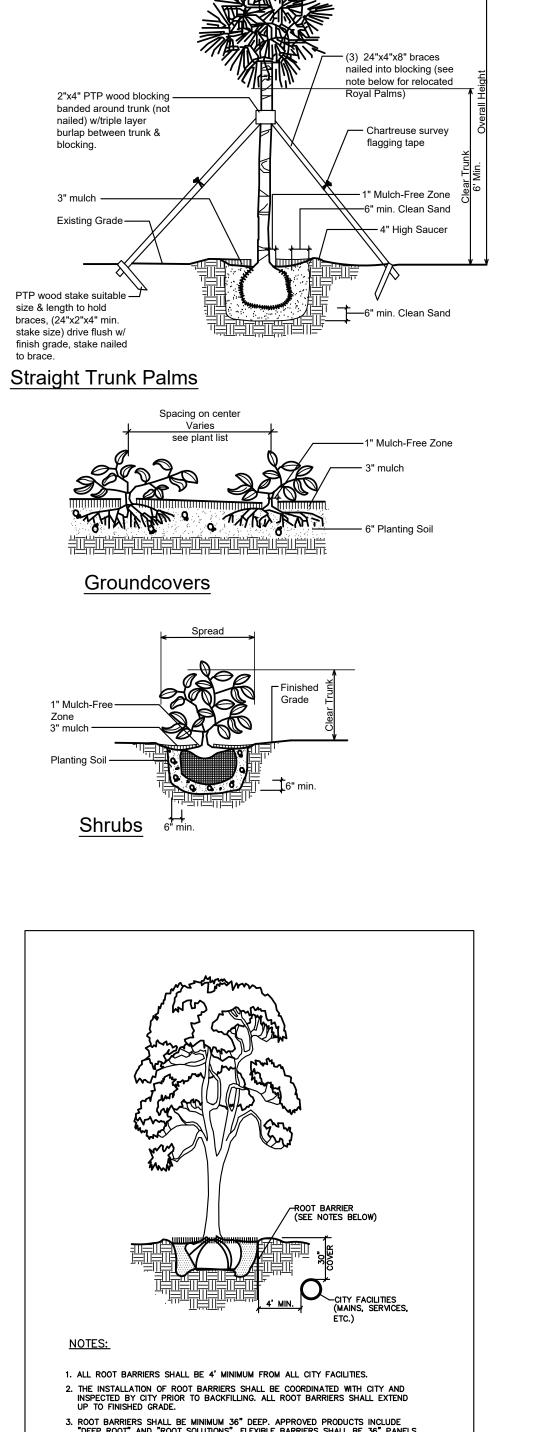

─ Black rubber hose to

protect trunk from wires

of #12 galv. wire doubled,

twist to tighten. Lengths of rubber hose to cover wire


at crotch over first sturdy

— 1" Mulch-Free Zone


PTP wood stake suitable


size & length to hold guys, drive flush w/ finish grade


(24"x2"x4" min. stake size)

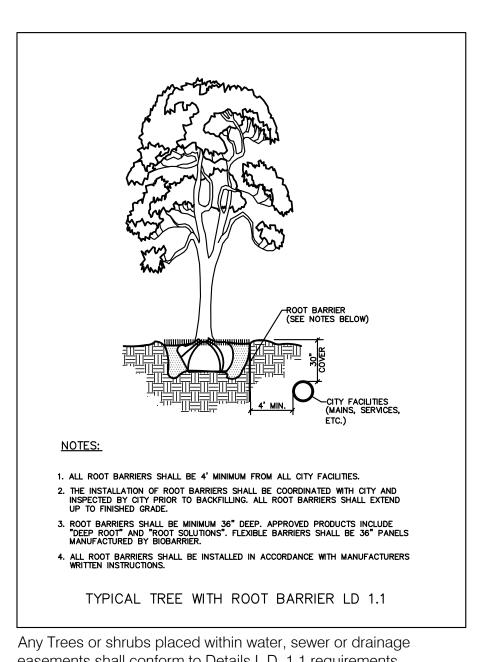

easements shall conform to Details L.D. 1.1 requirements. RB: Denotes Root Barrier

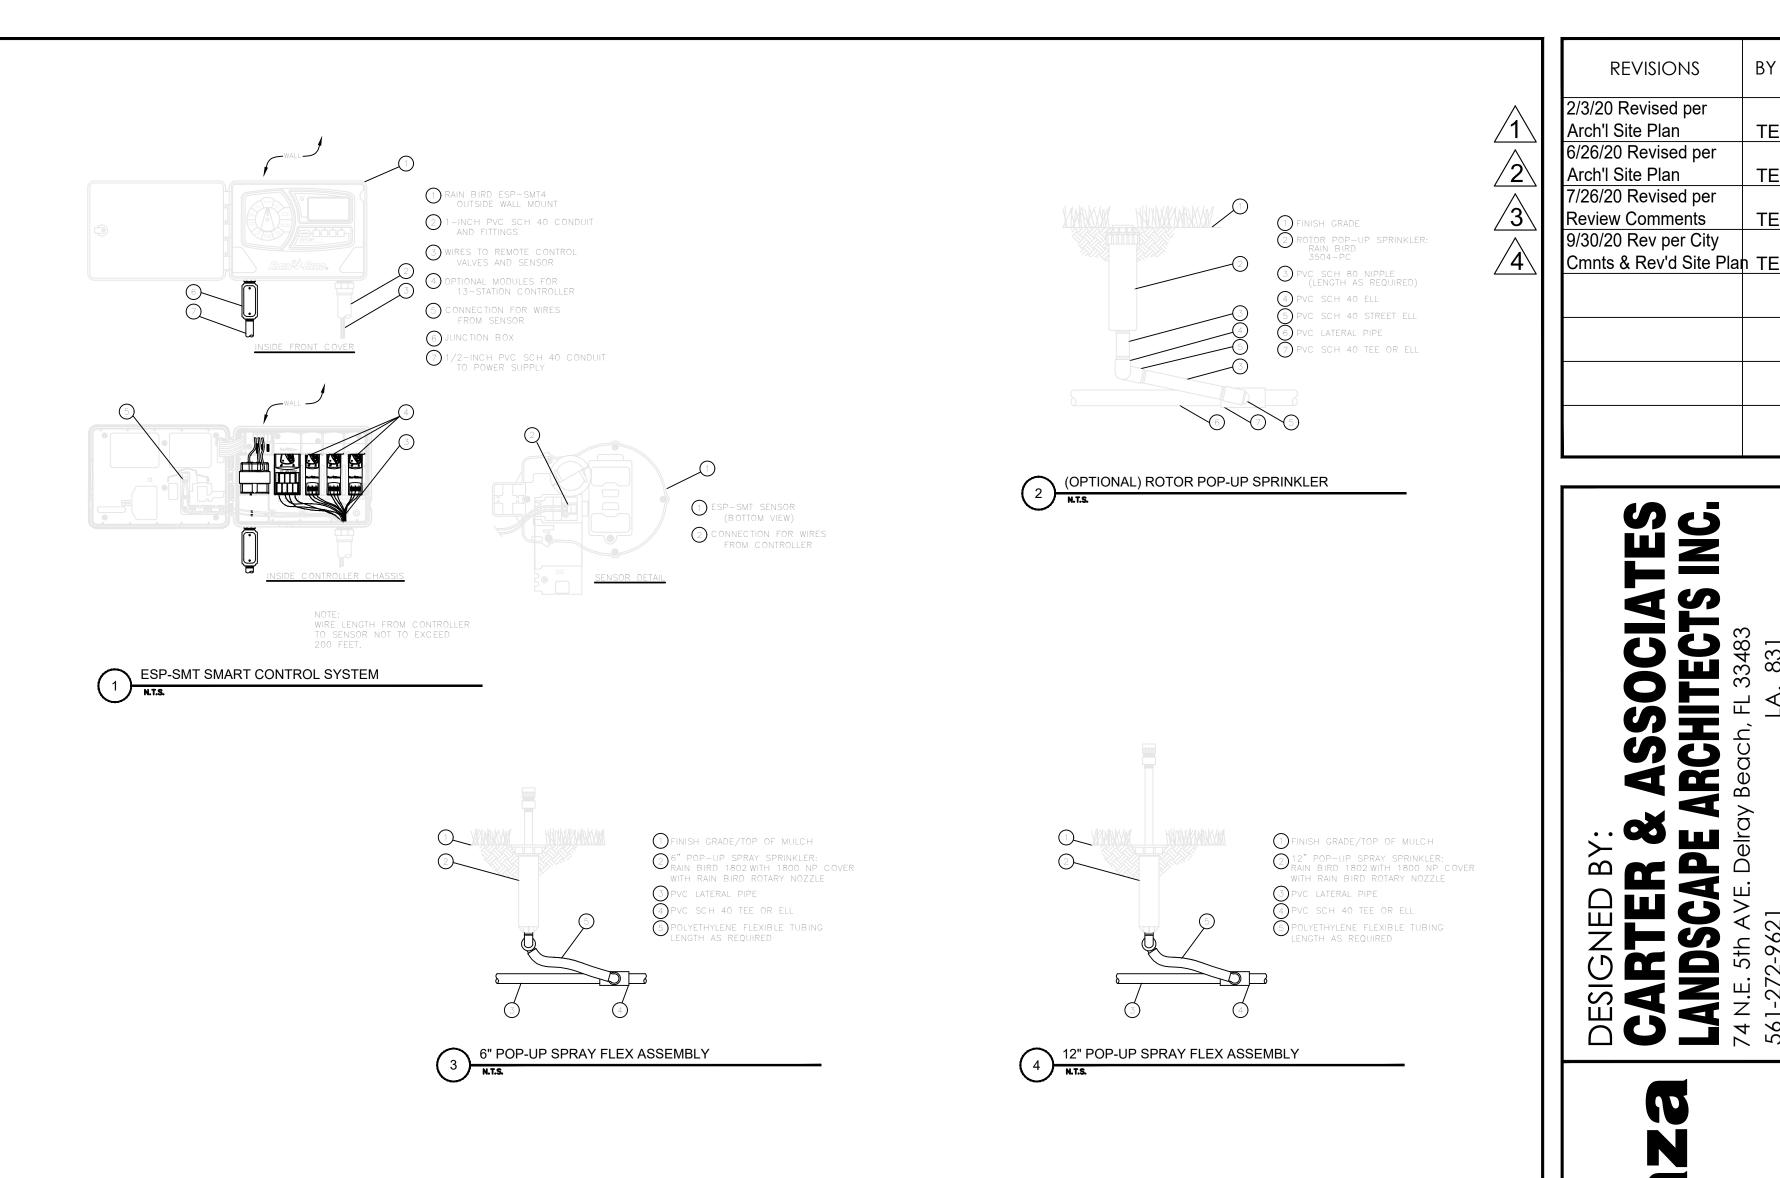

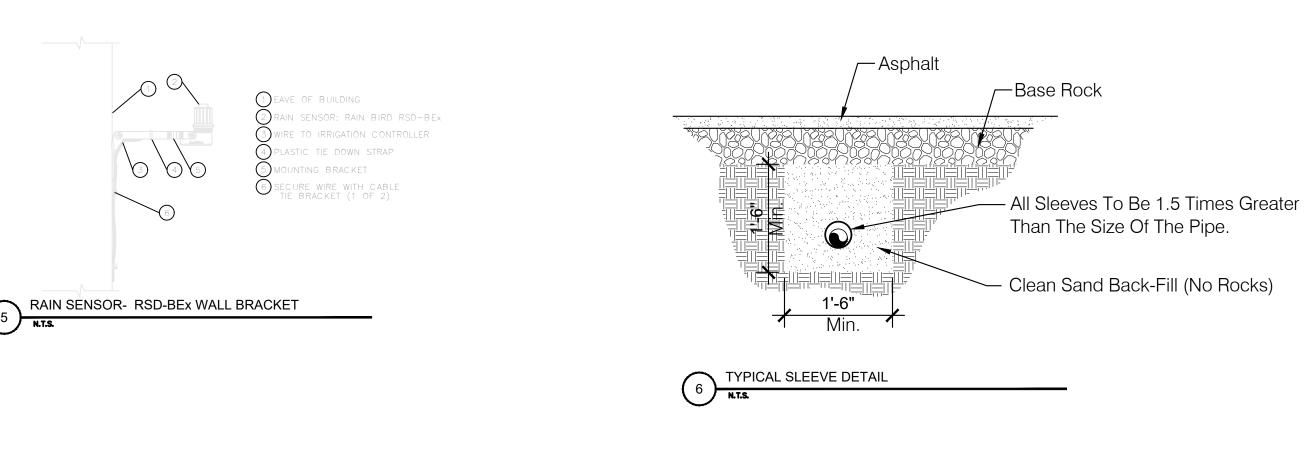

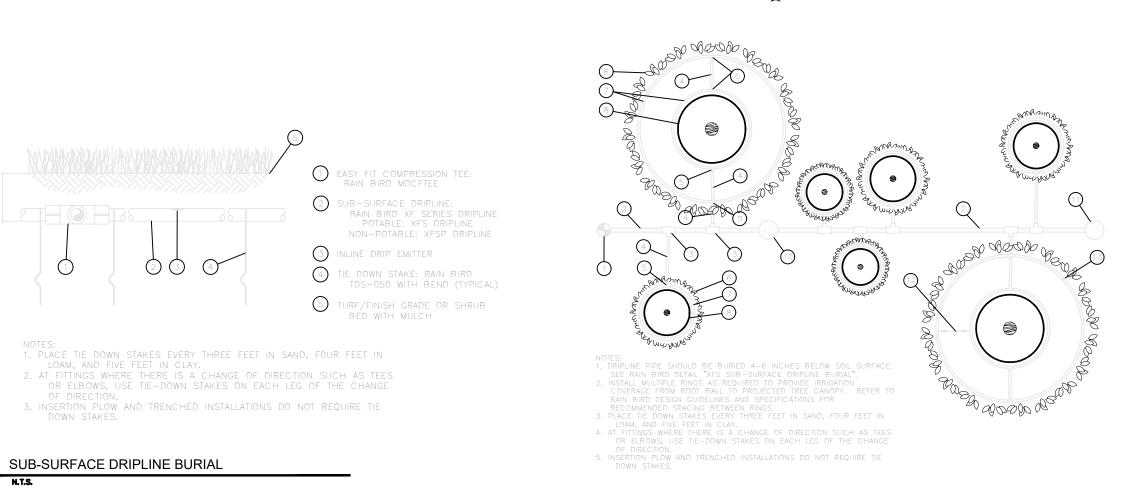

Irrigation Details

SUB-SURFACE DRIPLINE

RAIN BIRD CONTROL ZONE KIT (SIZED TO ACCOMMODATE LATERAL FLOW DEMAND)
2) PVC DRIP SUPPLY MANIFOLD PIPE
3 PVC SCH 40 TEE OR EL (TYPICAL)

5 BARB X BARB INSERT TEE: RAIN BIRD XFD—TEE (TYPICAL)

8 ROOT BALL (TYPICAL)

9 BARB X BARB INSERT CROSS: RAIN BIRD XFD—CROSS (TYPICAL AIR VACUUM RELIEF VALVE (SEE RAIN BIRD DETAIL "XFS AIR VACUUM RELIEF VALVE KIT IN PVC HEADER") INSTALL AT DRIPLINE ZONE HIGH POINT.

PUINI.

DRIPLINE FLUSH POINT (SEE RAIN BIRD DETAIL "XFS DRIPLINE FLUSH POINT WITH BALL VALVE") SPACING PER SPECIFICATION (QUANTITY AS REQUIRED, SEE NOTES 3-5 BELOW)

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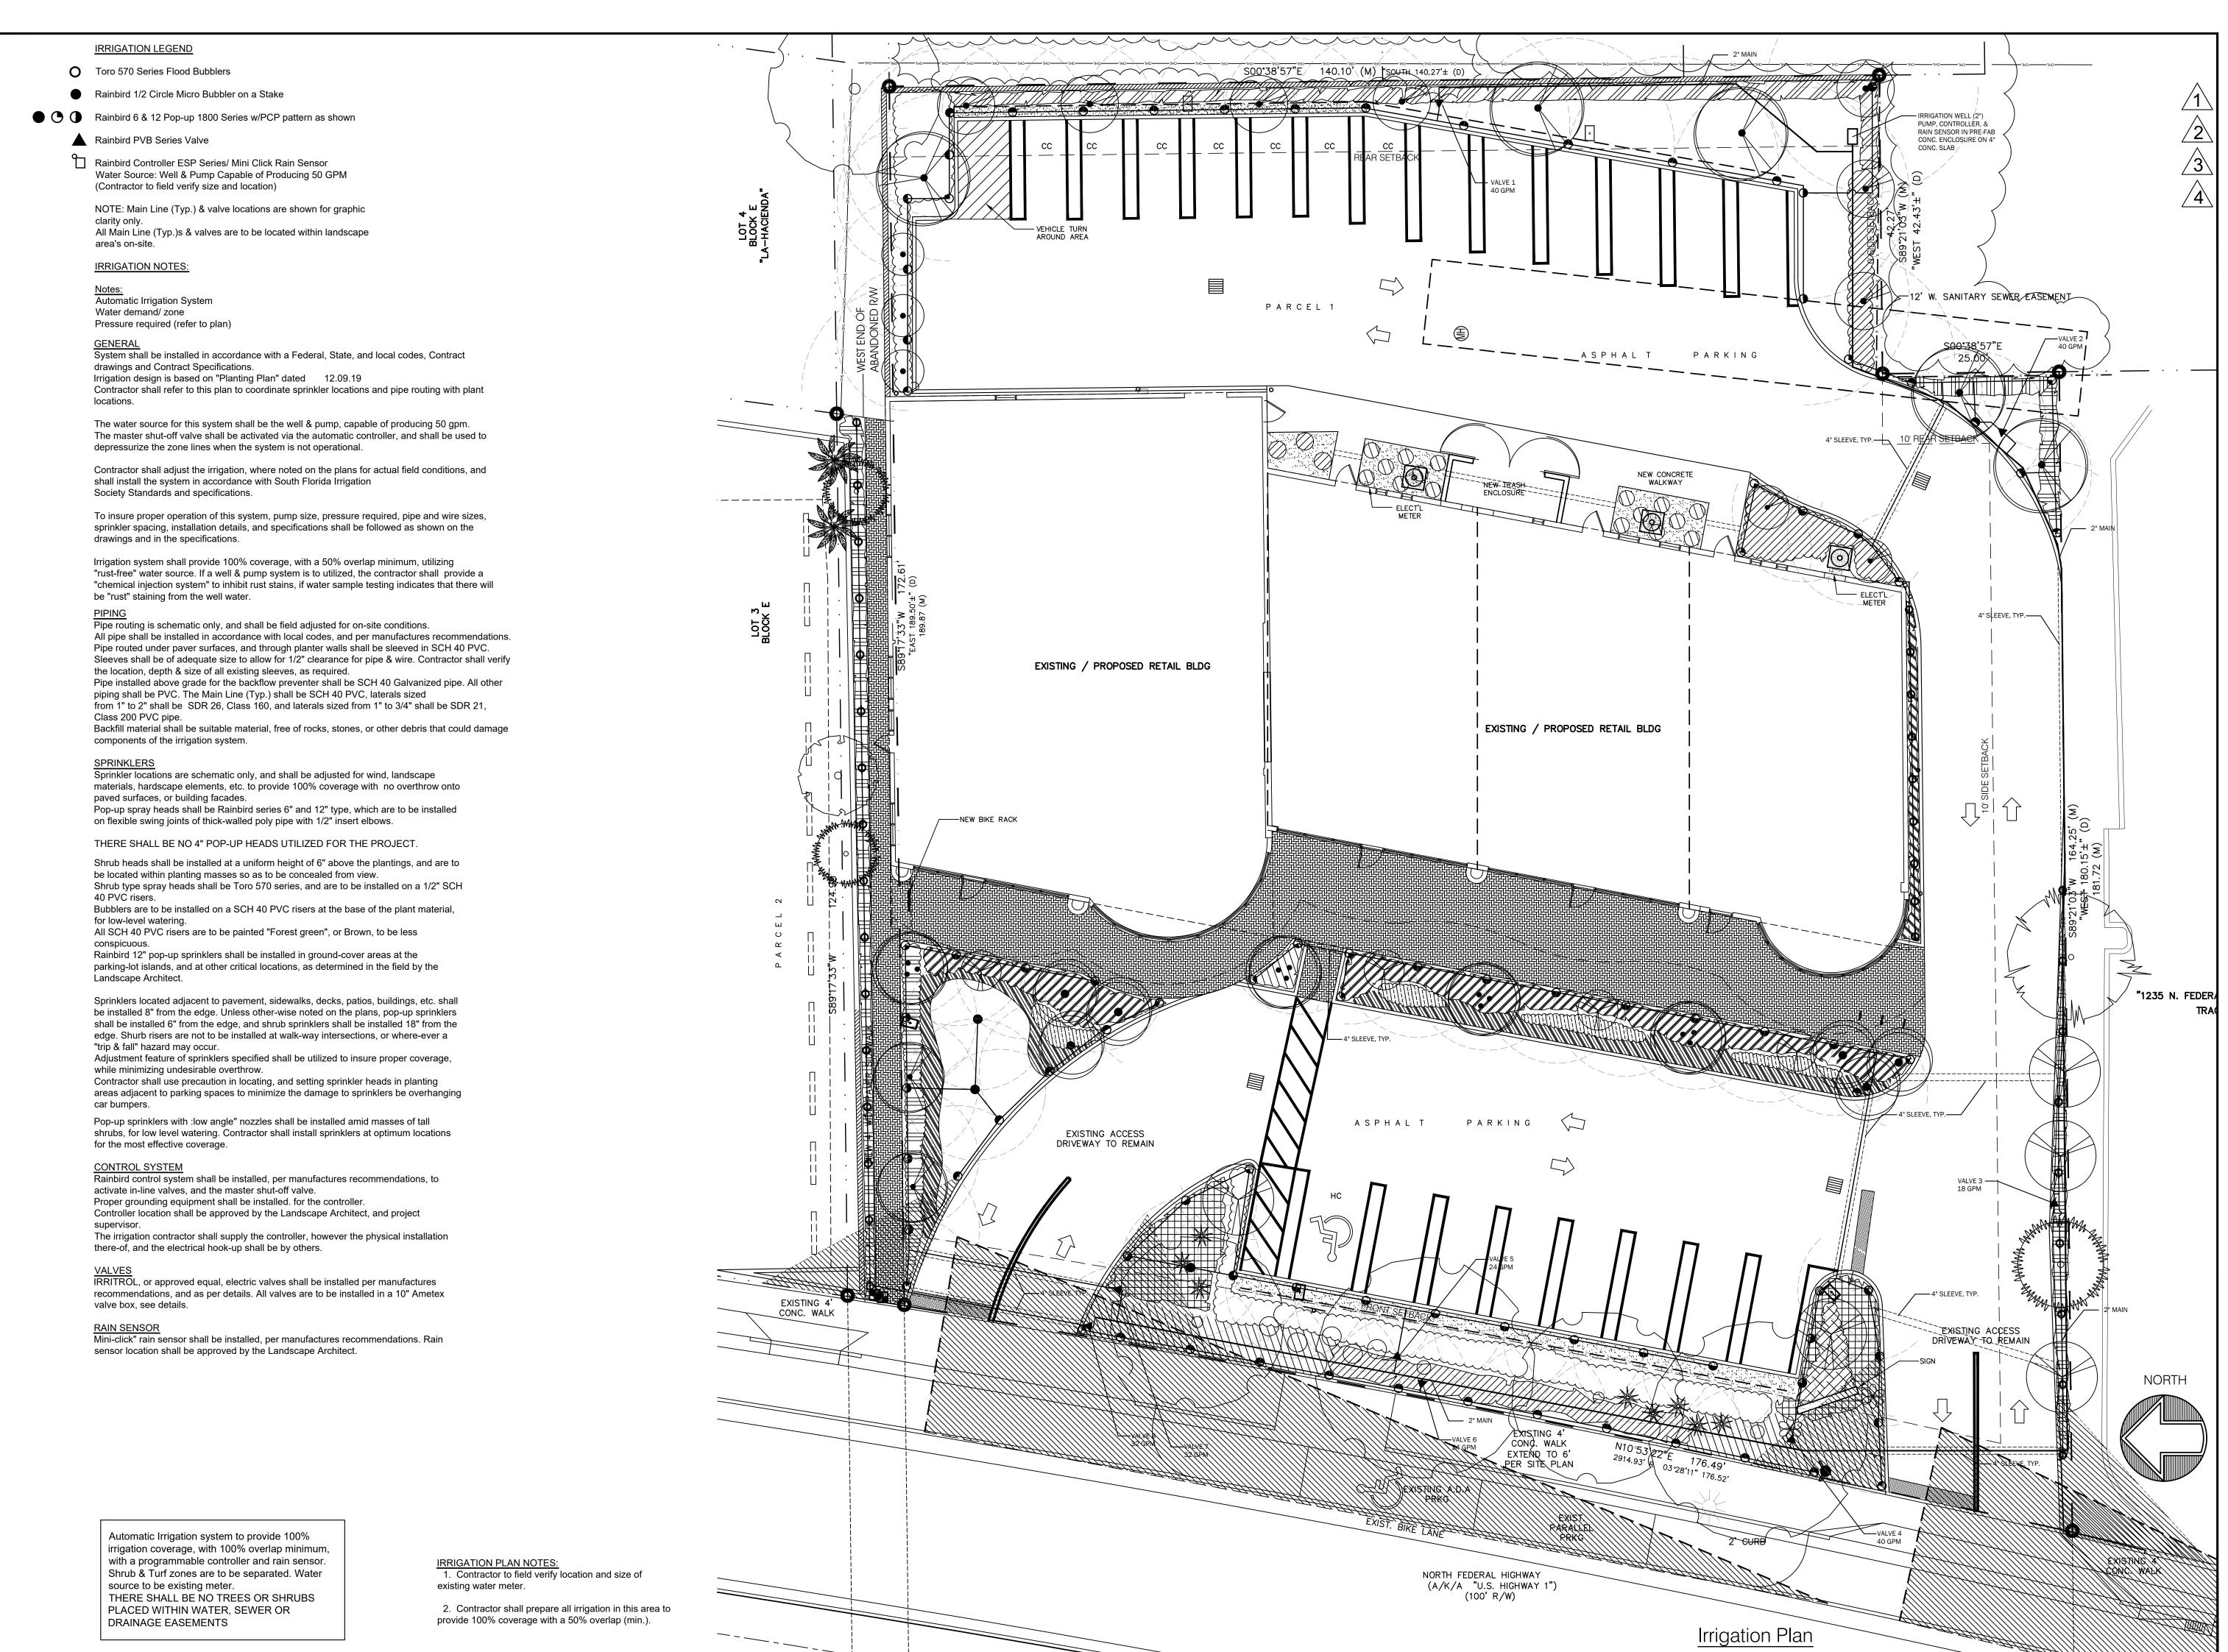
MULTIPLE TREE/SHRUB DETAIL

ab Landsca

REVISIONS

7/26/20 Revised per

1311-131 Delray Be DRAWN SKP CHECKED D.H.C. 12.09.19 1" = 10'-0" JOB NO. 102219




REVISIONS 2/3/20 Revised per Arch'l Site Plan 6/26/20 Revised per Arch'l Site Plan 7/26/20 Revised per Review Comments 9/30/20 Rev per City Cmnts & Rev'd Site Plan TE

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SKP CHECKED D.H.C. 12.09.19 1" = 10'-0" JOB NO. 102219



REVISIONS 2/3/20 Revised per Arch'l Site Plan 6/26/20 Revised per Arch'l Site Plan 7/26/20 Revised per Review Comments 9/30/20 Rev per City Cmnts & Rev'd Site Plan TE

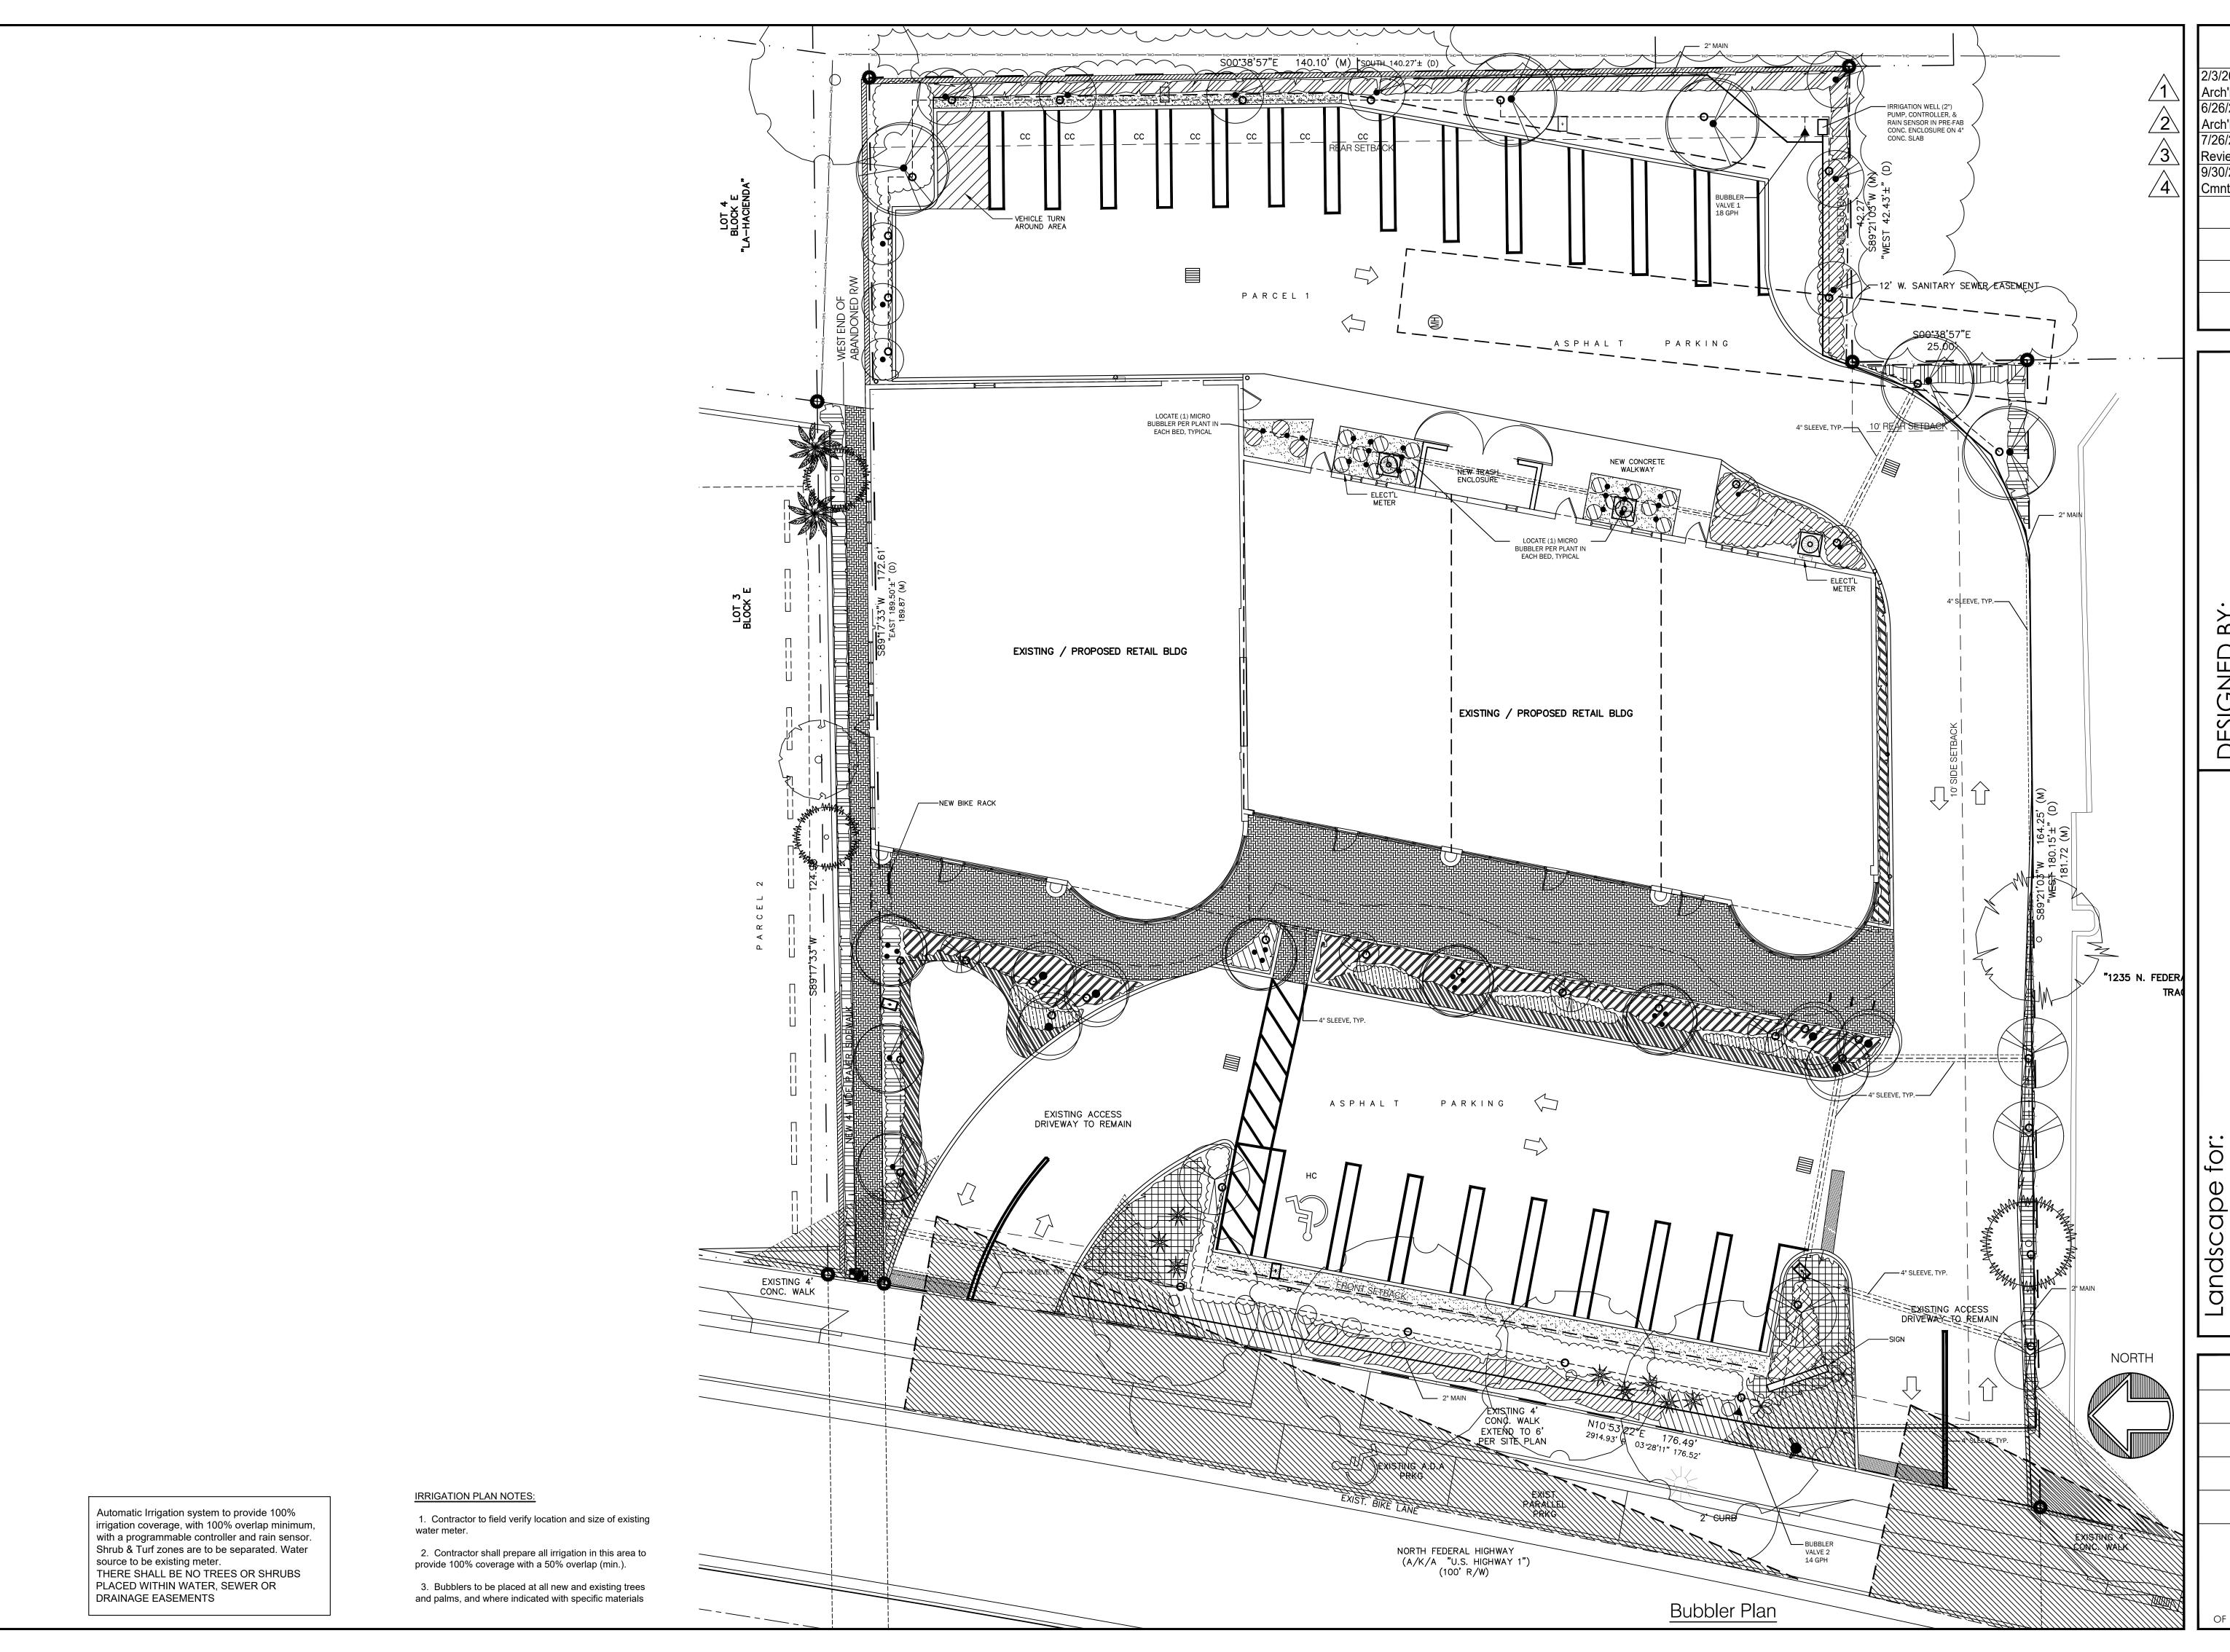1311-1319 Delray Be SKP CHECKED D.H.C. 12.09.19

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