

LIST OF DRAWINGS:

CS.I COVER SHEET

SP.I ARCHITECTURAL SITE PLAN

SU.I SURVEY

DI.I DEMOLITION/ AS-BUILT FLOOR PLAN

AO.I GENERAL SPECIFICATIONS AND NOTES
AI.I FLOOR PLANS, SCHEDULES & JAMB DETAILS

A2.1 EXTERIOR ELEVATIONS

A 2.2 EXTERIOR ELEVATIONS
A 3.1 BUILDING CROSS & WALL SECTIONS

SI.I FOUNDATION PLAN(S) & DETAILS

S2.1 FRAMING PLAN(S) & DETAILS, WIND DIAGRAMS

E I. I ELECTRICAL PLAN & DETAILS

GENERAL NOTES:

I. ALL IDEAS, DRAWINGS, PLANS AND ARRANGEMENTS INDICATED OR REPRESENTED BY THESE DRAWINGS ARE OWNED BY AND THE PROPERTY OF THE ARCHITECT AND/OR ENGINEER OF RECORD. THEY WERE CREATED FOR AND DEVELOPED FOR USE ON AND IN CONNECTION WITH THE SPECIFIED PROJECT. THE IDEAS, DESIGNS, DRAWINGS, PLANS AND ARRANGEMENTS OF THE SPECIFIED PROJECT SHALL NOT BE USED BY OR DISCLOSED TO ANY PERSONS, FIRM, OR CORPORATION FOR ANY PURPOSE WHATSOEVER WITHOUT THE WRITTEN PERMISSION OF THE ARCHITECT AND ENGINEER(S) OF RECORD.

2. ALL SHOP DRAWINGS SHALL BE SUBMITTED TO THE ARCHITECT/ENGINEER OF RECORD REVIEW ONLY AFTER THEY HAVE BEEN THOROUGHLY REVIEWED BY THE GENERAL CONTRACTOR FOR CONSTRUCTION METHODS, DIMENSIONS, FIELD CONDITIONS, "ASCONSTRUCTED" DIMENSIONS AND OTHER TRADE REQUIREMENTS, AND STAMPED WITH THE CONTRACTOR'S APPROVAL STAMP. ONLY REQUESTED SHOP DRAWINGS AND SUBMITTALS TO BE PROVIDED TO ARCHITECT FOR REVIEW, ALL OTHERS TO BE

APPROVED AND REVIEWED BY G.C.

3. ARCHITECT OF RECORD IS NOT RESPONSIBLE FOR ANY SURVEY OR CIVIL DWGS. THAT ARE INSERTED INTO THIS SET AND/OR LACK OF. THIS INCLUDES BUT IS NOT LIMITED TO PROPOSED AND/OR EXISTING CONDITIONS OF GRADING, PARKING, DRIVEWAYS, SEWER LINES, DRAINAGE, FINISH FLOOR ELEVATIONS, PROPERTY LINE LOCATIONS, EXISTING

VEGETATION LOCATIONS, AND ETC.

4. ALL FINISH FLOOR ELEVATIONS SHALL BE CONFIRMED BY LOCAL MUNICIPALITY OR A LICENSED CIVIL ENGINEER OR LICENSED SURVEYOR.

THE HALBERG RESIDENCE

120 NW 4th Ave. DELRAY BEACH, FLORIDA, 33444

ARCHITECTURAL RENDERING:



HOLLOE CORE

HOLLOW METAL

CONDITIONING

INSULATION

LAMINATED

MATERIAL

MAN HOLE

METAL THRESHOLD

NOT IN CONTRACT

PLUMBING CONTRACTOR

POUNDS PER SQARE INCH

PRESSURE TREADED

MOLDING

NUMBER

NOMINAL ON CENTER

OPENING

PLATE

OPEN WEB

RETURN AIR

ROOM

REQUIRED

SCHEDULE

SOLID CORE

STAINLESS STEEL

SPECIFICATION

TOP OF PLATE

TOP OF STEEL

TOP OF FOOTING

STRAIGHT VINYL BASE

THICK OR THICKNESS

VINYL COVE BASE

VERIFY IN FIELD

WROUGHT IRON

WELDED WIRE FABRIC

TOUNGUE AND GROOVE

VINYL COMPOSITION TILE

SECTION

SIMILAR

TOP OF

TYPICAL

WOOD

REINFORCING

SPALSH BLOCK

METAL MINIMUM

INVERT

HEATING, VENTILATION. & AIR

MECHANICAL CONTRACTOR

H.M.

INSUL. INV.

MAT.

M.H.

MIN.

M.T.

N.I.C.

NOM.

OPG.

O.W.

P.C.

R.A.

RM.

REIN.

S.B.

SCH.

SEC.

S.C.

SIM.

S.S.

S.V.B.

SPEC.

T.O.

T.O.F.

T.O.P.

T.O.S.

TYP.

THK.

T#G

V.C.T.

V.C.B.

W.I.

WD.

W.W.F.

NO.

MLDG.

ABBREVIATIONS:


<i>@</i>	AT
@ ^CT	
ACT	ACOUSTICAL TILE
ADJ.	ADJUSTABLE
A.B.	ANCHOR BOLT
A.C.	AIR CONDITIONING
AFF	ABOVE FINISH FLOOR
	ALUMINUM
ALT.	ALTERNATE
BD.	BOARD
BLDG.	BUILDING
B.M.	BENCH MARK
BRG.	BRIDGING OR BEARING
C/C	CENTER TO CENTER
CL	CENTER LINE
CAB.	CABINET
C.B.	CATCH BASIN
C.I.	CAST IRON
CER.	CERAMIC
CLG.	CEILING
C.O.	CLEAN OUT
CONC.	CONCRETE
COORD.	COORDINATE
COURD.	COLUMN
CONT.	CONTINUOUS
DET.	DETAIL
DN.	DOWN
DK.	DECK
D.S.	DOWN SPOUT
D.W.	DRY WALL
	DRAWING
E.C.	ELECTRICAL CONTRACTOR
EL. ELEV.	ELEVATION
ELEC.	ELECTRICAL
EX./EXIST	EXISTING
EXP.	EXPOSED OR EXPANSION
F.E.	FIRE EXTINGUISHER
F.F.	FINISHED FLOOR
FIN.	FINISH
FLR.	FLOOR
F.S.	FULL SIZE
F.T	FOOT OR FEET
FTG.	FOOTING
G.C.	GENERAL CONTRACTOR
GL.	GLASS OR GLAZING
G.PT.	GLAZED PAINT
GYP.	GYPSUM
H.B.	HOSE BIB
HGT.	HEIGHT

HRD'R

HARDENER

EXISTING CMU WALL EXISTING INTERIOR WALL EXISTING FIRE RATED PARTITION WALL CMU WALL, W/ ONE SIDE Ix PT FURRING & GYPSUM BOARD CMU WALL, W/ ONE SIDE 2x PT FURRING & GYPSUM BOARD CMU WALL, W/ ONE SIDE I -5/8" MTL. STUD & GYPSUM BOARD PARTITION WALL (PARTTY WALL) - CMU WALL, W/ I -5/8" MTL. STUD, (SFAB) & 5/8" GYPSUM BOARD ON EACH SIDE. NOTE: FIRE RATED PARTITION WALL PARTITION WALL (PARTTY WALL) - CMU WALL, W/ 2x PT FURRING, (SFAB) & 5/8" GYPSUM BOARD ON EACH SIDE. NOTE: FIRE RATED PARTITION WALL INTERIOR WALL INTERIOR FIRE RATED PARTITION WALL

ARCHITECTURAL SYMBOLS:

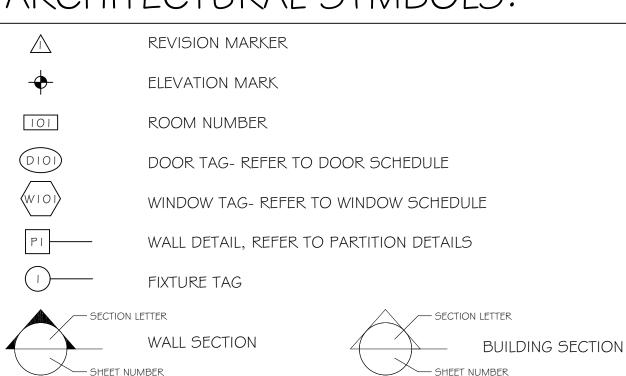

— DETAIL NUMBER

PROJECT DATA:

PROJECT DESCRIPTION:

THE PROPOSED PROJECT IS FOR A NEW WOOD FRAMED STRUCTURAL ADDITION TO AN EXISTING SINGLE FAMILY HOME AND FOR THE CONSTRUCTION OF A NEW DETACHED CMU GARAGE, LOCATED ON AN EXISTING SITE IN DELRAY BEACH, FLORIDA.

PROJECT INFORMATION:

OWNER: CHARLES HALBERG

ADDRESS: 120 NW 4th Ave.
DELRAY BEACH, FLORIDA, 33444

PCN: 12-43-46-16-01-027-0130

EGAL: TOWN OF DELRAY LT 13 BLK 27

ZONING AND CODE INFORMATION:

ZONING: R1-A SINGLE FAMILY RESIDENCE CONSTRUCTION TYPE: V-B CURRENT USE: 0100 - SINGLE FAMILY PROPOSED USE: 0100 - SINGLE FAMILY

FLORIDA BUILDING CODE

FBC-2017 BUILDING CODE & FBC-2017, 6TH EDITION RESIDENTIAL FBC EC = FLORIDA BUILDING CODE ENERGY CONSERVATION 2017 FLORIDA FIRE PREVENTION CODE, 5TH EDITION

NEC= NFPA 70 2014 EDITION, NATIONAL ELECTRICAL CODE FS= FLORIDA STATUTES

SITE/LAND DATA(LDR 4.	3.4): REQUIRED	EXISTING	PROPOSED
TOTAL SITE AREA:	+/-10,371.64 5	SF (.2381 AC)	
NAINL LOT AREA	7.500.65	10.270.65	10.270.65
MIN. LOT AREA:	7,500 SF	10,372 SF	10,372 SF
MIN. LOT WIDTH:	60/80'	112.81'	112.81'
MIN. LOT DEPTH:	100'	135.6'	135.6'
MIN. LOT FRONTAGE:	60/80'	76.5'	76.5'
MIN. FLOOR AREA:	1,000 SF	1,552 SF	3,253 SF
MAX. LOT COVERAGE (BLDG):	NA	15.0%	31.4%
MIN. OPEN SPACE:	(3)25%	81.5.%	55.4% (5,744 5
DENSITY.	NA	NΑ	NΑ

SITE/LAND DATA(LDR	(4.3.4): REQUIRED	EXISTING	PROPOSED
FRONT:	25.0'	13.06'	13.06'
REAR:	10.0'	65.83'	12.0'
SIDE (INTERIOR):	7.5'	23.69'	8.17'
SIDE (STREET):	15.0'	NA	NA
POOL:	10.0'	NA	17.25',11.51'

3,253 SF

BUILDING DATA:

MAX. BLDG. HT.

EXISTING TOTAL SF =	1,552 SF
EXISTING SF (UA): NEW ADDITION SF (UA):	1,400 SF 518 SF
TOTAL SF (UA):	1,918 SF
NEW GARAGE: NEW GYM:	574 SF 363 SF
NEW COVERED PORCH:	246 SF
EXISTING FRONT PORCH:	152 SF
TOTAL SF (UC):	1,335 SF


DESIGN TEAM:

OWNER:
CHARLES & PAMELA HALBERG I 20 NW 4th Ave. DELRAY BEACH, FL 33444
ARCHITECT:
STEVE SIEBERT ARCHITECTURE 466 N. FEDERAL HIGHWAY BOYNTON BEACH, FL 33435 (561) 880-7894 STEVE@STEVESIEBERT.COM

NEW TOTAL SF =

SURVEYOR:	
PERIMETER SURVEYING & MAPPING 947 CLINT MOORE RD BOCA RATON, FL. 33487 (561) 241-9988	

STRUCTURAL ENGINEER:
STEVE SIEBERT ARCHITECTURE 466 N. FEDERAL HIGHWAY
BOYNTON BEACH, FL 33435 (561) 880-7894 STEVE@STEVESIEBERT.COM

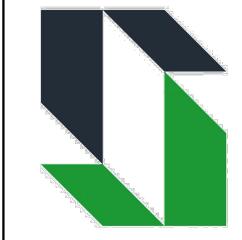

STEVE SIEBERT ARCHITECTURE 466 N. FEDERAL HIGHWAY

A66 N. FEDERAL HIGHWAY
BOYNTON BEACH, FL 33435
PH. 561.880.7894
Steve@stevesiebert.com
www.stevesiebert.com



STEVEN W. SIEBERT
FLORIDA AR001783

FLORIDA AR0017834 NEW JERSEY 21AI01517500 TEXAS 26934

G RESIDENC

CONSTRUCTION DRAWINGS

← ©

THE WRITTEN DIMENSIONS ON THESE DRAWINGS SHALL TAKE PRECEDENCE OVER SCALED DIMENSIONS.

THE CONTRACTOR SHALL VERIFY AND BE RESPONSIBLE FOR ALL DIMENSIONS AND CONDITIONS ON THE JOB, AND THIS OFFICE MUST BE NOTIFIED OF ANY VARIATION FROM THE DIMENSIONS.

COPYRIGHT STEVE SIEBERT ARCHITECTURE-UNAUTHORIZED ANY REPRODUCTION OR OTHER USE OF

THIS DRAWING IS PROHIBITED.

PROJECT NO: 20-260

DATE: 11.03.20

DATE: 11.03.20

DRAWN BY: BRT

CHECKED BY: SWS

REVISIONS: CLIENT CHGS 1.7.21

COVER SHEET

CS.1

FINAL ACCEPTANCE.

O I .O GENERAL REQUIREMENTS:

THE PROJECT IS A NEW HOME ON AN EXISTING SITE. THE GENERAL CONTRACTOR AND DEVELOPER SHALL BE SELECTED BY OWNER. ALL SUB-CONTRACTOR AND SUPPLIER PROPOSALS AND BIDS SHALL BE REVIEWED WITH CHOSEN CONTRACTOR FOR COMPLETENESS AND

THE FOLLOWING SPECIFICATIONS ARE NOT INTENDED TO BE A FULL COMPREHENSIVE CONSTRUCTION SPECIFICATION AND SHOULD NOT BE USED AS SUCH. THE ATTACHED DRAWINGS HAVE BEEN PREPARED TO BEST REPRESENT THE SCOPE AND INTENT OF THE PROJECT. EVERY EFFORT HAS BEEN MADE TO PRODUCE THE MOST ACCURATE DOCUMENTS POSSIBLE. THE ARCHITECT OF RECORD SHALL BE NOTIFIED IMMEDIATELY OF ANY SCALE AND/OR DIMENSIONAL ERRORS DISCOVERED IN YOUR REVIEW. THE ARCHITECT IS NOT RESPONSIBLE FOR ANY MIS-ORDERED MATERIAL DUE TO SCALE OR DIMENSION DISCREPANCIES.

I. THE G.C. SHALL ASSIST THE OWNER IN THE PREPARATION AND FILING OF A NOTICE OF COMMENCEMENT.

2. THE BUILDING PERMIT AND NOTICE OF COMMENCEMENT SHALL BE PROMINENTLY POSTED ON THE PROPERTY AND PROTECTED FROM ALL FORMS OF DAMAGE.

3. POWER & WATER ARE EXISTING AND AVAILABLE ON-SITE (THE OWNER SHALL PAY ALL UTILITIES DURING CONSTRUCTION)

4. THE CONTRACTOR SHALL PROVIDE ALL REQUIRED INSURANCE AGAINST PUBLIC LIABILITY AND PROPERTY DAMAGE FOR THE DURATION OF THE WORK

5. WORKER'S COMPENSATION: STATE: STATUTORY, EMPLOYER'S LIABILITY: STATUTORY

6. SAFETY AND OSHA COMPLIANCE IS THE RESPONSIBILITY OF THE G.C.

7. ALL WORK SHALL BE PERFORMED IN A FIRST CLASS WORKMANSHIP LIKE MANNOR IN ACCORDANCE WITH THESE PLANS AND SPECIFICATIONS, THE FLORIDA BUILDING CODE, THE STATE ENERGY EFFICIENCY CODE, INDUSTRY STANDARDS, AND ALL APPLICABLE NATIONAL, STATE, AND LOCAL CODES, ORDINANCES AND RULES.

8. THE G.C. IS RESPONSIBLE FOR DAILY SITE CLEANUP OF ALL DEBRIS, IMPLEMENTS AND SURPLUS MATERIAL TO 'BROOM-CLEAN" DAILY. FINAL CONSTRUCTION CLEANUP SHALL INCLUDE POLISHING OF ALL GLASS, HARDWARE, CERAMIC, AND MIRRORS, WASHING OF ALL FLOOR AND VERTICAL SURFACES REMOVING ALL FOOTPRINTS, HANDPRINTS, DUST, DIRT PUTTY, AND OVER PAINTING IN PREPARATION FOR OCCUPANCY.

9. SUBMITTALS: WHERE REQUIRED; SUBMIT MATERIAL SAMPLES FOR OWNER AND ARCHITECT TO REVIEW IN A TIMELY MANNOR (A MINIMUM OF 3 SAMPLES FOR EACH CATEGORY REQUIRED: (1) FOR OWNER TO RETAIN, (1) FOR ARCHITECT TO RETAIN, \$ (I) RETURNED TO THE SUPPLIER. (MAX OF 3 WILL BE MARKED AND RETURNED). IT IS THE SUPPLIER'S RESPONSIBILITY TO SUBMIT AHEAD OF YOUR ORDERING SCHEDULE TO ALLOW THE OWNER \$ ARCHITECT UP-TO 5 BUSINESS DAYS TO RETURN REVIEWED SUBMITTALS.

10. THE G.C. IS SOLELY RESPONSIBLE FOR CHECKING/REVIEWING ALL NOA'S/ FL. APPROVALS. THIS INCLUDES, BUT IS NOT LIMITED TO, THE WIND PRESSURES. SILL HEIGHTS, MATERIALS, ETC. THE FOLLOWING SCOPE OF WORK AND SPECIFICATIONS ARE INTENDED FOR GENERAL INFORMATION AND TO SUPPLEMENT THE REQUIREMENTS SHOWN ON THE DRAWINGS.

02.0 SITE WORK & DEMOLITION:

REFER TO THE ARCHITECTURE SITE PLAN - LOCATE THE HOME AS NOTED, AND FILL AND COMPACT GRADE AS REQUIRED. (CIVIL ENGINEERING IS NOT IN CONTRACT)

ALL SITE WORK SHOWN SHALL BE BY OTHERS; SITE WORK REQUIRED, BUT NOT INCLUDED IN THESE DOCUMENTS COULD INCLUDE: DRAINAGE, GRADING. LANDSCAPE & IRRIGATION. DRIVE-WAY, WALKWAYS, AND POOL. ON-SITE WELL IS REQUIRED FOR POTABLE & IRRIGATION WATER. DESIGN AND APPROVAL OF THE SEPTIC SYSTEM IS BY OTHERS. ALL SITE WORK SHOWN SHALL BE BY OTHERS; SITE WORK REQUIRED, BUT NOT INCLUDED IN THESE DOCUMENTS COULD INCLUDE: DRAINAGE, GRADING, LANDSCAPE # IRRIGATION, DRIVE-WAY, WALKWAYS, AND POOL.

02.1 LANDSCAPE PLAN:

UNDER-SEPARATE AGREEMENT THE OWNER/DEVELOPER SHALL ENGAGE A LANDSCAPE PROVIDER FOR THE DESIGN AND INSTALLATION OF A MINIMUM LANDSCAPE REQUIREMENT (TO COMPLY WITH ANY HOA/CITY REQUIREMENTS)

02.2 FUTURE POOL

UNDER SEPARATE AGREEMENT - THE OWNER/DEVELOPER SHALL ENGAGE A POOL SPECIALTY SUBCONTRACTOR FOR THE DESIGN, PERMITTING, AND INSTALLATION OF THE FOLLOWING: I. POOL

- POOL EQUIPMENT (PUMP, FILTER, HEATER, ETC..)
- POOL DECK (PAVERS CONCRETE TILE ETC..)

02.3 UTILITIES

EXISTING OVERHEAD ELECTRICAL SERVICE TO REMAIN

03.0 CONCRETE:

REFER TO THE DRAWINGS FOR ALL CONCRETE SPECIFICATIONS. THE CONCRETE SCOPE INCLUDES: NEW CONCRETE FLOOR SLABS, FOUNDATIONS ALL AS SHOWN.

I. CONCRETE SHALL BE MINIMUM 3,000 PSI STANDARD MIX CONCRETE.

2. MINIMUM 6x6 - 10/10 WELDED WIRE FABRIC REINFORCING IN SLAB

3. DEFORMED STEEL BARS OF SIZES SHOWN ON THE STRUCTURAL DRAWINGS FOR ALL COLUMNS, BEAMS, AND REINFORCING.

4. BROOM FINISH EXTERIOR SLABS, TROWEL FINISH INTERIOR SLABS TO MATCH EXISTING ADJACENT WORK.

6. TREAT THE GROUND BELOW SLABS WITH TERMITE TREATMENT AND RETAIN THE CERTIFICATE WITH THE PLANS.CONCRETE IS LIMITED TO THE POUR-BACK REQUIREMENTS WHERE SLAB CUTTING REQUIRED FOR

DRAIN PIPE WORK 4. POUR-BACK FOR SLAB CUT(S) SHALL HAVE #4 DOWELS X 12" LONG AT 24" O/ C, 3" IMBED INTO EXISTING SLAB, ON BOTH SIDES OF TRENCH.

5. TROWEL FINISH INTERIOR SLABS.

6. WHERE REQUIRED, TREAT THE GROUND WORK BELOW SLABS WITH TERMITE TREATMENT AND RETAIN THE CERTIFICATE WITH THE PLANS.

04.0 MASONRY: - MASONRY IS SPECIFIED IN THE STRUCTURAL DRAWINGS.

05.0 METALS: - LIGHT GAUGE INTERIOR FRAMING SHALL BE WITH GYPUSM WALL BOARD SHALL BE AS SPECIFIED IN DIVISION 09.

06.0 WOOD \$ PLASTIC:

OG. I ALL STRUCTURAL WOOD, FABRICATED TRUSSES, PLYWOOD SHEETING ETC... IS AS SPECIFIED AND DETAILED ON THE STRUCTURAL DRAWINGS.

06.2 ALL WOOD IN CONTACT W/ CMU, CONCRETE, OR STEEL SHALL BE PRESSURE TREATED. PROVIDE AN APPROVED MOISTURE VAPOR BARRIER BETWEEN THE CONCRETE OR OTHER CEMENTITIOUS MATERIALS AND THE WOOD AS REQUIRED PER APPLICABLE CODE.

O6.6 CONCEALED SPACES (FBC SECTION 7 | 8)

FIRE BLOCKING SHALL BE PROVIDED IN CONCEALED SPACES OF STUD WALLS AND PARTITIONS, INCLUDING FURRED SPACES, AND PARALLEL ROWS OF STUDS OR STAGGERED STUDS AS, FOLLOWS: (FBC 718.2.2)

I. VERTICALY AT THE CEILING AND FLOOR LEVELS.

2. HORIZONTALLY AT INTERVALS NOT EXCEEDING 10'-0" PROVIDE 1x2 OR 2x2 (PER WALL TYPE) FIRE STOP HORIZONTAL @ CEILING \$ WALL INTERSECTIONS AND/OR 8'-O" O/C VERT. MAX. AND ALL OTHER LOCATIONS

07.0 THERMAL & MOISTURE PROTECTION:

07.1 BUILDING INSULATION

A. ROOF INSULATION IN EXPOSED ROOF TRUSS SHALL BE CLOSED SPRAY-FOAM ON UNDERSIDE OF TRUSS SHEETING. (R-30) - REFER TO ENERGY CALC. B. ALL EXTERIOR BLOCK WALL SHALL BE 3/4" PT FURRING WITH R-4.1 FI-FOIL SHEETING OVER THE CAVITY

(IF APPLICABLE) 2X6 WOOD STUDS - LOAD-BEARING EXTERIOR WALLS ARE USED -INSULATE WITH 6" R-19 FIBERGLASS INSULATION BETWEEN EACH STUDS (PRIOR TO SHEETING WITH 5/8" GWB)

07.2 NEW (PITCHED) WOOD TRUSSES SHALL BE SHEATHED WITH 5/8" STRUCTURAL PLYWOOD (SPECIFICATIONS \$ NAILING PATTERN ON STRUCTURAL NOTES) AND FINISHED WITH GULF COAST - OCEAN GUARD, COASTAL ALUMINUM ROOFING OVER NOA-APPROVED MEMBRANE. (COLOR SHALL BE SILVER-ALUMINUM FINISH ON THE FRONT AND BACK, AND THE GARAGE ROOF DECK ROOF, AND DARK CHARCOAL GREY ON THE MAIN-HOUSE - COORDINATE COLORS WITH THE OWNER) USE GULF-SEAM (138 PSF) UPLIFT RESISTANT SYSTEM OR APPROVED **EQUAL**

07.3 FLASHING, WHERE INDICATED SHALL BE MINIMUM .032 ALUMINUM FLASHING - INSTALL AS NECESSARY TO PROVIDE WATER-TIGHT PENETRATIONS (ROOF-FLASHING SHALL BE PART OF ROOF PERMIT BY OTHERS)

07.4 SEALANT (CAULK) SEALANT FOR DOORS, WINDOWS, \$ WALL PENETRATIONS SHALL BE SILICONIZED LATEX (PAINTABLE).

07.5 BLOCK CORE (FOAM)

USE CFI FOAM, INC. INJECTION FOAM INSULATION IN ALL OPEN (HOLLOW BLOCK CORES) ALL UNITS INTERIOR \$ EXTERIOR. PRODUCT IS A CLASS I/CLASS A FIRE RATED PRODUCT. AT 85 PCF - 8" MASONRY WALL INSULATION WILL BE BETWEEN 12.0 \$ 7.8 R (USE RIO AVERAGE)

08.0 OPENINGS:

08.1 EXTERIOR DOORS \$ WINDOWS

EXTERIOR DOORS AND WINDOWS SHALL BE BE AS SCHEDULED, WITH MIAMI-DADE APPROVED NOA OR FLORIDA APPROVAL. (SUBSTITUTIONS ARE PERMITTED WITH WRITTEN APPROVAL OF THE ARCHITECT)

08.2 EGRESS WINDOWS

EGRESS WINDOWS SHALL BE OPERABLE FROM THE INSIDE WITHOUT THE USE OF TOOLS. EGRESS WINDOWS SHALL HAVE A MINIMAL NET OPENING OF 24" HIGH, 20" WIDE, AND MIN. NET AREA OF 5.7 S.F. FOR 2nd FLOOR WINDOWS AND 5.0 S.F. FOR 1st FLOOR WINDOWS. THE BOTTOM OF THE OPENING SHALL NOT BE MORE THAN 44" ABOVE THE FLOOR, LATCH AT 54" A.F.F. MAX. IN HVHZ AREAS WHERE THERE IS MORE THAN A 4'-O" DROP, THE SILL SHALL BE NO LESS THAN 24" AFF OR PROVIDE AN APPROVED SAFEGUARD. REFER TH FBC R3 I O. I

08.3 INTERIOR WOOD DOORS \$ FRAMES

ALL INTERIOR DOORS SHALL BE PAINT-GRADE SOLID CORE WITH HORIZONTAL PANELS OR FULL LOUVER, AS SCHEDULED. ALL INTERIOR DOORS SHALL BE JEN-WELD OR OWNER APPROVED EQUAL. ALL SHALL BE PRE-HUNG, FINGER-JOINTED, PAINT GRADE PINE. TRIM AS SELECTED BY THE OWNER.

08.5 DOOR HARDWARE

PROVIDE ALL DOOR HARDWARE AS SCHEDULED ON THE DRAWINGS AND AS REQUIRED TO COMPLETE THE DOOR OPERATION AND FUNCTION. ALL DOOR HARDWARE TO BE SCHLAGE RESIDENTIAL SERIES OR OWNER APPROVED EQUAL.

I. DOOR LEVER SETS SHALL BE: PASSAGE SET, PRIVACY SET, OR LOCK SET AS SCHEDULED (FINISH BY OWNER). PROVIDE STRIKE-PLATES TO MATCH. 2. ALL DOORS SHALL HAVE A MINIMUM OF 1 1/2 PAIR HINGES. 3. PROVIDE WALL BUMPERS FOR ALL DOORS.

08.6 EXTERIOR DOORS:

WHERE INDICATED, EXTERIOR SWING DOORS SHALL BE IMPACT RATED STEEL OR WOOD DOORS TO MEET THE REQUIRED WIND PRESSURES (SEE DRAWINGS \$ NOA).

I. FRENCH DOORS AS DETAILED ON THE DRAWINGS SHALL BE LAWSON (WOOD \$ GLASS) NOA#18-0903.06

2. GARAGE DOORS TO BE MODEL 2000 STEEL SECTIONAL GARAGE DOORS AS MANUFACTURED BY ADVANCED GARAGE DOOR CORP. NOA#16-0906.06

08.7 WINDOWS:

I. ALL EXTERIOR WINDOWS ARE IMPACT RATED LAWSON ALUMINUM WINDOWS. SEE SCHEDULE FOR TYPE(S): SLIDING, SINGLE HUNG, OR FIXED WINDOWS SHALL BE INSTALLED ACCORDING TO THE PUBLISHED NOTICE OF ACCEPTANCE (SEE NOA). ALL WINDOWS SHALL BE IN FINISH SELECTED BY OWNER. (GLASS TINT TO BE SELECTED BY OWNER.)

09.0 FINISHES:

09.1 METAL STUD AND GYPSUM WALL BOARD:

I. INTERIOR METAL STUDS TO BE 3 1/2" 25GA STANDARD INTERIOR STUDS ASSEMBLED WITH TOP & BOTTOM CHANNELS, HORIZONTAL CHANNEL BRIDGING @ 60" AFF, W FASTENERS BY SAME MANUFACTURER.

2. ALL GWB SHALL BE 5/8" STANDARD THICKNESS FOR WALLS AND 5/8" STANDARD THICKNESS FOR CEILINGS, IN 12' LENGTHS AND INSTALLED IN ACCORDANCE WITH INDUSTRY-STANDARDS. PROVIDE A PAINT READY LEVEL-4 FINISH.

3. WOOD BLOCKING SHALL BE AT ALL DOOR FRAMES

4. STUD WORK SUBCONTRACTOR SHALL BE RESPONSIBLE TO ADD MISCELLANEOUS WOOD BLOCKING (2x OR 3/4" PLYWOOD) AT ALL LOCATIONS REQUIRING ADDITIONAL SUPORT. WOOD BLOCKING TO BE PROVIDED, AT A MINIMUM, IN THE FOLLOWING LOCATIONS (SEE PLANS):

A. CABINET WORK, AND COUNTER TOPS

B. TOILET ROOM ACCESSORIES

C. LAVATORIES & VANITIES

D. SHELVING

E. PROVIDE TV MOUNTS AS NOTED ON PLANS.

F. OTHER; AS DIRECTED BY THE OWNER.

09.2 PAINTING:

ALL PAINT LISTED IN SUGGESTED SPECIFICATIONS IS COMMERCIAL GRADE SHERWIN-

WILLIAMS (OWNER APPROVED SUBSTITUTIONS PERMITTED) I A. INTERIOR WALLS (GYPSUM - IN ALL TOILET ROOMS)

PRIMER -Multi-Purpose Latex Primer (B5 | W450)

PAINT – Pro-Mar 200 0 VOC Semi-Gloss Latex Enamel IB. INTERIOR WALLS (TYPICAL FLAT PAINTED GYPSUM BOARD) PRIMER -Multi-Purpose Latex Primer (B5 | W450)

PAINT - Pro-Mar 200) VOC Latex Flat

IC. INTERIOR STAINED WOOD (WHERE NOTED) PRIMER -Multi-Purpose Latex Primer (B5 I W450)

PAINT - Pro-Mar 200 0 VOC Semi-Gloss Latex Enamel

ID. INTERIOR METAL FRAMES (PRIMED STEEL)

PRIMER -Pro-Cryl Universal Metal Primer (B66W310) PAINT - Pro-Mar 200 0 VOC Semi-Gloss Latex Enamel

IE. CEILINGS (PAINTED GYPSUM (THROUGH OUT) PRIMER -Multi-Purpose Latex Primer (B5 I W450)

PAINT -Pro-Mar 200) VOC Latex Flat

09.8 EXTERIOR FINISH:

GARAGE EXTERIOR WALLS SHALL BE FINISHED WITH A SIMULATED SIDING STUCCO FINISH IN 8" WIDE-PLANK SIMULATING SIDING AS INDICATED ON THE EXTERIOR ELEVATIONS. THE FINISHES ARE AS NOTED ON THE ELEVATIONS. PROVIDE SAMPLE FOR ARCHITECT AND OWNER APPROVAL PRIOR TO FINISHING WALL SURFACES.

I. STUCCO SUBSTRATES ON THIS PROJECT INCLUDE THE FOLLOWING:

- a. PLYWOOD SHEETING COVER WITH 15# FELT AND WIRE LATH
- b. NEW EXPOSED BLOCK POWER WASH AND LEAVE DAMP c. NEW POURED CONCRETE - COAT WITH PURPLE BONDING AGENT
- 2. INSTALL STUCCO BASE AND FINISH COATS ACCORDING TO ASTM 926 GUIDELINES 3. ACCESSORIES: USE FRY-REGLET BRUSHED ALUMINUM REGLETS WHERE INDICATED, USE DOUBLE "J" CONTROL JOINTS WERE INDICATED, ALL CORNER TRIM, DOUBLE J'S,

AND OTHER METAL ACCESSORIES SHALL BE ZINC-ALOY ONLY (NO GALV OR VINYL

- SUBSTITUTIONS PERMITTED) 4. ALL 90 DEGREE DOOR AND WINDOW CORNERS (WITH OUT AN EXPANSION JOINT, CONTROL JOINT, OR REGLET LEADING AWAY) - INSTALL A 6" WIDE, BY 12" LONG PIECE OF LATH AT 45% TO THE WINDOW IN THE BASE COAT. (AND/OR) LAMINATE IN THE
- FINISH COAT. 5. CUT ALL LATH BEHIND ALL EXPANSION, CONTROL, \$ REGLET JOINTS.
- 6. LAP ALL LATH JOINTS AS REQUIRED PER ASTM 1063
- 7. INSTALL BASE AND FINISH COATS, IN A UNIFORM THICKNESS, PER ASTM C926, MIST OR FOG CURE FOR 3 DAYS WHEN HUMIDITY IS BELOW 80% OR WIND ABOVE IOMPH.

10.0 SPECIALTIES: (NOT INCLUDED IN THIS SCOPE)

I I.O EQUIPMENT: GENERATOR BY OWNER

12.0 FURNISHINGS: (NOT INCLUDED IN THIS SCOPE)

13.0 SPECIAL CONSTRUCTION: AS NOTED ON PLANS

14.0 CONVEYING SYSTEMS: (NOT REQUIRED)

15.0 MECHANICAL & PLUMBING; SEE M & P DRAWINGS BY OWNER FOR MECHANICAL & PLUMBING


16.0 ELECTRICAL; SEE ELECTRICAL CONTRACTOR'S DRAWINGS FOR ELECTRICAL

END-OF-SCOPE AND SPECIFICATIONS

STEVE SIEBERT **ARCHITECTURE** 466 N. FEDERAL HIGHWAY **BOYNTON BEACH, FL 33435** PH. 561.880.7894

Steve@stevesiebert.com

www.stevesiebert.com

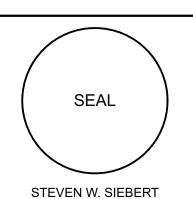

FLORIDA AR0017834 NEW JERSEY 21AI01517500

 $\langle
 \langle
 \rangle$

CONSTRUCTION DRAWINGS

— M


THE WRITTEN DIMENSIONS ON THESE DRAWINGS SHALL TAKE PRECEDENCE OVER SCALED DIMENSIONS. THE CONTRACTOR SHALL VERIFY AND BE RESPONSIBLE FOR ALL DIMENSIONS AND CONDITIONS ON THE JOB, AND THIS OFFICE MUST BE NOTIFIED OF ANY VARIATION FROM THE DIMENSIONS. COPYRIGHT STEVE SIEBERT ARCHITECTURE-UNAUTHORIZED ANY REPRODUCTION OR OTHER USE OF

PROJECT NO: 20-260 11.03.20 DATE:

THIS DRAWING IS PROHIBITED.

DRAWN BY: BRT CHECKED BY: SWS REVISIONS:

GENERAL NOTES &

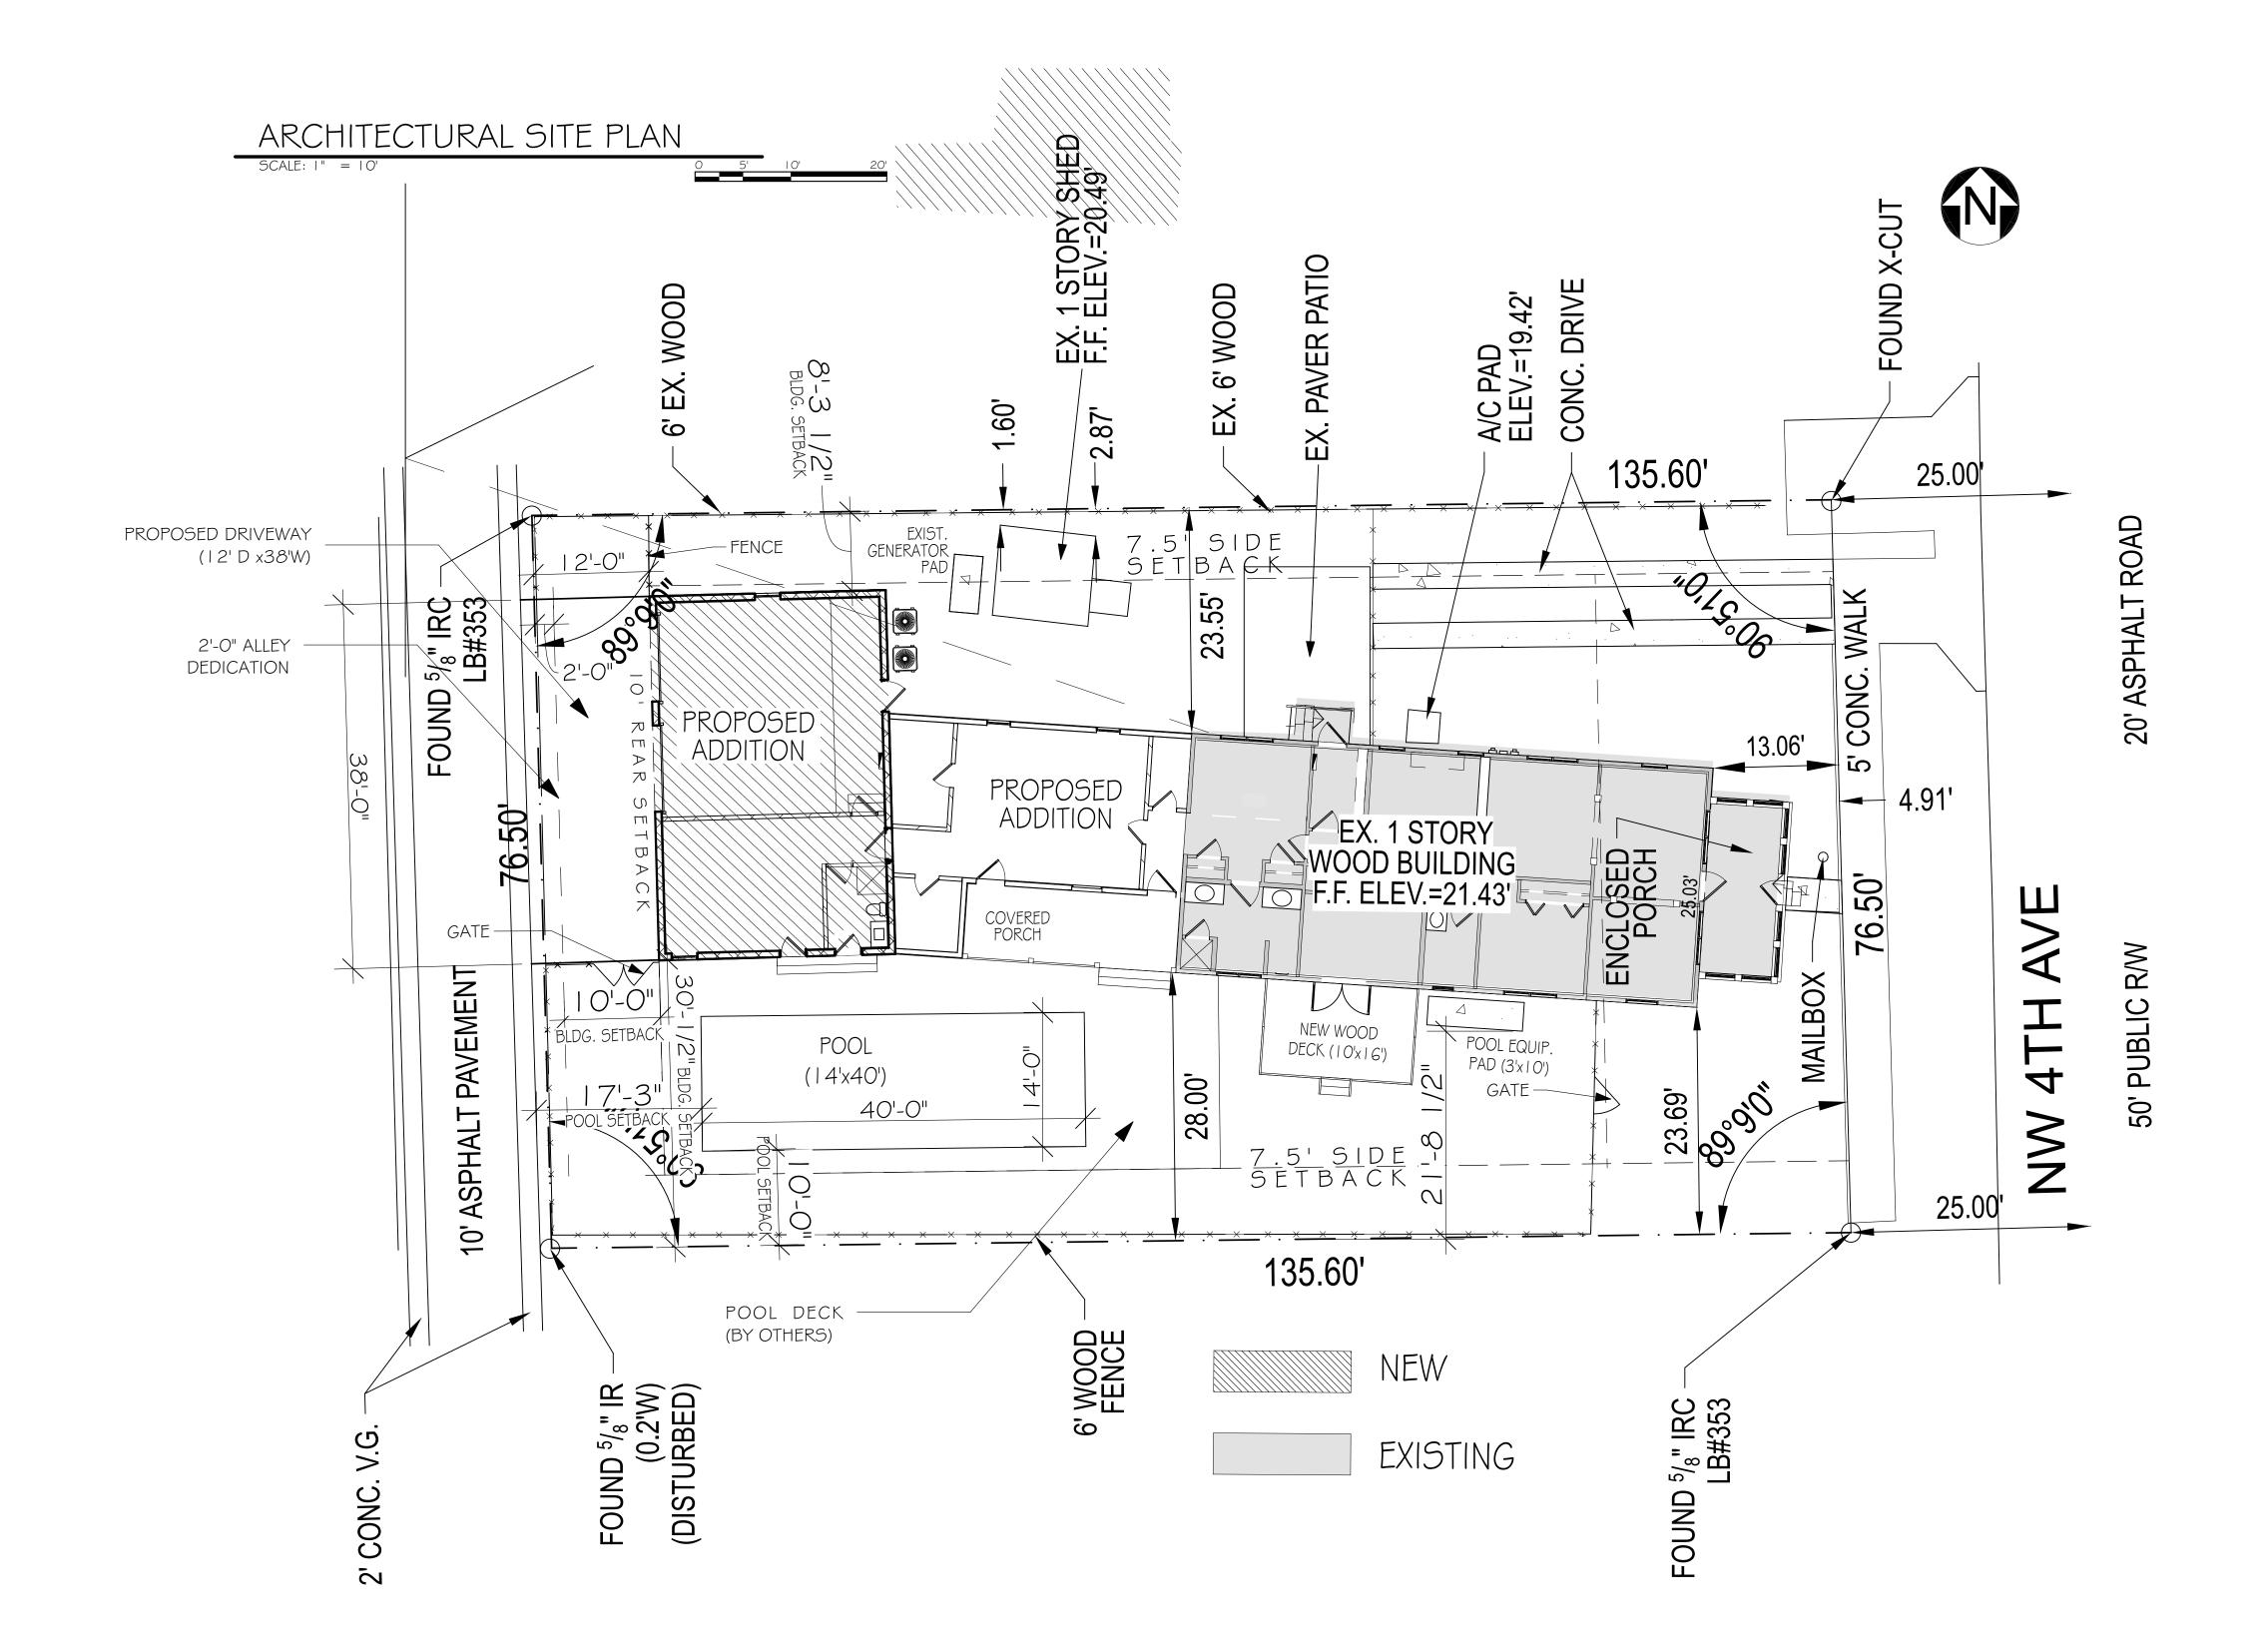



SEAL STEVEN W. SIEBERT FLORIDA AR0017834 NEW JERSEY 21AI01517500 TEXAS 26934

h Ave. ORIDA 120 NW 4th, BEACH, FLC

CONSTRUCTION DRAWINGS

DELRAY

THE WRITTEN DIMENSIONS ON THESE DRAWINGS SHALL TAKE PRECEDENCE OVER SCALED THE CONTRACTOR SHALL VERIFY AND BE RESPONSIBLE FOR ALL DIMENSIONS AND CONDITIONS ON THE JOB, AND THIS OFFICE MUST BE NOTIFIED OF ANY VARIATION FROM THE DIMENSIONS. COPYRIGHT STEVE SIEBERT ARCHITECTURE-UNAUTHORIZED ANY REPRODUCTION OR OTHER USE OF THIS DRAWING IS PROHIBITED.


PROJECT NO: 20-260

11.03.20 DRAWN BY:

CHECKED BY:__ REVISIONS: CLIENT CHGS 1.7.21

SITE PLAN

SP1.1

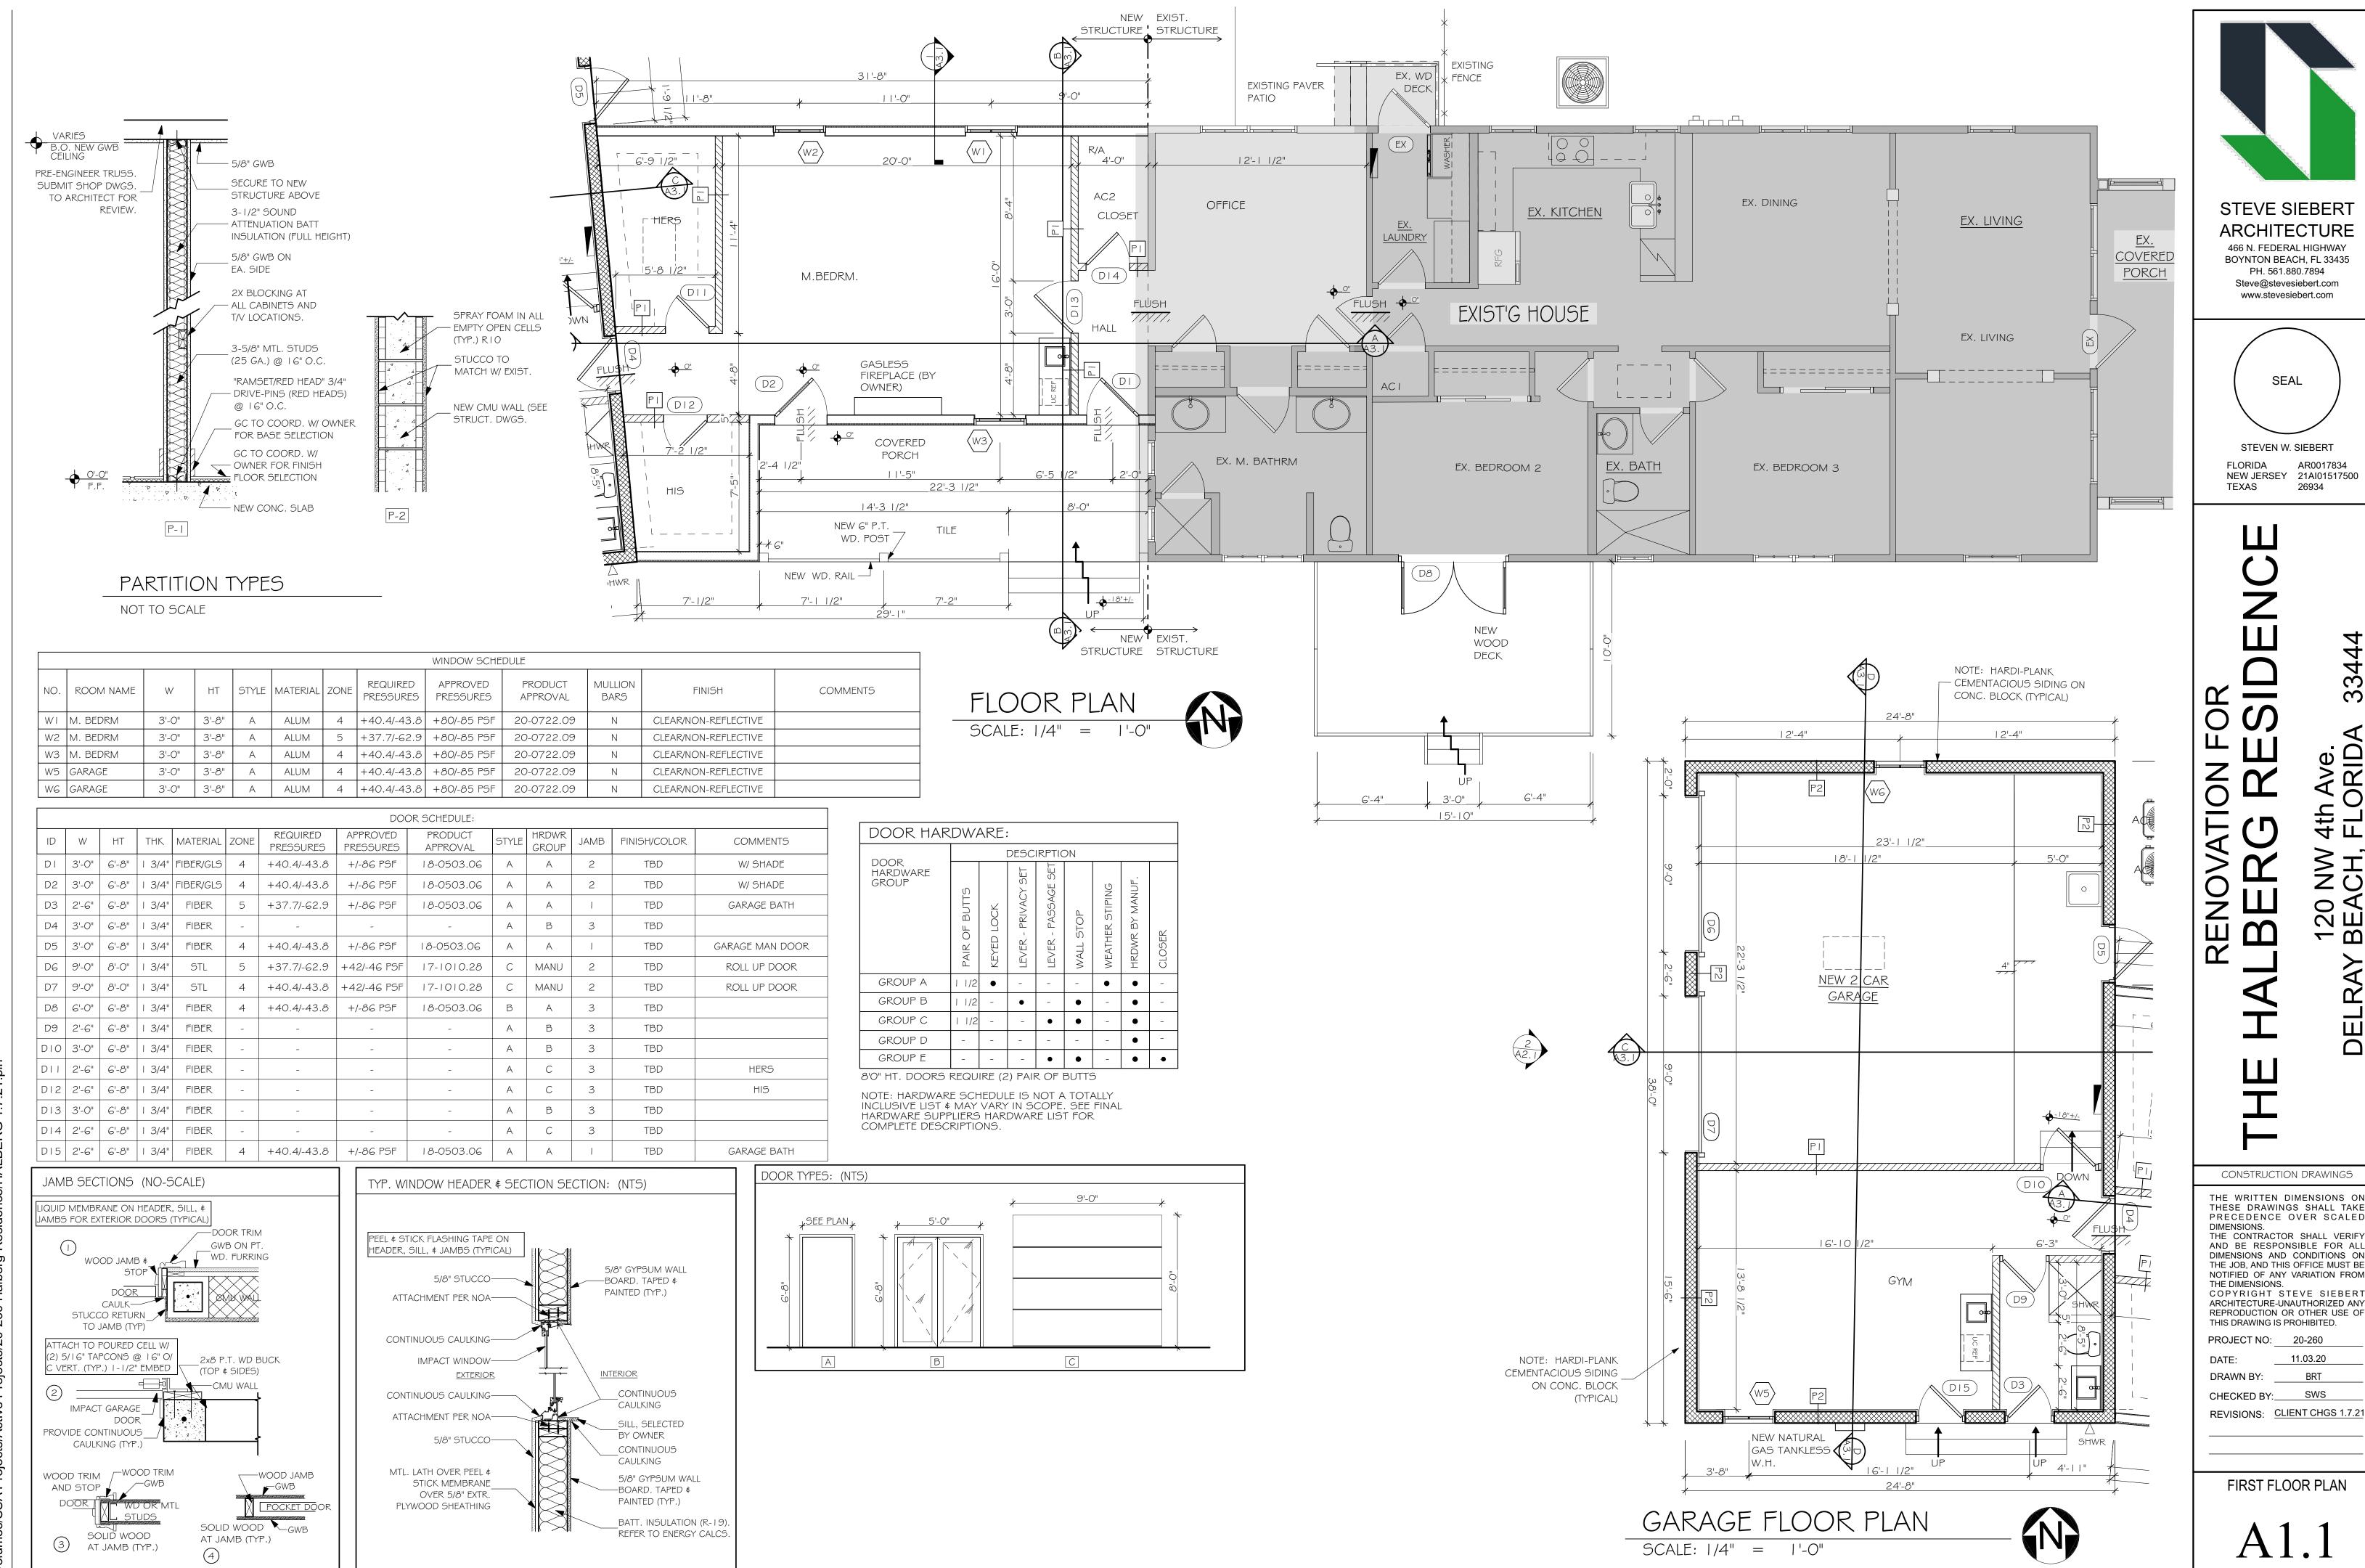



466 N. FEDERAL HIGHWAY BOYNTON BEACH, FL 33435 PH. 561.880.7894 Steve@stevesiebert.com www.stevesiebert.com

SEAL STEVEN W. SIEBERT FLORIDA

TEXAS 26934

AR0017834 NEW JERSEY 21AI01517500

OENC

CONSTRUCTION DRAWINGS


THE WRITTEN DIMENSIONS ON THESE DRAWINGS SHALL TAKE PRECEDENCE OVER SCALED THE CONTRACTOR SHALL VERIFY AND BE RESPONSIBLE FOR ALL DIMENSIONS AND CONDITIONS ON THE JOB, AND THIS OFFICE MUST BE NOTIFIED OF ANY VARIATION FROM THE DIMENSIONS. COPYRIGHT STEVE SIEBERT ARCHITECTURE-UNAUTHORIZED ANY REPRODUCTION OR OTHER USE OF

THIS DRAWING IS PROHIBITED. PROJECT NO: 20-260

11.03.20 BRT DRAWN BY: CHECKED BY: SWS

FIRST FLOOR PLAN


EXIST. EAST ELEVATION SCALE: 1/4" = 1'-0"

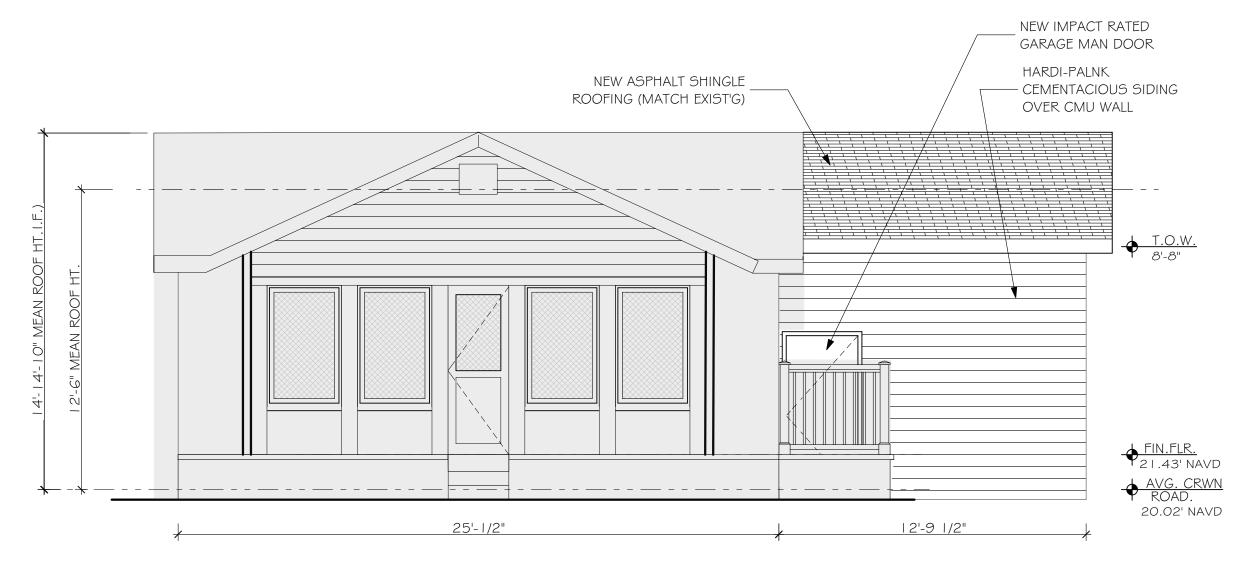

PROPOSED EAST ELEVATION SCALE: 1/4" = 1'-0"



EXIST. WEST ELEVATION

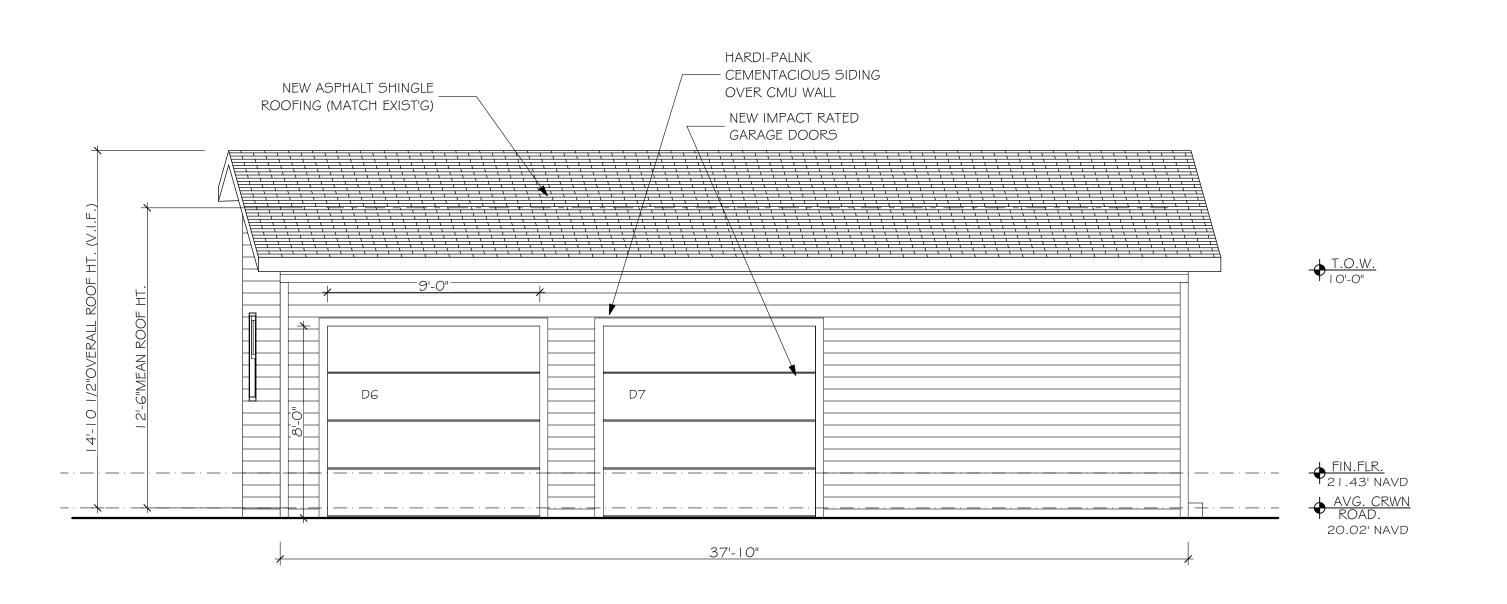


PROPOSED WEST ELEVATION



ARCHITECTURE 466 N. FEDERAL HIGHWAY BOYNTON BEACH, FL 33435 PH. 561.880.7894 Steve@stevesiebert.com

www.stevesiebert.com

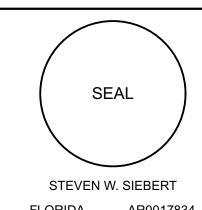

FLORIDA AR0017834 NEW JERSEY 21AI01517500 TEXAS 26934

CONSTRUCTION DRAWINGS

THE WRITTEN DIMENSIONS ON THESE DRAWINGS SHALL TAKE PRECEDENCE OVER SCALED DIMENSIONS. THE CONTRACTOR SHALL VERIFY
AND BE RESPONSIBLE FOR ALL
DIMENSIONS AND CONDITIONS ON THE JOB, AND THIS OFFICE MUST BE NOTIFIED OF ANY VARIATION FROM THE DIMENSIONS. COPYRIGHT STEVE SIEBERT ARCHITECTURE-UNAUTHORIZED ANY REPRODUCTION OR OTHER USE OF


DELRAY

THIS DRAWING IS PROHIBITED. PROJECT NO: _____20-260 11.03.20 DRAWN BY: BRT


CHECKED BY: SWS REVISIONS: _____

ELEVATIONS

PROPOSED SOUTH ELEVATION SCALE: 1/4" = 1'-0"

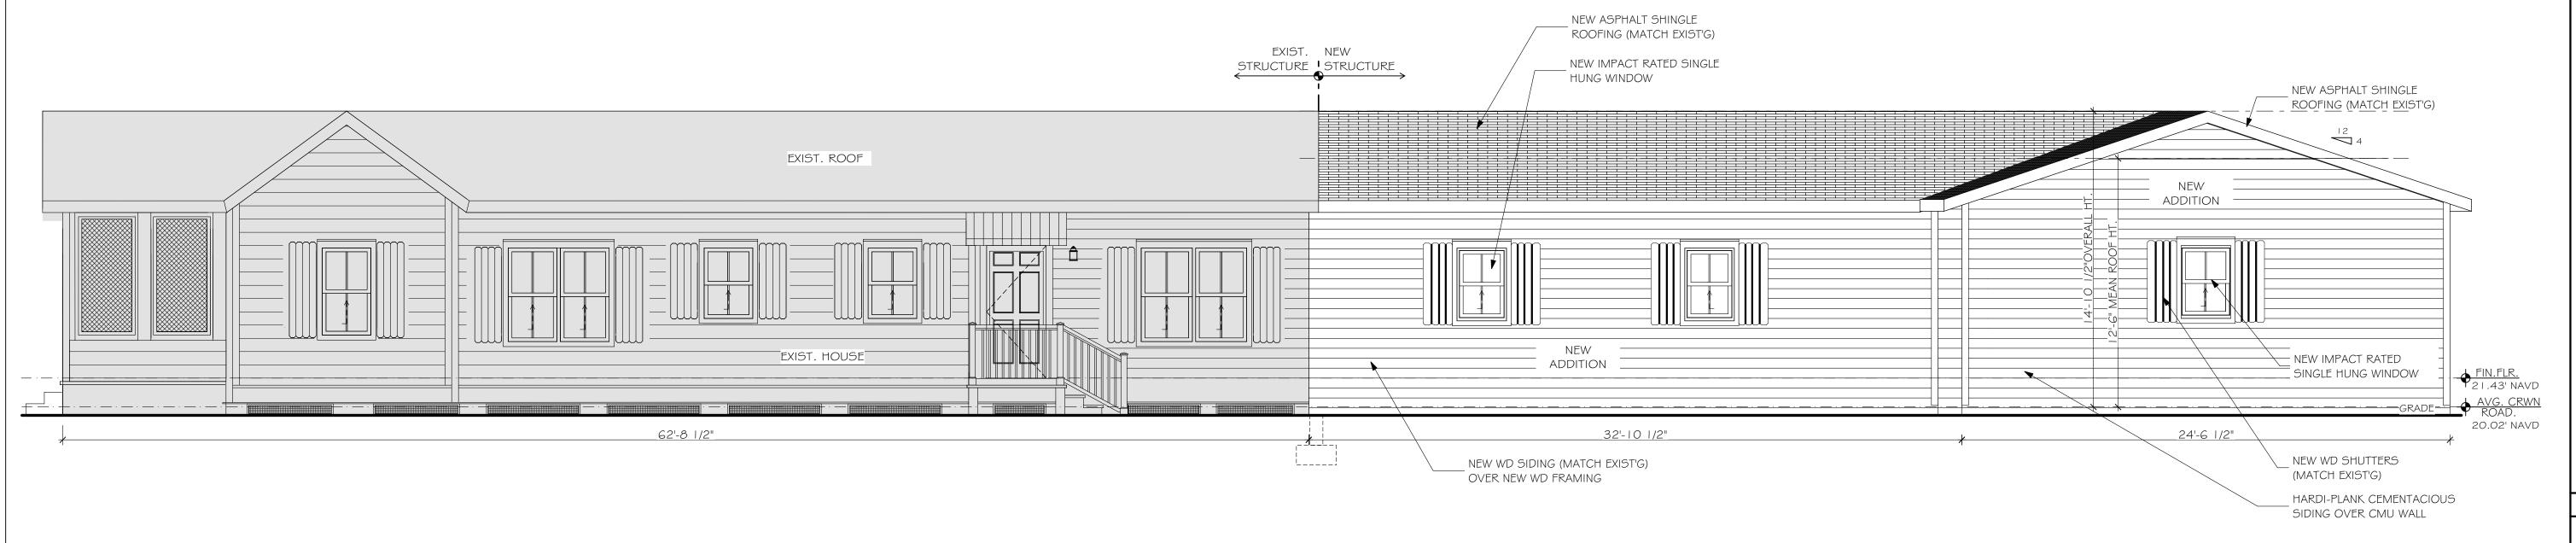


PROPOSED NORTH ELEVATION

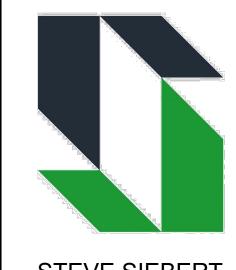

STEVE SIEBERT ARCHITECTURE 466 N. FEDERAL HIGHWAY BOYNTON BEACH, FL 33435 PH. 561.880.7894

Steve@stevesiebert.com

www.stevesiebert.com

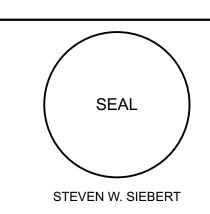

FLORIDA AR0017834 NEW JERSEY 21AI01517500 TEXAS 26934

SIDENC

120 NW 4th BEACH, FL(

DELRAY

CONSTRUCTION DRAWINGS

THE WRITTEN DIMENSIONS ON THESE DRAWINGS SHALL TAKE PRECEDENCE OVER SCALED DIMENSIONS. THE CONTRACTOR SHALL VERIFY
AND BE RESPONSIBLE FOR ALL
DIMENSIONS AND CONDITIONS ON THE JOB, AND THIS OFFICE MUST BE NOTIFIED OF ANY VARIATION FROM THE DIMENSIONS. COPYRIGHT STEVE SIEBERT ARCHITECTURE-UNAUTHORIZED ANY REPRODUCTION OR OTHER USE OF

THIS DRAWING IS PROHIBITED. PROJECT NO: 20-260

11.03.20 DRAWN BY: BRT

CHECKED BY: SWS REVISIONS: CLIENT CHGS 1.7.21

ELEVATIONS

NEW ASPHALT SHINGLE ROOFING

NEW ASPHALT SHINGLE

NEW EXIST'G



STEVE SIEBERT **ARCHITECTURE** 466 N. FEDERAL HIGHWAY BOYNTON BEACH, FL 33435 PH. 561.880.7894 Steve@stevesiebert.com

www.stevesiebert.com



NEW JERSEY 21AI01517500 TEXAS 26934

← M

CONSTRUCTION DRAWINGS

THE WRITTEN DIMENSIONS ON THESE DRAWINGS SHALL TAKE PRECEDENCE OVER SCALED DIMENSIONS. THE CONTRACTOR SHALL VERIFY AND BE RESPONSIBLE FOR ALL DIMENSIONS AND CONDITIONS ON THE JOB, AND THIS OFFICE MUST BE NOTIFIED OF ANY VARIATION FROM THE DIMENSIONS. COPYRIGHT STEVE SIEBERT ARCHITECTURE-UNAUTHORIZED ANY REPRODUCTION OR OTHER USE OF

THIS DRAWING IS PROHIBITED. PROJECT NO: 20-260 11.03.20

DRAWN BY: BRT CHECKED BY:____ **REVISIONS:**

BUILDING SECTIONS

GENERAL DEMOLITION NOTES

I. DEMOLITION PLANS SHOW APPROXIMATE LAYOUT OF EXISTING BUILDING AND ARE NOT INTENDED TO REPRESENT EXACT "AS-BUILT" CONDITIONS. CONTRACTOR SHALL VISIT THE SITE AND BECOME FAMILIAR WITH THE ACTUAL SITE CONDITIONS PRIOR TO BIDDING. 2. ALL ELECTRICAL DEMOLITION (DISCONNECT) WORK, SHALL BE PERFORMED BY A FLORIDA LICENSED ELECTRICAL CONTRACTOR AND COMPLETED IN ACCORDANCE WITH ALL CURRENT APPLICABLE CODES. 3. ALL PLUMBING DEMOLITION (SUPPLY AND DRAIN LINES) SHALL BE PROPERLY DISCONNECTED AND TEMPORARILY CAPPED BY A FLORIDA LICENSED PLUMBING CONTRACTOR.

4. ASBESTOS REPORT FOR DEMOLITION SHALL BE COMPLETED AND SUBMITTED BY THE G.C.

5. THE DEMOLITION CONTRACTOR SHALL BE RESPONSIBLE FOR THE REMOVAL OF DEBRIS FROM THE SITE AND FOR MAINTAINING A CLEAN JOB SITE.

6. ALL HAZARDOUS MATERIALS SHALL BE PROPERLY REMOVED AS REQUIRED BY AN EPA LICENSED AND INSURED MATERIAL CONTAINMENT CONTRACTOR.

7. SELECTIVE DEMOLITION SHALL BE PERFORMED WITH A METHOD DESIGNED TO PRESERVE ADJACENT MATERIAL SCHEDULED TO REMAIN. TAKE EXTRA CARE TO PRESERVE EXISTING ELEMENTS SCHEDULED FOR REINSTALLATION OR REUSE.

8. PROVIDE ALL NECESSARY SHORING, BRACING, AND SUPPORT TO PREVENT MOVEMENT, SETTLEMENT, OR COLLAPSE OF THE STRUCTURE TO BE DEMOLISHED, OR ADJACENT ELEMENT SHOWN TO REMAIN.

DEMOLITION NOTES:

I. REMOVE THE EXISTING EAST EXTERIOR LOAD BEARING 2x FRAMED WALL, DOORS & WINDOWS. PROVIDE BRACING AS


2. REMOVE A PORTION OF THE SOUTH EAST WALL AND WINDOW AS SHOWN.

3. REMOVE THE EXISTING MASTER BATH VANITY, BATH TUB

SURROUND AND SHOWER ENCLOSURE. 4. REMOVE THE EXISTING WOOD FRAMED PORCH STRUCTURE,

STEPS AND RAILINGS. 5. REMOVE THE EXISTING MASTER BEDROOM CLOSETS.

5. REMOVE THE INTERIOR DOOR BETWEEN THE MASTER BEDROOM AND MASTER BATH. SAVE FOR REINSTALLATION.

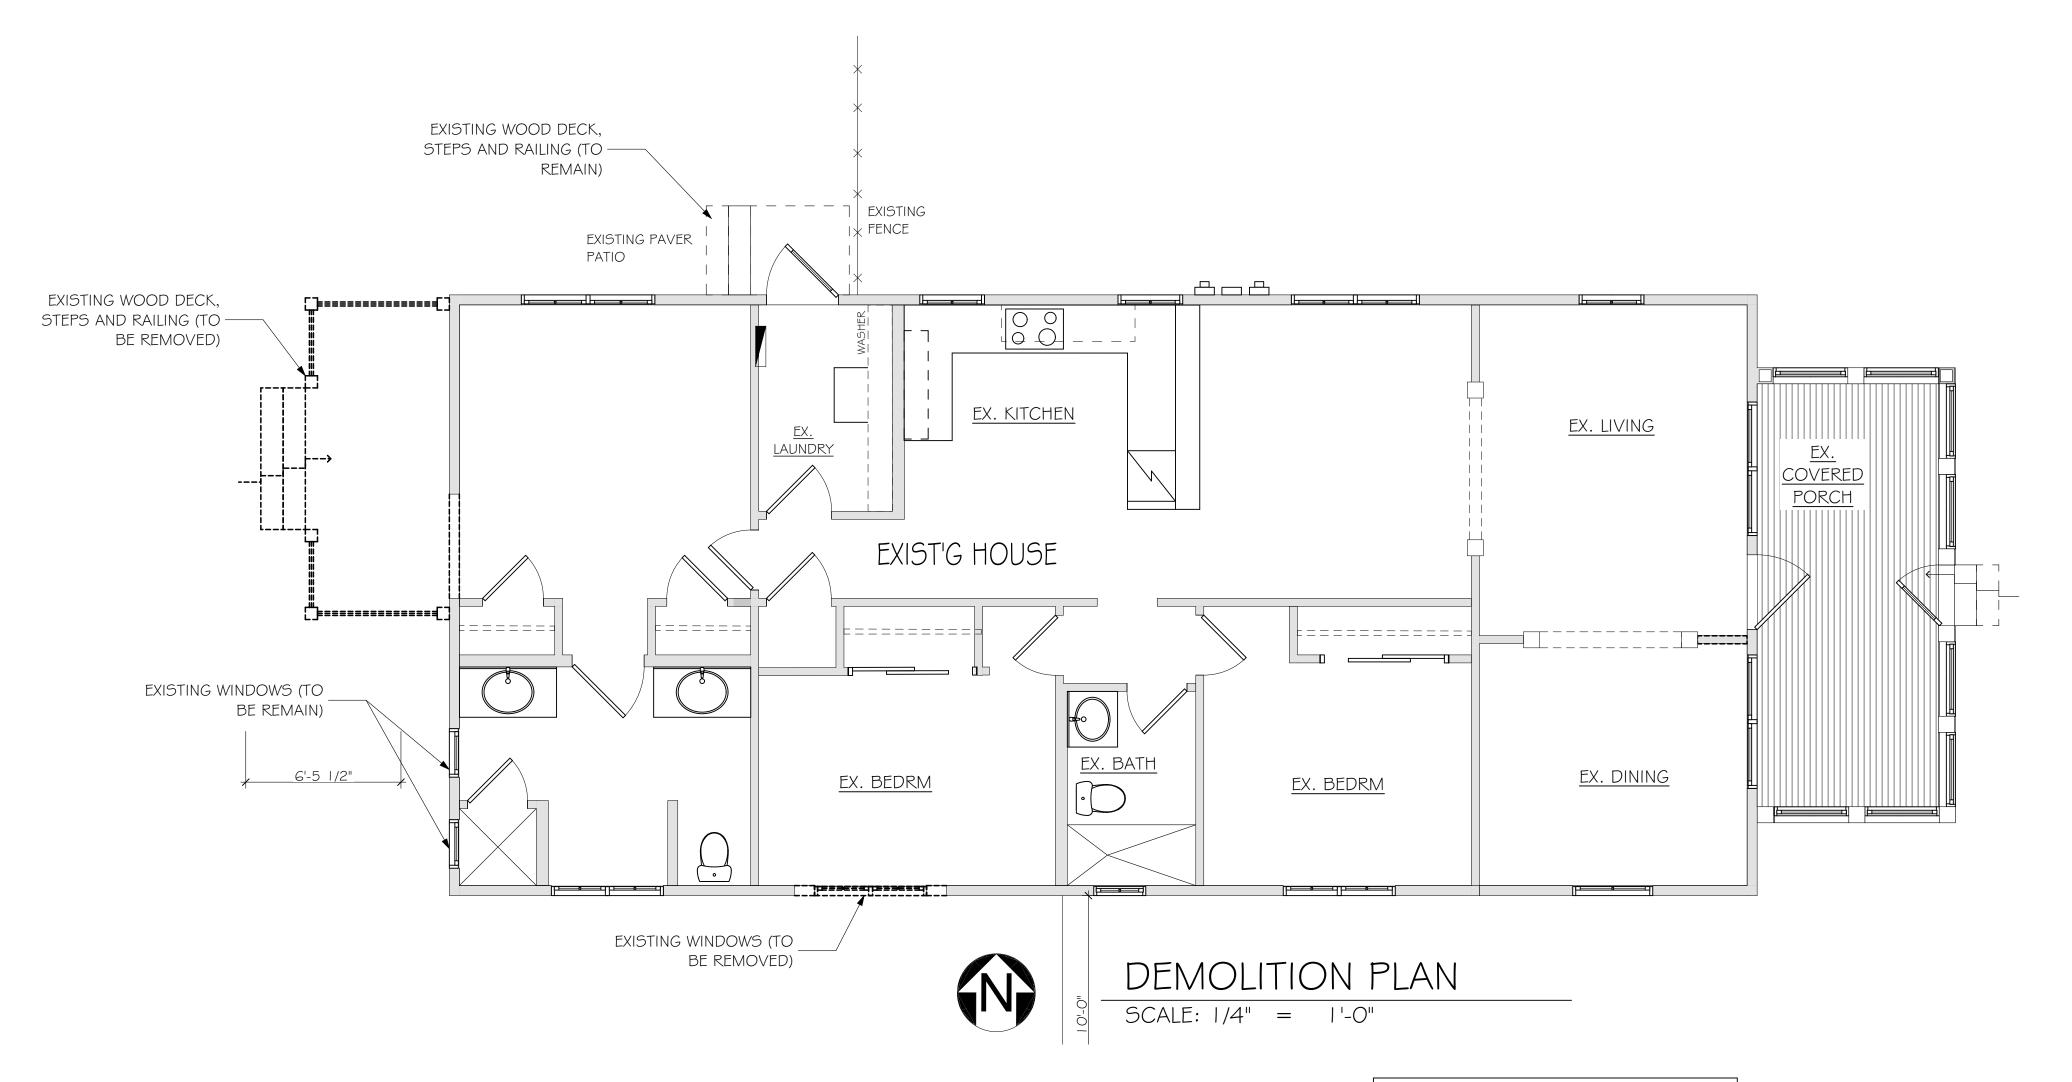


DEMOLITION LEGEND [___] EXISTING TO BE REMOVED EXISTING TO REMAIN EXISTING MASONRY WALL TO REMAIN



STEVE SIEBERT

ARCHITECTURE 466 N. FEDERAL HIGHWAY

BOYNTON BEACH, FL 33435 PH. 561.880.7894 Steve@stevesiebert.com www.stevesiebert.com

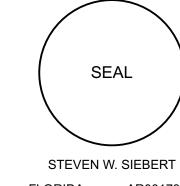

TEXAS 26934

AR0017834 NEW JERSEY 21AI01517500

CONSTRUCTION DRAWINGS

THE WRITTEN DIMENSIONS ON THESE DRAWINGS SHALL TAKE PRECEDENCE OVER SCALED DIMENSIONS. THE CONTRACTOR SHALL VERIFY AND BE RESPONSIBLE FOR ALL DIMENSIONS AND CONDITIONS ON THE JOB, AND THIS OFFICE MUST BE NOTIFIED OF ANY VARIATION FROM THE DIMENSIONS.


REPRODUCTION OR OTHER USE OF THIS DRAWING IS PROHIBITED.

COPYRIGHT STEVE SIEBERT ARCHITECTURE-UNAUTHORIZED ANY


PROJECT NO: 20-260 11.03.20 DRAWN BY: BRT


CHECKED BY: SWS REVISIONS: CLIENT CHGS 1.7.21


DEMOLITION PLAN

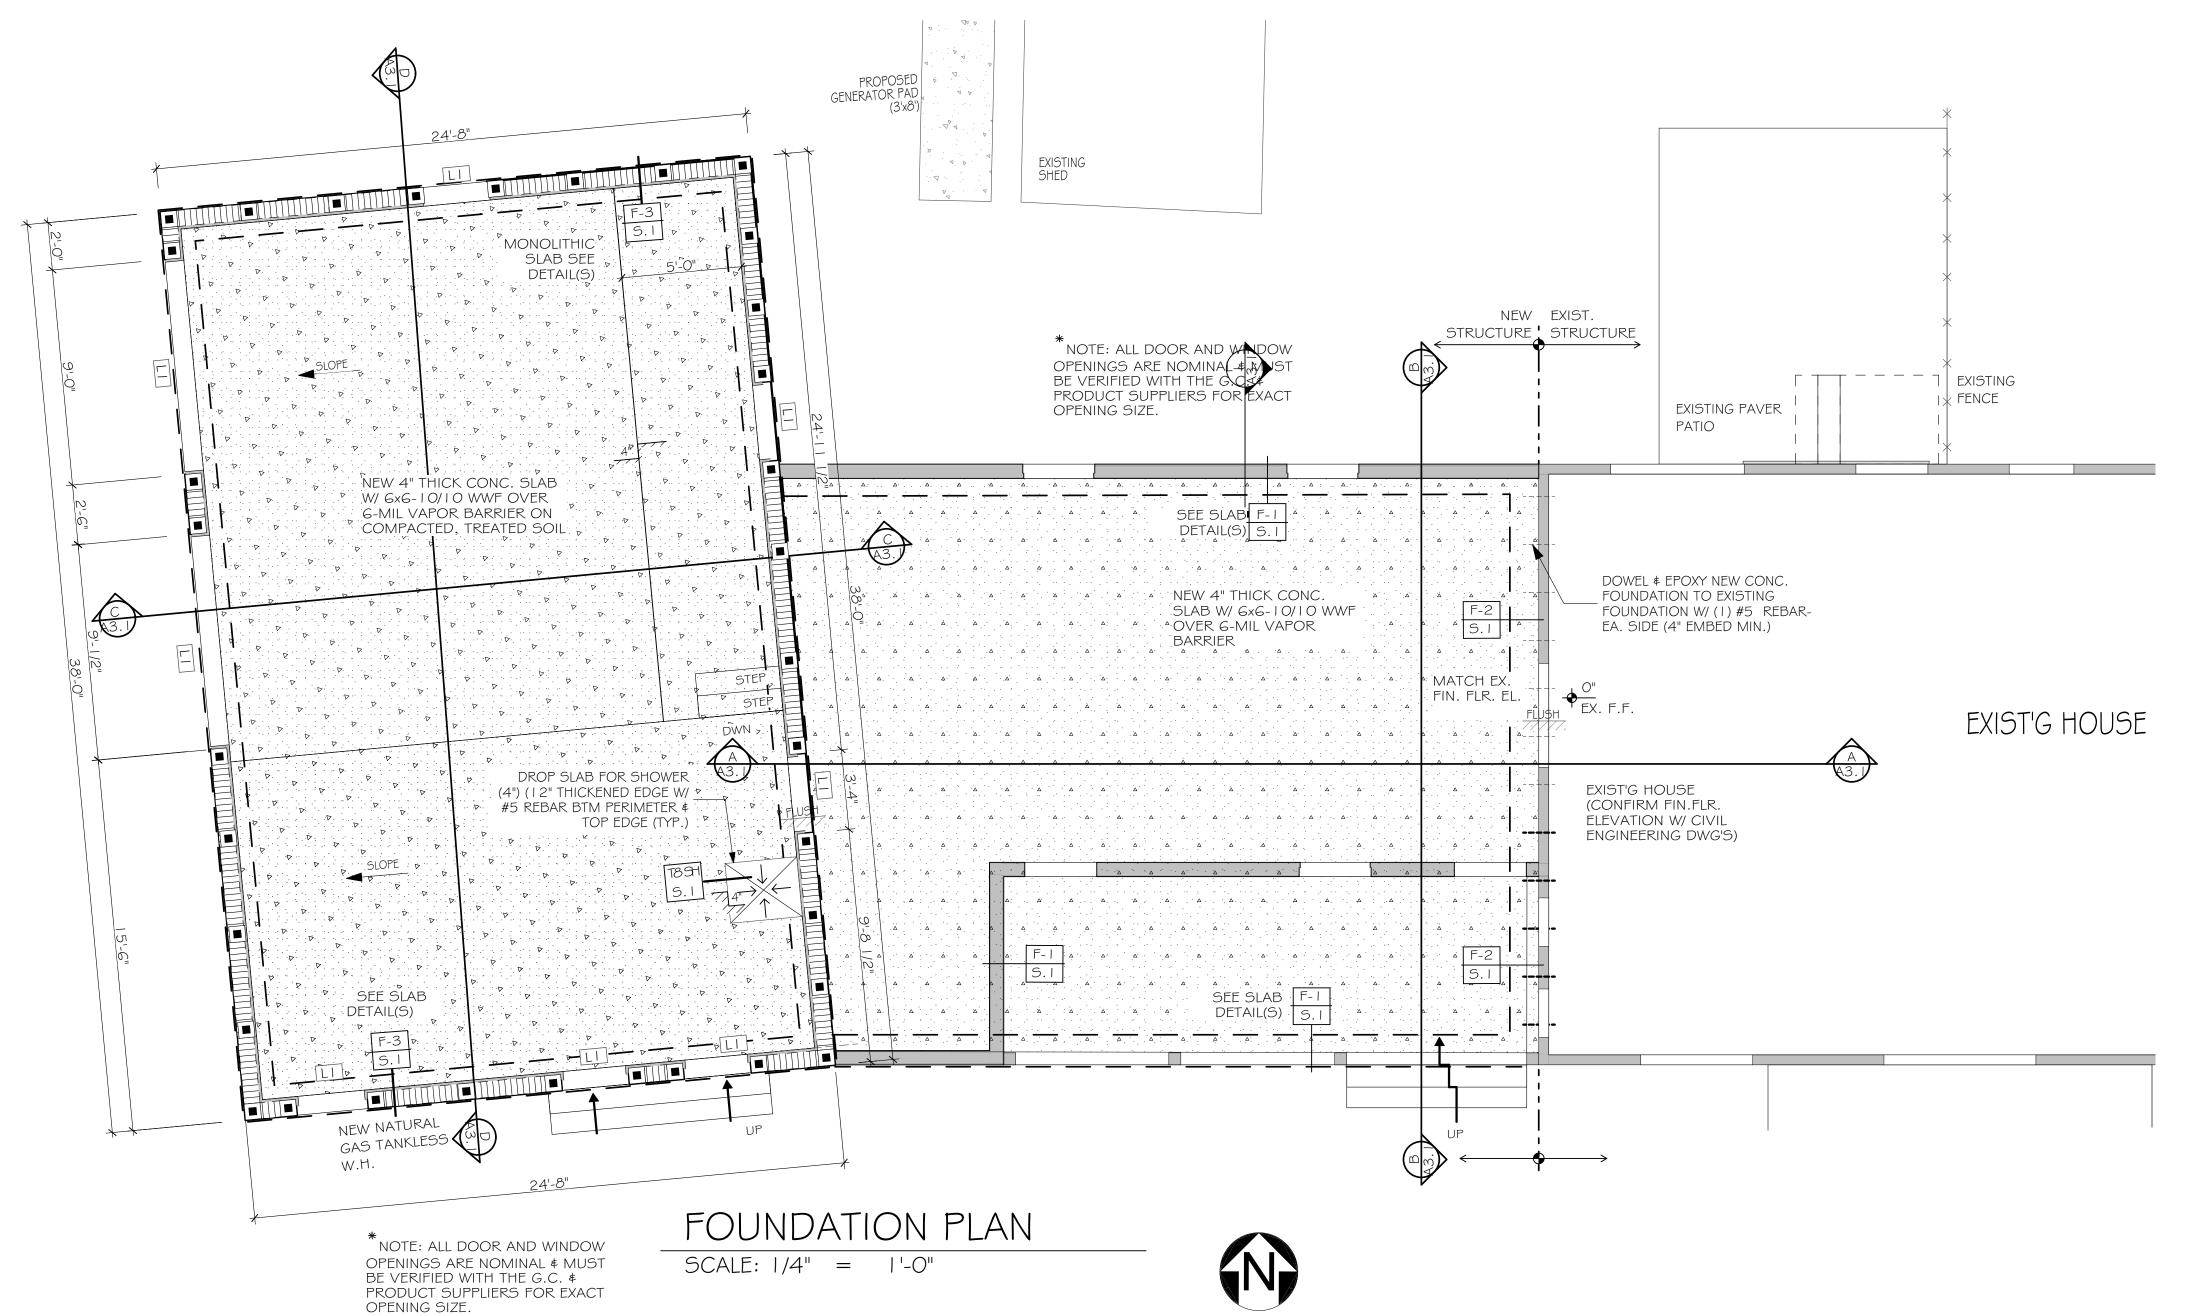


FOOTING SCHEDULE REINFORCING DESCRIPTION SYMBOL | SIZE (WxD) POURED CONC. F-4 12"x12"x8" FOOTER @ DECK F-3 16"x16"x CONT. (2) #5 CONT. MONOLITHIC MONOLITHIC F-2 8"x24"x CONT. (2) #5 CONT. POURED CONC. (5) #5 @ 10" OC 12"x24"x CONT. F-1 STEM WALL EA. WAY

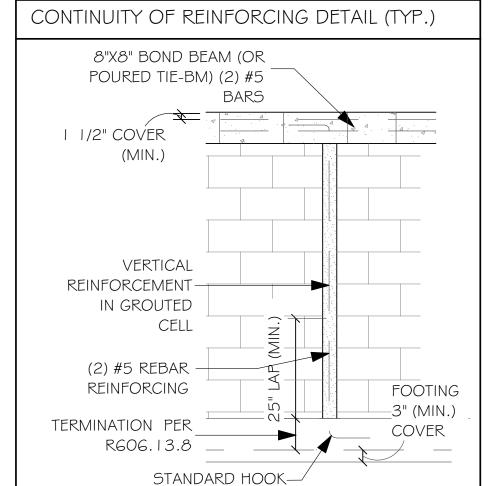

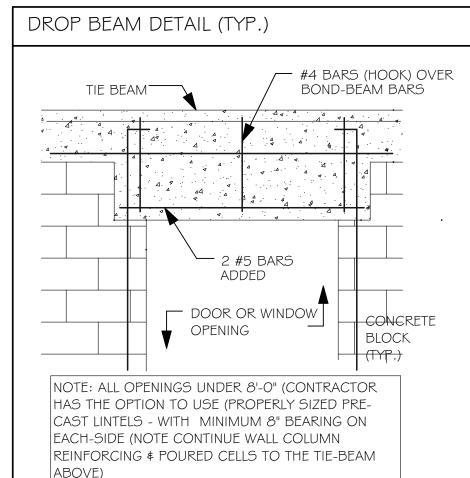

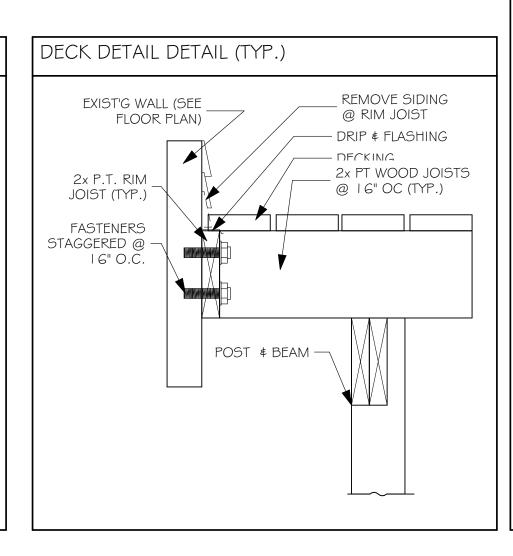

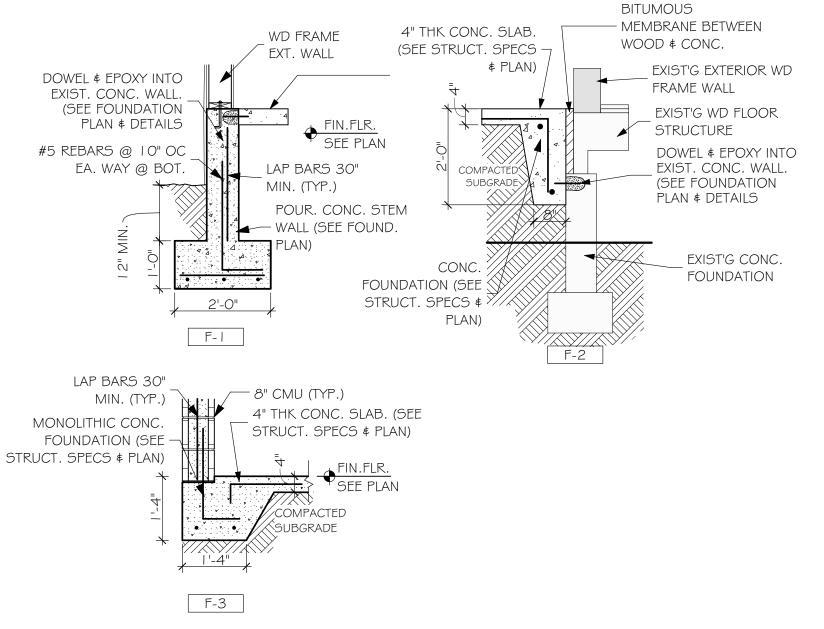

FOUNDATION DETAILS;

STRUCTURAL NOTES:

DESIGN CRITERIA:

DESIGN BASED ON THE PROVISIONS OF THE FLORIDA BUILDING CODE 2017 6th EDITION, EXISTING

ROOF LOADS: LL= 30 PSF, DL=25 PSF

WIND LOADS: BASIC WIND SPEED: V= 170 MPH (3 SEC GUST)

IMPORTANT FACTOR I= 1.0 EXPOSURE CATEGORY =C

INTERNAL PRESSURE COEFFICIENT =+/-0.18 KD (DIRECTIONALITY) = 1.0

I. MATERIALS USED SHALL BE NEW, OF GOOD QUALITY AND THE CONSTRUCTION PERFORMED BY WORKERS SKILLED IN THEIR TRADE AND IN ACCORDANCE WITH RECOMMENDED PRACTICE NO DIMENSIONS SHALL BE SCALED FROM DRAWINGS (THE BUILDING IS EXISTING AND

SHOULD BE FIELD MEASURED FOR ALL MEASUREMENTS) THESE NOTES SHALL BE USED IN CONJUNCTION WITH THE ARCHITECTS NOTES AND SPECIFICATIONS

WHEN PREFORMING WORK, CARE SHALL BE TAKEN TO PROTECT EXISTING ELEMENTS TO THE CONTRACTOR SHALL BE RESPONSIBLE FOR ALL LABOR, MATERIAL EQUIPMENT AND

SERVICES OF EVERY KIND, INCLUDING WATER AND POWER NECESSARY FOR PROPER EXECUTION OF THE WORK SHOWN ON THESE DRAWINGS.

THE SITE SHALL BE KEPT CLEAN FROM ACCUMULATION OF WATER, MATERIALS, AND DEBRIS. AT THE END OF THE WORK, THIS CONTRACTOR SHALL LEAVE THE BUILDING AND SURROUNDING AREA BROOM CLEAN.

SHOP DRAWINGS ARE AN AID FOR FIELD PLACEMENT AND ARE SUPERSEDED BY THE STRUCTURAL DRAWINGS. IT SHALL BE THE RESPONSIBILITY OF THE GENERAL CONTRACTOR TO MAKE SURE THAT ALL CONSTRUCTION IS IN FULL AGREEMENT WITH THE LATEST STRUCTURAL DRAWINGS. SOILE TREATMENT (UNDER SLAB)

SOIL UNDER NEW SLAB & POUR-BACK TRENCH(S) SHALL BE TREATED FOR SUBTERRANEAN TERMITES AND A CERTIFICATE OF COMPLETION SHALL BE ISSUED TO THE BUILDING DEPARTMENT BY A LICENSED COMPANY.

ALL REINFORCING STEEL SHALL BE DEFORMED BARS FREE FROM LOSE RUST AND SCALE CONFORMING TO ASTM A615/A615M

ALL REINFORCING SHALL BE DETAILED AND FABRICATED FOLLOWING THE REQUIREMENTS OF ACI-244-94. PLACING OF REBARS SHALL CONFORM TO CRSI "RECOMMENDED PRACTICES FOR PLACING REINFORCING BARS"

MINIMUM CONCRETE COVER ON REINFORCING STEEL FOR NON-PRESTRESSED CONCRETE SHALL BE AS FOLLOWS:

		MIN COVER	TOLERANCE
- CAST AGAINST & PERN	MANENTLY		
EXPOSED TO EARTH OR	R WEATHER	3"	3/8"
- #5 AND SMALLER BAR	25	l 1/2"	3/8"
- #G AND LARGER BARS	D .	2"	3/8"
- NOT EXPOSED TO EAR	RTH OR WEATHER	1 "	3/8"
- BEAMS AND COLUMN	S	l √2"	3/8"
- SLABS ON GRADE		l 1/2"	1/4"

NO DEVIATION FROM THE STRUCTURAL PLANS SHALL BE PERMITTED WITHOUT THE EXPRESS WRITTEN CONSENT OF THIS STRUCTURAL ENGINEER. ALL REINFORCING DETAILS TO BE SUBMITTED TO THE ENGINEER FOR HIS APPROVAL

ALL REINFORCING BARS SHALL BE SECURELY HELD IN-PLACE DURING CONCRETE POURING - IF NECESSARY ADDITIONAL BARS SHALL BE PROVIDED BY THE CONTRACTOR TO FURNISH SUPPORT TO REQUIRED BARS.

ALL WALLS AND COLUMNS SHALL BE DOWELED INTO FOOTINGS, WALLS, BEAMS, OR SLABS WITH BARS OF THE SAME SIZE AND SPACING AS THE BARS ABOVE. USE (30) BAR DIAMETER LAP DISTANCE UNLESS NOTED OTHERWISE.

VERTICAL WALL BARS SHALL BE SPLICED AT OR NEAR FLOOR LINES. LINTELS MAY BE USED IN MASONRY OPENINGS UP TO 5'4" CLEAR. THESE MAY BE PRE-CAST OR CAST-IN-PLACE AND SHALL BE 8" NOMINAL WITH A MINIMUM OF (2) #5 TOP AND

BOTTOM BARS.

ALL STRUCTURAL LUMBER TO BE SOUTHERN YELLOW PINE NO.2 OR BETTER. NON- STRUCTURAL LUMBER TO BE SPF (SPRUCE PINE FIR) #2 OR BETTER. WOOD IN CONTACT WITH CONCRETE OR MASONRY SHALL BE PRESSURE-TREATED (WOLMANIZED

WOOD SHALL BE SIZED AS INDICATED ON THE STRUCTURAL DRAWINGS. PLYWOOD SHALL COMPLY WITH THE PLYWOOD DESIGN SPECIFICATION BY THE AMERICAN PLYWOOD

PLYWOOD SHEATHING SHALL BE 5/8" APA RATED SHEATHING.

RTING, PLACING, CURING, AND DEPOSITING OF CONCRETE SHALL COMPLY WITH (ACI - 301-99)

WHERE INDICATED ON THE DRAWINGS, WOOD BUCKS SHALL BE A SINGLE, NON-STRUCTURAL MEMBER 3/4" OR I I/2" THICK IS ACCEPTABLE.

WIDTH SHALL BE 5 1/2" +/- TO ACCOMMODATE THE FULL WIDTH OF THE WINDOW FRAME ATTACH WOOD BUCKS WITH CUT NAILS AT 24" O/C (FRONT AND BACK) \$ AT EACH END.

ALL WINDOW ANCHORS SHALL EMBED A MINIMUM OF 1 1/4" INTO THE CONCRETE OR MASONRY STRUCTURAL FRAME.

CONCRETE:

ALL REINFORCED CONCRETE DESIGN SHALL BE IN ACCORDANCE WITH BUILDING CODE REQUIREMENTS (ACI - 318-02)

ALL CONCRETE WORK SHALL BE DONE IN ACCORDANCE WITH SPECIFICATIONS FOR STRUCTURAL CONCRETE FOR BUILDINGS (ACI - 301-99) CONCRETE STRENGTH AT 28 DAYS SHALL BE AS FOLLOWS: FOUNDATIONS - 3500 PSI,

COLUMNS - 3500 PSI, STRUCTURAL SLABS - 4000 PSI, BEAMS - 3500 PSI, SLABS ON

GRADE - 3000 PSI, EXTERIOR WALKS, STEPS, RAMPS - 3000 PSI. FORMWORK SHALL COMPLY WITH RECOMMENDED PRACTICE FOR CONCRETE FORMWORK (ACI

THE OWNER SHALL CONTACT AN INDEPENDENT LABORATORY APPROVED BY THE ENGINEER TO PERFORM CONCRETE CYLINDER TESTS: (4) FOR EACH DAY OF POURING TRANSPORTING, PLACING, CURING, AND DEPOSITING OF CONCRETE SHALL COMPLY WITH (ACI - 301-99)

REINFORCED MASONRY LOAD BEARING:

LAY UP ALL 8" MASONRY UNITS (IN-RUNNING-BOND) PRIOR TO THE CONSTRUCTION OF THE SUPPORTED MEMBERS. USE TYPE M MORTAR IN BEARING WALLS. CONSTRUCT REINFORCED MASONRY WALLS IN ACCORDANCE WITH ACI 531, BUILDING CODE

REQUIREMENTS FOR CONCRETE MASONRY STRUCTURES. USE CONCRETE MASONRY UNITS CONFORMING TO ASTM C90 GRADE N WITH MINIMUM

COMPRESSIVE PRISM STRENGTH OF (1,500 PSI - AVG OF 3 UNITS). TYPE M MORTAR SHALL CONFORM TO ASTM C270. USE 3/8" FULL BEDDED JOINTS. (REMOVE PROTRUDING MORTAR FROM CELL CAVITIES THAT ARE TO BE REINFORCED AND

USE 3000 PSI PUMP MIX, WITH MAX 3/8" AGGREGATE FOR GROUTING.

USE HEAVY DUTY TRUSS-TYPE (OR LADDER-TYPE) REINFORCING IN EVERY-OTHER COURSE (HORIZONTAL) USE PREFABRICATED CORNERS \$ LAP MIN JOINTS MIN OF 12" IN ACCORDANCE WITH ASTM A 182. USE GROUTED CELLS WITH A #5 VERTICAL BAR AS SHOWN ON DRAWINGS (AT A MINIMUM OF

EVERY CORNER, EACH SIDE OF DOOR \$ WINDOW OPENINGS, ALL WALL ENDS, AND NOT MORE THAN 48" O/C IN WALL RUNS) PROVIDE CLEAN-OUT OPENINGS FOR EACH GROUTED CELL.

PROVIDE POURED IN-PLACE (CONCRETE) LINTELS OR HEADERS OVER ALL MASONRY OPENINGS. REINFORCING SPLICES IN STRUCTURAL LINTELS TO BE 48 BAR DIAMETERS.

MECHANICAL FASTENERS:

EXPANSION ANCHORS: "WEDGE-ALL" BY SIMPSON OR "POWER-BOLT" BY RAWL ADHESIVE ANCHORS: "EPOSY TIE" BY SIMPSON OR "POWER-FAST" BY RAWL MASONRY SCREWS: "TITEN" BY SIMPSON OR "TAPPER" BY RAWL POWDER ACTUATED FASTENERS: "POWDER ACTUATED FASTENERS" BY SIMPSON OR "PINS"

ALL FASTENERS SHALL BE INSTALLED AS SPECIFIED BY THE MANUFACTURER.

I . CUSTOM FABRICATE STEEL COLUMNS, PLATES, AND BEAMS FROM THE FOLLOWING STEEL GUIDES:

Federal Specifications: FF-B-56IC - Bolts, (Screw), Lag FF-B-588C (1) - Bolt, Toggle; and Expansion Sleeve, Screw

FF-S-92B (1) - Screw, Machine; Slotted, Cross-recessed or Hexagonal Head ASTM Intenational: ASTM A53 / A53M Standard Specification for Pipe, Steel, Black and Hot-Dipped, Zinc-Coated, Welded and Seamless


ASTM A I 08 Standard Specification for Steel Bar, Carbon and Alloy, Cold-Finished Standard Specification for Carbon Steel Bolts and Studs, 60 000 PSI Tensile Strer ASTM A325 Standard Specification for Structural Bolts, Steel, Heat Treated, 120/105 ksi Minim ASTM A500 / A500M Standard Specification for Cold-Formed Welded and Seamless Carbon Stee

tructural Tubing in Rounds and Shapes ASTM A992 / A992M Standard Specification for Structural Steel Shapes



STEVE SIEBERT **ARCHITECTURE** 466 N. FEDERAL HIGHWAY

BOYNTON BEACH, FL 33435 PH. 561.880.7894 Steve@stevesiebert.com www.stevesiebert.com

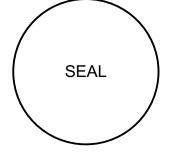

STEVEN W. SIEBERT

FLORIDA AR0017834 NEW JERSEY 21AI01517500 26934

TEXAS

CONSTRUCTION DRAWINGS

THE WRITTEN DIMENSIONS ON THESE DRAWINGS SHALL TAKE PRECEDENCE OVER SCALED DIMENSIONS.

THE CONTRACTOR SHALL VERIFY AND BE RESPONSIBLE FOR ALL DIMENSIONS AND CONDITIONS ON THE JOB, AND THIS OFFICE MUST BE NOTIFIED OF ANY VARIATION FROM THE DIMENSIONS. COPYRIGHT STEVE SIEBERT ARCHITECTURE-UNAUTHORIZED ANY REPRODUCTION OR OTHER USE OF

THIS DRAWING IS PROHIBITED. PROJECT NO: 20-260

5.26.20 DRAWN BY:

CHECKED BY:_ REVISIONS: CLIENT CHGS 1.7.21

FOUNDATION PLAN

SIMPSON - STRONGTIE - STRAP SCHEDULE **FASTENERS** UPLIFT 1450 (7) 10dx 1 1/2 (14) 16d 2120 (14) 10d 1125

TRUSS CONNECTION DETAIL (TYP.) 5/8" CDX PLYWOOD ON PRE-ENGINEERED WOOD -TRUSSES (24" O/C TYP.) POURED IN PLACE TIE DOWN STRAP (SEE STRUCT. DWG'S) 2x FASCIA W/ (2) 16d @ EA.TRUSS BOND BEAM OR POURED TIE-BEAM (SEE STRUCT DWG'S) TOP CHORD BEARING

BEAM SC	CHEDL	JLE			
SYMBOL	W	D	TYPE	STEEL	NOTES
ВВ-1	8"	12"	POURED	(2) #5 REBAR T \$ B \$ #3 STR. @ 10" OC	
L-I	8"	8"	LINTEL	(I) #5 REBAR	PRECAST SOLID LINTEL OVER GROUT FILLED CMU WALL
ВМ-1	4"	12"	LAM/WD		PARALAM. BEAM

TYPICAL ROOF FRAMING NOTES:

I. THE ROOF STRUCTURE SHALL BE SHEETED WITH 5/8" CDX PLYWOOD ON PRE-ENGINEERED WOOD TRUSSES AT 24" O/C, ATTACH WITH COATED-10d NAILS AT 6" O/C (IN-FIELD) AND AT 4" O/C AT EDGES.

2. ROOF LOAD: SOL=25 PSF/LL=30

3. COORDINATE THIS DIAGRAMMATIC DRAWING WITH THE ARCHITECTURAL DRAWINGS FOR ALL DIMENSIONS, SLOPE, PROFILE, ETC ... 4. PROVIDE PERMANENT BRACING OF TRUSSES IN ACCORDANCE WITH THE REQUIREMENTS OF "BRACING WOOD TRUSSES COMMENTARY AND RECOMMENDATIONS" PREPARED BY "TRUSS PLATE INSTITUTE, INC." 5. UPLIFT-# DESIGNATES TYPICAL UPLIFT FORCE IN KIPS (I KIP= 1000LBS), SEE TYPICAL UPLIFT TIE-DOWN SCHEDULE FOR APPROPRIATE TIE DOWN AND FASTENERS DESIGNATED. 6. PROVIDE PRE-CAST LINTEL OR DROP DOWN BEAM AT ALL OPENINGS WHERE A BEAM IS NOT DESIGNATED. (SEE DETAIL THIS SHEET) 7. BOTTOM CHORD OF TRUSS (CEILING) SHALL BE SHEETED WITH 5/8" GYPSUM WALL BOARD FOR ADDITIONAL TRUSS SUPPORT UNLESS OTHERWISE DESIGNATED ON ARCHITECTURAL DRAWINGS.

REQ'D)

OPENINGS)

SCREWS

SINGLE BOTTOM PLATE

ZONE 4 +40.4/ -43.8 PSF

ZONE 5 +37.7/-62.9 PSF

2x CRIPPLES

DOUBLE TOP

@ 16" OC

PLATE



STEVE SIEBERT **ARCHITECTURE** 466 N. FEDERAL HIGHWAY

BOYNTON BEACH, FL 33435 PH. 561.880.7894 Steve@stevesiebert.com www.stevesiebert.com

SEAL STEVEN W. SIEBERT

26934

FLORIDA AR0017834 NEW JERSEY 21AI01517500 TEXAS

Z 120 NW BEACH,

CONSTRUCTION DRAWINGS

DELRAY


THE WRITTEN DIMENSIONS ON THESE DRAWINGS SHALL TAKE PRECEDENCE OVER SCALED THE CONTRACTOR SHALL VERIFY AND BE RESPONSIBLE FOR ALL DIMENSIONS AND CONDITIONS ON THE JOB, AND THIS OFFICE MUST BE NOTIFIED OF ANY VARIATION FROM THE DIMENSIONS. COPYRIGHT STEVE SIEBERT ARCHITECTURE-UNAUTHORIZED ANY REPRODUCTION OR OTHER USE OF


THIS DRAWING IS PROHIBITED. PROJECT NO: 20-260


11.03.20 DRAWN BY:


CHECKED BY:___ REVISIONS: CLIENT CHGS 1.7.21


> **ROOF FRAMING & DETAILS**

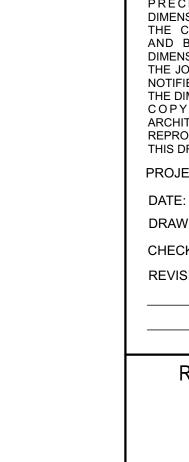

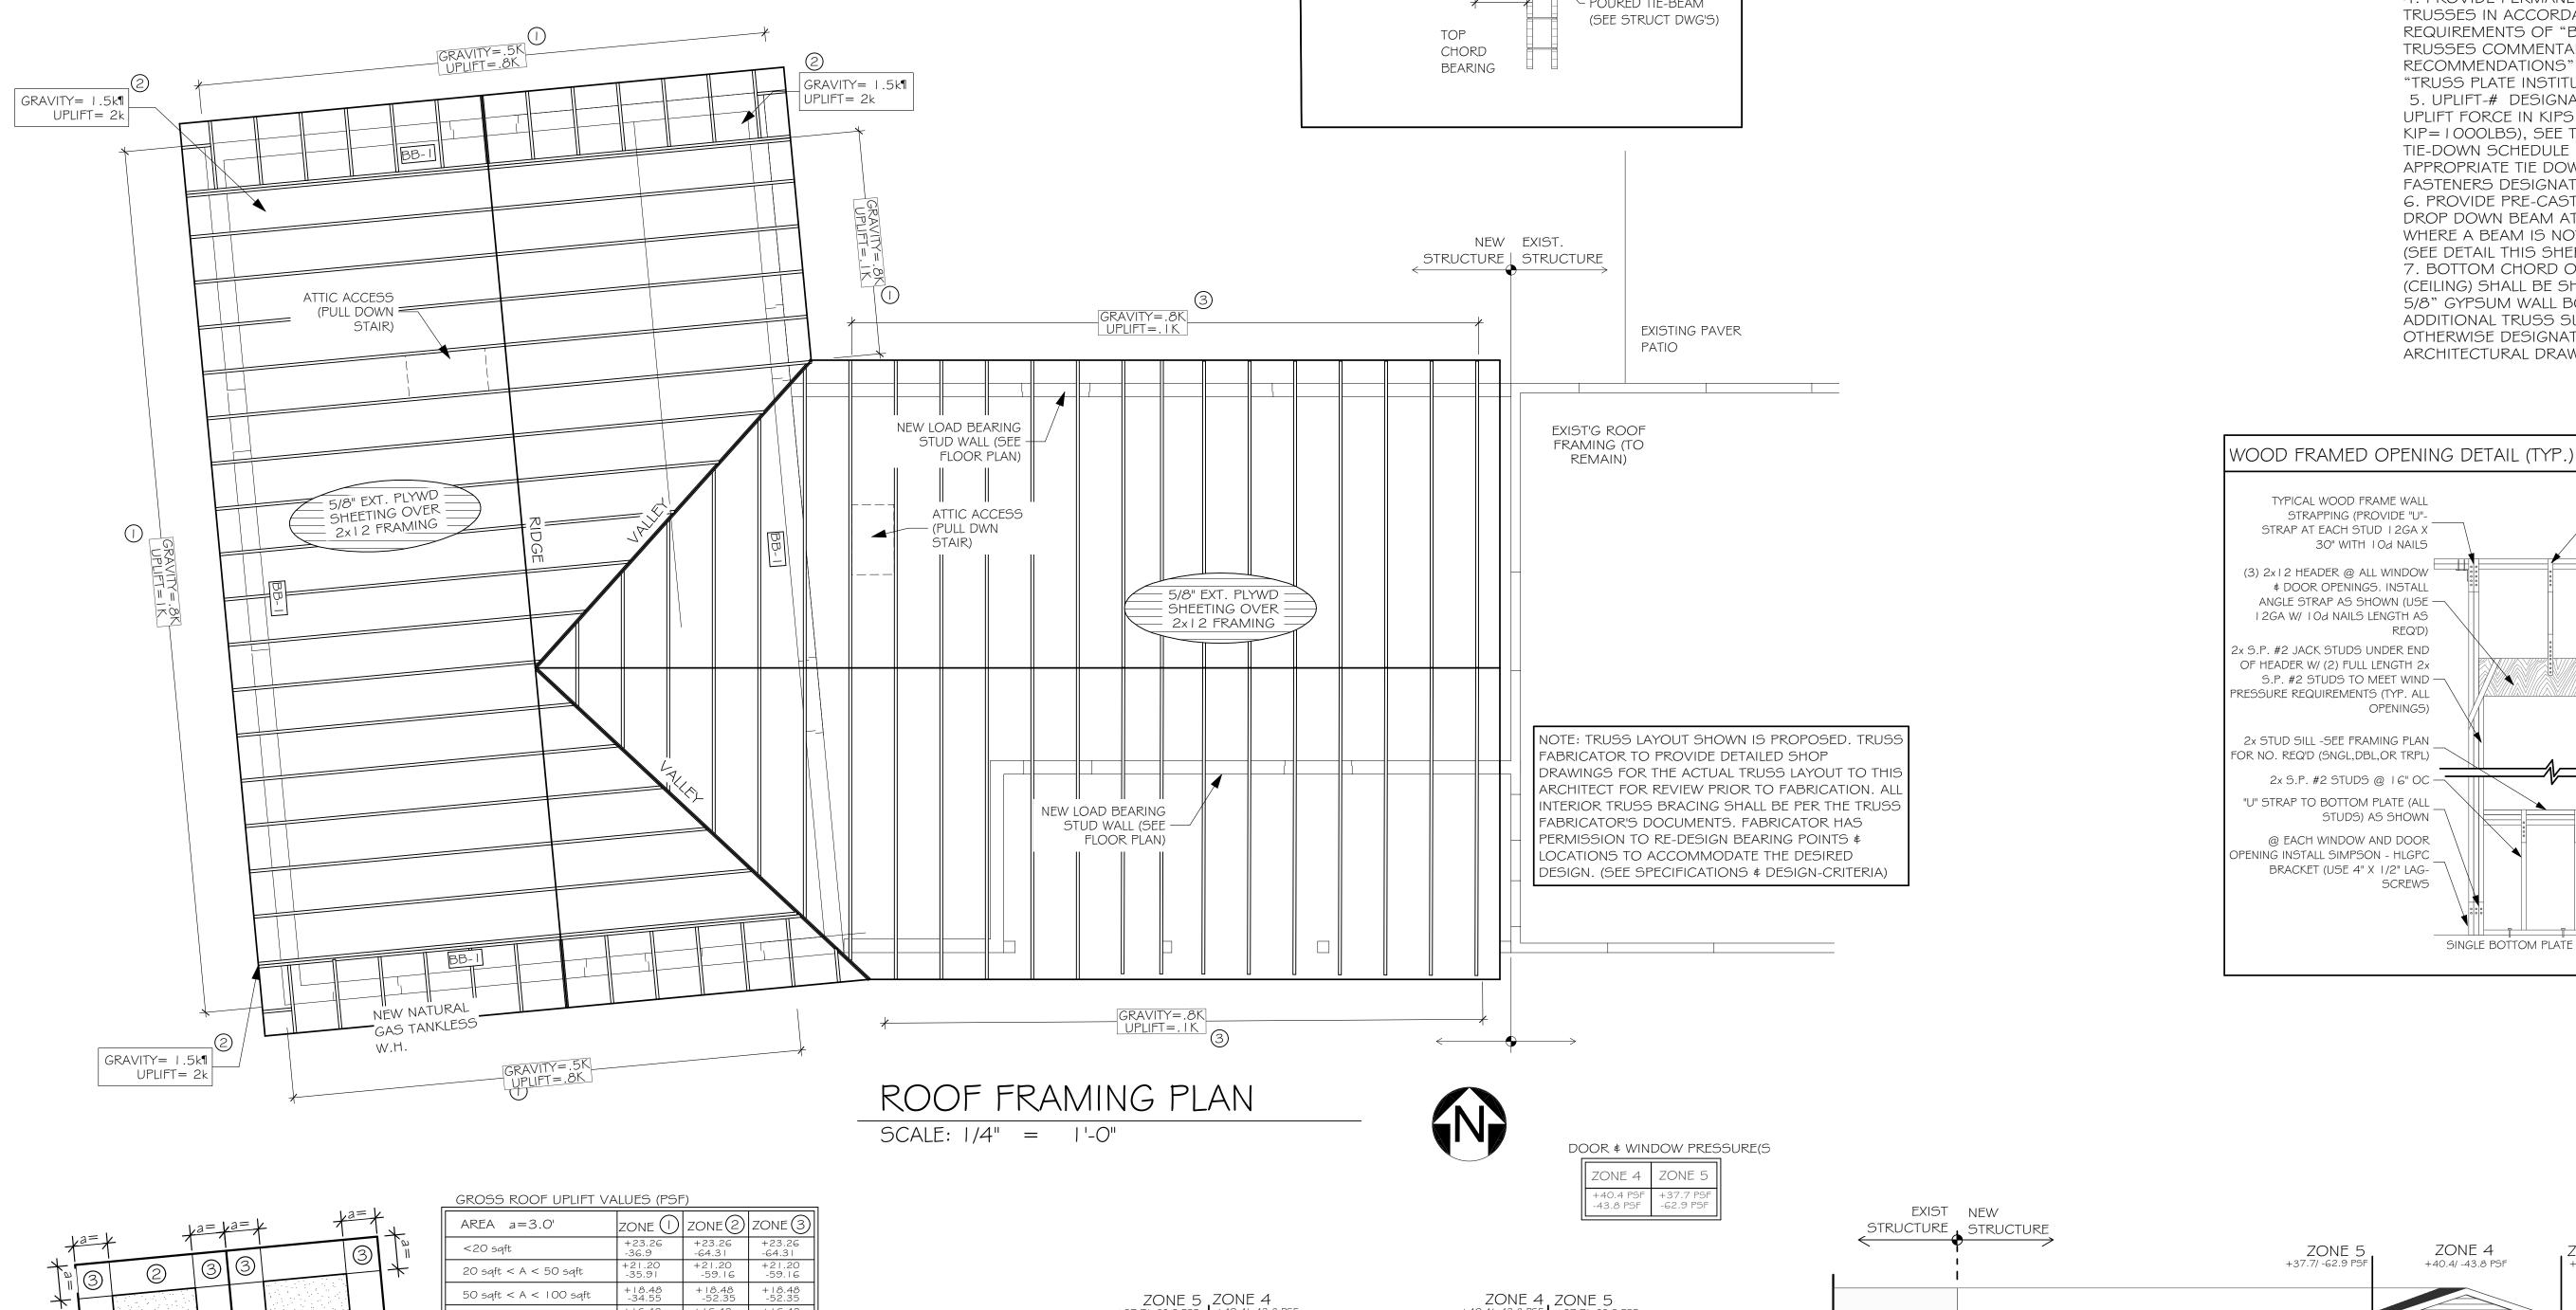

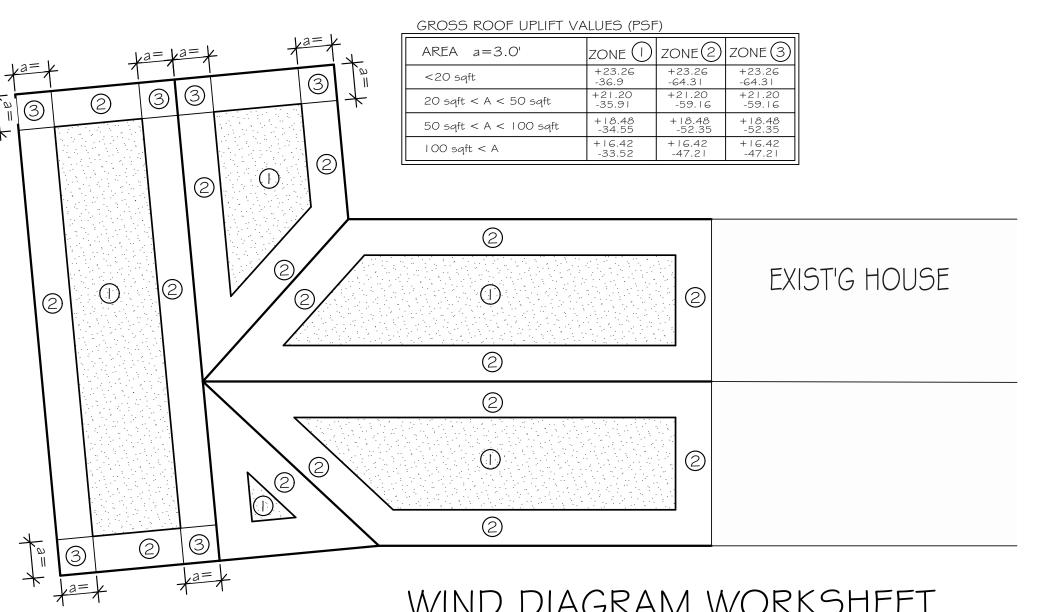

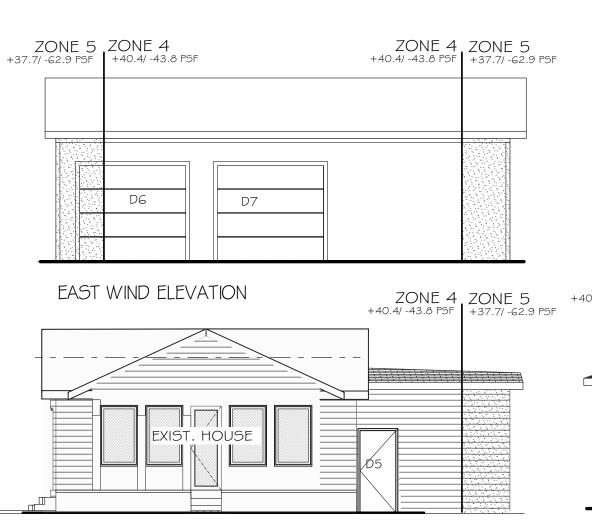

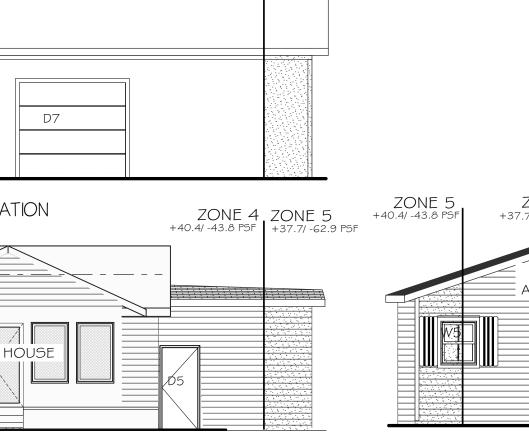

NORTH WIND ELEVATION ZONE 4 +37.7/ -62.9 PSF ZONE 4 ZONE 5 +40.4/ -43.8 PSF | +37.7/ -62.9 PSF ZONE 5 +40.4/-43.8 PSF EXIST. HOUSE ADDITION


NEW


ADDITION

WIND DIAGRAM WORKSHEET SCALE: 1/8" = 1'-0"

WEST WIND ELEVATION

SOUTH WIND ELEVATION

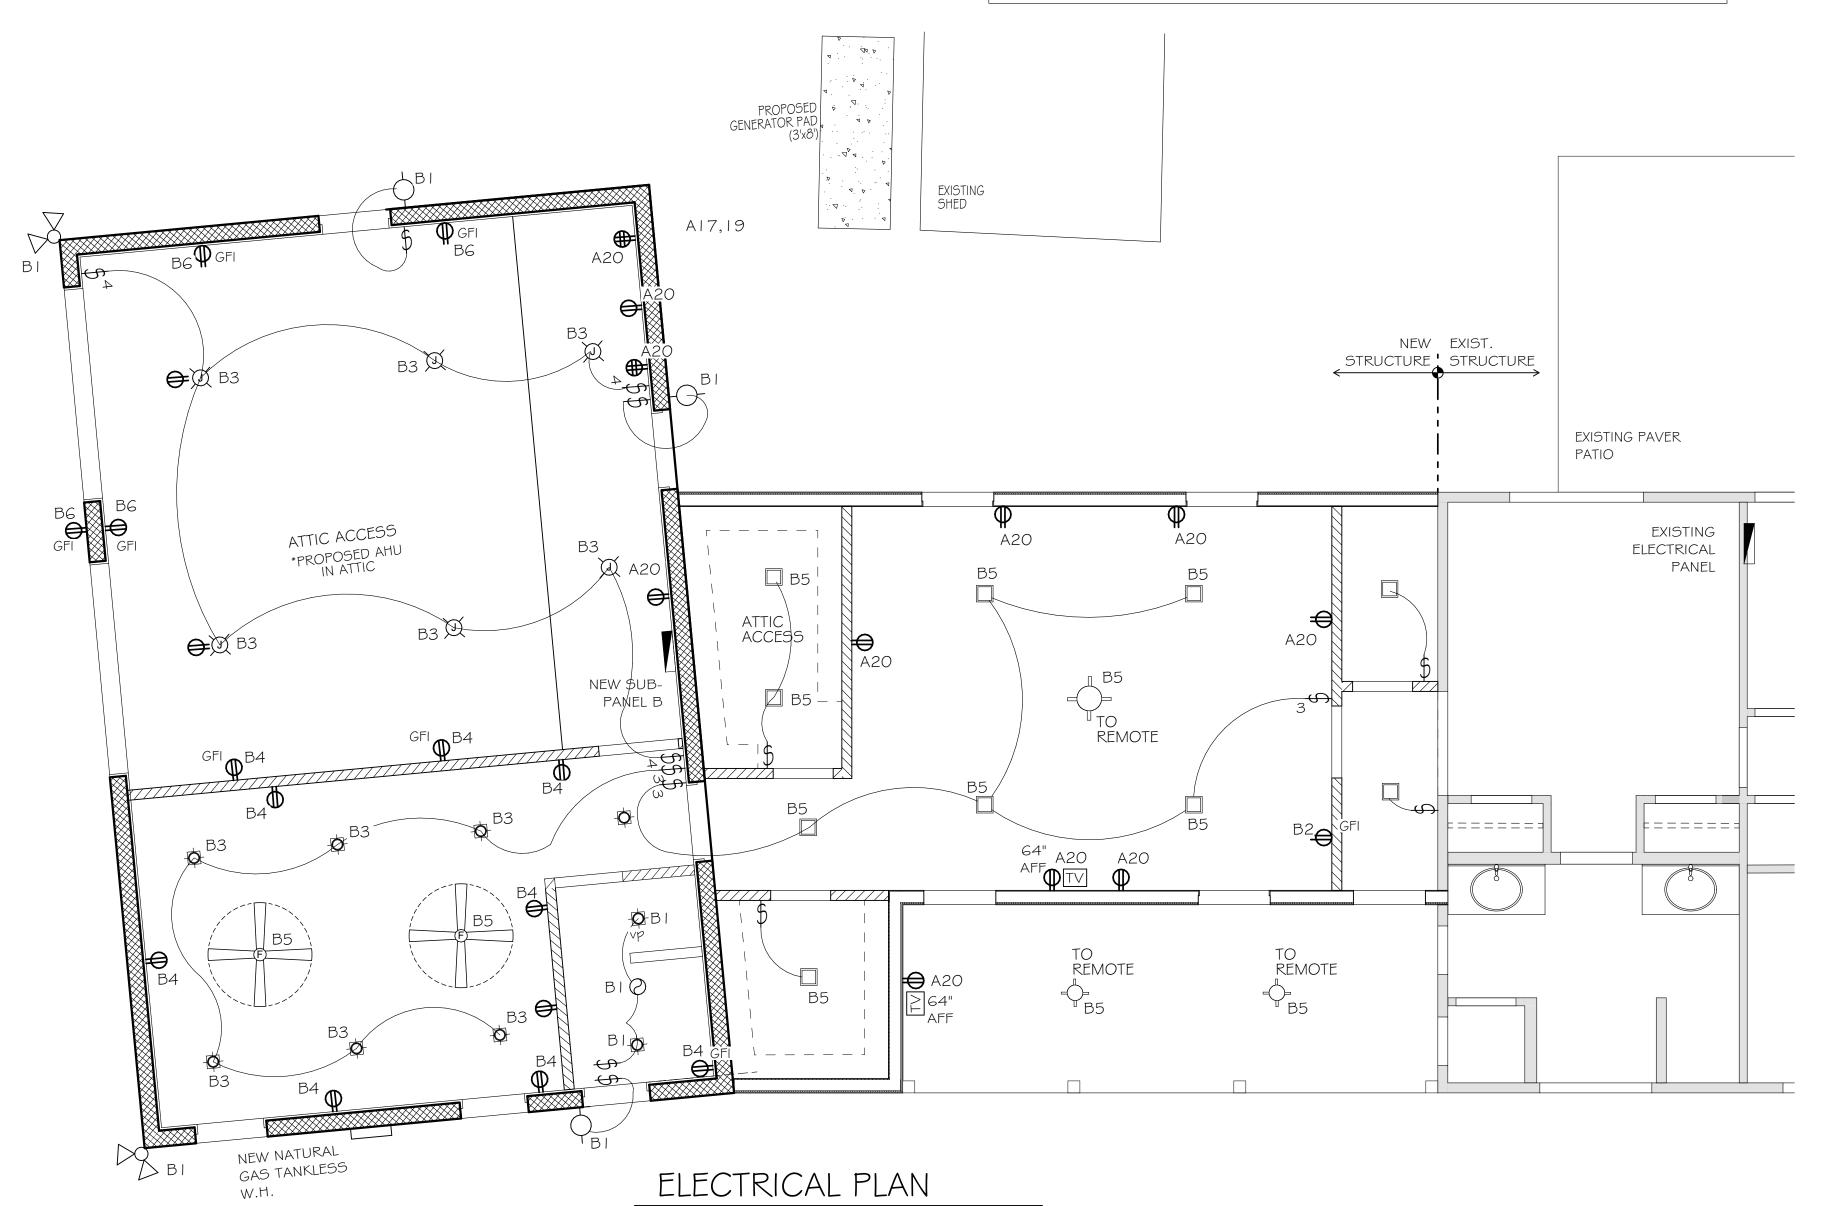

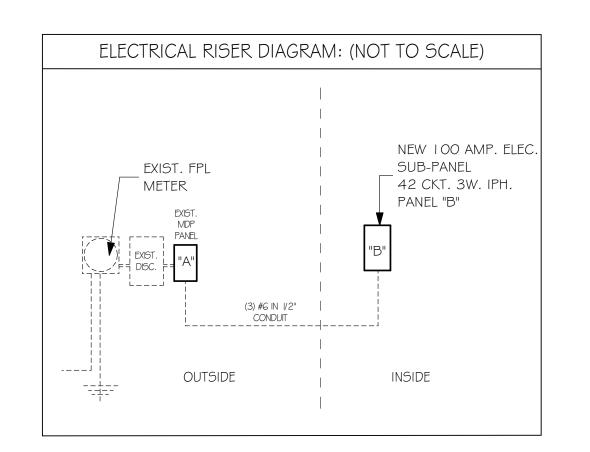

SCALE: 1/4" = 1'-0"

NEV	V PANEL (SEE PLANS FOR LOCATION)			1	00A SL	JB-	PANEL E	3			100 A 120/240 V	/
	CIRCIUT DESCRIPTION	СВ	W I R E	G R N D	EST. LOAD WATTS		EST. LOAD WATTS	G R N D	W I R E	СВ	CIRCIUT DESCRIPTION	
1	GARAGE LIGHTING	20	12		1,500		2,000		12	20	GARAGE BATH GFCI RECEPTACLES	2
3	GARAGE LIGHTING	20	12		1,500		2,000		12	20	GARAGE GFCI RECEPTACLES	4
5	GARAGE GFCI RECEPTACLES	20	12		2,000		2,000		12	20	POOL HEATER	6
7	SPARE										SPARE	8
9	SPARE										SPARE	10
11	SPARE										SPARE	12
<u> </u>	OTAL GENERAL LOAD:		ı	11,0	5,000 00		6,000					
	FIRST 10,000 @ 100% = REST. @ 40% (1,000)=	=		-	000 400							
-	TOTAL LOAD:		=	11,4	00							

GENERAL ELECTRICAL NOTES:

- I. ALL WORK SHALL BE DONE IN ACCORDANCE WITH THE NATIONAL ELECTRIC CODE (NEC 2014), FBC
- 2017, NFPA-101 2015, \$ NFPA-1 2015. 2. ALL MATERIAL SHALL BE NEW AND SHALL BEAR THE U.L LABEL WHERE APPLICABLE (OR COMPARABLE
- AGENCY APPROVAL)
- ALL WORK SHALL BE PERFORMED BY A LICENSED ELECTRICAL CONTRACTOR IN A FIRST CLASS WORKMANLIKE MANOR. THE COMPLETED SYSTEM SHALL BE FULLY OPERATIVE AND ACCEPTED BY
- THE GENERAL CONTRACTOR, ENGINEER, AND OWNER. CONTRACTOR MUST VISIT THE SITE PRIOR TO BID OR CONSTRUCTION TO VERIFY ALL EXISTING
- IT IS NOT THE INTENT OF THESE PLANS TO SHOW EVERY MINOR DETAIL OF CONSTRUCTION. THE CONTRACTOR IS EXPECTED TO FURNISH AND INSTALL ALL ITEMS FOR A COMPLETE ELECTRICAL SYSTEM ND PROVIDE ALL REQUIREMENTS NECESSARY FOR EQUIPMENT TO BE PLACED IN PROPER
- THE E.C. SHALL MAKE ALL NECESSARY CUTTING AND ALL NECESSARY PATCHING AS NECESSARY
- FOR THE PROPER EXECUTION OF THIS WORK. AFTER COMPLETION OF THE ELECTRICAL WORK, THE SYSTEM SHALL BE FREE FROM SHORT
- CIRCUITS AND GROUNDS. WHERE ELECTRICAL CONDUCTORS ARE INSTALLED IN CONDUIT, THE CONDUIT SHALL COMPLY WITH
- THE N.E.C. REQUIREMENTS. ALL CONDUCTORS SHALL BE COPPER. NO CONDUCTOR SHALL SMALLER THAN #12 AWG AND SHALL BE RATED FOR 600 VOLTS THWN OR THHN INSULATION. INSTALL A GROUNDING CONDUCTOR WITH ALL CIRCUITS, UNLESS OTHERWISE NOTED, SIZED PER N.E.C. 250-122
- 10. VERIFY BREAKER AND CORRESPONDING WIRE SIZES FOR ALL ELECTRICAL EQUIPMENT. DO NOT ORDER MATERIAL BEFORE VERIFYING BREAKER AND WIRE SIZE. REPORT ANY DISCREPANCY
- IMMEDIATELY TO THE ENGINEER OF RECORD. II. VERIFY AVAILABLE INTERRUPTING CURRENT (AIC) WITH POWER COMPANY. EQUIPMENT AIC RATING
- MUST BE LARGER THAN THE POWER COMPANY AIC.
- 12. SAFETY SWITCHES SHALL BE SQUARE 'D', GENERAL ELECTRIC, OR WESTINGHOUSE, FUSED OR NON-FUSED AND SIZED AS INDICATED, NEMA 3R WHEN EXPOSED TO WEATHER.
- 13. PANELS SHALL BE SQUARE 'D', GENERAL ELECTRIC, OR EQUAL, TYPE AND NUMBER OF BREAKERS AS INDICATED ON THE PANEL SCHEDULE, STENCIL PANEL DESIGNATION ON THE INSIDE OF THE PANEL. ALL TWO-POLE BREAKERS SHALL BE COMMON TRIP. PROVIDE TYPE WRITTEN SCHEDULE IN EACH LOAD CENTER. CONNECTION OT MAIN BUS SHALL BE WITH BURNDY ANNULAR COMPRESSION
- 14. ALL EXTERIOR ELECTRICAL EQUIPMENT SHALL BE ANCHORED TO COMPLY WITH LOCAL WIND
- RESISTANCE ALL ELECTRICAL AND COMMUNICATION OUTLETS TO BE 15" AFF TO BOTTOM OF OUTLETS UNLESS
- OTHERWISE NOTED. ALL LIGHTING SWITCHES SHALL BE 42" AFF TO BOTTOM OF SWITCH. 16. SERVICE TO BE 3' ABOVE MSL, VERIFY AT THE SITE.
- 17. ELECTRICAL LAYOUT IS DIAGRAMMATIC. ELECTRICAL CONTRACTOR TO FOLLOW ALL NEC 2017 CODES AND LOCAL REQUIREMENTS AND VERIY ALL EXISTING CIRCUITS AND CONDITIONS DURING INSTALLATION. PROVIDE FINAL RISER, PANEL SCHEDULE AND CALCULATIONS AS RE'D.
- 18. ALL LIGHT FIXTURES TO BE CENTERED TO ROOM UNLESS OTHER WISE NOTED. 19. ELECTRICAL CIRCUITS IN KITCHEN TO BE ADJUSTED AS NECESSARY PER FINAL KITCHEN LAYOUT
- CONTRACTOR TO VERIFY WITH EQUIPMENT AND PROVIDE APPROPRIATE NEMA PLUG FOR DEDICATED CIRCUITS.
- 21. ALL OULETS TO SWITCHES, ONLY TOP OUTLET TO BE SWITCHED, BOTT. TO REMAIN POWERED AT
- 22. ALL LOW-VOLTAGE TO BE COORDINATED BY OWNER.

ELECTRICAL NOTES:


- I. INSTALL NEW DUPLEX OUTLETS AS INDICATED ON THE PLANS. ALL OUTLETS ON EXISTING CIRCUITS. ALL BATHROOM RECEPTACLES SHALL BE GFCI PROTECTED.
- ALL RECEPTACLES ON COUNTERTOPS ARE EXISTING \$ SHALL BE GFCI PROTECTED.
- ANY MODIFIED, EXTENDED, OR REPLACED BRANCH CIRCUITS SHALL BE ARC FAULT PROTECTED EITHER BY A COMBINATION TYPE AFCI OR BRANCH CIRCUIT TYPE AFCI LOCATED AT THE FIRST
- RECEPTACLE PER NEC 210.12 (B) INSTALL NEW DUPLEX OUTLET FOR RELOCATED REFRIGERATOR AND CONNECT TO EXISTING REFRIGERATOR CIRCUIT AS INDICATED ON THE PLANS.
- EXISTING ELECTRICAL PANEL TO BE REPLACED IN SAME LOCATION WITH SIEMENS "#P3040B | 200 (OR APPROVED EQUAL).
- ALL EXISTING ELECTRICAL CIRCUITS TO BE REMAIN.

EXIS	STING PANEL		W	G	EXISTING		150 A 20/240 \				
	CIRCIUT DESCRIPTION	СВ	V R E	R N D	EST. LOAD WATTS	EST. LOAD WATTS	G R N D	W I R E	СВ	CIRCIUT DESCRIPTION	
	SA	20	12		1,500	1,500		12	20	WASHER	
, <u> </u>	SPACE					1,500		12	20	BEDROOM LIGHTS	7
2	SPACE					3,000		12	20	COMPRESSOR	4
3 -	SPACE					3,000		12	25	COIVII REJJOR	
5 -	SPACE					11.400			100	SUB-PANEL B	6
5	DISHWASHER	20	12		1,800	11,400		6	100	JUD-I ANLL D	
7	DISPOSAL	20	12		1,500	2,000		10	30	BATH GFIS	8
,	MICROWAVE	20	12		1,500	2,000		12	20	DATTI GITO	
9	EXT. GFCI'S	15	14		2,000	2,000		12	20	DINING	
	SA	20	12		1,500	2,000		12	20	DIMING	
	FRIDGE	20	12		1,500	2,000		14	15	LIVING	12
1 1	AQ. PANEL	15	14		1,500	2,000		14	1.0	LIVING	
13	AIR	60	10		4,500	2,000		14	15	FAMILY	1.
15	HANDLER	60	10		2,000	2,000		14	15	OUTSIDE WALL PAK MASTER OUTSIDE LIGHTS	- 1 (
17			-		2 000	2,000		14	15	BEDS 2 \$ 3	1.
19	GARAGE AC	50	10		3,000	2,000		12	20	M. BED. RECEPT.	20
	TOTAL GENERAL LOAD FIRST 10,000 @ 100 AIR CONDITION @ 10 REST. @ 40% (30,80)% =)0%=			22,300 53,300 10,000 12,500 12,320	31,000	l	l			<u>I</u>
	TOTAL LOAD:			=	=34,820						



STEVE SIEBERT ARCHITECTURE

466 N. FEDERAL HIGHWAY BOYNTON BEACH, FL 33435 PH. 561.880.7894 Steve@stevesiebert.com www.stevesiebert.com

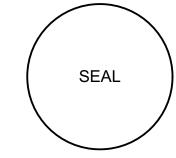

STEVEN W. SIEBERT

FLORIDA AR0017834

NEW JERSEY 21AI01517500 26934

TEXAS

CONSTRUCTION DRAWINGS

THE WRITTEN DIMENSIONS ON THESE DRAWINGS SHALL TAKE PRECEDENCE OVER SCALED DIMENSIONS. THE CONTRACTOR SHALL VERIFY AND BE RESPONSIBLE FOR ALL DIMENSIONS AND CONDITIONS ON THE JOB, AND THIS OFFICE MUST BE NOTIFIED OF ANY VARIATION FROM THE DIMENSIONS. COPYRIGHT STEVE SIEBERT ARCHITECTURE-UNAUTHORIZED ANY


THIS DRAWING IS PROHIBITED. PROJECT NO: 20-260

REPRODUCTION OR OTHER USE OF

11.03.20 DRAWN BY: CHECKED BY: SWS

REVISIONS: CLIENT CHGS 1.7.21

ELECTRICAL PLAN

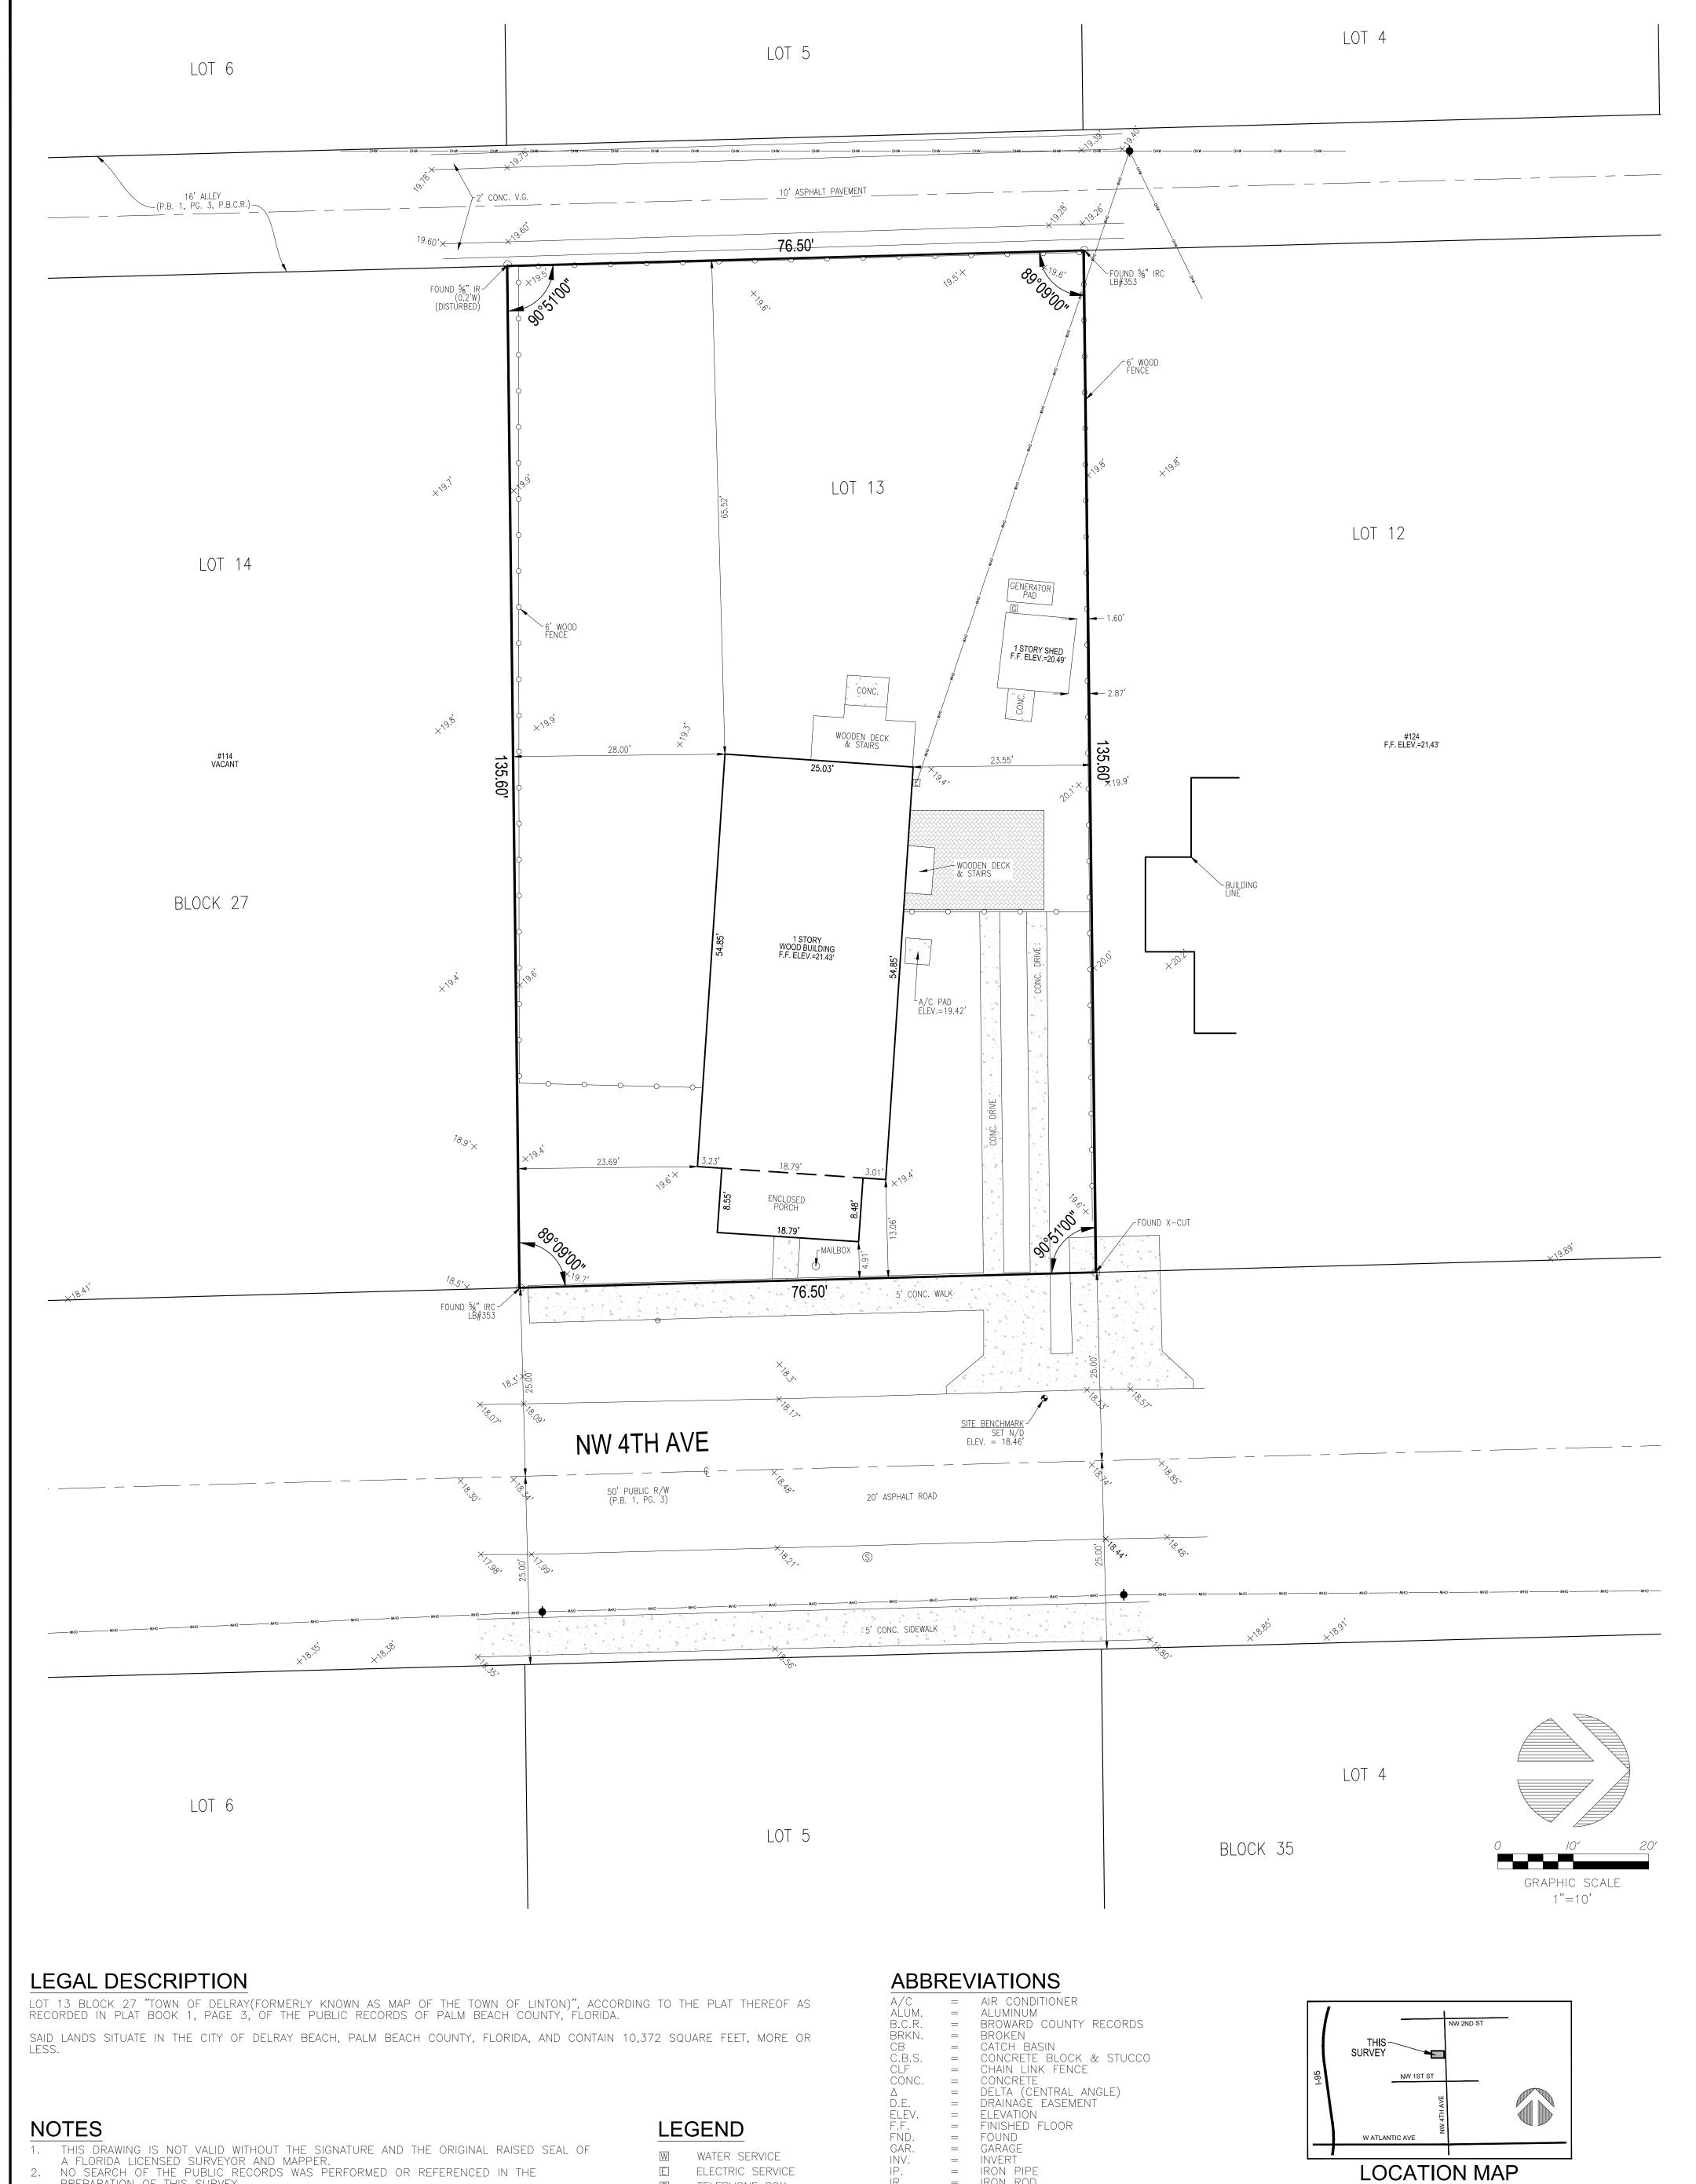

- PREPARATION OF THIS SURVEY. ALL EASEMENTS SHOWN HEREON ARE PER THE RECORD PLAT(S) UNLESS OTHERWISE
- THERE HAVE BEEN NO UNDERGROUND IMPROVEMENTS LOCATED IN CONNECTION WITH THIS
- SURVEY, EXCEPT AS SHOWN. ELEVATIONS SHOWN HEREON ARE RELATIVE TO THE NORTH AMERICAN VERTICAL DATUM OF

N/A

- 1988 AND WERE DETERMINED FROM PALM BEACH COUNTY BENCHMARK "14.264(SRD)" ELEVATION = 12.752'.

 PROPERTY ADDRESS: 120 NW 4TH AVE, DELRAY BEACH, FL 33444

 FLOOD INFORMATION IS AS FOLLOWS:
- COMMUNITY NUMBER 0979F PANEL NUMBER DATE OF FIRM INDEX ZONE 10-05-2017

BASE FLOOD ELEVATION

- T TELEPHONE BOX C CABLE TV BOX DRAINAGE MANHOLE (\$)
- \bowtie _0_ SIGN FIRE HYDRANT CATCH BASIN

WATER VALVE

SANITARY MANHOLE

- Ø LIGHT POLE WOOD UTILITY POLE CONCRETE UTILITY POLE CLEAN OUT CENTERLINE ×0.00' EXISTING ELEVATION
- IRON ROD IRC IRON ROD & CAP ARC LENGTH LAKE MAINTENANCE EASEMENT MONUMENT MON. N/D NAIL AND DISC
- P.B.C.R. PLAT BOOK PALM BEACH COUNTY RECORDS = PG. PROP. PAGE PROPOSED RADIUS RIGHT-OF-WAY = SQ. STY. SQUARE =

UTILITY EASEMENT

STORY TYPICAL

=


TYP.

NOT TO SCALE

SURVEYOR'S CERTIFICATION

I HEREBY CERTIFY THAT THE SURVEY SHOWN HEREON COMPLIES WITH STANDARDS OF PRACTICE AS CONTAINED IN CHAPTER 5J-17.051, FLORIDA ADMINISTRATIVE CODE, PURSUANT TO SECTION 472.027, FLORIDA STATUTES, AND THAT SAID SURVEY IS TRUE AND CORRECT TO THE BEST OF MY KNOWLEDGE AND BELIEF AS PREPARED UNDER MY DIRECTION.

JEFF S. HODAPP SURVEYOR AND MAPPER FLORIDA LICENSE NO. LS5111 DATE OF LAST FIELD WORK: OCTOBER 9, 2020

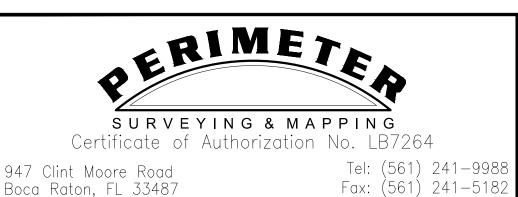

BOUNDARY & TOPOGRAPHIC SURVEY
LOT 13 BLOCK 27 - TOWN OF LINTON

NO.	DATE	BY	CK'D	REVISION	
1	12/26/2019	AJR	JSH	BOUNDARY & TOPOGRAPHIC SURVEY	
2	10/09/2020	AJR	JSH	BOUNDARY & TOPOGRAPHIC SURVEY UPDATE	
					SEAL

JOB NO.	10202
SCALE	1" = 10'
DRAWN	AJR
CHECKED	JSH
SHEET	1 of 1