

#### Development Services Department

#### **BOARD ACTION REPORT - APPEALABLE ITEM**

Project Name: The George

**Project Location:** 655 George Bush Blvd **Request:** Class V Site Plan Modification

**Board:** Site Plan Review and Appearance Board

Meeting Date: January 13, 2021 Board Vote: Approved on a 5-2 vote

#### **Board Action:**

Approved (5 to 2), the Class V (2020-183) Site Plan, Landscape Plan, and Architectural Elevations for The George located at 655 George Bush Boulevard as amended, by finding that the request is consistent with the Comprehensive Plan and meets criteria set forth in the Land Development Regulations.

#### **Project Description:**

The subject site is a 0.32-acre property with Palm Beach County parcel control number 12-43-46-09-16-002-0100, located at 655 George Bush Blvd. The subject site is zoned General Commercial (GC). The request before the Site Plan Review and Board (SPRAB) was for a Class V Site Plan (2020-183), Landscape Plan, and Architectural Elevations associated with the construction of an 18,387 gross square foot, four-story mixed-use residential/office building.

#### **Board Comments:**

Comments from the board members included concerns about the small size of interior landscape islands, the architectural appearance, environmental issues, roof, building separation, and access to the neighboring building on the east (Sail Inn 657 George Bush Blvd).

#### **Public Comments:**

A letter was provided to the board by Carney Stanton PL, an attorney on behalf of the owner of The Sail Inn, with several comments regarding the project (see attached). The comments included concerns about the proposed project's impact on their property regarding environmental issues, construction, access, and a request for an easement along the west property line from the applicant to facilitate maintenance.

#### **Associated Actions:**

Prior to the board making the final motion on the item, the agent of the applicant (Richard Jones Architecture) requested that the board provide a brief recess so they can contact their client regarding the easement request from the neighboring property. The board motioned and provided a 10-minute recess. Once the meeting reconvened, the agent stated that they spoke with their client and they would be willing to work with their neighbor to provide the easement.

#### **Next Action:**

The SPRAB action is final unless appealed by the City Commission.














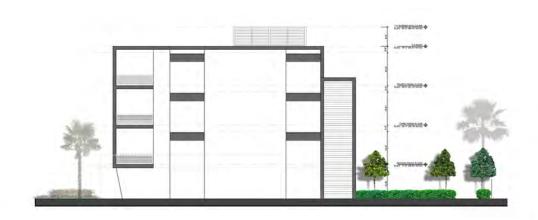













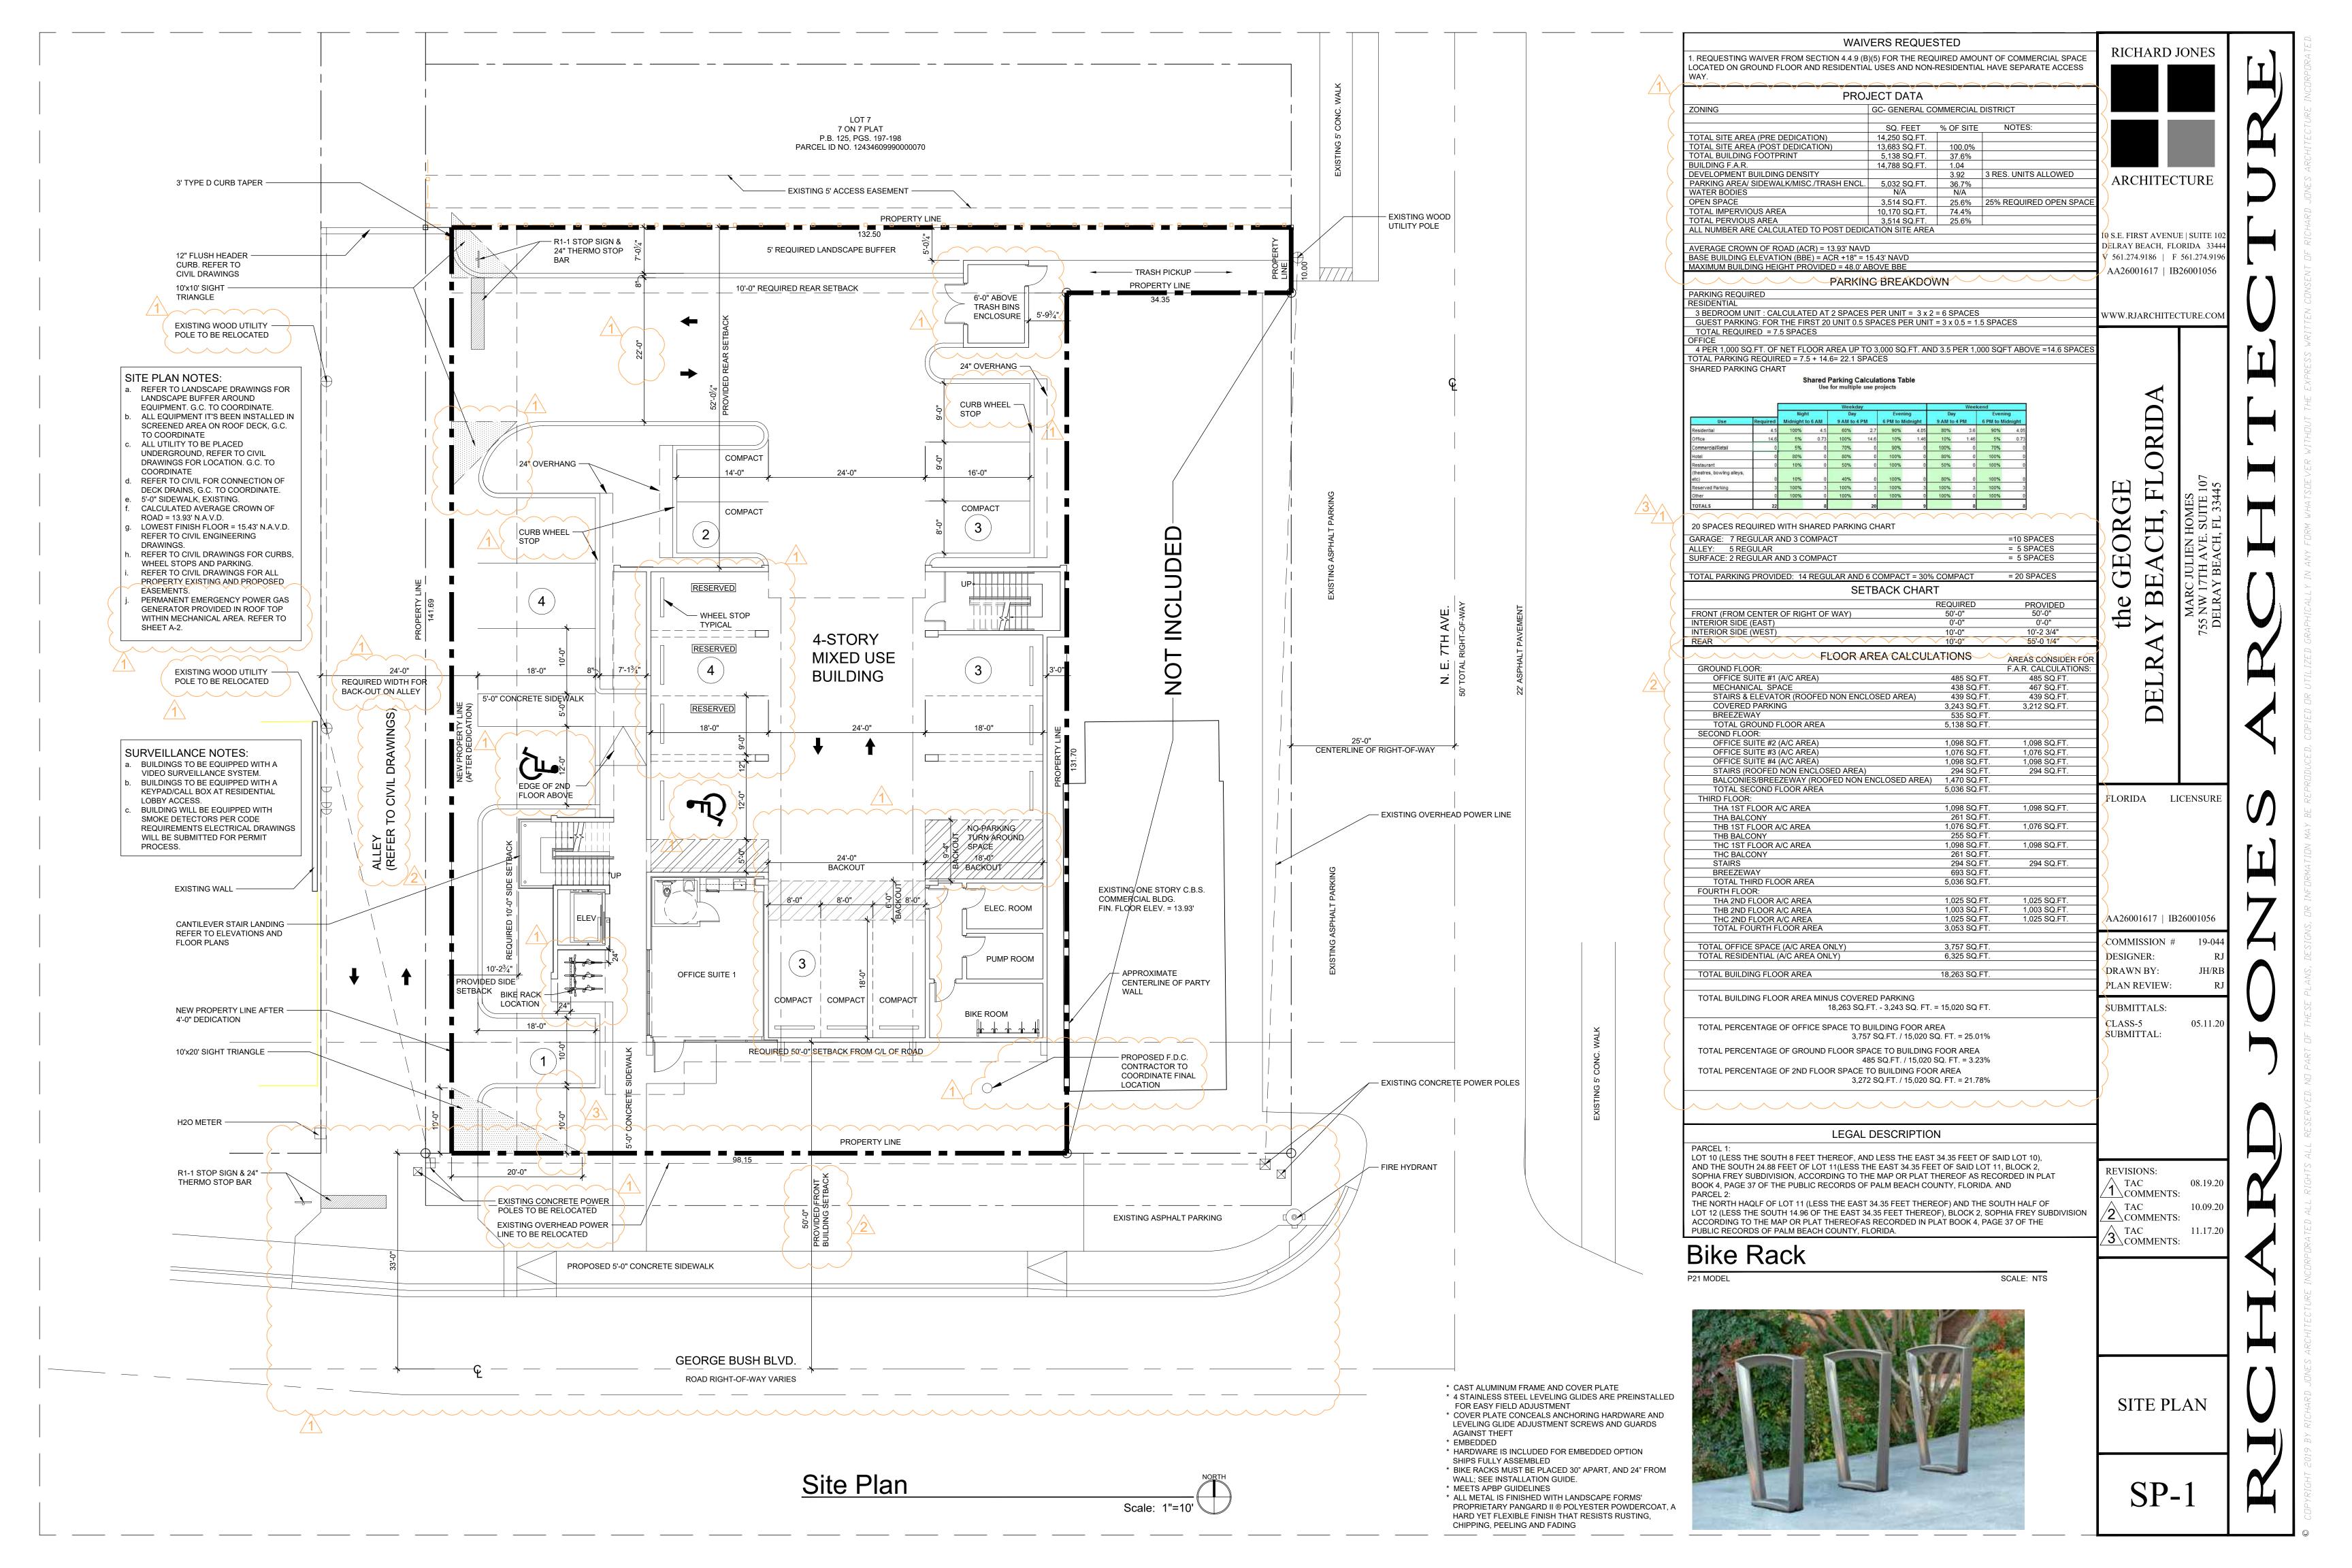

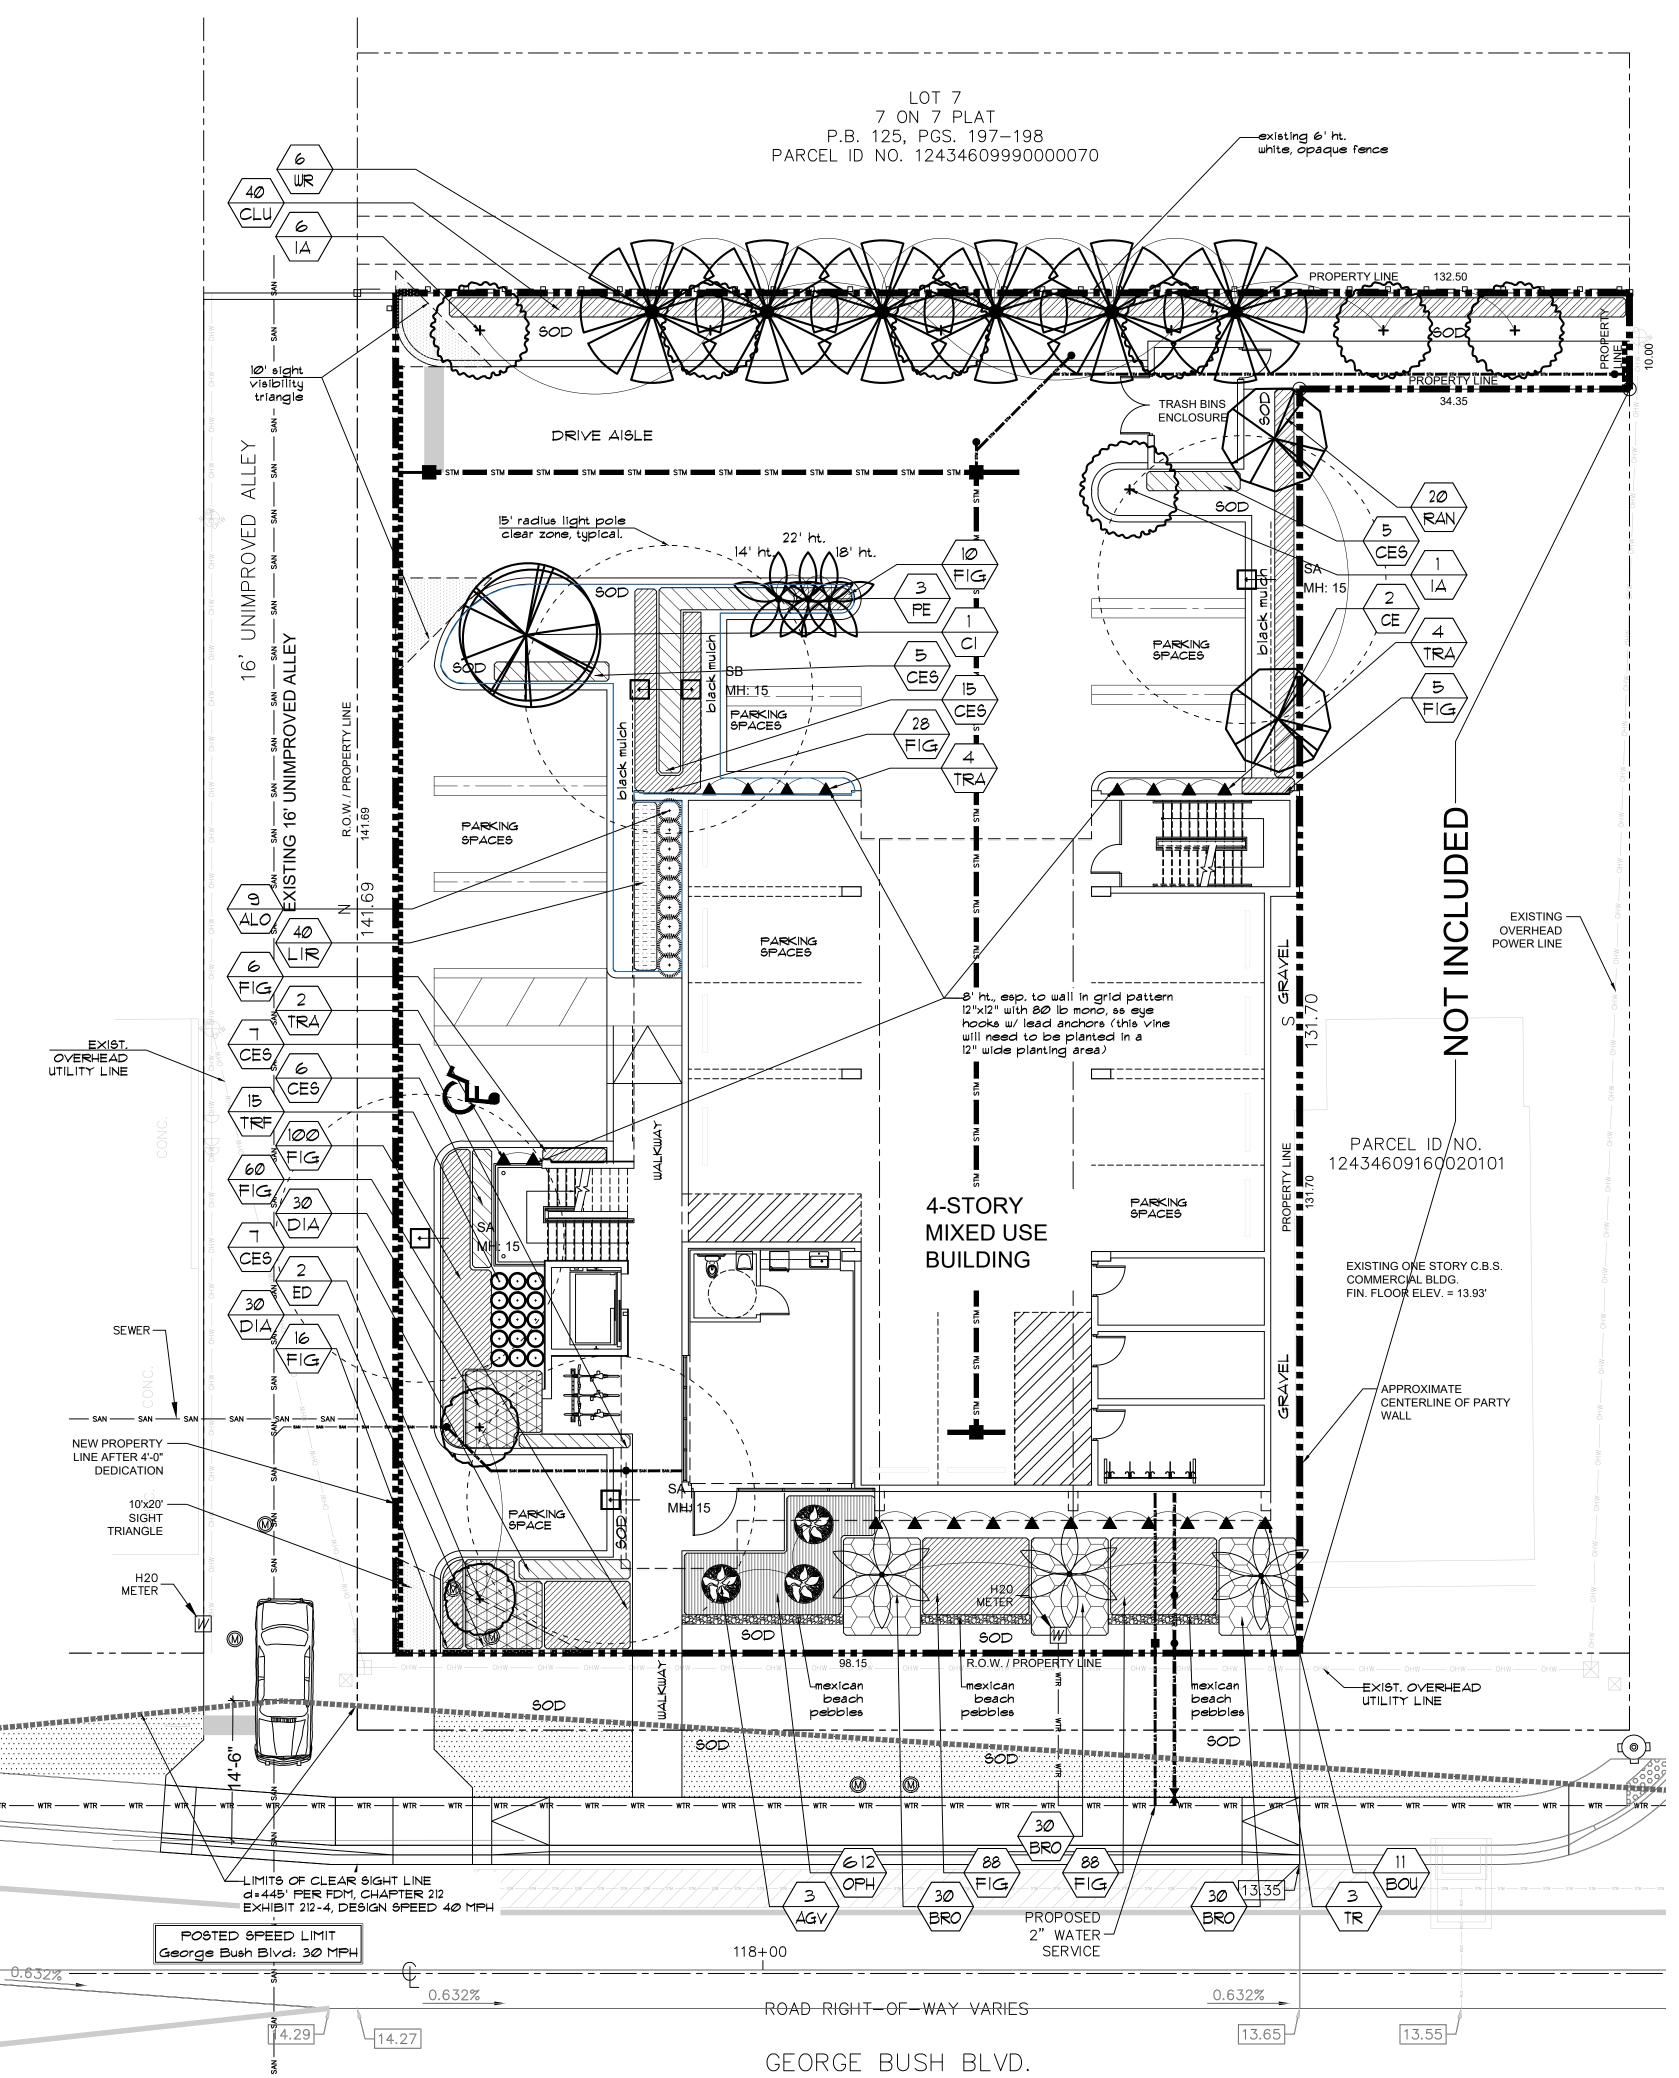

# CODE DATA

# multiple family, commercial, \$ industrial

110	* (C)   C   C   C   C   C   C   C   C   C		140 61 101
Д	TOTAL LOT AREA		14,250 S.F.
В	STRUCTURES, PARKING, WALKWAYS, DRIVES, ETC.		10,754 S.F.
С	TOTAL PERVIOUS LOT AREA	C = (A - B)	3,496 S.F.
D	AREA OF SHRUBS AND GROUND COVERS REQUIRED	D = (C × 30)	1,049 S.F.
E	AREA OF SHRUBS AND GROUND COVERS PROVIDED		1,786 S.F.
F	NATIVE VEGETATION REQUIRED	F = (D x 25)	263 SF.
G	NATIVE VEGETATION PROVIDED		48Ø S.F.
н	TOTAL PAVED VEHICULAR USE AREA		10,487 S.F.
1	TOTAL INTERIOR LANDSCAPE AREA REQUIRED	= (H × .1∅)	1,049 SF.
J	TOTAL INTERIOR LANDSCAPE AREA PROVIDED		1,683 SF.
K	TOTAL INTERIOR SHADE TREES REQUIRED	K = (1/125 S.F.)	5 TREES
L	TOTAL INTERIOR SHADE TREES PROVIDED		5 TREES
M	TOTAL LINEAR FEET SURROUNDING PARKING OR VEHICULAR USE AREAS*		182 L.F.
N	TOTAL NUMBER OF PERIMETER TREES REQUIRED	N = (M/30) N = (M/25) IF ADJACENT TO PROPERTY IN RESIDENTIAL USE	8 TREES
0	TOTAL NUMBER OF PERIMETER TREES PROVIDED		II TREES
P	TOTAL NUMBER OF EXISTING TREES TO BE SAVED ON SITE		Ø TREES
Q	TOTAL NUMBER OF NATIVE TREES REQUIRED	Q = ((K + N) x .50)	9 TREES
R	TOTAL NUMBER OF NATIVE TREES PROVIDED		10 TREES
s	TOTAL NUMBER OF TREES ON PLAN PROVIDED		16 TREES

- ALL PLANT MATERIAL SHALL BE FLORIDA #1 GRADE OR BETTER. - MULCH SHALL BE APPLIED TO A MINIMUM DEPTH OF THREE (3) INCHES IN ALL PLANTING BEDS. - ALL PROHIBITED PLANT SPECIES SHALL BE ERADICATED FROM THE SITE. - ALL LANDSCAPE AREAS SHALL BE PROVIDED WITH AN IRRIGATION SYSTEM, AUTOMATICALLY OPERATED,
- TO PROVIDE COMPLETE COVERAGE TO ALL PLANT MATERIALS AND GRASS.

   SOD AND IRRIGATION SHALL BE PROVIDED WITHIN THE UNPAVED PORTION OF THE RIGHT-OF-WAY ADJACENT TO THE PROPERTY LINE.
- THREE (3) PALMS ARE EQUIVALENT TO ONE (1) SHADE TREE. - ANY TREES OR SHRUBS PLACED WITHIN WATER, SEWER, OR DRAINAGE EASEMENTS SHALL CONFORM TO THE CITY OF DELRAY BEACH STANDARD DETAILS: LD 1.1 & LD 1.2.

NOTE:
ANY TREES OR SHRUBS PLACED WITHIN WATER, SEWER OR DRAINAGE EASEMENTS SHALL CONFORM TO THE CITY OF DELRAY BEACH STANDARD DETAILS LD 1.1 AND LD 1.2.


THE AREA BETWEEN THE PROPERTY LINE / R.O.W. LINE AND THE EDGE OF PAVEMENT OF CITY STREETS SHALL BE SODDED OR LANDSCAPED WITH A GROUND COVER ACCEPTABLE TO THE CITY ENGINEERING DEPARTMENT. IT IS UNDERSTOOD THAT ANY REPAIRS DUE TO CITY MAINTENANCE WILL BE REPLACED. (THE CITY WILL ONLY REPLACE WITH ST. AUGUSTINE OR BAHIA

A COST ESTIMATE WILL BE SUBMITTED AT THE TIME OF THE BUILDING PERMIT APPLICATION.

AN IRRIGATION PLAN WILL BE SUBMITTED AT THE TIME OF THE BUILDING PERMIT APPLICATION

# PLANT LIST

SYM CE	BOTANICAL/COMMON NAME Conocarpus erectus Green Buttonwood	SPECIFICATIONS 16' ht. x 7' spr., 3" cal., 8' c.t.	QTY 2	_
CI	Calophyllum inophyllum Brazilian Beauty Leaf	16' ht. x 7' spr., 3" cal., 8' c.t.	1	
ED	Elaeocarpus decipiens Japanese Blueberry	16' ht. x 5' spr., 3" cal., 8' c.t., pyramidal	2	
IA	llex attenuata East Palatka Holly	16' ht. x 5' spr., 3" cal., 8' c.t.	٦	
PE	Ptychosperma elegans Solitaire Palm	o.a. ht. as noted on plan	3	
TR	Thrinax radiata Thatch Palms	22' o.a. ht. matched, specimens	3	
WR	Washingtonia robusta Washington Palm	33' <i>o.a.</i> ht.	6	
AGY	Agave 'Blue Glow' Blue Glow Agave	3' ht. × 3' spr.,	3	
ALO	Alocasia odora 'California' Dwarf Elephant Ear	36" ht. x 36" spr., 24" o.c.	9	
BOU	Bougainvillea 'purple' Purple bougainvillea	8' runners, espalier to metal grid	11	
BRO	Bromeliad 'Jeffrey Block' Bromeliads	18" ht. x 18" spr., 18" o.c.	90	
CES	Conocarpus erectus 'Sericeus' Silver Buttonwood	36" ht. x 24" spr., 24" o.c.	45	
CLU	Clusia guttifera Small Leaf Clusia	4 1/2' ht. x 3' spr., 3' o.c.	40	
DIA	Dianella tasmanica Blueberry Flax Lily	18" ht. x 18" spr., 18" o.c.	60	
FIG	Ficus microcarpa Green Island	10" ht. x 10" spr., 12" o.c.	401	
LIR	Liriope 'evergreen giant' Giant Liriope	10" ht. x 10" spr., 12" o.c.	40	
OPH	Ophiopogon japonicus Mondo Grass	4" ht. x 4" spr., 6" o.c.	612	
RAN	Randia aculeata White Indigo Berry	24" ht. x 18" spr., 24" o.c.	2Ø	
TRA	Trachelospermum jasminoides Confederate Jasmine	8' ht., esp. to wall in grid pattern 12"x12" with 80 lb mono, ss eye hooks w/ lead anchors (this vine will need to be planted in a 12" wide planting area)	10	
TRF	Tripsacum floridanum Dwarf Fakahatchee Grass	18" ht. x 18" spr., 24" o.c.	15	
SOD	Stenotaphrum secundatum St. Augustine Sod	full, fresh sod as	req'd	
	Mexican Beach Pebbles	3" dia., 3" layer as	req'd	

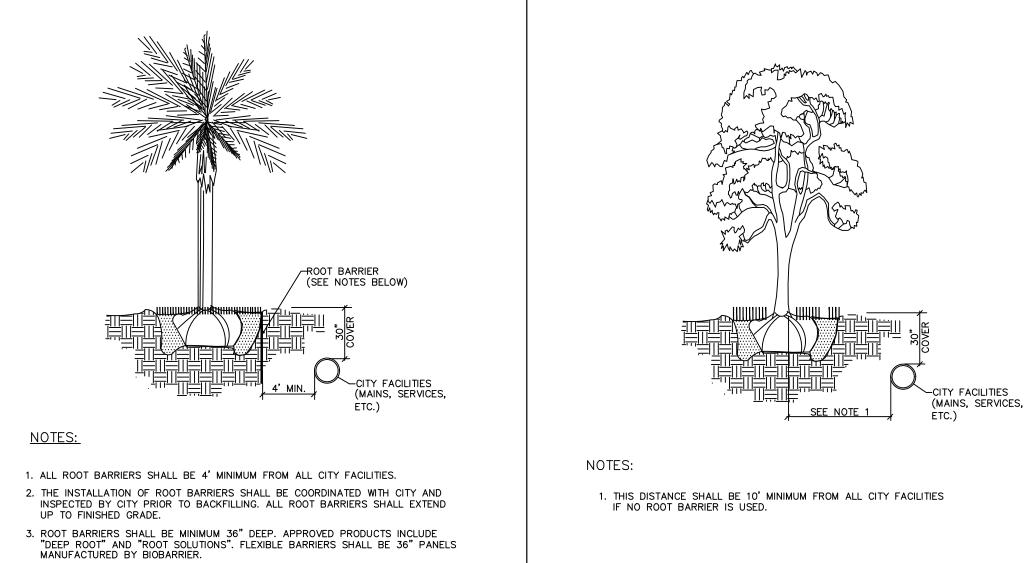

TYPICAL TREE WITHOUT ROOT BARRIER LD 1.2

# the george corner of george bush blvd & ne 7th ave delray beach, fl

#### dave bodker landscape architecture/planning inc.

601 n. congress ave., suite 105—a delray beach, florida 33445 561-276-6311

#LA0000999

sheet title:

plan

# planting

### project number: 05/11/2020 1" = 10'


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revisions: 1/28/20 city comments  $\triangle$  11/23/20 city comments









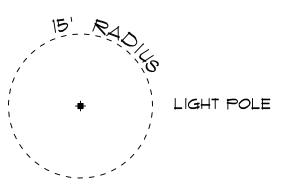

4. ALL ROOT BARRIERS SHALL BE INSTALLED IN ACCORDANCE WITH MANUFACTURERS WRITTEN INSTRUCTIONS.

TYPICAL TREE WITH ROOT BARRIER LD 1.1

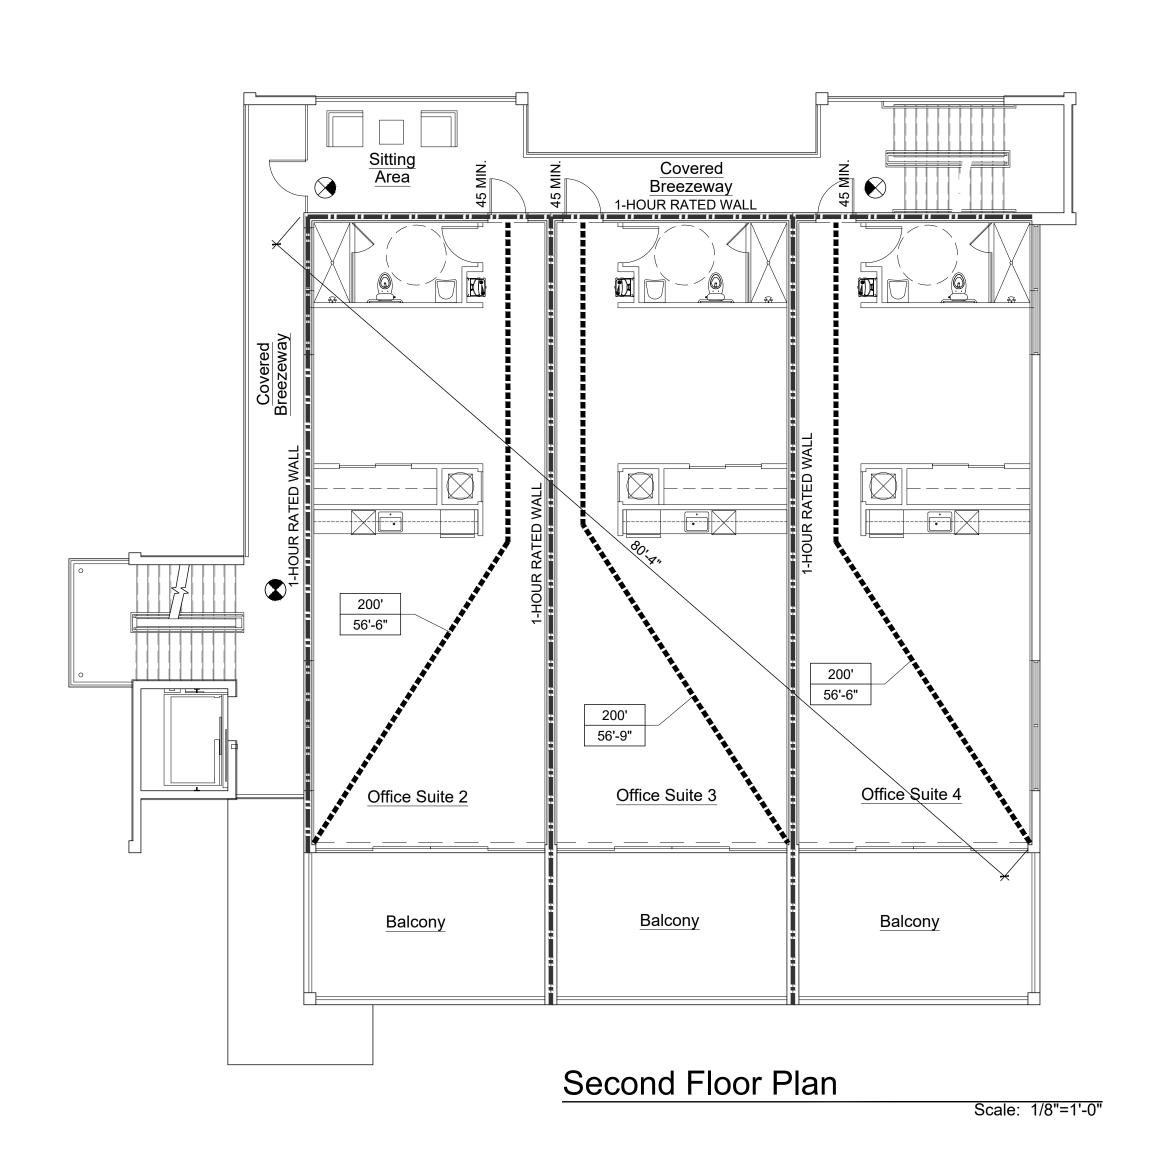

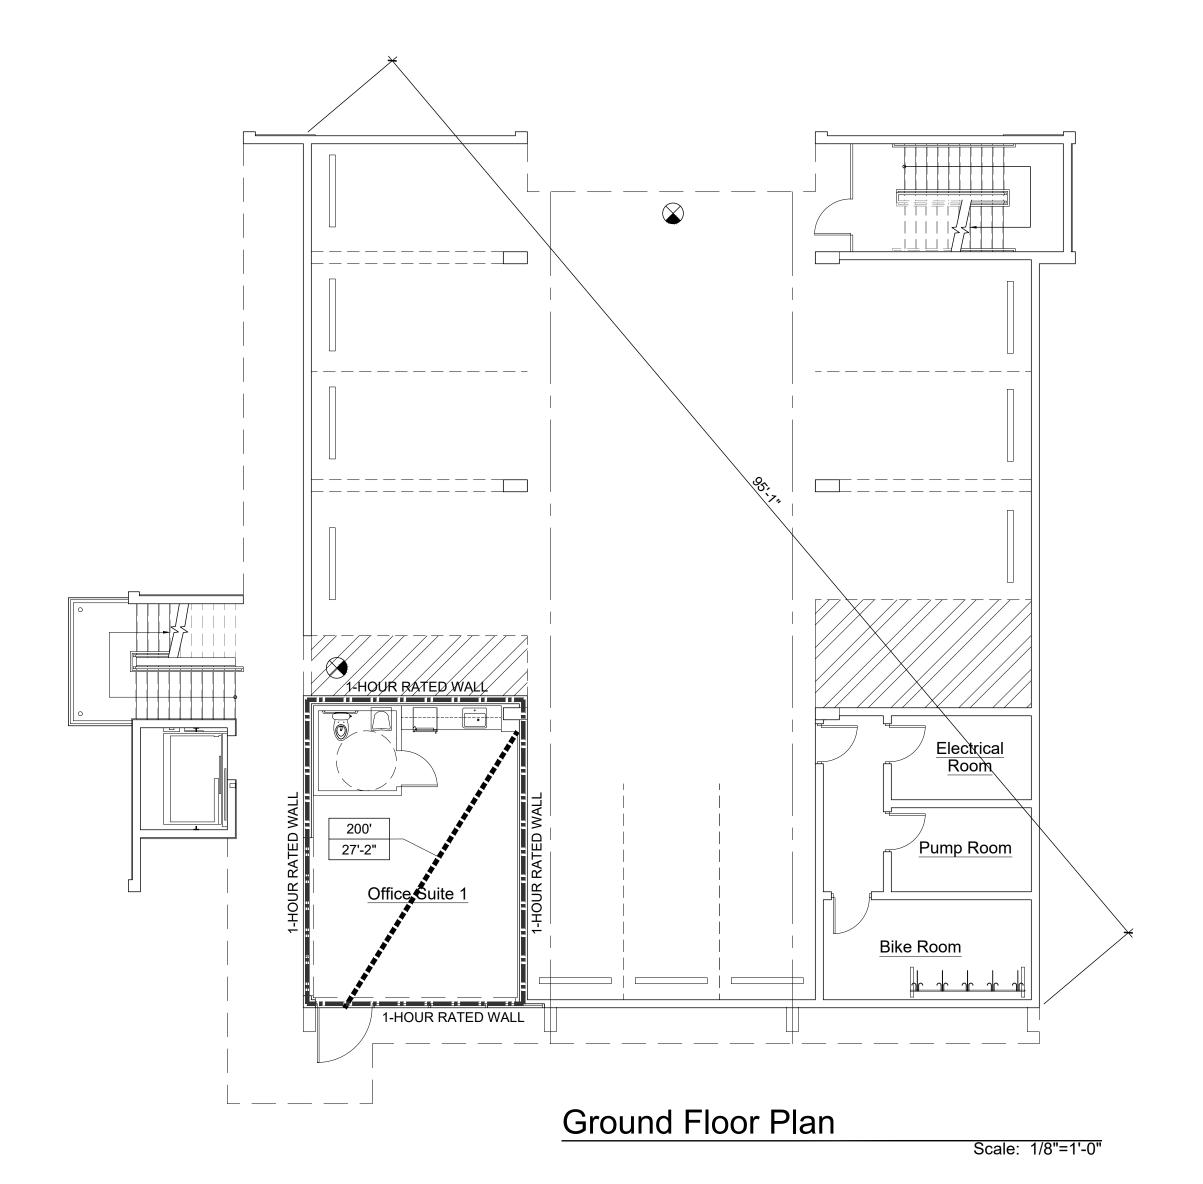

1			
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VALLS / '	PARTITIONS / DOORS	EGRESS							FIRE ALA	ARM & PRO	OTECTION			FIRE EXT	INGUISHERS	SIGNAGE			
SYMBOL	DESCRIPTION	SYMBOL	DESCRIPTION	SYMBOL	DESCRIPTION	SYMBOL	DESCRIPTION	SYMBOL DESCRIPTION	SYMBOL	DESCRI	RIPTION	SYMBOL	DESCRIPTION	SYMBOL	DESCRIPTION	SYMBOL	DESCRIPTION	SYMBOL	DESCRIPTION
1 HR FIRE RATED SEPARATION: ALL DOORS AND PENETRATIONS HORIZONTALLY THRU SEPARATION SHALL HAVE A 20-MINUTE FIRE RESISTANCE RATING AT CORRIDOR	F4 36"	EXIT TAG      EGRESS WIDTH PROVIDED IN INCHES	<b>∢</b> s	SECONDARY MEANS OF EGRESS, IF REQUIRED	<b>√8</b> >	EXIT SIGN & EMERGENCY LIGHT FIXTURE COMBINATION W/ 90 MINUTE BATTERY PACK		FD	THERMAL D	DETECTOR, ATE-OF-RISE	*DF	SIGNALING HORN *(V) WITH VISUAL SIGNAL (STROBE, 75CD UNLESS NOTED)		CLASS A: PROVIDE ONE FIRE EXTINGUISHER PER NFPA 10 FOR EACH 3,000 SQ.FT. OF BUILDING WITH A 75'-0" MAX.	EGD	EVACUATION GRAPHIC DIAGRAM OF EGRESS ROUTES FROM SPACE	EX TR	SIGN TO READ: "EXIT TI LEVEL FOR TRANSFER SECONDARY MEANS OF EGRESS."	
	PARTITIONS AND A 45-MINUTE FIRE RESISTANCE RATING AT OTHER LOCATIONS  2 HR FIRE RATED SEPARATION: ALL DOORS	E4 180		<b>(*)</b>	LIGHTED EXIT SIGN - SINGLE FACED W/ 90 MINUTE BATTERY PACK	<b>♣</b>	EMERGENCY LIGHT FIXTURE W/ 90 MINUTE BATTERY PACK		FX	THERMAL D	DETECTOR, IP.	Œ <sup>†</sup>	FIRE ALARM STROBE, MOUNTED 80" AFF	FEX	TRAVEL DISTANCE. F.E. RATTING: 2A  (W) DENOTES WALL HUNG	EXIT	TACTILE EXIT SIGN, WALL- MOUNTED ADJACENT TO STAIR ENTRY DOOR ON LATCH SIDE @ 60" TO CENTERLINE OF SIGN	NAAV	MAXIMUM OCCUPANCY TO READ: "OCCUPANCY MORE THAN 'X' PERSON DANGEROUS AND UNLA
	AND OPENINGS SHALL BE PROTECTED BY A 90 MINUTE FIRE-RESISTANT RATING.	200'	—MAXIMUM TRAVEL DISTANCE ALLOWED	•	LIGHTED EXIT SIGN - DOUBLE FACED W/ 90 MINUTE BATTERY PACK	FACE OF SIGN	REA OF EXIT SIGN INDICATES		F	MANUAL ST	TATION	<b>₹</b>	EMERGENCY LIGHT FIXTURE W/ 90 MINUTE BATTERY PACK		(WC) DENOTES WALL HUNG CABINET (RC) DENOTES RECESSED CABINET	NO_EXIT	"NO EXIT" SIGN, MOUNT ON DOOR @ CENTERLINE OF ACTIVE LEAF 54" A.F.F.		CONFIRM WITH LOCAL JURISDICTION HAVING AUTHORITY FOR SIGNA REQUIREMENTS.
	3 HR FIRE RATED HAZARD AND EXIT SEPARATION: ALL DOORS AND PENETRATIONS SHALL HAVE A 180 MINUTE FIRE-RESISTANCE RATING.	[110]	DISTANCE IN FEET FROM AN OCCUPIABLE POINT 12" FROM WALL TO THE NEAREST EXIT	⊗ ↓	LIGHTED EXIT SIGN - SINGLE FACED W/ DIRECTIONAL ARROWS & 90 MINUTE BATTERY PACK				SD	SYSTEM, 12	ETECTOR - NON 120V W/ BATTERY	(D) DENOT	R PROTECTION FIXTURE SUFFIX: TES DUCT MOUNTED TES CEILING MOUNTED			ELEV	ELEVATOR SIGN: "IN CASE OF FIRE, DO NOT USE ELEVATOR, USE STAIRS."	FEX	"FIRE EXTINGUISHER IN USE SIGN ONLY WHERE EXTINGUISHER IS LOCA
- N	FIRE RATED DOORS 'X' = 20 MIN. 45 MIN. 90 MIN.	••	PATH OF TRAVEL	₩.	LIGHTED EXITSIGN - DOUBLE FACED W/ DIRECTIONAL ARROWS & 90 MINUTE BATTERY PACK				SD <sub>P</sub>	SMOKE DET	ETECTOR -	(F) DENOT	FES FLUSH WALL MOUNTED FES WEATHERPROTECTED			G	ACCESSIBLE ROUTE SIGN. (DIRECTIONAL WHERE INDICATED)		WITHIN A ROOM THAT I UNLOCKED WHILE THE BUILDING IS OCCUPIED

EMERGENCY LIGHT

## FIRE PROTECTION NOTES

WALL OR PARTITION.)

#### FIRE PROTECTION GENERAL NOTES:

1. FULLY SPRINKLED BUILDING AS PER FBC, CHAPTER 9, SECTION 903.2.7 AND NFPA 13. REFER TO FIRE SPRINKLER PLANS BY OTHERS.

WITH ONLY A PRIMARY

EGRESS REQUIREMENT)

- 2. FIRE ALARM, FIRE DETECTION AND COMMUNICATION SYSTEM SHALL BE INSTALLED AS PER FBC, CHAPTER 9 AND NFPA 72-2018 (NATIONAL FIRE ALARM CODE) AND SECTION 403.
- 3. STANDBY POWER SYSTEM (EMERGENCY GENERATOR) SHALL CONFORM WITH FBC CHAPTER 27, SECTION 403.10
- AND NFPA 110-2016. 4. PROVIDE STENCIL WITH 4" HIGH LETTERING @ 30'-0" ON BOTH SIDES OF ALL FIRE AND SMOKE BARRIERS ABOVE
- CEILINGS TO READ: FIRE/SMOKE PARTITION PROTECT ALL OPENINGS. SEAL ALL OPENINGS AND PENETRATIONS TO RESIST THE MIGRATION OR PASSAGE OF SMOKE AND GASES.
- 5. SPECIFIC EXCEPTIONS TO THE LISTED RATINGS MAY BE PERMITTED WHERE INDICATED.
- 6. FIRE RESISTANT ASSEMBLIES, MATERIALS, PROPERTIES AND THICKNESS REQUIRED, SHALL COMPLY WITH THOSE WHICH HAVE SUCCESSFULLY BEEN PERFORMED UNDER TESTS MADE BY A RECOGNIZED LABORATORY PER ASTM E119 OR BASED ON CALCULATIONS PERMITTED BY THE FBC AND BUILDING OFFICIAL.
- 7. LIFE SAFETY DRAWINGS SHALL BE USED IN CONJUNCTION AND COORDINATED WITH THE FIRE ALARM, MECHANICAL, ELECTRICAL DRAWINGS WHETHER INCLUDED WITH THESE DRAWINGS OR UNDER SEPARATE PERMIT.
- 8. PROVIDE MAXIMUM OCCUPANCY SIGN. 9. FIRE ALARM SYSTEM WITH VOICE EVAC SHALL BE INSTALLED IN ACCORDANCE WITH NFPA 101:12.3.4

- ALL WOOD COMPONENTS IN CONCEALED SPACES SHALL BE FIRE RETARDANT TREATED WOOD IN ACCORDANCE TO FBC SECTION 603.1.
- 2. INTERIOR FINISHES SHALL BE MINIMUM CLASSIFICATION "C" WITHIN ALL UNITS AND MINIMUM OF CLASSIFICATION "B" IN ALL COMMON AND PUBLIC SPACES. AS PER FBC 803.5.
- 3. ALL INTERIOR PLASTIC SIGNS SHALL CONFORM WITH FBC 2604.15.

FIRE RESISTANT MATERIAL NOTES:

# **DOOR LOCKING DEVICES NOTE:** (NFPA, FLORIDA FIRE

DOORS SHALL BE ARRANGED TO BE OPEN READILY FROM	OFI
THE EGRESS SIDE AT ALL TIMES. LOCKS IF PROVIDED, SHALL NOT REQUIRE THE USE OF A KEY, A TOOL, OR	
SPECIAL KNOWLEDGE OR EFFORT FOR OPERATION FROM	
THE EGRESS SIDE	RE

PREVENTION CODE 2018)

SHALL NOT REQUIRE THE USE OF A KEY, A TOOL, OR SPECIAL KNOWLEDGE OR EFFORT FOR OPERATION FROM	
THE EGRESS SIDE	RI

			\	
	(F.B.C. TABLE 1004.1.	2)		
	FUNCTION OF SPACE	AREA OF SPACE	MAXIMUM OCCUPANTS	-
1	OFFICE/RETAIL AREA	3,757 SQUARE FEET	38(37.57) OCCUPANTS	
1	ELECTRICAL/ MECHANICAL/ BIKE STORAGE	467 SQUARE FEET	3(3.11) OCCUPANTS	,
1	RESIDENTIAL AREA	6,325 SQUARE FEET	32(31.63) OCCUPANTS	
	TOTAL BUILDING:		73 OCCUPANTS	
			/	ı

OCCUPANT LOAD CALC.

RICHARD JONES
ARCHITECTURE

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WWW.RJARCHITECTURE.COM

ORID FL BE DELR

FLORIDA LICENSURE

AA26001617 | IB26001056 COMMISSION #

PLAN REVIEW: SUBMITTALS: CLASS-5 05.11.20 SUBMITTAL:

DESIGNER: DRAWN BY:

REVISIONS: TAC COMMENTS: TAC COMMENTS: 10.09.20


 $\sqrt{3}$  COMMENTS:

 $\triangle$  TAC


LIFE SAFETY GROUND & SECOND

11.17.20

FLOOR PLAN

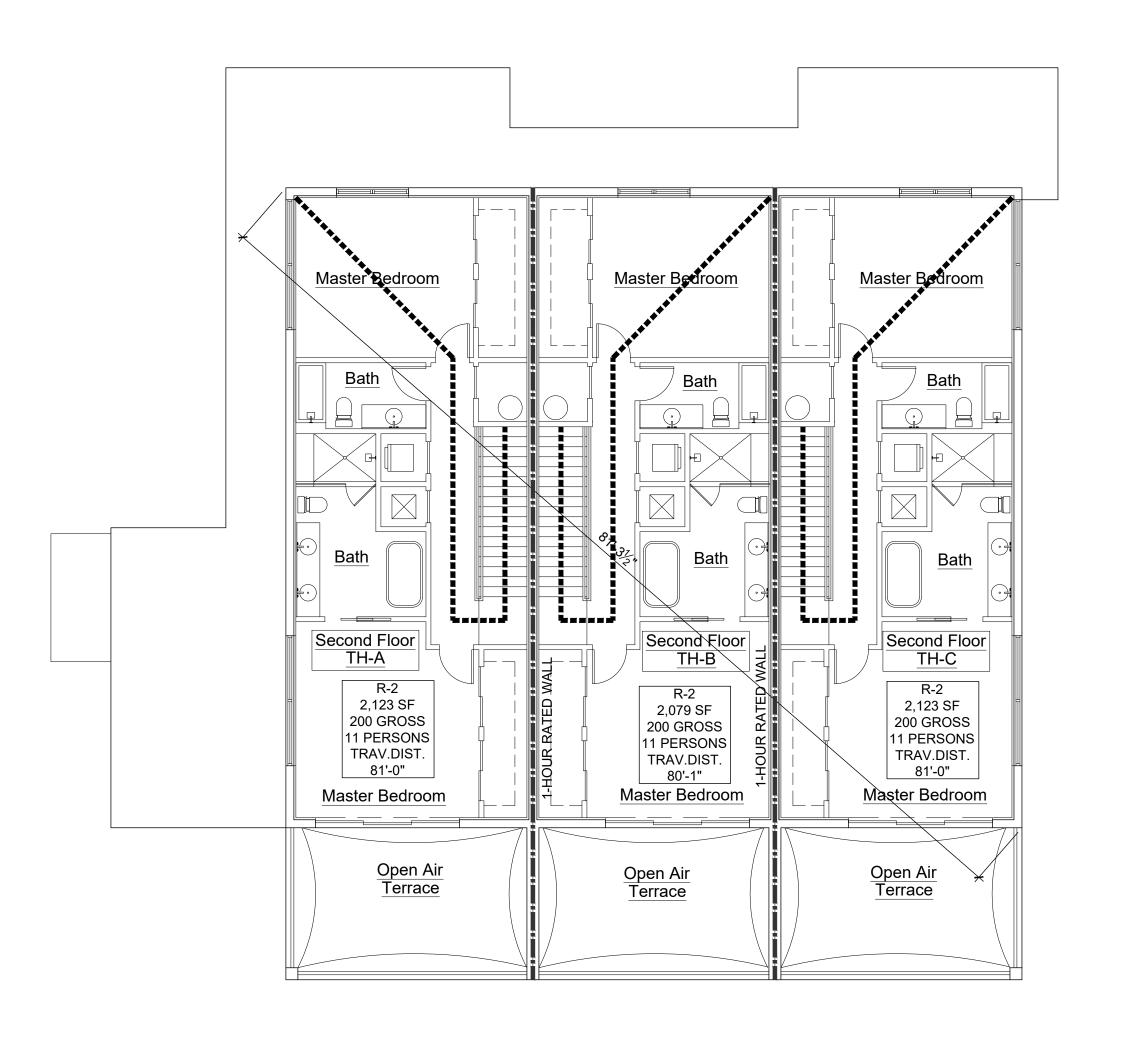

Fourth Floor Plan Scale: 1/8"=1'-0"

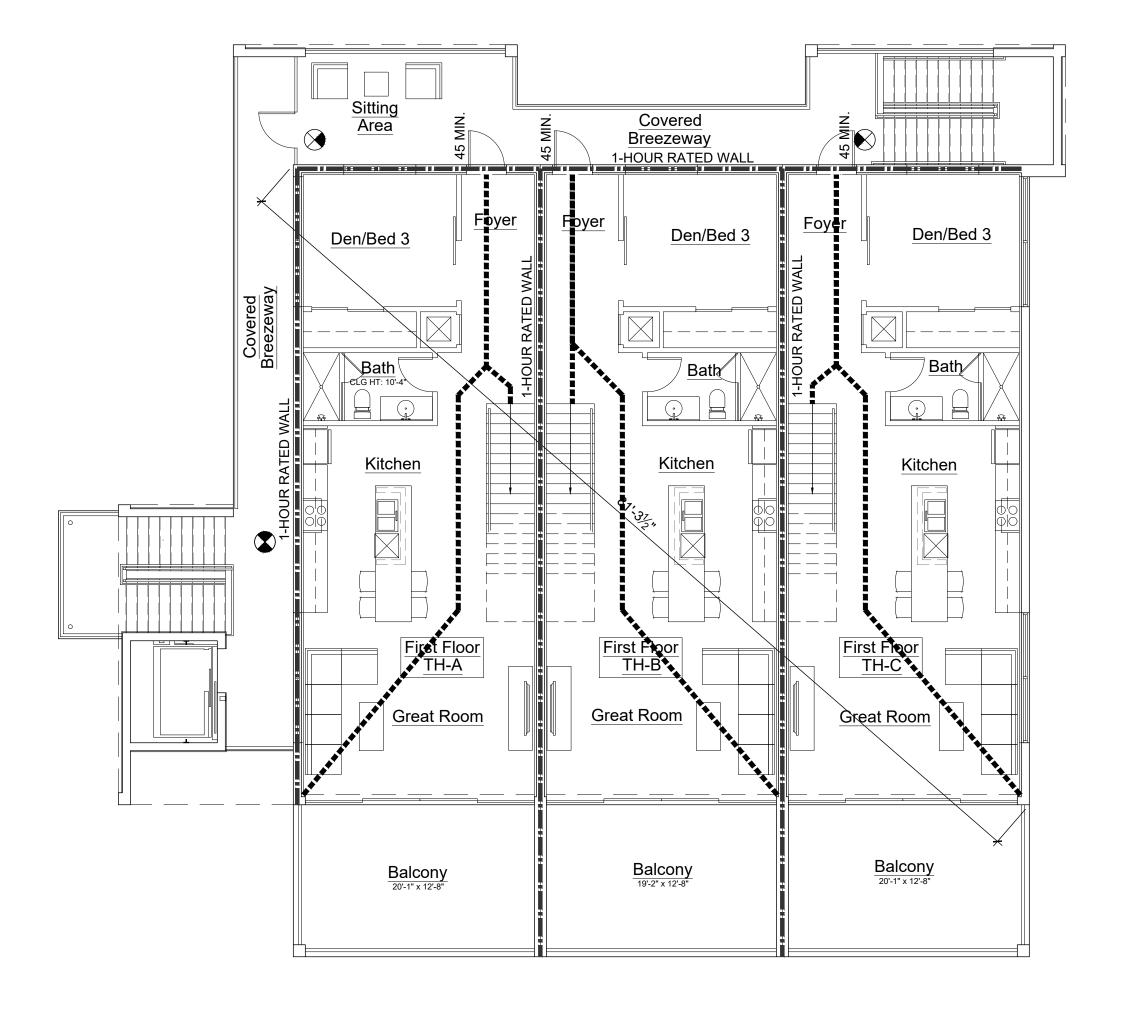

Third Floor Plan

Scale: 1/8"=1'-0'

# LIFE SAFETY LEGEND

VALLS / F	PARTITIONS / DOORS	EGRESS							FIRE AL	ARM & PROTECTION	N		FIRE EXT	INGUISHERS	SIGNAGE			
SYMBOL	DESCRIPTION	SYMBOL	DESCRIPTION	SYMBOL	DESCRIPTION	SYMBOL	DESCRIPTION	SYMBOL DESCRIPTION	SYMBOL	L DESCRIPTION	SYMBO	OL DESCRIPTION	SYMBOL	DESCRIPTION	SYMBOL	DESCRIPTION	SYMBOL	DESCRIPTION
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	180 MIN. (REFER TO FIRE-RESISTANCE RATING OF	<b>●</b> P	PRIMARY MEANS OF EGRESS (NOT SHOWN FOR SPACES WITH ONLY A PRIMARY	<b>③</b>	LIGHTED WALL MOUNTED EXIT SIGN W/ 90 MINUTE			EXTERIOR WALL PACK EMERGENCY LIGHT					-					

EMERGENCY LIGHT

## FIRE PROTECTION NOTES

WALL OR PARTITION.)

#### FIRE PROTECTION GENERAL NOTES:

1. FULLY SPRINKLED BUILDING AS PER FBC, CHAPTER 9, SECTION 903.2.7 AND NFPA 13. REFER TO FIRE SPRINKLER PLANS BY OTHERS.

WITH ONLY A PRIMARY

EGRESS REQUIREMENT)

- 2. FIRE ALARM, FIRE DETECTION AND COMMUNICATION SYSTEM SHALL BE INSTALLED AS PER FBC, CHAPTER 9 AND NFPA 72-2018 (NATIONAL FIRE ALARM CODE) AND SECTION 403.
- 3. STANDBY POWER SYSTEM (EMERGENCY GENERATOR) SHALL CONFORM WITH FBC CHAPTER 27, SECTION 403.10 AND NFPA 110-2016.
- 4. PROVIDE STENCIL WITH 4" HIGH LETTERING @ 30'-0" ON BOTH SIDES OF ALL FIRE AND SMOKE BARRIERS ABOVE
- CEILINGS TO READ: FIRE/SMOKE PARTITION PROTECT ALL OPENINGS. SEAL ALL OPENINGS AND PENETRATIONS TO RESIST THE MIGRATION OR PASSAGE OF SMOKE AND GASES.
- 5. SPECIFIC EXCEPTIONS TO THE LISTED RATINGS MAY BE PERMITTED WHERE INDICATED.

**BATTERY PACK** 

- 6. FIRE RESISTANT ASSEMBLIES, MATERIALS, PROPERTIES AND THICKNESS REQUIRED, SHALL COMPLY WITH THOSE WHICH HAVE SUCCESSFULLY BEEN PERFORMED UNDER TESTS MADE BY A RECOGNIZED LABORATORY PER ASTM E119 OR BASED ON CALCULATIONS PERMITTED BY THE FBC AND BUILDING OFFICIAL.
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FIRE RESISTANT MATERIAL NOTES:

# (F.B.C. TABLE 1004.1.2)

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N FROM	RESIDENTIAL AREA	6,325 SQUARE FEET	32(31.63) OCCUPANTS				
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TOTAL BUILDING:

OCCUPANT LOAD CALC.

# THIRD & **FOURTH** FLOOR PLAN

RICHARD JONES ARCHITECTURE 10 S.E. FIRST AVENUE | SUITE 102 DELRAY BEACH, FLORIDA 33444 V 561.274.9186 | F 561.274.9196 AA26001617 | IB26001056 WWW.RJARCHITECTURE.CO ORID FL H DELR FLORIDA LICENSURE

AA26001617 | IB26001056 COMMISSION # DESIGNER:

PLAN REVIEW: SUBMITTALS: CLASS-5 05.11.20 SUBMITTAL:

DRAWN BY:

REVISIONS: TAC COMMENTS: TAC COMMENTS: 10.09.20

3 COMMENTS:


11.17.20

 $\triangle$  TAC

LIFE SAFETY

73 OCCUPANTS



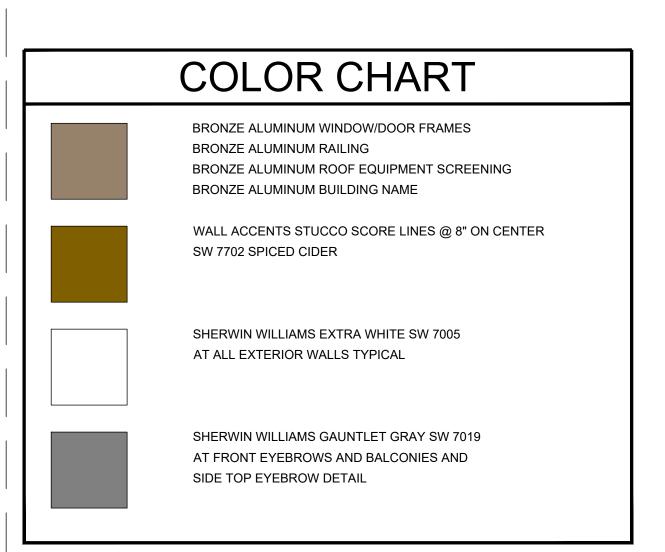

South Elevation

Scale: 3/16"=1'-0"

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A-3.1

RICHARD JONES





# BRONZE ALUMINUM WINDOW/DOOR FRAMES BRONZE ALUMINUM RAILING BRONZE ALUMINUM ROOF EQUIPMENT SCREENING BRONZE ALUMINUM BUILDING NAME WALL ACCENTS STUCCO SCORE LINES @ 8" ON CENTER SW 7702 SPICED CIDER SHERWIN WILLIAMS EXTRA WHITE SW 7005 AT ALL EXTERIOR WALLS TYPICAL SHERWIN WILLIAMS GAUNTLET GRAY SW 7019 AT FRONT EYEBROWS AND BALCONIES AND SIDE TOP EYEBROW DETAIL

West Elevation

Scale: 3/16"=1'-0"

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North Elevation

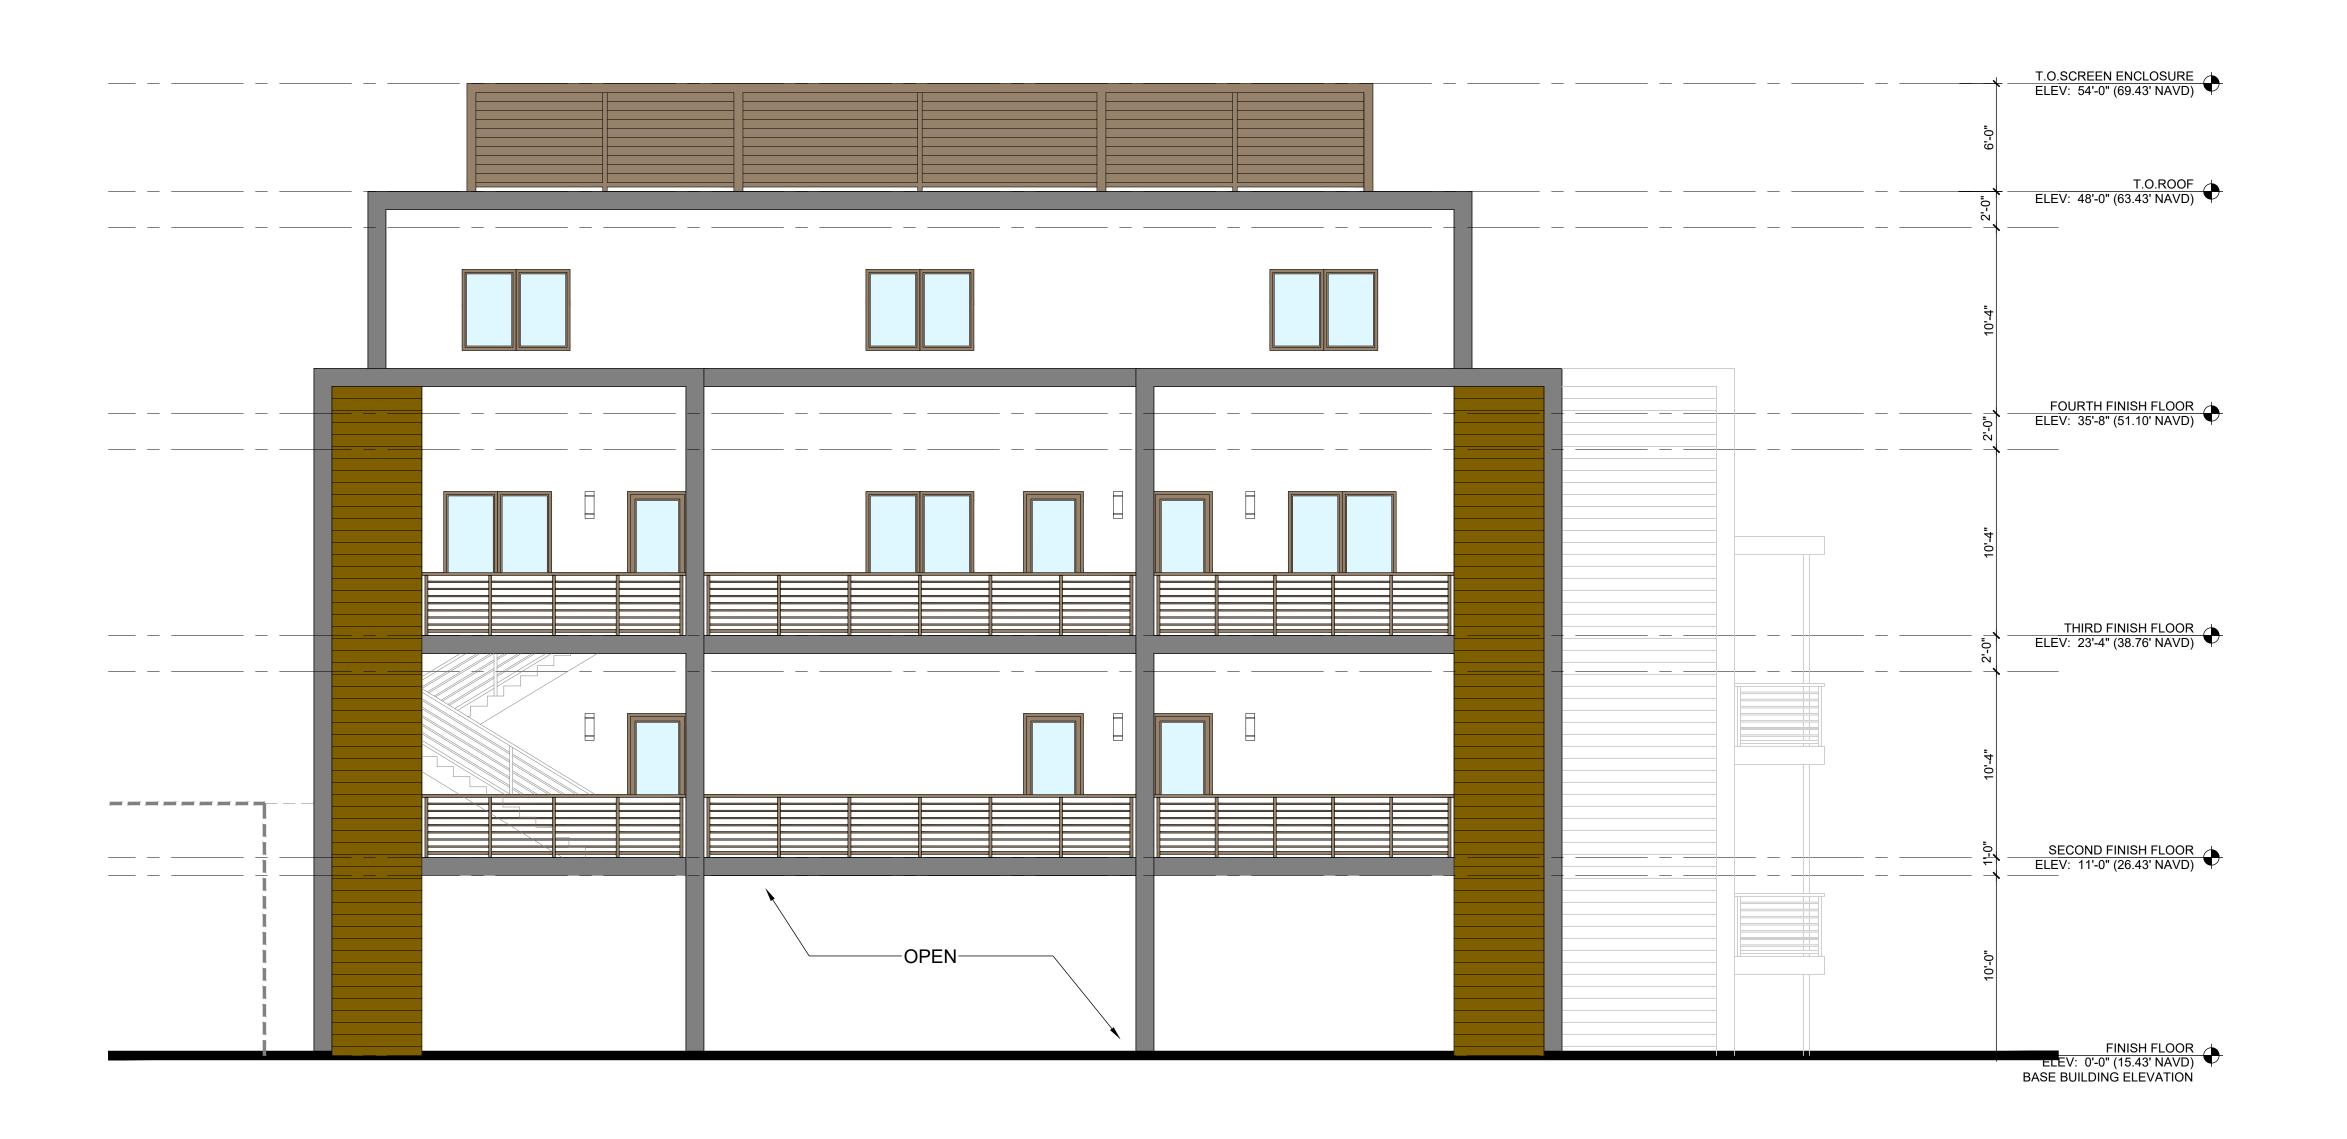
Scale: 3/16"=1'-0"

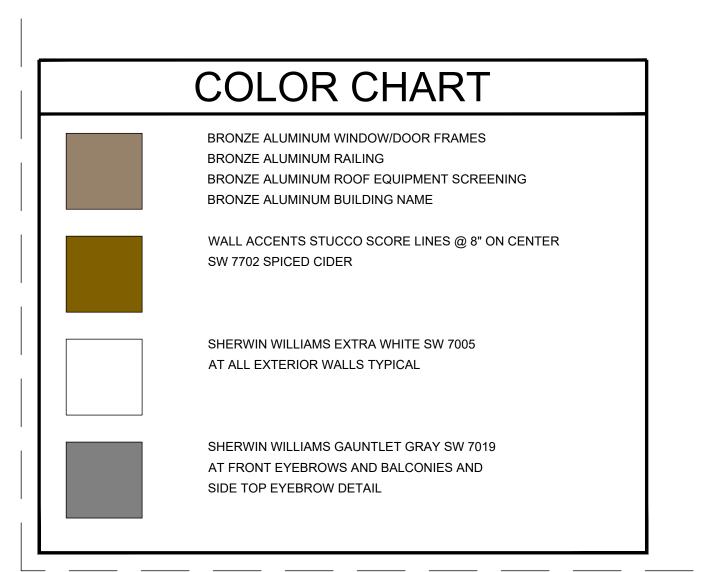ARCHITECTURE 10 S.E. FIRST AVENUE | SUITE 102 DELRAY BEACH, FLORIDA 33444 V 561.274.9186 | F 561.274.9196 AA26001617 | IB26001056 WWW.RJARCHITECTURE.COM CH, FLORID BEA DELR FLORIDA LICENSURE AA26001617 | IB26001056 COMMISSION # 19-044 DESIGNER: DRAWN BY: PLAN REVIEW: SUBMITTALS: CLASS-5 SUBMITTAL: TAC COMMENTS: TAC COMMENTS: TAC COMMENTS: NORTH **ELEVATION** 

RICHARD JONES

NORTH ELEVATION

A-3.3

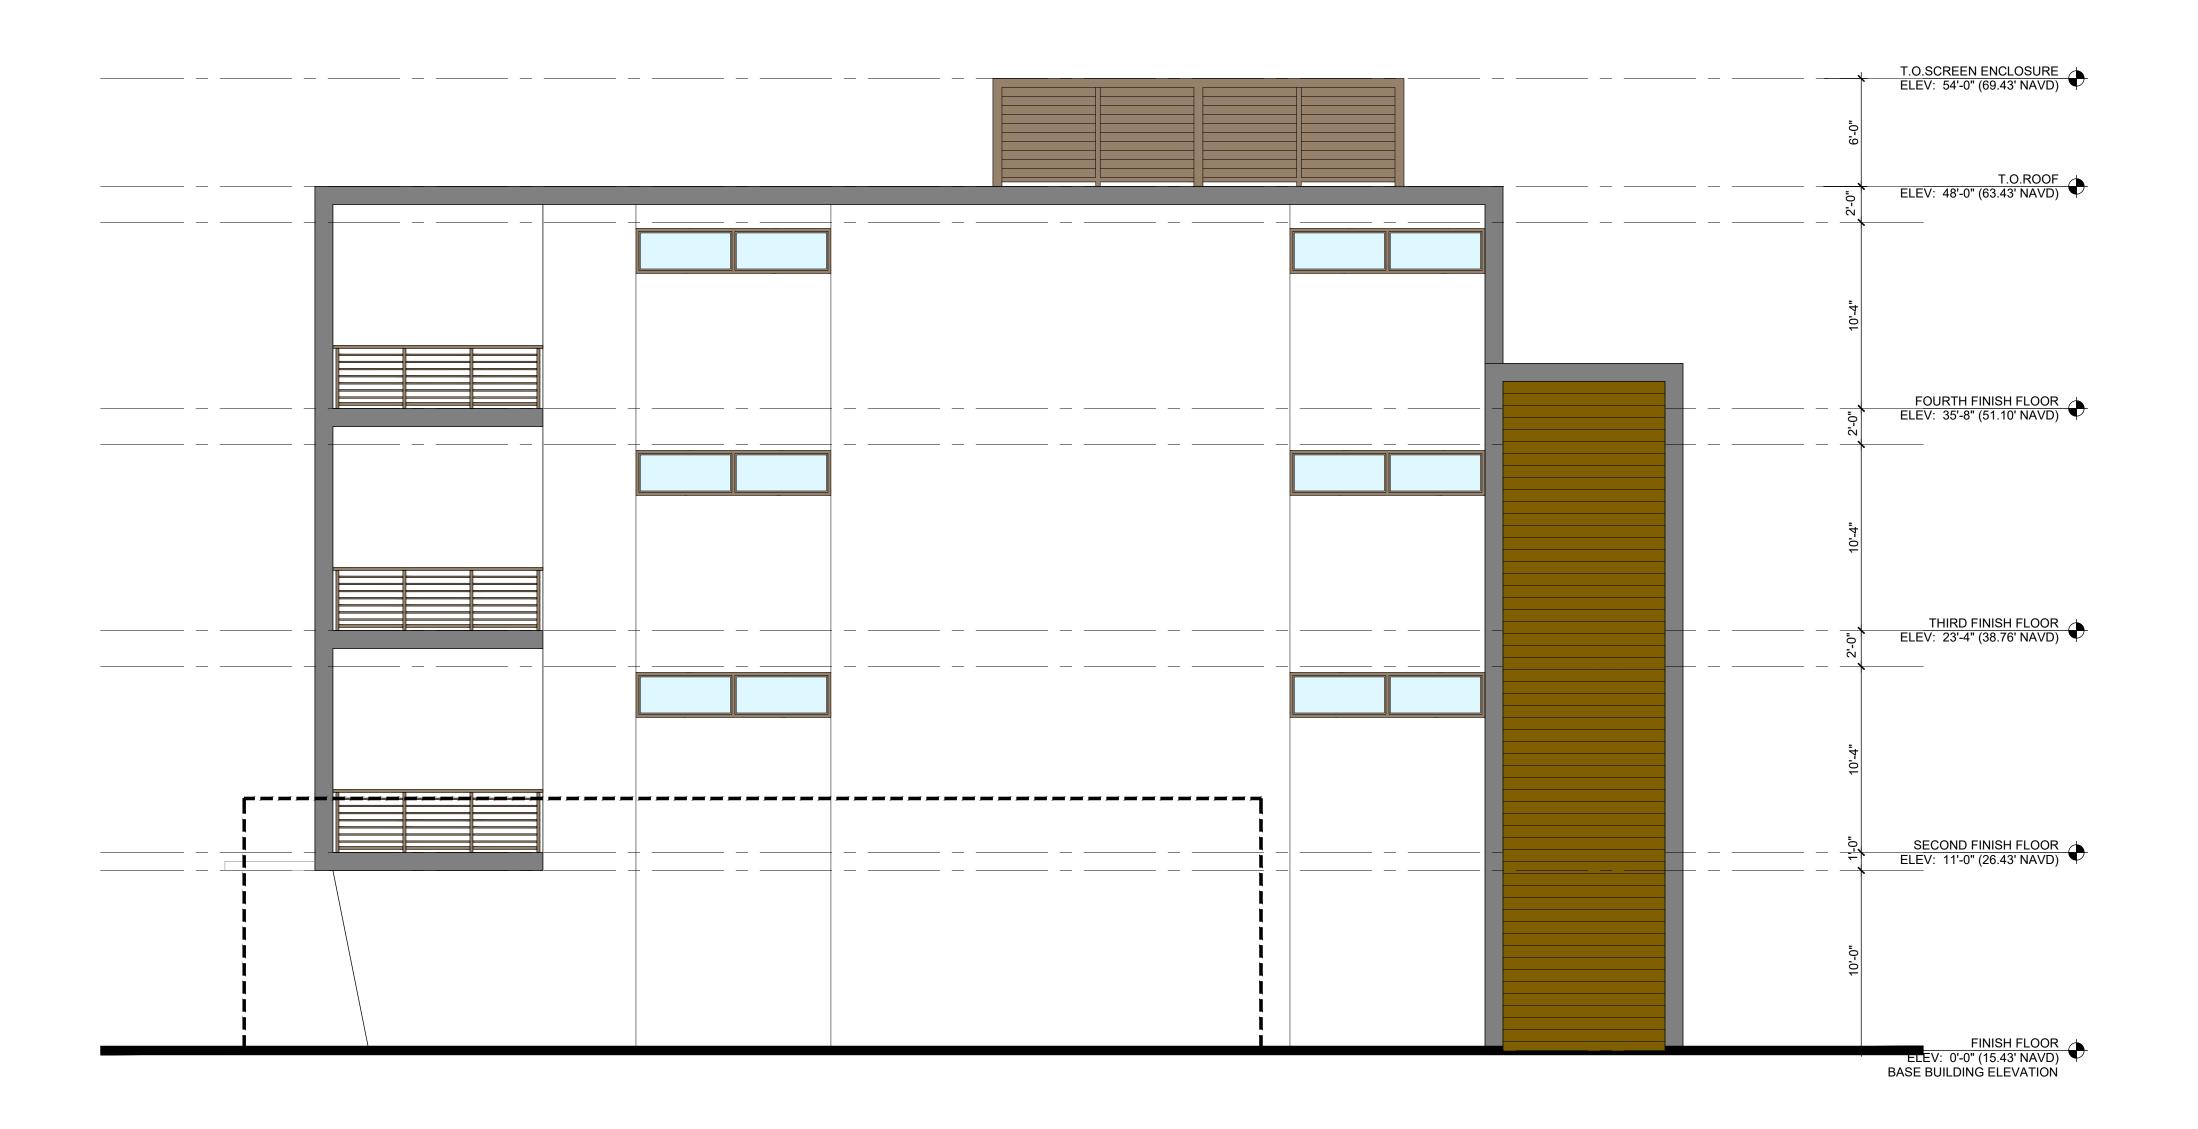

# COLOR CHART BRONZE ALUMINUM WINDOW/DOOR FRAMES BRONZE ALUMINUM RAILING BRONZE ALUMINUM ROOF EQUIPMENT SCREENING BRONZE ALUMINUM BUILDING NAME WALL ACCENTS STUCCO SCORE LINES @ 8" ON CENTER SW 7702 SPICED CIDER SHERWIN WILLIAMS EXTRA WHITE SW 7005 AT ALL EXTERIOR WALLS TYPICAL SHERWIN WILLIAMS GAUNTLET GRAY SW 7019 AT FRONT EYEBROWS AND BALCONIES AND SIDE TOP EYEBROW DETAIL

East Elevation

Scale: 3/16"=1'-0"

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COMMENTS:
TAC
TAC
COMMENTS: TAC COMMENTS: **EAST ELEVATION** 

#### CARNEY STANTON P.L.

Attorneys At Law

135 S.E. 5<sup>TH</sup> AVENUE, SUITE 202 DELRAY BEACH, FLORIDA 33483 TEL: (561) 278-5565 FAX: (561) 330-8233

EMAIL: tfc@carneystanton.com

January 12, 2021

Mr. Kent Walia Planning & Zoning Department City of Delray Beach Delray Beach, FL-33444

In Re: Comments on the "George" Project / 655 George Bush Boulevard

Dear Kent:

This office represents The Sail Inn situated at 637 George Bush Boulevard, which is immediately west and adjacent to the proposed "The George" project (the "Project") currently under consideration by the Site Plan Appearance & Review Board (SPRAB).

As the immediate adjacent property owner, we have concerns pertaining to the design of the Project and the effects that this project will have on my client's property.

First, the design appears as though there will be some type of separation (3') between the exterior western wall of my client's building and the building to be constructed. We are unsure what this separation is for and what effect this will have on our building. We are trying to understand what the purpose of it and I would appreciate if you could provide us with some type of explanation.

Second, we are concerned about access to our property, which is an operating bar, during the construction period. The bar operates during the daytime hours as well as in the evening. As you know, parking is extremely limited and the access to my client's building, which is already small, could be materially and negatively impacted by the parking of the construction vehicles related to the construction of the George. Please provide us with some type of comment on how the parking during the construction period is to be addressed and what measures are being taken to ensure that my client's parking will not be impacted, nor will the ability to use the bar and the backlot (which is currently being used, under a temporary permit, due to COVID).

Third, we want to make sure what kind of provisions are being made in the event that, while digging and creating the foundation and otherwise doing the construction on the property, to mitigate any damage to my client's structure and requiring repairs any damage to my client's property, including wall cracks and other unanticipated "settlement" issues which may arise due to the construction.

Fourth, in the northeast portion of the property, there is a narrow entrance from N.E. 9th Avenue (described on the plan as trash pickup). What buffering is being provided to ensure that the trucks utilizing this entrance to collect the garbage and trash, will not interfere with the quiet enjoyment of the backlot of my client's property. Is there any intention to build a wall? I do not see it on the plans.

Fifth, in noting the eastern boundary of the proposed plan, there appears to be a stairwell which connects to my client's western wall. This configuration (at least from what I can see on the plans) would mean that anyone accessing the west wall would have to go around to the other side of the building in order to do so (in other words, this stairwell blocks the continuous ability to walk up and down the west portion of the wall.

Since there will now be open space on the western wall of my client's property, we will need some type of easement so that we will have access to that wall over the George Property (this was not necessary before because the wall abutted the western wall of my property – now that it is not, it will require a different type of maintenance, etc., and access must be provided, as part of the approval, for my client to reach that portion of his property.

Are there provisions being made to replace the wooden fence on the rear western boundary line of the property. With the intensity of the building being constructed, some requirement should be imposed to build a wall in its place.

Regarding the environmental issues, we know that the property upon which this structure is being constructed had environmental issues from the migration of contaminants from the gas station to its west. We want to make sure that any construction on this site does not aggravate the contaminants and accelerate any migration to my client's property.

I look forward to hearing from you. Please confirm the date and time of the meeting as we will wish to make comments at the meeting. Please note that we are an affected party for purposes of participating in the discussion.

Sincerely,

CARNEY STANTON P.L.

Thomas F. Carney, Jr.

cc: Michael Holzheid / The Sail Inn