# FEDERICK ISLES, DELRAY BEACH, FL

JMC DELRAY, LLC

# **TOWN HOME**

## **GENERAL NOTES**

THE CONTRACTOR SHALL IN THE WORK OF ALL TRADES. PERFORM ANY

WORK, AND SHALL PROTECT THE EXISTING BUILDING FROM DAMAGE

THE EXISTING CONSTRUCTION TO ITS ORIGINAL CONDITION TO RESTORE

AND ALL CUTTING AND PATCHING NECESSARY TO COMPLETE THE

OPERATIONS, OR UTILITIES WITHOUT OBTAINING OWNER'S PRIOR

3. THE CONTRACTOR SHALL BE RESPONSIBLE FOR LEAVING ALL FINISH

ALL EXCESS MATERIAL AND DEBRIS FROM THE JOB REGULARLY.

4. ALL CONSTRUCTION AND WORKMANSHIP SHALL CONFORM TO THE

SURFACES CLEAN AT COMPLETION OF THE WORK AND SHALL REMOVE

5. THE CONTRACTOR SHALL VISIT THE JOB SITE AND BE RESPONSIBLE FOR THE VERIFICATION OF ALL ELEVATIONS, CONDITIONS, AND DIMENSIONS

6. ANY CONFLICTS OR OMISSIONS BETWEEN THE VARIOUS ELEMENTS OF

7. THE GENERAL CONTRACTOR SHALL COORDINATE AND VERIFY WITH ALL

TRENCHES, SLEEVES, SPECIAL BOLTING FOR EQUIPMENT CONDUITS,

SUBCONTRACTORS THE SIZE AND LOCATION OF ALL PIPING, DUCTWORK

ITEMS BY ALL SUBCONTRACTORS PRIOR TO FABRICATION.KEN FOR ALL

**VICINITY MAP** 

DRAWINGS.IG WITH ANY WORK SO INVOLVED. DO NOT SCALE

THE WORKING DRAWINGS AND/OR GENERAL NOTES SHALL BE BROUGHT TO THE ATTENTION OF THE ARCHITECT IMMEDIATELY AND BEFORE

SATISFACTION OF THE OWNER AND THE ARCHITECT.

APPROVAL AND INSTRUCTIONS IN EACH CASE.

REQUIREMENTS OF LOCAL CODES.

REQUIRING BACKING.

PRIOR TO COMMENCING CONSTRUCTION.

FLORIDA BUILDING & RESIDENDCIAL CODE, 2017 W/6TH CODE & 2012 FLORIDA ACCESSIBILTY CODE

CODES

NATIONAL ELECTRIC CODE

ALL OTHER RULES, REGULATIONS, AND CODES HAVING JURISDICTION RESIDENTIAL:

OCCUPANCY GROUP: GROUP R3 TOWNHOMES, FEE SIMPLE CONSTRUCTION TYPE: TYPE VB, UNPROTECTED, UNSPRINKLED

<u>PERMITTED</u>

**ROOF CEILING** 

AS PER TABLE 700, S.B.C.

9. GENERAL CONTRACTOR RESPONSIBLE FOR INSTALLING SOLID BLOCKING BEHIND ALL SHELVING, CABINETS, ETC., OR EQUIPMENT

8. JOB SITE MEASUREMENTS ARE THE FULL RESPONSIBILITY OF THE

### EDITION W/ ADDENDUMS, 2012 FLORIDA FIRE PREVENTION

NO. OF STORIES

FIRE PROTECTION REQUIREMENTS

AS PER TABLE 600, F.B.C.			
STRUCTURAL	REQUIRED	PROPOSED	DESIGN
ELEMENT	RATING	RATING	NO.
INTERIOR BEARING WALLS	0	0	-
INTERIOR NON-BEARING WALLS	0	0	-
COLUMNS	0	0	-
BEAMS, GIRDERS, TRUSSES	0	0	-

EXTERIOR BEARING WALLS FIRE PROTECTION REQUIREMENTS: FIRE RESISTANCE PARTITIONS

**VERTICAL SHAFTS:** 

2 HR **OCCUPANCY SEPARATIONS:** 2 HR **TENANT SEPARATIONS:** 

# INDEX OF DRAWINGS

	ARCHITECTURE BUILDING 2
Sheet Number	Sheet Name
A0.1	TITLE SHEET
A0.2	SITE PLAN
A0.3	PRODUCT APPROVAL
A0.4	PRODUCT APPROVAL
A0.5	PRODUCT APPROVAL
A0.6	PRODUCT APPROVAL
A0.7	PRODUCT APPROVAL
A1.1	BUILDING PLANS
A1.2	ROOF PLANS
A2.1	ELEVATIONS
A2.2	SECTIONS
A2.3	SECTIONS
A3.1	SCHEDULES
A4.1	EXTERIOR DETAILS
A4.2	EXTERIOR DETAILS
A4.3	DOOR & WINDOW DETAILS
A5.1	PLAN A1
A5.2	PLAN B1
A6.1	INTERIOR DETAILS
A6.2	UL ASSEMBLIES



10180 Lexington Estates Blvd Boca Raton, FL 33428

T 561.923.0745 C 561.414.6729

12/10/20

AR 008071

Civil Engineer

Consultant 1680 SE 4th St Address

Deerfield Beach, FL 33441 (954) 260-6194

johnjhaley@comcast.net

Structural Engineer MBV Engineering, Inc

1835 20th Street Address Address Vero Beach, FL 33960 (772) 569-0035

rodolfov@mbveng.com

Mechanical Engineer Consultant Stoffer & Associates, Inc.

10381 Hart Branch Circle Orlando, FL 33832

(407) 381-4555

stofengr@aol.com

Landscape Architect Consultant William A Flint III

1821 SW Palm City RD, #B302 Stuart, FL 34994 (772) 220-0424 Fax

Address

Number

**REVISION SCHEDULE** 

Revision Date

# **KEYNOTES**


A keynote system is used on the drawings for materials references and notes to keynote legend on the drawings for information which relates touch keynote symbol on the respective

Each keynote symbol consists of a 2-digit number followed by a period and a letter suffix. The 2-digit number relates to the specification section whichth generally covers the item that is referenced, and the 2-digit suffix identifies specific reference notation used on the drawing. The digit suffix does not

THE ORGANIZATION OF THE KEYNOTE SYSTEM ON THE DRAWINGS, WITH THE KEYNOTE REFERENCE NUMBERS RELATED TO THE SPECIFICATIONS SECTIONS NUMBERING SYSTEM, SHALL NOT CONTROL SUBCONTRACTORS OR IN ESTABLISHING THE EXTENT OF WORK TO BE PERFORMED BY ANY TRADE.

**PREFIX** 

### **SYMBOLS ABBREVIATIONS** ADJUSTABLE ALUMINUM NUMBER NOT TO SCALE

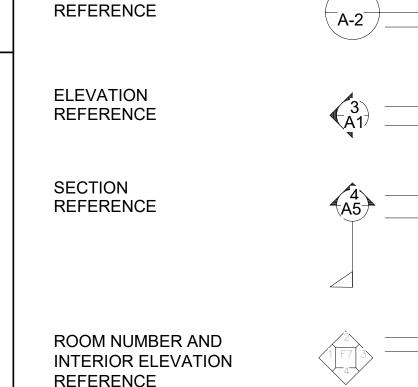

REFERENCE

REFERENCE

WINDOW

REFERENCE

REFERENCE

REVISION

REFERENCE

DOOR

**SECTION NUMBER** WALL NUMBER INTERIOR ELEV. SHEET NUMBER

6,340 SQ.FT.

**DETAIL NUMBER** 

SHEET NUMBER

SHEET NUMBER

REFERENCE

NUMBER

REVISION

NUMBER

ELEVATION NUMBER

**ROOM NUMBER** DOOR NUMBER WINDOW NUMBER

EQUAL EXHAUST EXPANSION EXTERIOR EXISTING FORCE AIR UNIT FIRE HOSE CABINET FLASHING FLUORESCENT FACE OF FINISH FOOT/FEET FOOTING GALVANIZED GLASS GRADE GYPSUM HOSE BIBB HOLLOW CORE HARDWOOD HARDWARE HOLLOW METAL INSIDE DIAMETER INTERIOR JANITOR

LOCATION

MAXIMUM MECHANICAL METAL MANUFACTURER

MINIMUM MISCELLANEOUS

APPROXIMATE

BUILDING BLOCK BLOCKING

BEAM BOTTOM

CLEAR COLUMN CONCRETE

CONNECTION CONTINUOUS

DECORATIVE

DIAMETER DIMENSION DOWN

DOWN SPOUT DRAWING

ELECTRICAL

PRESSURE TREATED QUARRY TILE REINFORCE ROOM ROUGH OPENING REDWOOD RAIN WATER LEADER SCHEDULE SHEET SIMILAR STAINLESS STEE SUSPENDED SYMMETRICAL U.O.N.

TOP OF LEDGER TOP OF PLATE UNLESS OTHERWISE NOTED VESTIBULE DOUGLAS FIR WATER CLOSET WATER HEATER

ON CENTER OUTSIDE DIAMETER

OPENING OPPOSITE

PLYWOOD

CONTRACTOR INSTALL OFFICE

TONGUE AND GROOVE TOP OF CHIMNEY


SYMBOLS


DIAMETER OR ROUND

JMC DELRAY, LLC FEDERICK ISLES, DELRAY BEACH, FL TITLE SHEET


**RIC 2007** Project number 12/10/20 Drawn by Checked by

1/8" = 1'-0" Scale

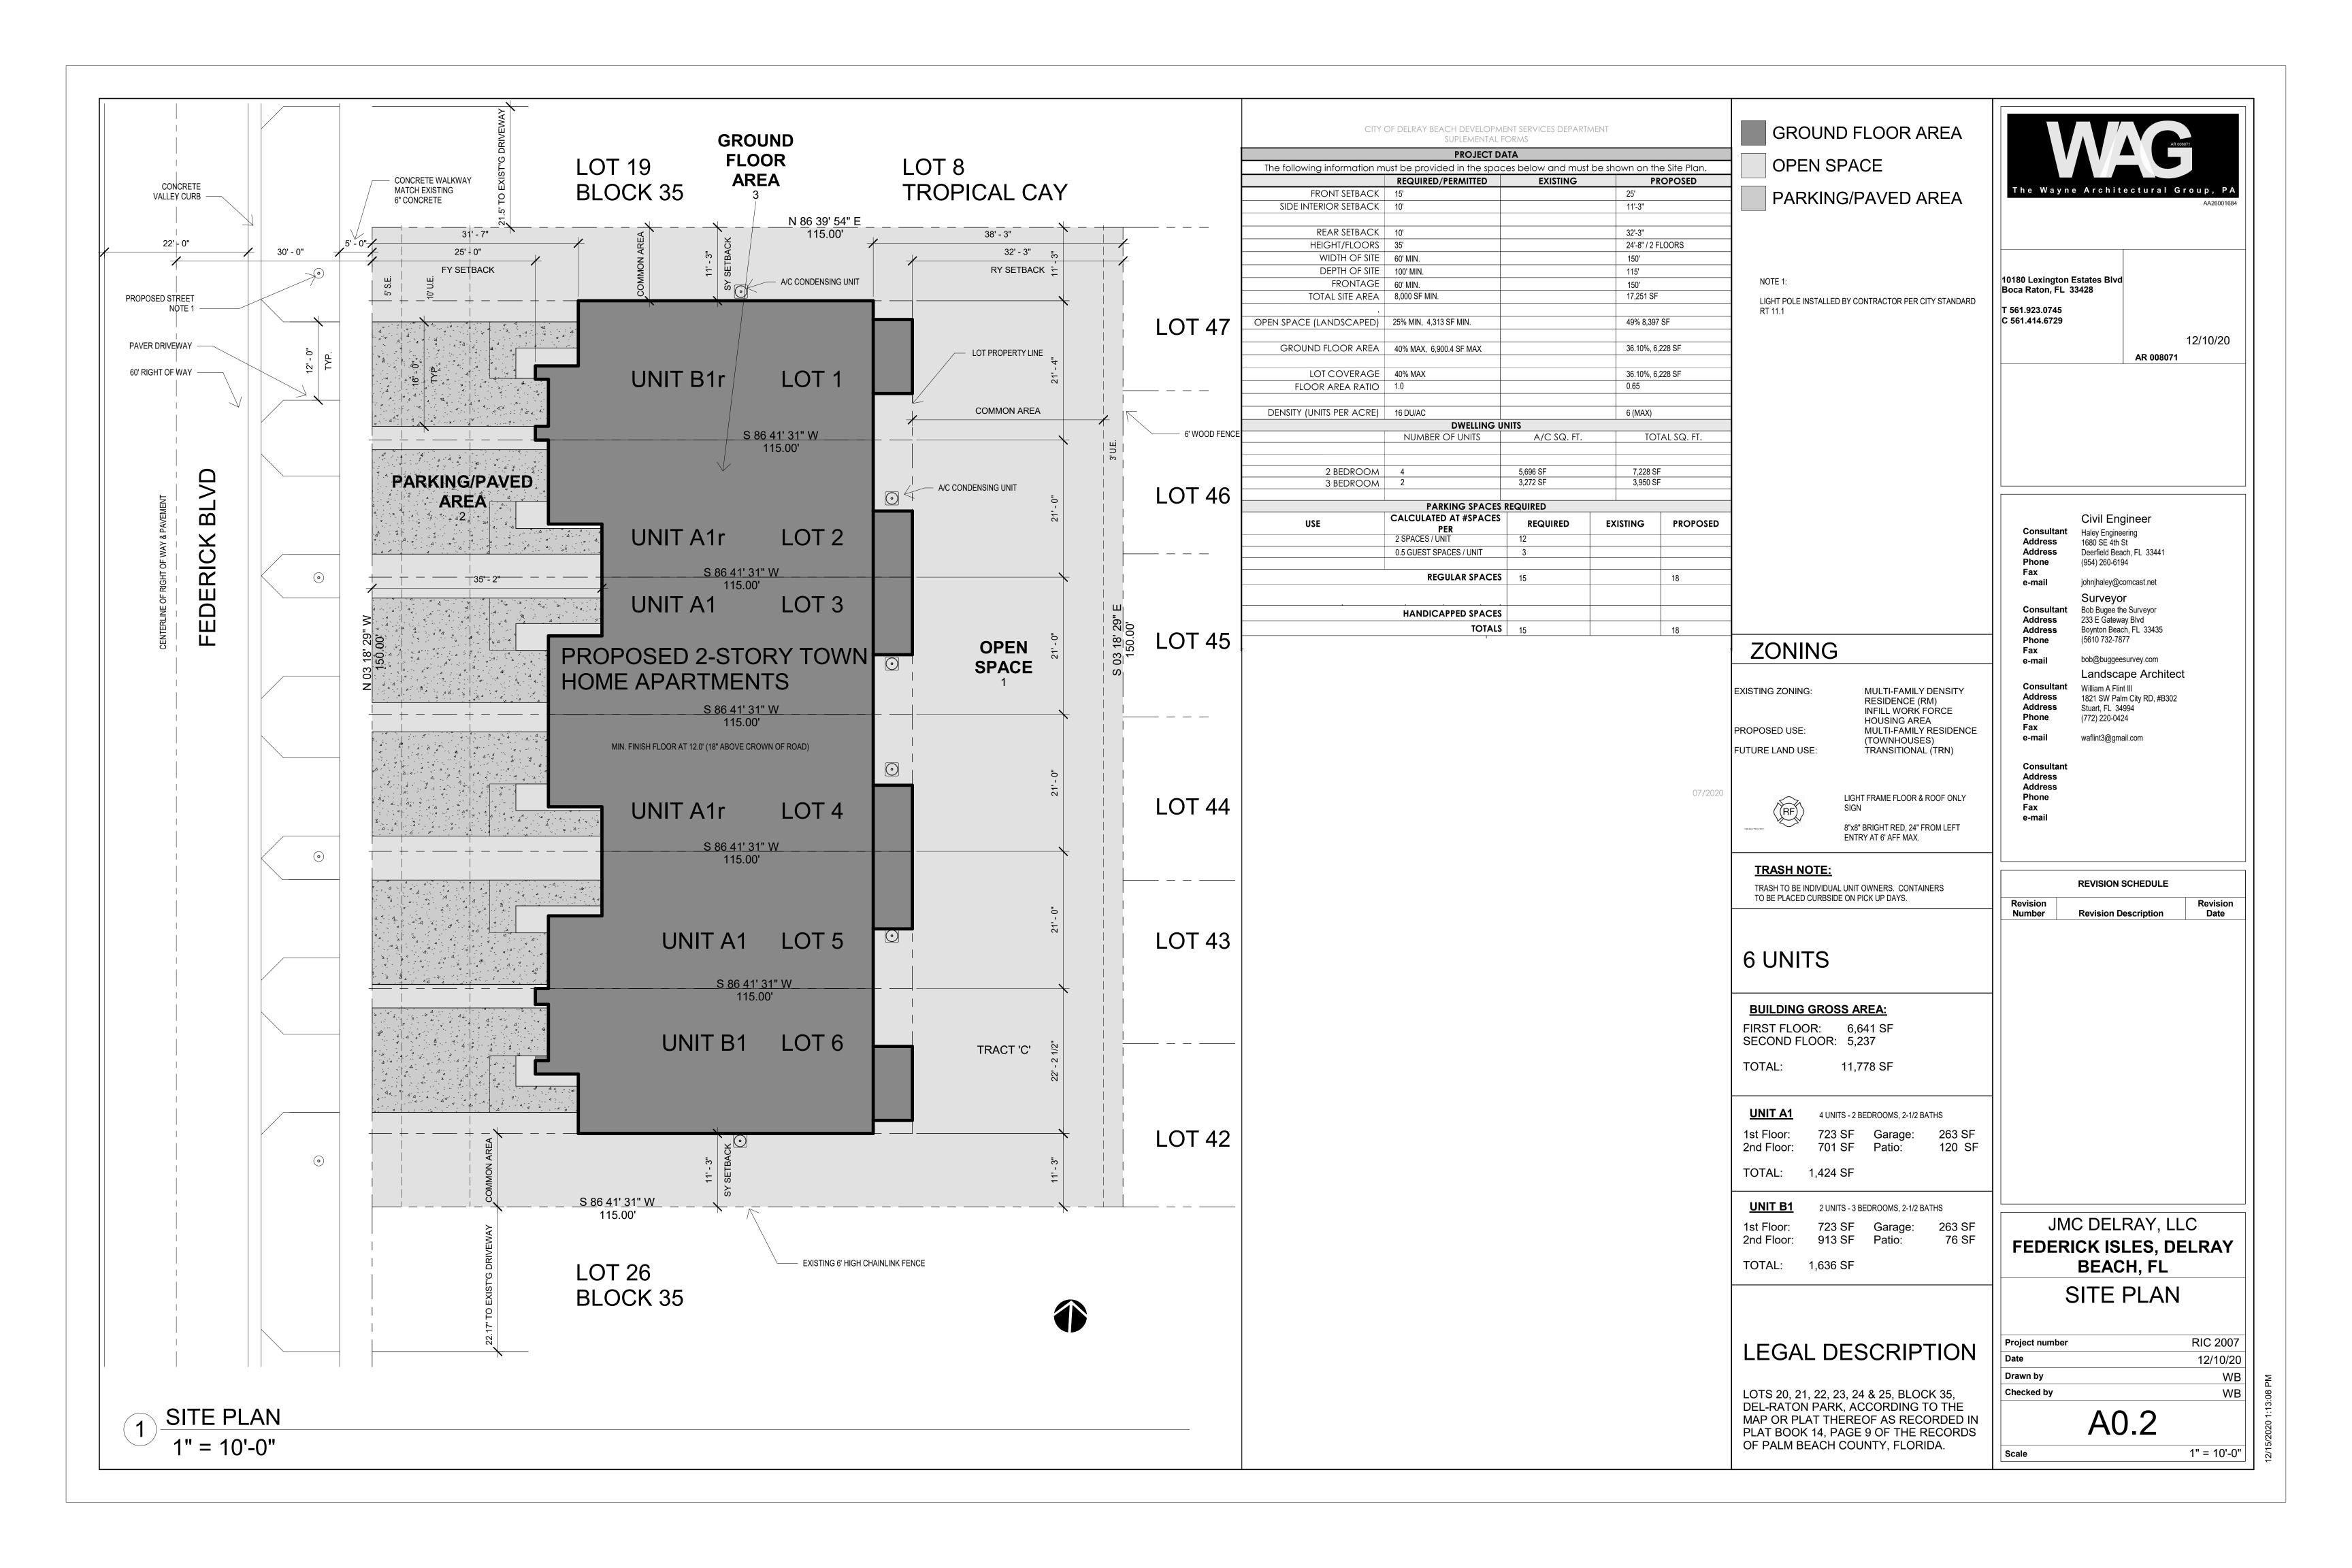

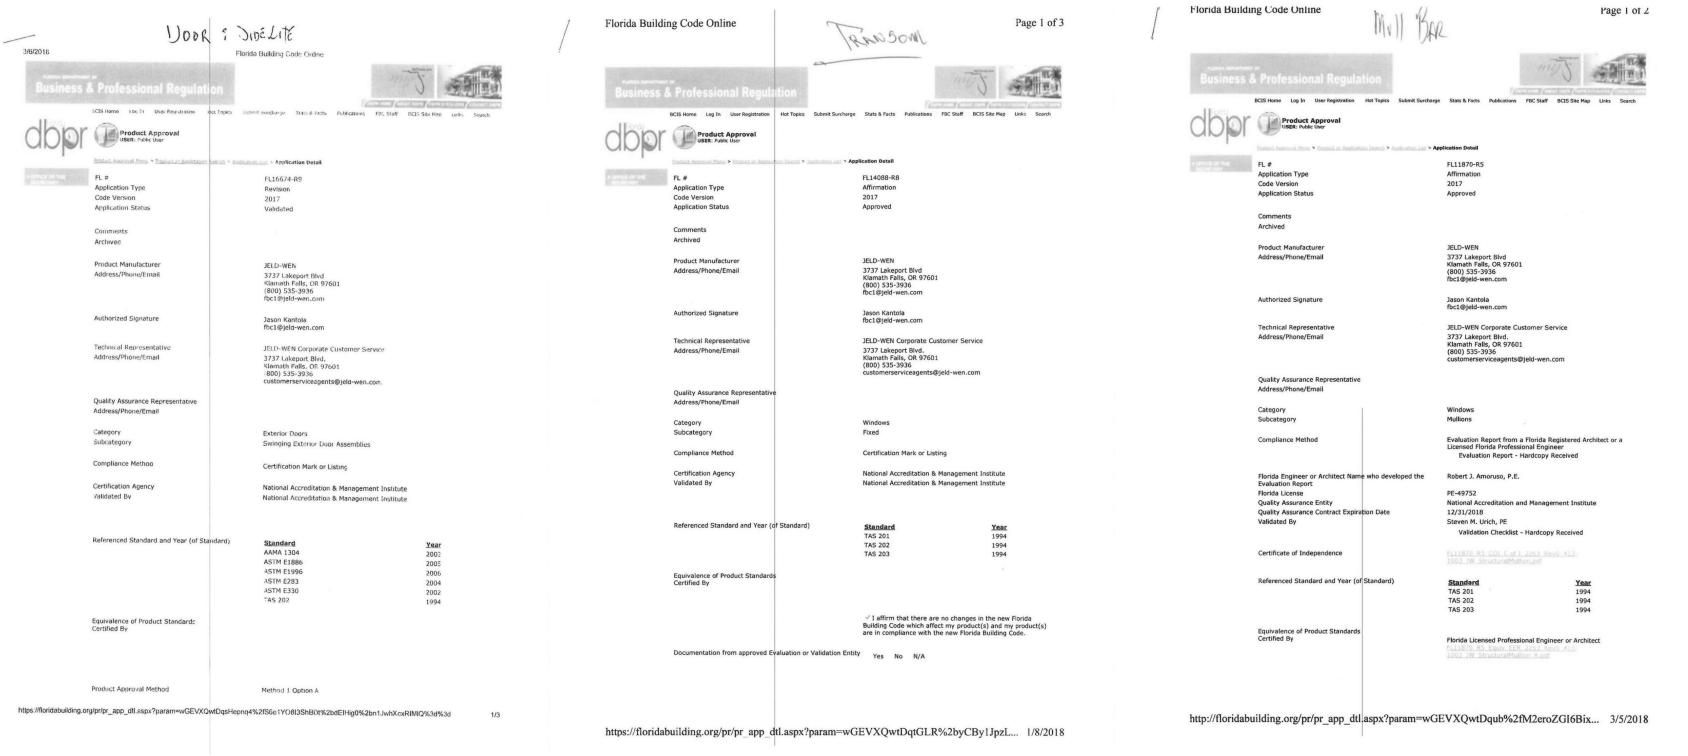

ENTRY DOOR

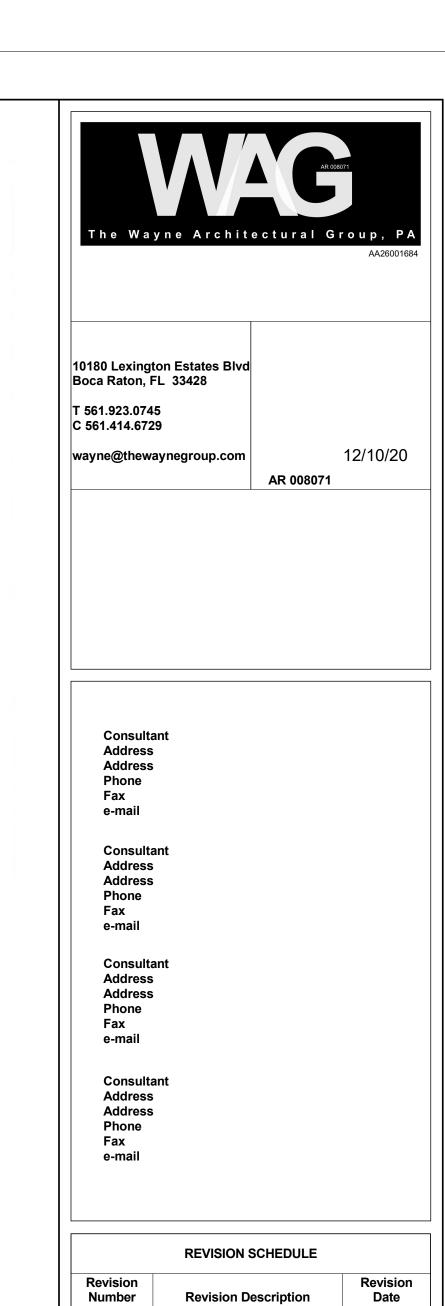

JMC DELRAY, LLC
FEDERICK ISLES, DELRAY
BEACH, FL
PRODUCT

APPROVAL

Project number RIC 2007

Date 12/10/20

Drawn by Author

Checked by Checker

A0.3

Test reports on: 1) Air Infiltration Test, per FBC, TAS 202-94

sealed by Idalmis Ortega, P.E.

2. Glazing complies with ASTM E1300-09

C. CALCULATIONS

D. QUALITY ASSURANCE

E. MATERIAL CERTIFICATIONS

expiring on 07/08/19.

2) Uniform Static Air Pressure Test, Loading per FBC TAS 202-94

3) Water Resistance Test, per FBC, TAS 202-94

4) Forced Entry Test, per FBC, TAS 202-94

Anchor verification calculations and structural analysis, complying with FBC 5th

Notice of Acceptance No. 16-1117.01 issued to Kuraray America, Inc. for their

"Trosifol® Ultraclear, Clear, and Color PVB Glass Interlayers" dated 01/19/17,

Expiration Date: August 17, 202

Miami-Dude Department of Regulatory and Economic Resources (RER).

E-1

Edition (2014), dated 07/16/17, prepared, signed and scaled by Francisco Hernandez,

4) Large Missile Impact Test, per FBC, TAS 201-94

5) Cyclic Wind Pressure Loading, per FBC, TAS 203-94

along with marked-up drawings and installation diagram of a 37" wide x 74-1/4" high

aluminum single hung window, prepared by Fenestration Testing Laboratory, Inc. Test

Report No. FTL-8861, dated 10/05/16, with Revision 1, dated 06/19/17, signed and

2. NEW EVIDENCE SUBMITTED

1. Drawing No. SH17-01, titled "Series 2000-2 Aluminum Single Hung Window

Miami-Dude Department of Regulatory and Economic Resources (RER)

Notice of Acceptance No. 17-1114.14 issued to Kuraray America, Inc. for their

Statement letter of conformance, complying with FBC 6<sup>th</sup> Edition (2017), and of no

E-2

"Trosifol® Ultraclear, Clear and Color PVB Glass Interlayers" dated 01/18/18,

financial interest, dated January 11, 2018, issued, signed and scaled by Francisco

Notice of Acceptance No. 17-0508.03, issued to Sunshine Windows Manufacturing, Inc. for their Series "2000-2" Aluminum Single Hung Window - L.M.I. approved on

Product Control Examine

Expiration Date: August 17, 2022 Approval Date: April 26, 2018

L.M.I.", sheets 1 through 6 of 6, dated 06/23/17, with revision #1 dated 12/28/17,

prepared by manufacturer, signed and sealed by Francisco Hemandez, P.E.

A. DRAWINGS

1. None

C. CALCULATIONS

None.

F. STATEMENTS

D. QUALITY ASSURANCE

E. MATERIAL CERTIFICATIONS

expiring on 07/08/19.

08/17/17 and expiring on 08/17/22.

Sunshine Windows Manufacturing, Inc.

Control Section (In Miami-Dade County) and/ or the AHJ (in areas other than Miami-Dade County) reserve the right to have this product or material tested for quality assurance purposes. If this product or material fails to perform in the accepted manner, the manufacturer will incur the expense of such testing and the AHJ may immediately revoke, modify, or suspend the use of such product or material within their jurisdiction. RER reserves the right to revoke this acceptance, if it is determined by Miami-Dade County Product Control Section that this product or material fails to meet the requirements of the applicable building code. This product is approved as described herein, and has been designed to comply with the Florida Building Code, including the High Velocity Hurricane Zone. DESCRIPTION: Series "2000-2" Aluminum Single Hung Window – L.M.I.

APPROVAL DOCUMENT: Drawing No. SH17-01, titled "Series 2000-2 Aluminum Single Hung Window L.M.I.", sheets 1 through 6 of 6, dated 06/23/17, with revision #1 dated 12/28/17, prepared by manufacturer, signed and sealed by Francisco Hernandez, P.E., bearing the Miami-Dade County Product Control Revision stamp with the Notice of Acceptance number and expiration date by the Miami-Dade County Product Control Section

MISSILE IMPACT RATING: Large and Small Missile Impact Resistant LABELING: Each unit shall bear a permanent label with the manufacturer's name or logo, city, state, model/series, and following statement: "Miami-Dade County Product Control Approved", unless otherwise

RENEWAL of this NOA shall be considered after a renewal application has been filed and there has been no change in the applicable building code negatively affecting the performance of this product. **TERMINATION** of this NOA will occur after the expiration date or if there has been a revision or change in the materials, use, and/ or manufacture of the product or process. Misuse of this NOA as an endorsemen of any product, for sales, advertising or any other purposes shall automatically terminate this NOA. Failure to comply with any section of this NOA shall be cause for termination and removal of NOA. ADVERTISEMENT: The NOA number preceded by the words Miami-Dade County, Florida, and followed by the expiration date may be displayed in advertising literature. If any portion of the NOA is displayed, then it shall be done in its entirety. INSPECTION: A copy of this entire NOA shall be provided to the user by the manufacturer or its distributors and shall be available for inspection at the job site at the request of the Building Official.

This NOA revises NOA# 17-0508.03 and consists of this page 1 and evidence pages E-1 and E-2, as well as The submitted documentation was reviewed by Manuel Perez, P.E.



MIAMI-DADE COUNTY

DEPARTMENT OF REGULATORY AND ECONOMIC RESOURCES (RER) BOARD AND CODE ADMINISTRATION DIVISION

Sunshine Windows Manufacturing, Inc.



NOA No. 18-0123.16 Expiration Date: August 17, 2022 Approval Date: April 26, 2018

SINGLE HUNG WINDOW

The Wayne Architectural Group, PA

10180 Lexington Estates Blvd

wayne@thewaynegroup.com

AR 008071

12/10/20

**REVISION SCHEDULE** Revision **Revision Description** Date

JMC DELRAY, LLC

FEDERICK ISLES, DELRAY BEACH, FL

> **PRODUCT APPROVAL**

**RIC 2007 Project number** 12/10/20 Drawn by Author Checked by Checker

Amarr Garage Doors

NOTICE OF ACCEPTANCE: EVIDENCE SUBMITTED

2. New Evidence submitted. A. DRAWINGS

None.

B. CALCULATIONS 1. None

C. QUALITY ASSURANCE Miami Dade Department of Regulatory and Economic Resources (RER).

D. MATERIAL CERTIFICATIONS

E. STATEMENTS

1. Statement letter of conformance to FBC 2017 (6th Edition) dated 09/11/17, prepared, signed and sealed by Thomas L. Shelmerdine, P.E.

This NOA revises NOA # 17-0517.11, expiring 10/04/22.

Ishaq I. Chanda, P.E. Product Control Examiner NOA No. 17-1010.28 Expiration Date: October 4, 2022 Approval Date: December 28, 2017

Amarr Garage Doors

NOTICE OF ACCEPTANCE: EVIDENCE SUBMITTED

1. Evidence submitted in previous files

A. DRAWINGS "Submitted under NOA # 13-0503.05" Drawing No. IRC-9518-165-26-I, titled "Model 950 Heritage and Model 655 Oak Summit (24ga) 1000, 2000 Short, Long, Flush and Oak Summit Panels", Sheets 1 through 3 of 3, dated 06/07/2007, with revision C dated 04/02/2013, prepared by Amarr Garage Doors, signed and sealed by Thomas L. Shelmerdine, P.E.

B. TESTS "Submitted under NOA # 12-0228.04" Test report on Evaluation of Painted or Coated Specimens Subjected to Corrosive

Environments per ASTM D1654 & ASTM B117, prepared by Architectural Testing, Inc., Test Report # A7420.01-106-18, dated 04/12/2011, signed and sealed by Joseph A. Reed, P.E. "Submitted under NOA # 12-0228.09"

Test report on Forced Entry Test per FBC, TAS 202-94, prepared by American Test Lab, Inc., Test Report # ATLNC 0912.01-11, dated 10/13/2011, signed and sealed by David W.

"Submitted under NOA # 07-0820.04"

3. Test report on 1) Uniform Static Air Pressure Test, per FBC TAS 202-94,
2) Large Missile Impact Test, per FBC TAS 201-94,

3) Cyclic Wind Pressure Test, per FBC TAS 203-94, along with marked-up drawings, prepared by American Test Lab, Inc., Report # ATLNC 0604.02-07, dated 06/30/07, signed and sealed by David W. Johnson, P.E.
 Test report on Tensile Test for 3 Samples per ASTM E 8, prepared by Hurricane Engineering & Testing Inc., Report # HETT-07-T735, dated 06/26/2007, signed

and sealed by Candido F. Font, P.E. C. CALCULATIONS "Submitted under NOA # 12-0228.04"

Anchor calculations prepared by Structural Solutions, P.A., dated 01/25/2012, signed and sealed by Thomas L. Shelmerdine, P.E.

D. QUALITY ASSURANCE 1. Miami-Dade Department of Regulatory and Economic Resources (RER)

E. MATERIAL CERTIFICATIONS

None.

F. STATEMENTS Statement letter of code conformance to the 5th edition (2014) FBC and no financial interest issued by Structural Solutions, PA., dated 05/08/2017, signed and sealed by Tomas L. Shelmerdine, P.E.

E -1

Ishaq L Chanda, P.E. Product Control Examiner NOA No. 17-1010.28 Approval Date: December 28, 2017

DEPARTMENT OF REGULATORY AND ECONOMIC RESOURCES (RER) BOARD AND CODE ADMINISTRATION DIVISION NOTICE OF ACCEPTANCE (NOA)

Amarr Garage Doors

165 Carriage Court Winston-Salem, NC 27105

SCOPE: This NOA is being issued under the applicable rules and regulations governing the use of construction materials. The documentation submitted has been reviewed and accepted by Miami-Dade County RER-Product Control Section to be used in Miami Dade County and other areas where allowed by the Authority Having Jurisdiction (AHJ).

This NOA shall not be valid after the expiration date stated below. The Miami-Dade County Product Control Section (In Miami Dade County) and/or the AHJ (in areas other than Miami Dade County) reserve the right to have this product or material tested for quality assurance purposes. If this product or material fails to perform in the accepted manner, the manufacturer will incur the expense of such testing and the AHJ may immediately revoke, modify, or suspend the use of such product or material within their jurisdiction. RER reserves the right to revoke this acceptance, if it is determined by Miami-Dade County Product Control Section that this product or material fails to meet the requirements of the applicable building code.

This product is approved as described herein, and has been designed to comply with the Florida Building Code,

including the High Velocity Hurricane Zone.

DESCRIPTION: Model 950 Heritage & 655 Oak Summit 1000, 2000 Steel Sectional Garage Door up to 18'-0" Wide (DP +42.0, -46.0 PSF) APPROVAL DOCUMENT: Drawing No. IRC-9518-165-26-I, titled "Model 950 Heritage and Model 655 Oak Summit (24ga) 1000, 2000 Short, Long, Flush and Oak Summit Panels", sheets 1 through 3 of 3, dated

06/07/2007, with revision C dated 04/02/2013, prepared by Amarr Garage Doors, signed and sealed by Thomas L. Shelmerdine, P.E., bearing the Miami-Dade County Product Control revision stamp with the Notice of Acceptance number and expiration date by the Miami-Dade County Product Control Section. MISSILE IMPACT RATING: Large and Small Missile Impact Resistant LABELING: A permanent label with the manufacturer's name or logo, 3800 Greenway Circle, Lawrence, Kansas,

model number, the positive and negative design pressure rating, indicate impact rated if applicable, installation instruction drawing reference number, approval number (NOA), the applicable test standards, and the statement reading 'Miami-Dade County Product Control Approved' is to be located on the door's side track, bottom angle, or inner surface RENEWAL of this NOA shall be considered after a renewal application has been filed and there has been no change

in the applicable building code negatively affecting the performance of this product.

The submitted documentation was reviewed by Ishaq I. Chanda, P.E.

TERMINATION of this NOA will occur after the expiration date or if there has been a revision or change in the materials, use, and/or manufacture of the product or process. Misuse of this NOA as an endorsement of any product, for sales, advertising or any other purposes shall automatically terminate this NOA. Failure to comply with any section of this NOA shall be cause for termination and removal of NOA. ADVERTISEMENT: The NOA number preceded by the words Miami-Dade County, Florida, and followed by the

expiration date may be displayed in advertising literature. If any portion of the NOA is displayed, then it shall be done INSPECTION: A copy of this entire NOA shall be provided to the user by the manufacturer or its distributors and shall be available for inspection at the job site at the request of the Building Official.

This NOA revises NOA # 17-0517.11 and consists of this page 1 and evidence page E-1 & E-2, as well as

NOA No. 17-1010.28 Expiration Date: October 4, 2022 Approval Date: December 28, 2017

MIAMI-DADE COUNTY PRODUCT CONTROL SECTION 11805 SW 26 Street, Room 208

Miami, Florida 33175-2474 T (786) 315-2599 F (786) 315-2599

www.miamidade.gov/economy

**GARAGE DOOR** 



10180 Lexington Estates Blvd Boca Raton, FL 33428

C 561.414.6729

T 561.923.0745

wayne@thewaynegroup.com

AR 008071

12/10/20

Consultant Address Address Phone Fax

e-mail Consultant Address Address Phone

Fax

e-mail Consultant Address Address Phone

Fax e-mail

Consultant Address Address Phone Fax

**REVISION SCHEDULE** 

Revision Date

JMC DELRAY, LLC FEDERICK ISLES, DELRAY BEACH, FL

> PRODUCT **APPROVAL**

RIC 2007 **Project number** 12/10/20 Drawn by Checker Checked by

A0.5

#### INSTALLATION

- 1. Shingles shall be installed in compliance with Roofing Application Standard RAS 115.
- 2. Flashing shall be in accordance with Roofing Application Standard RAS 115 3. The manufacturer shall provide clearly written application instructions.
- 4. Exposure and course layout shall be in compliance with Detail 'A', attached. 5. Nailing shall be in compliance with Detail 'B', attached.

#### LABELING

Shingles shall bear the imprint or identifiable marking of the manufacturer's name or logo, city and state of manufacturing facility, and following statement: "Miami-Dade County Product Control Approved" or the Miami-Dade County Product Control Seal as shown below.



#### **BUILDING PERMIT REQUIREMENTS**

- 1. Application for building permit shall be accompanied by copies of the following:
- 1.1 This Notice of Acceptance. 1.2 Any other documents required by the Building Official or the applicable code in order to properly evaluate the installation of this system.

EVIDENCE SUBMITTED		
<b>Test Agency</b>	<b>Test Identifier</b>	Test Name/Repor
Underwriters Laboratories,LLC	ASTM D3462	4787344101
Underwriters Laboratories, Inc.	ASTM D3462	11CA48924
Underwriters Laboratories, Inc	ASTM D3462	10CA21994

nderwriters Laboratories, Inc	ASTM D3462	10CA28717	07/26/1
nderwriters Laboratories, Inc.	ASTM D3462	05CA47541	11/10/0
nderwriters Laboratories, Inc.	ASTM D3462	06CA31580	11/30/0
RI Asphalt Technologies, Inc.	ASTM D3462	GAF-101-02-02	11/02/0
nderwriters Laboratories, Inc.	ASTM D3462	06NK05159	08/09/0
RI Asphalt Technologies, Inc.	ASTM D3462	GAF-098-02-02	11/08/0
nderwriters Laboratories, Inc.	ASTM D3462	02NK41809	08/11/0
nderwriters Laboratories, Inc.	ASTM D3462	03NK26444	10/17/0
enter for Applied Engineering	ASTM D3462	257989	05/13/9
nderwriters Laboratories, Inc.	TAS 107	01NK45803	04/13/9
nderwriters Laboratories, Inc.	TAS 107	06NK05159	08/09/0
nderwriters Laboratories, Inc.	TAS 107	04NK04273	02/20/0
nderwriters Laboratories, Inc.	TAS 107	05CA42840	11/11/0
nderwriters Laboratories, Inc.	TAS 107	02NK41811	11/11/0
nderwriters Laboratories, Inc.	TAS 107	03CA35209	10/17/0
nderwriters Laboratories, Inc.	TAS 107	04CA13850	08/30/0
enter for Applied Engineering	TAS 100	257989	04/01/9
RI Asphalt Technologies, Inc.	TAS 100	GAF-044-02-01	01/13/0
RI Asphalt Technologies, Inc.	TAS 100	GAF-098-02-01	11/08/0
RI Asphalt Technologies, Inc.	TAS 100	GAF-101-02-01	11/09/0
RI Asphalt Technologies, Inc.	TAS 100	GAF-116-02-02	03/23/0
RI Asphalt Technologies, Inc.	TAS-100	ELK-083-02-01	10/16/0
		ELK-084-02-01	10/15/0
		ELK-085-02-01	10/14/0
		ELK-086-02-01	10/24/0
		ELK-087-02-01	10/21/0
		ELK-088-02-01	10/16/0
		ELK-107-02-01	10/09/0

#### LIMITATIONS

NOA No.: 16-0811.11

Page 4 of 6

Expiration Date: 02/21/22

Approval Date: 02/09/17

1. Fire classification is not part of this acceptance; refer to a current Approved Roofing Materials Directory for

ELK-108-02-01

ELK-109-02-01

- fire ratings of this product. 2. Shall not be installed on roof mean heights in excess of 33 ft.
- 3. All products listed herein shall have a quality assurance audit in accordance with the Florida Building Code and Rule 61G20-3 of the Florida Administrative Code.

	DADE CO	LINITY
M	DADE CC	UNIT
	APPROVED	

#### ROOFING ASSEMBLY APPROVAL

Roofing
Asphalt Shingles
Laminate
Wood

#### **SCOPE**

07/25/16

10/24/11

04/22/11

10/09/03

NOA No.: 16-0811.11

Expiration Date: 02/21/22

Approval Date: 02/09/17

Page 3 of 6

This approves GAF Timberline HD®, Timberline® Natural Shadow®, Timberline American® Harvest®, and Fortitude<sup>TM</sup> Shingles as manufactured by GAF as described in this Notice of Acceptance.

1 of titude Similares as manarae	tured by Griff us de	serioca in tins 140	nee of receptance.
PRODUCT DESCRIPTION <u>Product</u>	<b>Dimensions</b>	Test Specifications	<b>Product Description</b>
GAF Timberline HD®  Manufacturing  Locations #1, 2, 3, 4, 5, 6, 7	13 <sup>1</sup> / <sub>4</sub> " x 39 <sup>3</sup> / <sub>8</sub> "	TAS 110	Fiberglass reinforced heavy weight asphalt roof shingle, with a laminate profile
GAF Timberline Natural Shadow® Manufacturing Locations #1, 2, 3, 4, 5, 6, 7	13 <sup>1</sup> / <sub>4</sub> " x 39 <sup>3</sup> / <sub>8</sub> "	TAS 110	Fiberglass reinforced heavy weight asphalt roof shingle, with a laminate profile
GAF Timberline® American Harvest® Manufacturing Locations #2, 4, 5, 6	13 <sup>1</sup> / <sub>4</sub> " x 39 <sup>3</sup> / <sub>8</sub> "	TAS 110	Fiberglass reinforced heavy weight asphalt roof shingle, with a laminate profile

#### MANUFACTURING LOCATION

- 1. Tampa, FL
- Michigan City, IN Baltimore, MD

GAF Fortitude<sup>TM</sup>

Manufacturing Locations #1, 4

- Myerstown, PA 5. Ennis, TX
- **6.** Tuscaloosa, AL 7. Dallas, TX





DETAIL B

OVERALL DIMENSIONS AND NAILING PATTERN

13-1/4"

14-1/2" - 17-1/2"

6-1/2" - 9-1/2"

6-1/2" - 9-1/2"

14-1/2" - 17-1/2"

6-1/2" - 9-1/2"

1/2" - 2-1/2"

(146mm - 159mm)

from bottom of shingle

ENHANCED NAILING PATTERN - six nails per shingle\*

\* required by some local codes and required for enhanced wind coverage on certain products See limited warranty for details.

These shingles MUST be nailed a nominal 6" (152mm) from bottom of of shingle, above the cut outs, as shown. Nails must not be exposed.

END OF THIS ACCEPTANCE

13 <sup>1</sup>/<sub>4</sub>" x 39 <sup>3</sup>/<sub>8</sub>" TAS 110 Fiberglass reinforced heavy weight asphalt

roof shingle, with a laminate profile

DEPARTMENT OF REGULATORY AND ECONOMIC RESOURCES (RER) BOARD AND CODE ADMINISTRATION DIVISION NOTICE OF ACCEPTANCE (NOA)

MIAMI-DADE COUNTY PRODUCT CONTROL SECTION 11805 SW 26 Street, Room 208 Miami, Florida 33175-2474 T (786) 315-2590 F (786) 315-2599 www.miamidade.gov/economy

1 Campus Drive Parsippany, NJ 07054

This NOA is being issued under the applicable rules and regulations governing the use of construction materials. The documentation submitted has been reviewed and accepted by Miami-Dade County RER - Product Control Section to be used in Miami Dade County and other areas where allowed by the Authority Having Jurisdiction (AHJ).

This NOA shall not be valid after the expiration date stated below. The Miami-Dade County Product Control Section (In Miami Dade County) and/or the AHJ (in areas other than Miami Dade County) reserve the right to have this product or material tested for quality assurance purposes. If this product or material fails to perform in the accepted manner, the manufacturer will incur the expense of such testing and the AHJ may immediately revoke, modify, or suspend the use of such product or material within their jurisdiction. RER reserves the right to revoke this acceptance, if it is determined by Miami-Dade County Product Control Section that this product or material fails to meet the requirements of the applicable building code.

This product is approved as described herein, and has been designed to comply with the Florida Building Code including the High Velocity Hurricane Zone of the Florida Building Code. DESCRIPTION: GAF Timberline HD®, Timberline® Natural Shadow®, Timberline® American Harvest®, and Fortitude™ Shingles

**LABELING:** Each unit shall bear a permanent label with the manufacturer's name or logo, city, state and following statement: "Miami-Dade County Product Control Approved", unless otherwise noted herein.

RENEWAL of this NOA shall be considered after a renewal application has been filed and there has been no change in the applicable building code negatively affecting the performance of this product. **TERMINATION** of this NOA will occur after the expiration date or if there has been a revision or change in the

materials, use, and/or manufacture of the product or process. Misuse of this NOA as an endorsement of any product,

for sales, advertising or any other purposes shall automatically terminate this NOA. Failure to comply with any section


ADVERTISEMENT: The NOA number preceded by the words Miami-Dade County, Florida, and followed by the expiration date may be displayed in advertising literature. If any portion of the NOA is displayed, then it shall be done in its entirety.

INSPECTION: A copy of this entire NOA shall be provided to the user by the manufacturer or its distributors and shall be available for inspection at the job site at the request of the Building Official.

This NOA renews and revises NOA # 14-1022.20 and consists of pages 1 through 6. The submitted documentation was reviewed by Alex Tigera.




of this NOA shall be cause for termination and removal of NOA.

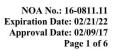


### SINGLE ROOF

#### **DETAIL A** COURSE LAYOUT

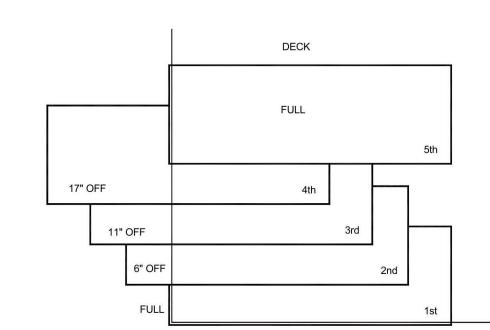

NOA No.: 16-0811.11 Expiration Date: 02/21/22 Approval Date: 02/09/17

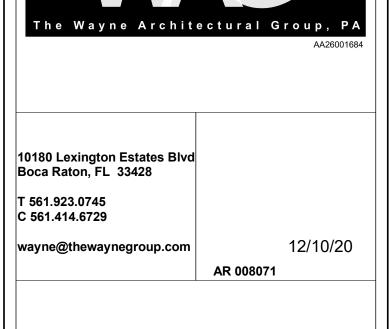

Consultant	
Address	
Address	
Phone	
Fax	
e-mail	
Consultant	
Address	
Address	
Phone	

e-mail Consultant Address Address Phone

e-mail Consultant Address Address Phone

Fax

Fax

**REVISION SCHEDULE** Revision **Revision Description** Number Date

### JMC DELRAY, LLC FEDERICK ISLES, DELRAY BEACH, FL

### PRODUCT **APPROVAL**

RIC 2007 **Project number** 12/10/20 Drawn by Author Checker Checked by

A0.6

Scale

NOA No.: 16-0811.11 Expiration Date: 02/21/22 Approval Date: 02/09/17

Page 6 of 6

#### APPROVED ASSEMBLIES: DMC 150 SS - 24Ga. Steel Panel 16" wide Panel Deck Type: Wood, Non-insulated Deck Description: New Construction 19/32" or greater plywood or wood plank. Slope Range: 2": 12" or greater See Maximum Design Pressures below Maximum Uplift In accordance with applicable Building Code, but in no case shall it be less than 8d annular ring shank nails spaced 6" o.c. In reroofing, where the deck is less than 19/32" thick (Minimum 15/32") The above attachment method must be in addition to existing attachment. Minimum underlayment shall be an ASTM D 226 Type II installed with a minimum 4" side-lap and 6" end-laps. Underlayment shall be fastened with corrosion resistant tin-caps and 12 gauge 1 1/4" annular ring-shank nails, spaced 6" o.c. at all laps and two staggered rows 12" o.c. in the field of the roll or any approved underlayment having a current NOA. Fire Barrier Board: Any approved fire barrier having a current NOA. Refer to a current fire directory listing for fire ratings of this roofing system assembly as well as the location of the fire barrier within the assembly. See Limitation # 1.

Valley construction shall be in compliance with Roofing Application Standard RAS 133 and with the current published installation instructions and details in DMC Association of Regional Manufacturers Installation Manual. Metal Panels and Install the "DMC 150 SS - 24Ga. Steel Panel 16" wide Panel" including flashing penetrations, valleys, end laps and accessories in compliance "DMC Association of Regional Manufacturers" current, published installation instructions and in compliance with the minimum requirements detailed in Roofing Application Standard RAS 133.

resistant #10 pancake head fasteners of sufficient length to penetrate through the sheathing a minimum of 3/16". The panel clips shall be located at the maximum spacing listed in Table A below.

MAXIMUM DESIGN PRESSURES	3
Field	Perimeter and Corner <sup>1</sup>
-99.25 psf	-114.25 psf
16" o.c.	12" o.c.
DMC 150SS Butterfly Clip	DMC 150SS Continuous Butterfl Clip
180°	180°
	-99.25 psf 16" o.c. DMC 150SS Butterfly Clip

NOA No.: 19-0304.03 Expiration Date: 06/26/2023 Approval Date: 10/10/2019 Page 4 of 11

Panels shall be secured along the male rib with approved clips fastened with two corrosion

TRADE NAMES OF PRODUCTS MANUFACTURED OR LABELED BY APPLICANT:

Dimensions	Test Specifications	Produc Descripti	33
N/A	TAS 110	Heavy duty construct	tion adhesive.
Tes	t Identifier	Test Name/Report	Date
AKZC-0	001-02-01 to 05	ASTM B 117	10/08/02
DMC	C-006-02-01	TAS 125	03/11/13
DMC	C-009-02-01	TAS 100	03/11/13
VLS	-015-02-01	ASTM B 117	05/15/18
VLS	-015-02-01	ASTM G 155	05/15/18
5684	2.02-122-18	TAS 100	06/08/05
028	7-0311-07	TAS 125	08/07/07
	N/A  Test  AKZC-0  DM0  DM0  VLS  VLS  5684	Specifications	N/A   TAS 110   Heavy duty construct    Test Identifier   Test Name/Report

NOA No.: 19-0304.03

Expiration Date: 06/26/2023 Approval Date: 10/10/2019

ROOFING SYSTEM APPROVAL: Sub-Category: Metal, Panels (Non-Structural) Wood

Material: Deck Type: Maximum Design Pressure -165.00 psf

TRADE NAMES OF PRODUCTS MANUFACTURED OR LABELED BY APPLICANT:

Product	Dimensions	Test Specifications	Product Description
DMC 150 SS = 24Ga. Steel Panel	Length: various Height: 1-1/2" Width: 16" Thickness 24 ga Min. Yield Strength: 50ksi.	TAS 110	Corrosion resistant, galvanized steel or galvalume standing seam metal panel.
DMC 150SS Butterfly Clip	Base: Length: 4.5" Height: 1-1/4" Width: 1" Thickness: 22ga Upper Clip: Length: 5.045" Height: 0.929" Width: 0.40" Thickness: 24ga		Two piece panel clip (base and upper clip) used for the field conditions of DMC 150 SS panel assembly System A.
DMC 150SS Continuous Butterfly Clip	Base: Length: 120" Height: 1-1/4" Width: 1" Thickness: 22ga Upper Clip: Length: 5.045" Height: 0.929" Width: 0.40" Thickness: 24ga		Two piece panel clip (base and upper clip) used for the perimeter and corner conditions of DMC 150 SS panel assembly System A.
24 ga. DMC 150SS Fixed Clip	Length: 2-1/4" Height: 1-5/8" Base Width: 15/16" Thickness: 24ga		One piece panel clip used for the field conditions of DMC 150 SS panel assembly <b>System B</b> .
22 ga. DMC 150SS Fixed Clip	Length: 6-1/4" Height: 1-5/8" Base Width: 3/4" Thickness: 22ga		One piece panel clip used for the perimeter and corner conditions of DMC 150 SS panel assembly <b>System B</b> .

NOA No.: 19-0304.03

Page 2 of 11

Expiration Date: 06/26/2023

Approval Date: 10/10/2019

Louisville, KY 40213

DEPARTMENT OF REGULATORY AND ECONOMIC RESOURCES (RER)

MIAMI-DADE COUNTY PRODUCT CONTROL SECTION 11805 SW 26 Street, Room 208 Miami, Florida 33175-2474 T (786) 315-2590 F (786) 315-2599 www.miamidade.gov/economy

NOTICE OF ACCEPTANCE (NOA) Drexel Metals, Inc. 1234 Gardiner Lane

This NOA is being issued under the applicable rules and regulations governing the use of construction materials. The documentation submitted has been reviewed and accepted by Miami-Dade County RER - Product Control Section to be used in Miami-Dade County and other areas where allowed by the Authority Having Jurisdiction (AHJ).

This NOA shall not be valid after the expiration date stated below. The Miami-Dade County Product Control Section (In Miami-Dade County) and/or the AHJ (in areas other than Miami-Dade County) reserve the right to have this product or material tested for quality assurance purposes. If this product or material fails to perform in the accepted manner, the manufacturer will incur the expense of such testing and the AHJ may immediately revoke, modify, or suspend the use of such product or material within their jurisdiction. RER reserves the right to revoke this acceptance, if it is determined by Miami-Dade County Product Control Section that this product or material fails to meet the requirements of the applicable building code. This product is approved as described herein, and has been designed to comply with the Florida Building Code

including the High Velocity Hurricane Zone of the Florida Building Code. DESCRIPTION: DMC 150 SS - 24Ga. Steel Panel over Plywood deck

LABELING: Each unit shall bear a permanent label with the manufacturer's name or logo, city, state and following statement: "Miami-Dade County Product Control Approved", unless otherwise noted herein.

RENEWAL of this NOA shall be considered after a renewal application has been filed and there has been no change in the applicable building code negatively affecting the performance of this product.

TERMINATION of this NOA will occur after the expiration date or if there has been a revision or change in the materials, use, and/or manufacture of the product or process. Misuse of this NOA as an endorsement of any product, for sales, advertising or any other purposes shall automatically terminate this NOA. Failure to comply with any section of this NOA shall be cause for termination and removal of NOA.

ADVERTISEMENT: The NOA number preceded by the words Miami-Dade County, Florida, and followed by the expiration date may be displayed in advertising literature. If any portion of the NOA is displayed, then it shall be done

INSPECTION: A copy of this entire NOA shall be provided to the user by the manufacturer or its distributors and shall be available for inspection at the job site at the request of the Building Official.

DMC 150 SS - 24Ga. Steel Panel 16" wide Panel

New Construction 19/32" or greater plywood or wood plank.

In accordance with applicable Building Code, but in no case shall it be less than 8d annular

ring shank nails spaced at a maximum distance specified below in **Table B**. In reroofing, where the deck is less than <sup>19</sup>/<sub>32</sub>" thick (Minimum <sup>15</sup>/<sub>32</sub>") The above attachment method must

Minimum underlayment shall be an ASTM D 226 Type II installed with a minimum 4" side-lap and 6" end-laps. Underlayment shall be fastened with corrosion resistant tin-caps and 12 gauge 1 ¼" annular ring-shank nails, spaced 6" o.c. at all laps and two staggered rows 12" o.c. in the field of the roll or any approved underlayment having a current NOA. Any approved fire barrier having a current NOA. Refer to a current fire directory listing for fire ratings of this roofing system assembly as well as the location of the fire barrier within

Valley construction shall be in compliance with Roofing Application Standard RAS 133 and with the current published installation instructions and details in DMC Association of

Install the "DMC 150 SS - 24Ga. Steel Panel 16" wide Panel" including flashing penetrations, valleys, end laps and accessories in compliance "DMC Association of Regional Manufacturers" current, published installation instructions and in compliance with

Panels shall be secured along the male rib with approved Panel clip listed below in Table B with two corrosion resistant #10 pancake head fasteners of sufficient length to penetrate through the sheathing a minimum of  $^{3}/_{16}$ ". The panel clips are to be placed at a spacing listed below in **Table B**. The female rib of panel is placed over the male/clip assembly and

the minimum requirements detailed in Roofing Application Standard RAS 133.

MAXIMUM DESIGN PRESSURES

Wood, Non-insulated

be in addition to existing attachment.

the assembly. See Limitation # 1.

seamed. See Detail B herein.

Regional Manufacturers Installation Manual.

2": 12" or greater See Table B below

This NOA revises NOA-NO. 18-1024.08 and consists of pages 1 through 11. The submitted documentation was reviewed by Freddy Semino



NOA No.: 19-0304.03 Expiration Date: 06/26/2023 Approval Date: 10/10/2019 The Wayne Architectural Group, PA

10180 Lexington Estates Blvd Boca Raton, FL 33428

C 561.414.6729 wayne@thewaynegroup.com

T 561.923.0745

12/10/20 AR 008071

Consultant Address Address Phone e-mail

Consultant Address Address Phone e-mail

> Consultant Address Address Phone Fax e-mail

Consultant Address Address Phone Fax

REVISION SCHEDULE

Revision Number Date

JMC DELRAY, LLC **FEDERICK ISLES, DELRAY** BEACH, FL

PRODUCT **APPROVAL** 

RIC 2007 **Project number** 12/10/20 Drawn by Author Checked by Checker

A0.7

Scale

STANDING SEAM METAL ROOF

DMC 150SS Continuous Butterfly Clip 24 GA, DMC 150SS FIXED CLIP 22 GA, DMC 150SS FIXED CLIP NOA No.: 19-0304.03 Expiration Date: 06/26/2023 Expiration Date: 06/26/2023 Approval Date: 10/10/2019

Approval Date: 10/10/2019

Page 8 of 11

Maximum Design Pressures lywood Fastener Spacing

Maximum Clip Spacing Bostik Seam Sealant

System B:

Deck Type:


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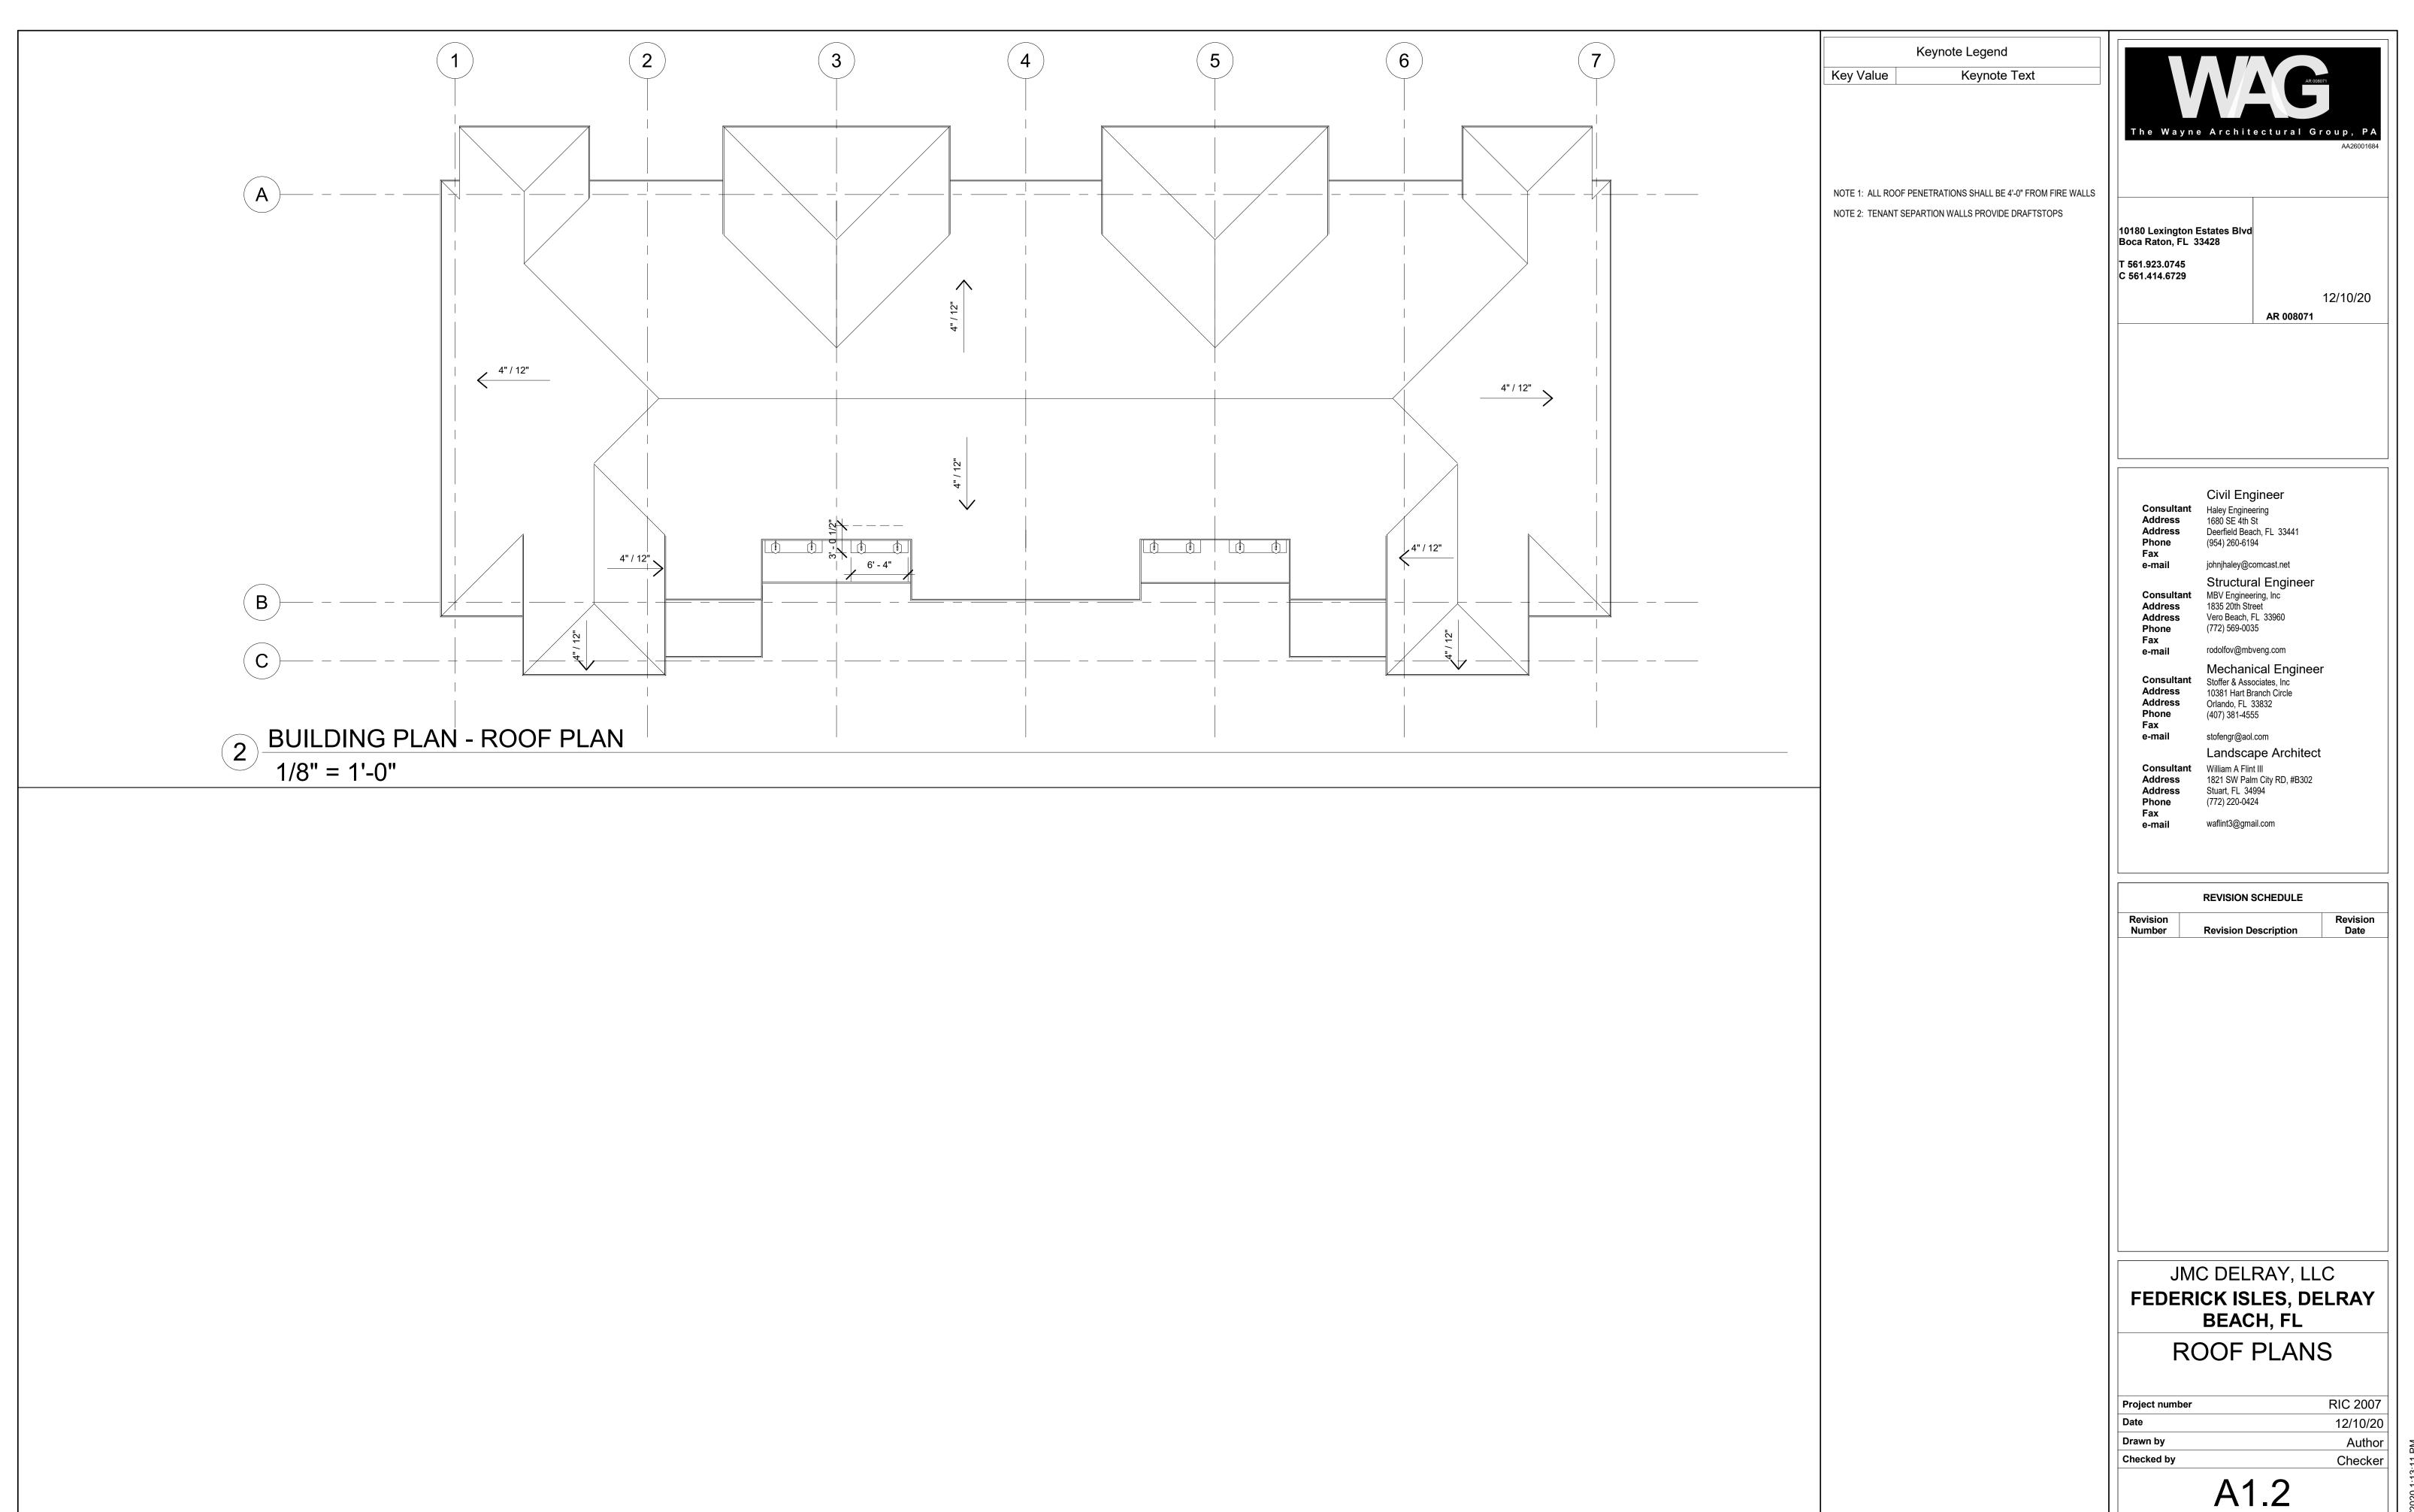
Deck Attachment:

Slope Range:

Pressure:


Expiration Date: 06/26/2023 Approval Date: 10/10/2019




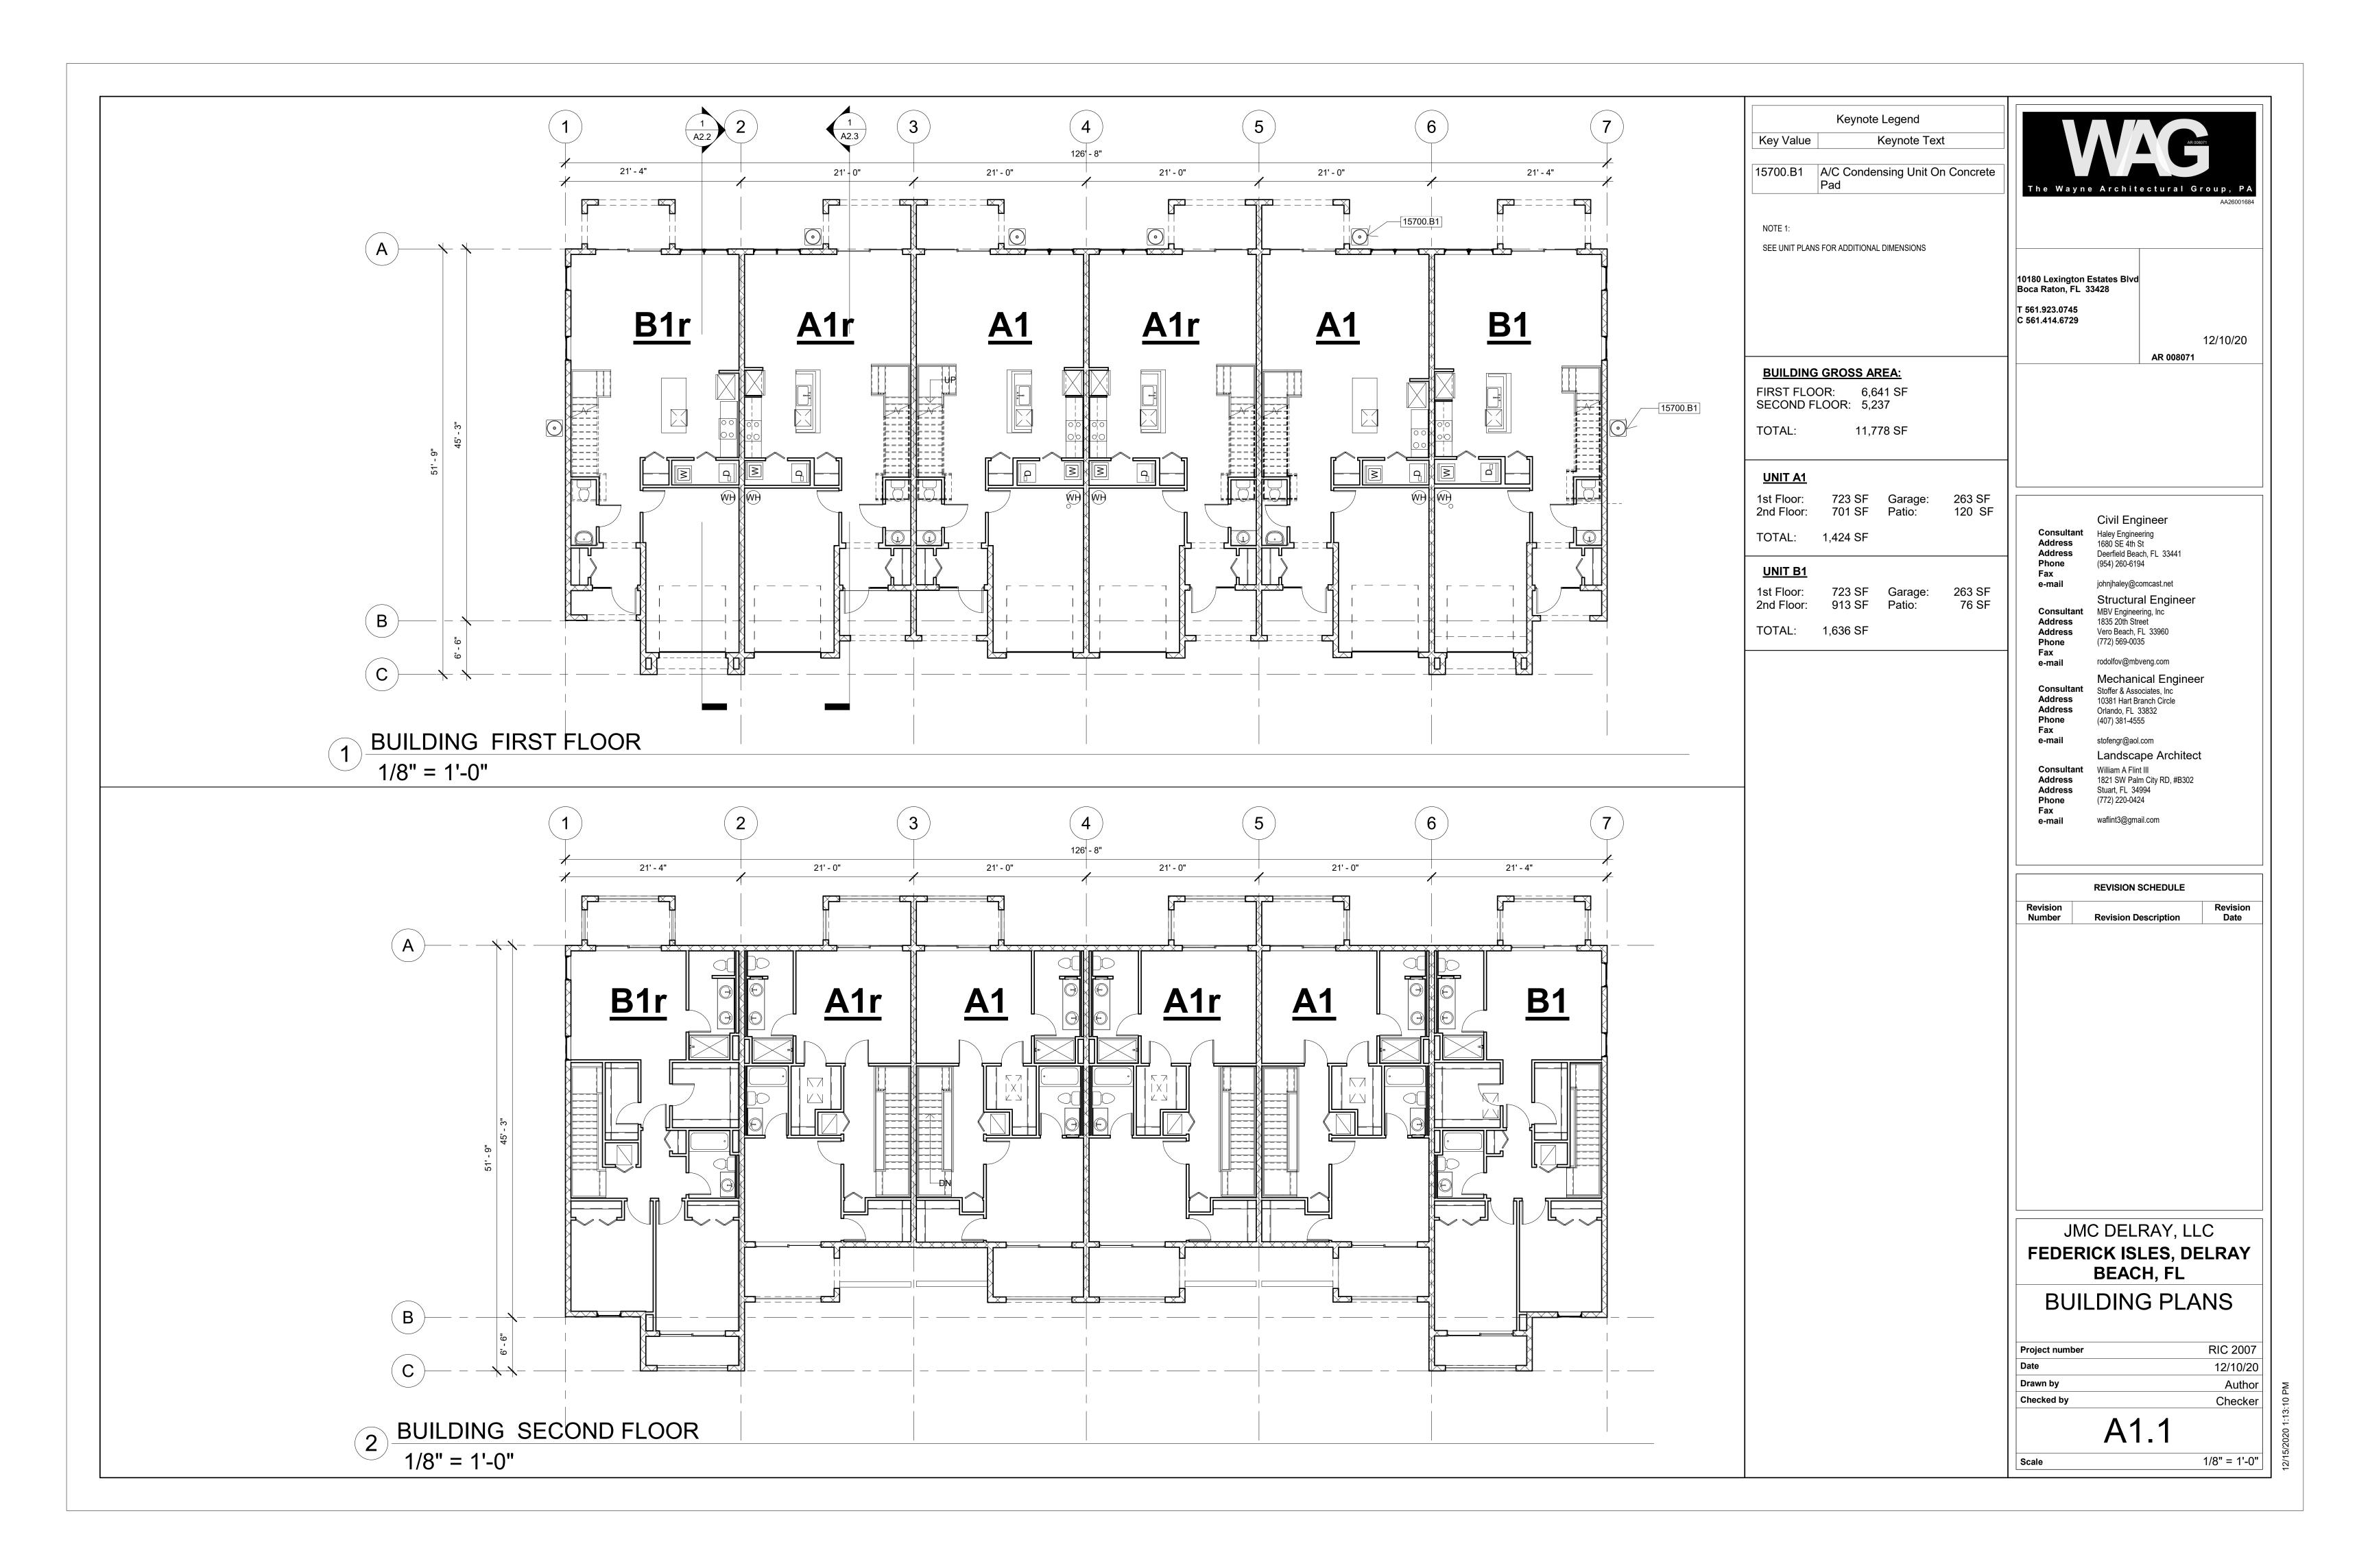

1/8" = 1'-0"



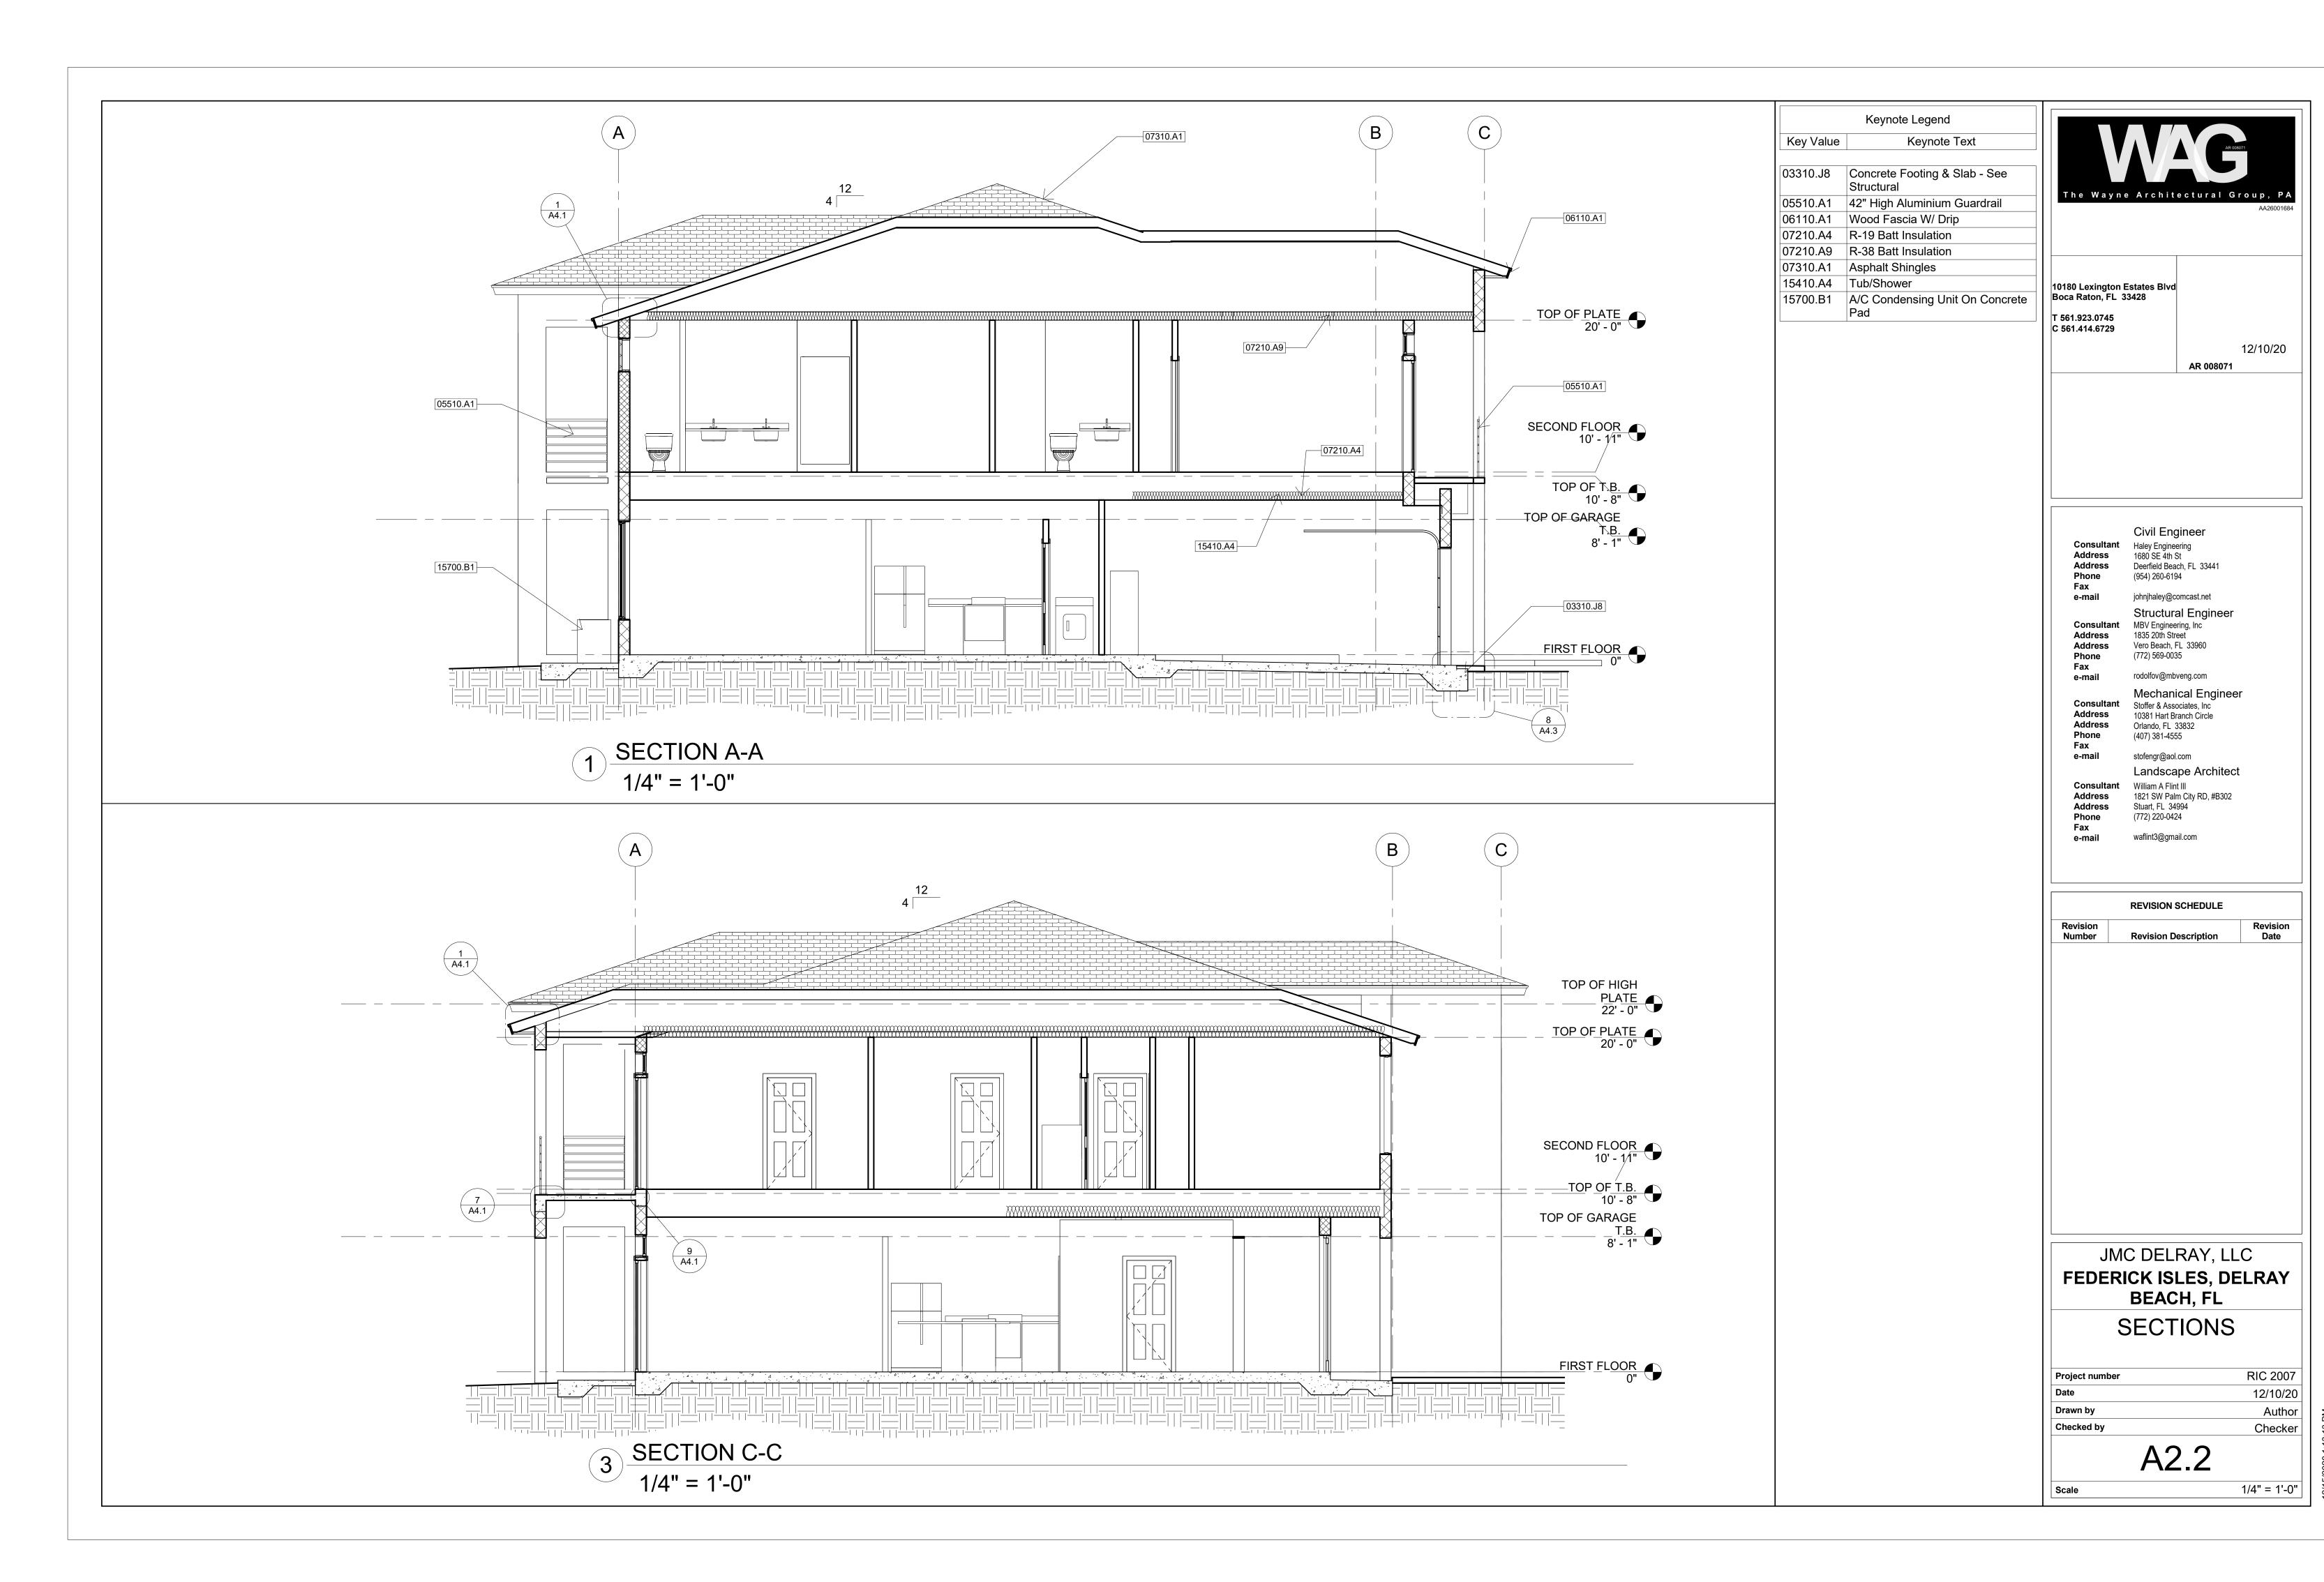

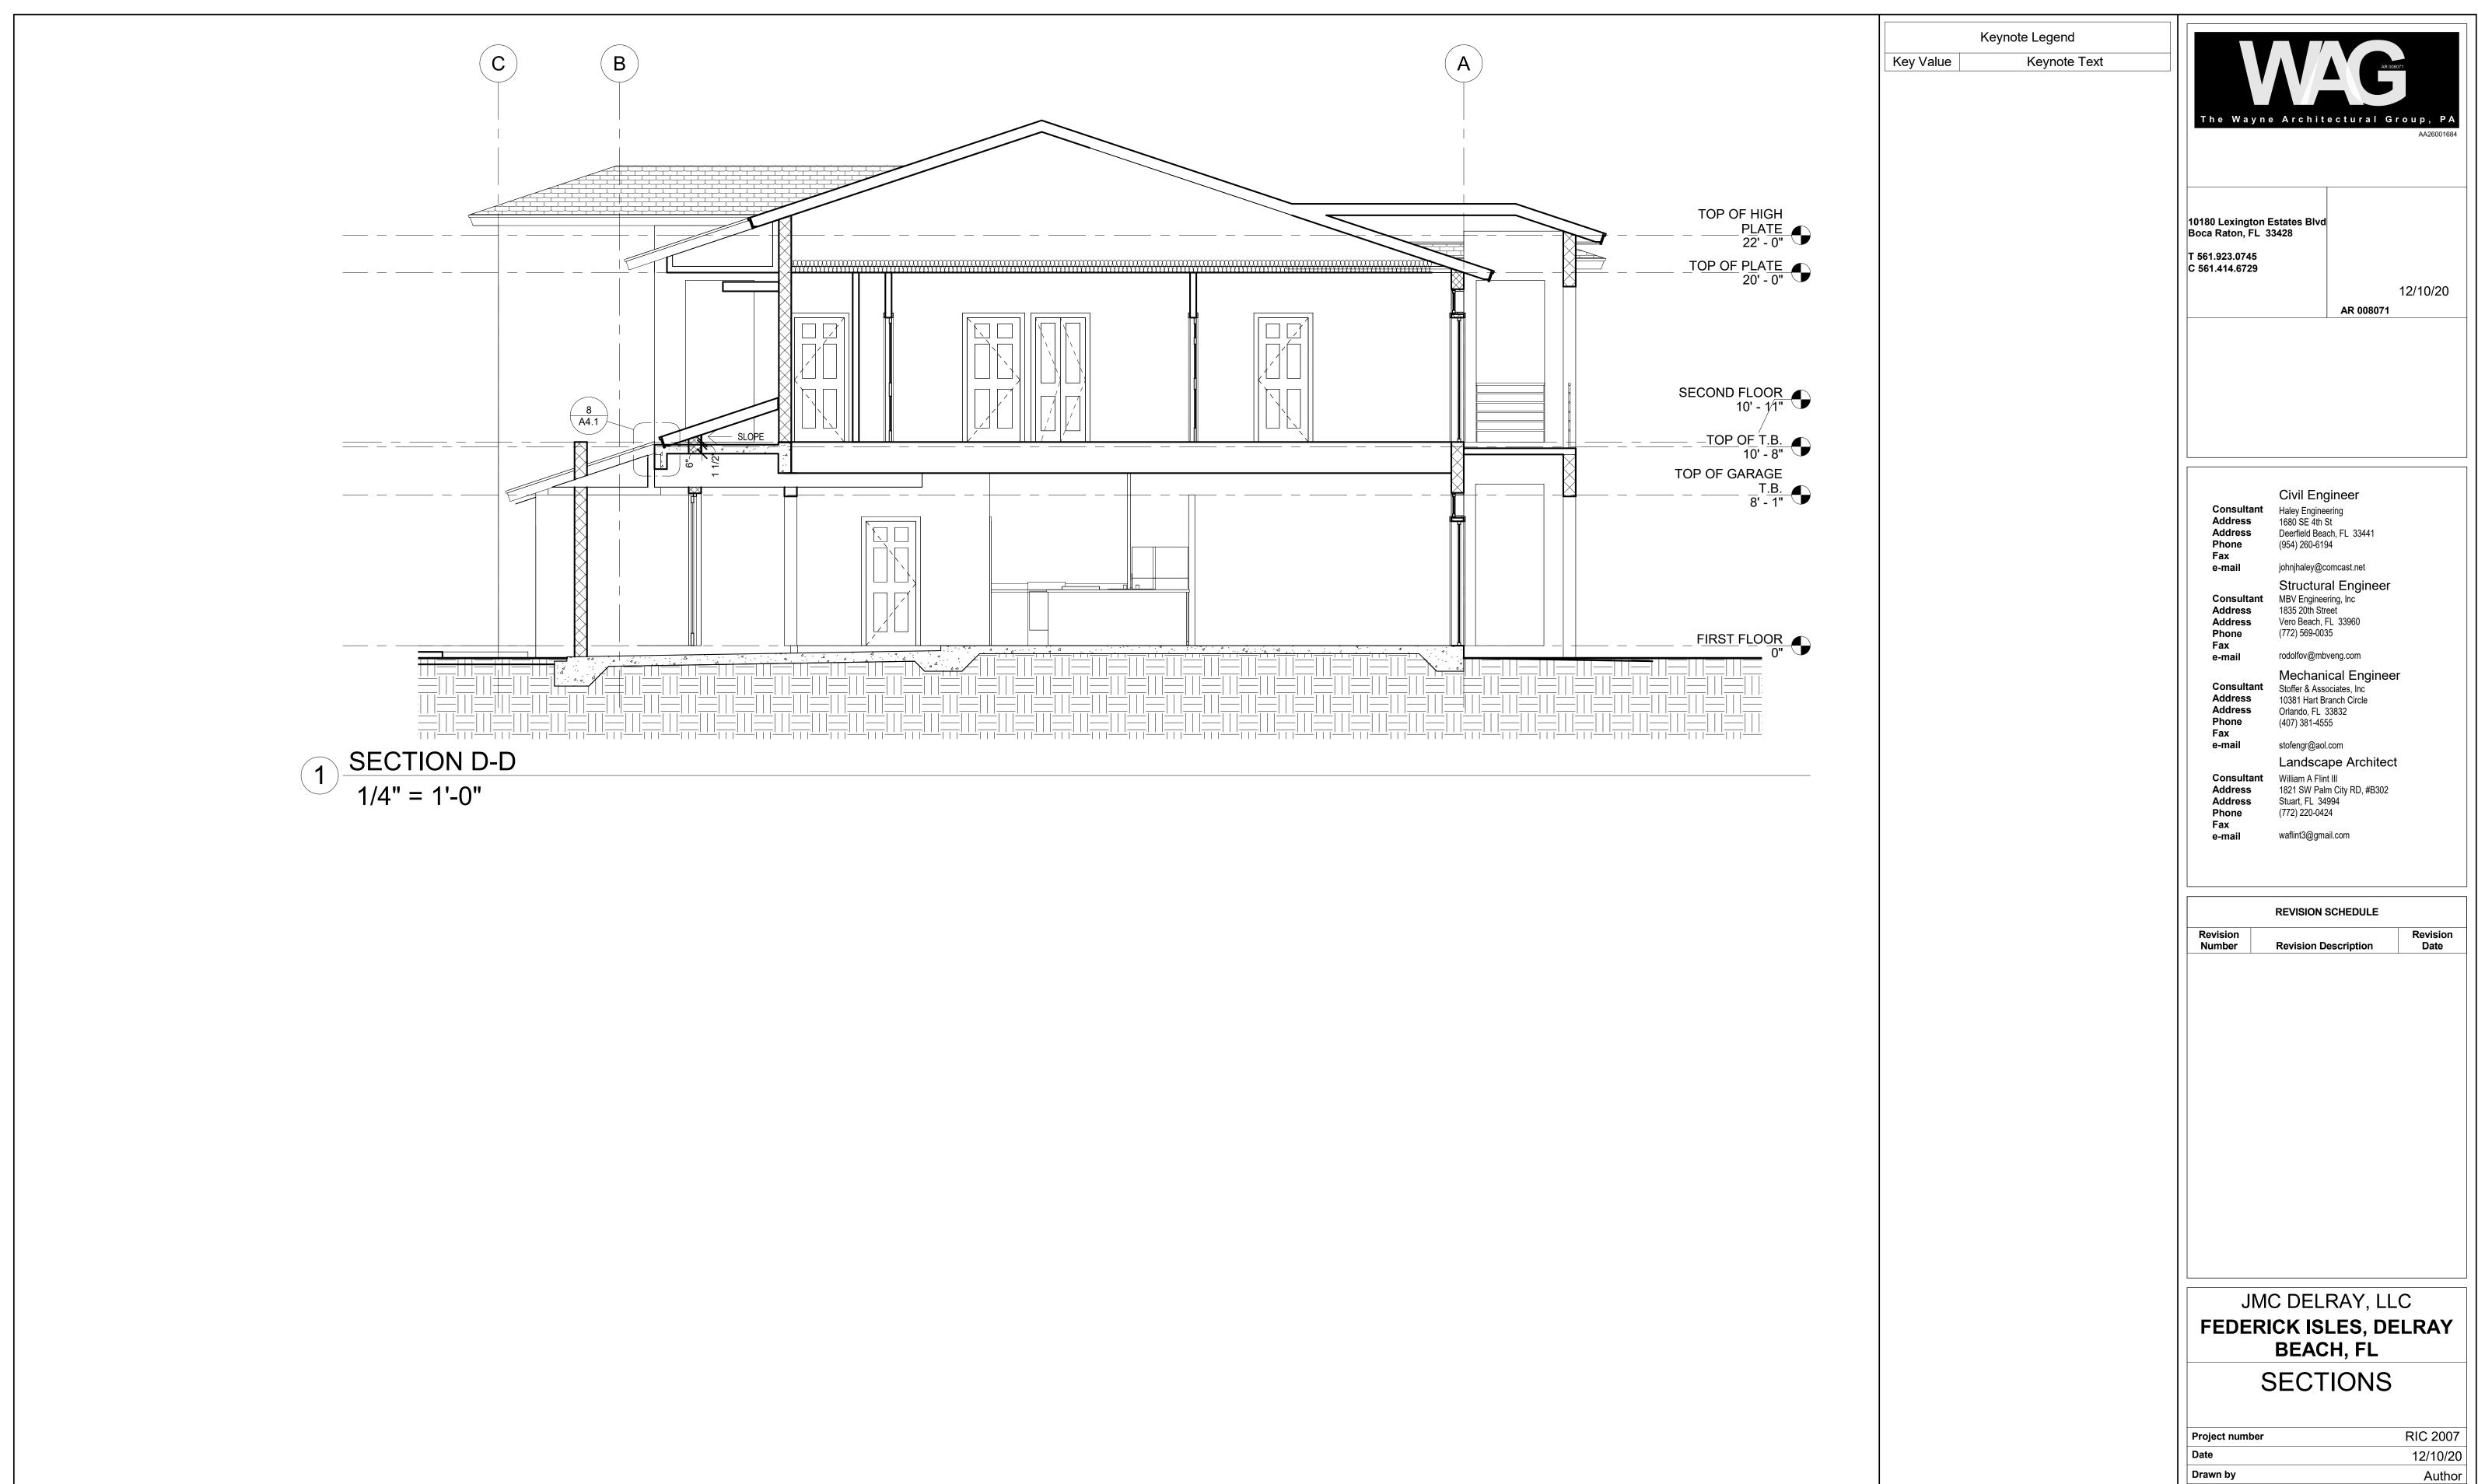

12/15/2020 1:13:14 PM

1/4" = 1'-0"

Checker

Checked by

Scale

A2.3

					WINDOW SC	HEDULE							DOOR SC	HEDULE		
Лark	Description	Window Type	Туре	WINE Width	OOW SIZE Height	Material	Comments	Ma	k Widt	DOOR SIZ		Door Type	Door Material	FRAME MATERIA		Comn
	Casement - Vent	1	3571	2' - 11"	5' - 11"	Alum	Egrees at Bedrooms	1	3' - 0"	8' - 0"	2"	F	Alum	WD	Self Closer	
	Unit Fixed	2	24" x 24"	2' - 0"	2' - 0"	Alum			8' - 0"	7' - 0"	1 1/2"	С	Alum	WD		
	Fixed		96" x 16"	8' - 0"	1' - 4"	Alum		4  5	2' - 8" 2' - 10"	6' - 8" 6' - 8"	1 1/2" 1 1/2"	D A	HC WD	DW WD		
	- indu		- X 10			7 110111		<mark>5</mark>	2' - 8"	6' - 8"	1 1/2"	A	HC WD	WD		
								7	5' - 0"	6' - 8"	1 1/2"	E	HC WD	DW		
NOT								8	2' - 8"	6' - 8"	1 1/2"	D	HC WD	DW		
THAT	ERAL CONTRACTOR SHALL VERIFY FALL ESCAPE OR RESCUE WINDO\	WS SHALL HAVE A MIN	NIMUM NET					9	2' - 6"	6' - 8"	1 1/2"	D	HC WD	DW		
CLEA	AR OPENABLE AREA OF 5.7 SQUAR NABLE HEIGHT DIMENSION SHALL I	RE FEET. THE MINIMUM	M CLEAR					10	2' - 10" 8' - 0"	6' - 8" 6' - 8"	1 1/2" 2"	B	HC WD Alum	WD WD		
	<u>TE 2:</u> WINDOW OPENINGS IMPACT GLASS		ARCHITECT.													
<u>NOT</u> ALL V											- IMPACT GLASS			I OUVER	RFD AT	
											- IMPACT GLASS			LOUVER	RED AT AHU	IMPACT. GLA
											- IMPACT GLASS			LOUVER		IMPACT. GLAS
				3					A		- IMPACT GLASS		C			IMPACT. GLA
	WINDOW OPENINGS IMPACT GLASS	S 2		3						RTYPE	B		C		AHU —	
	WINDOW OPENINGS IMPACT GLASS	s 2 TYPES		3					DOC	R TYPE = 1'-0"	B		C		AHU —	

Number	Name	Room				
		Base Finish	Floor Finish	Wall Finish	Ceiling Finish	Comments
01	ENTRY	B-1	F-2	P-1	C-1	
02	GARAGE		F-3	P-1	C-1	
03	POWDER					
04	KITCHEN	B-1	F-2	P-2	C-1	
05	<b>GREAT ROOM</b>	B-1	F-1	P-1	C-1	
06	PATIO					
07	HALL	B-1	F-1	P-1	C-1	
08	MASTER BEDROOM	B-1	F-1	P-1	C-1	
09	MBA	B-1	F-2	P-2	C-1	
010	TOILET	B-1	F-2	P-2	C-1	
011	W.I.C.	B-1	F-1	P-1	C-1	
012	BATH 2	B-1			C-1	
013	BEDROOM 2	B-1	F-1	P-1	C-1	
014	BEDROOM 3	B-1	F-1	P-1	C-1	
015	LAUNDRY	B-1	F-2	P-2	C-1	
016	DECK		F-4	P-3	C-2	



10180 Lexington Estates Blvd Boca Raton, FL 33428

T 561.923.0745 C 561.414.6729

12/10/20

AR 008071

Civil Engineer

Phone Fax

Consultant Haley Engineering
Address 1680 SE 4th St
Address Deering 33441 (954) 260-6194

johnjhaley@comcast.net Structural Engineer
Consultant MBV Engineering, Inc
Address 1835 20th Street Vero Beach, FL 33960

Address Phone (772) 569-0035 rodolfov@mbveng.com e-mail

Mechanical Engineer Consultant Stoffer & Associates, Inc Address 10381 Hart Branch Circle Address Orlando, FL 33832 Phone (407) 381-4555

stofengr@aol.com Landscape Architect Consultant William A Flint III

Address 1821 SW Palm City RD, #B302 Address Stuart, FL 34994 Phone Fax (772) 220-0424

Fax

FLOORING

F-3 SEALED CONCRETE

F-4 DEKOTEX FLOORING

BASE B-1 WOOD BASE, PAINTED

PEEL P-3 PAINTED EXTERIOR PLASTER

CEILING
C-1 GYP BD W/ KNOCK DOWN FINISH
C-2 PAINTED EXTERIOR PLASTER

INTERIOR FINISHES

WALLS AND CEILINGS SHALL MAINTAIN A MINIMUM OF A "C" RATING PER NFPA 101

PAINT

F-1 CARPET W/ PAD OR TBD BY OWNER
F-2 CERAMIC TILE, UNGLAZED OR TBD BY OWNER

P-1 GYP BD, PAINTED, ORANGE PEEL
P-2 WATER RESISTANT GYP BD, PAINTED ENAMEL, ORANGE

Revision Date Revision Number **Revision Description** 

**REVISION SCHEDULE** 

JMC DELRAY, LLC FEDERICK ISLES, DELRAY BEACH, FL


SCHEDULES


RIC 2007 Project number 12/10/20 Drawn by Author Checked by Checker


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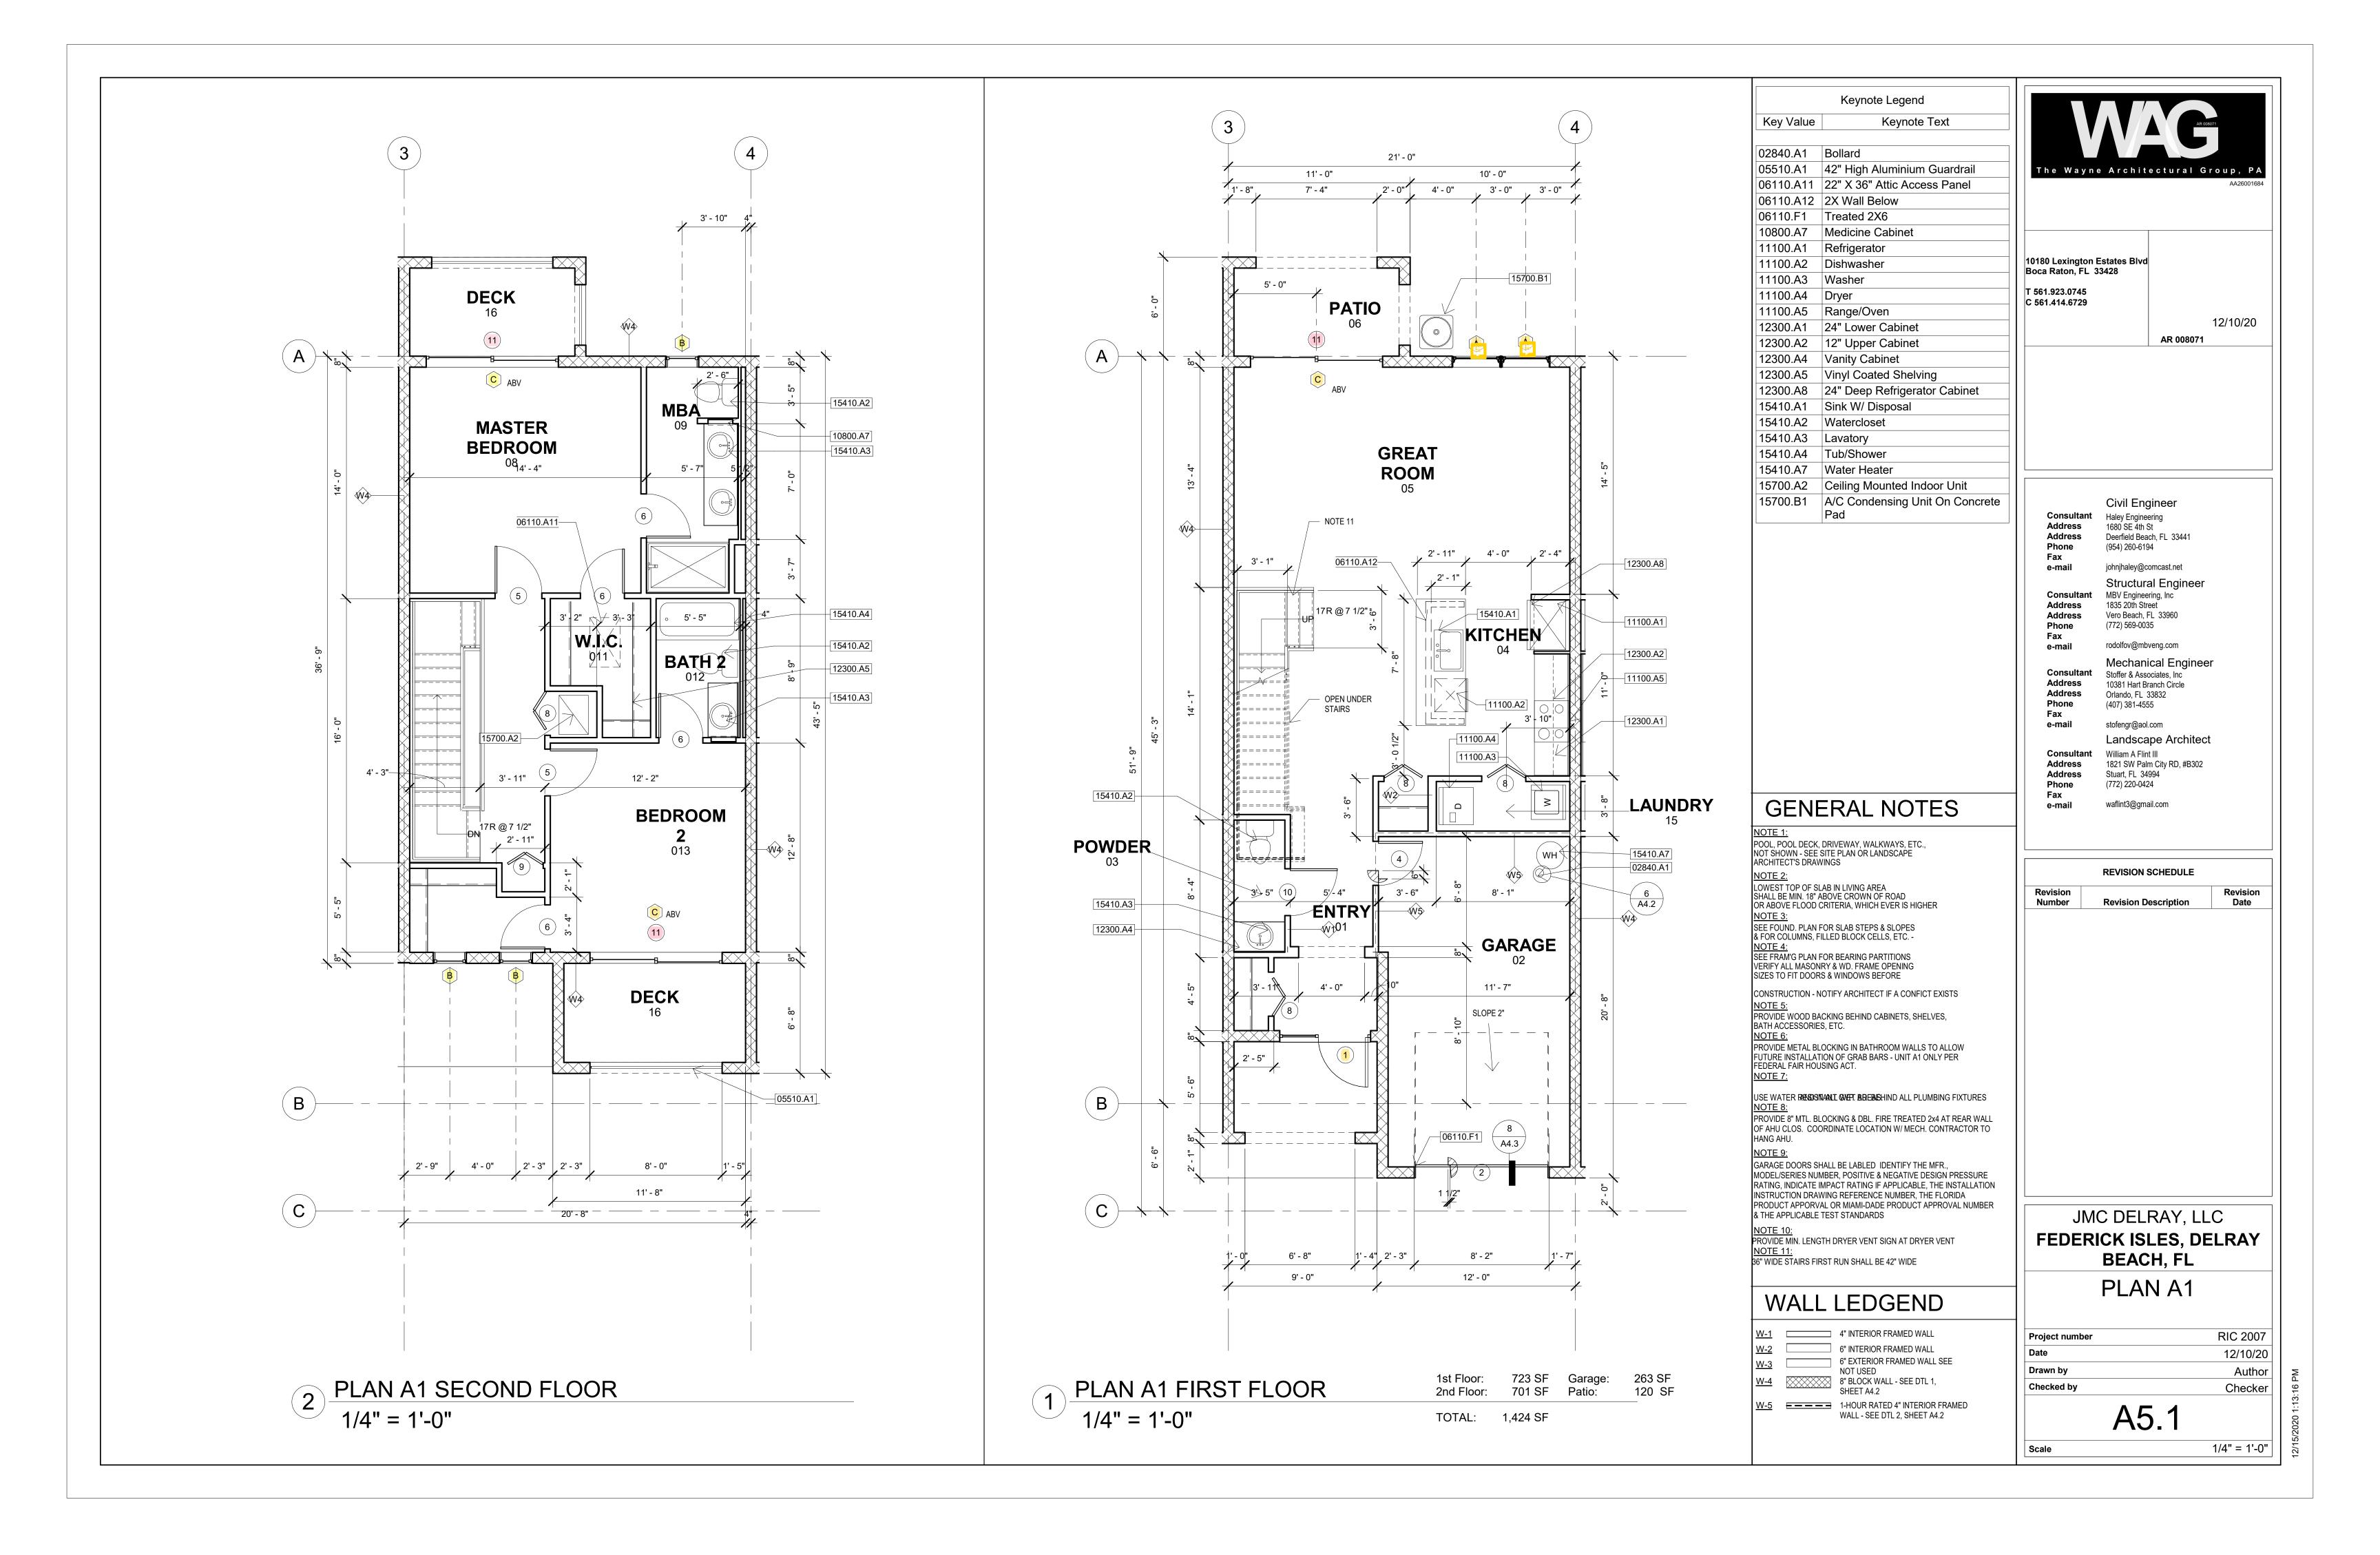
Scale


1/4" = 1'-0"




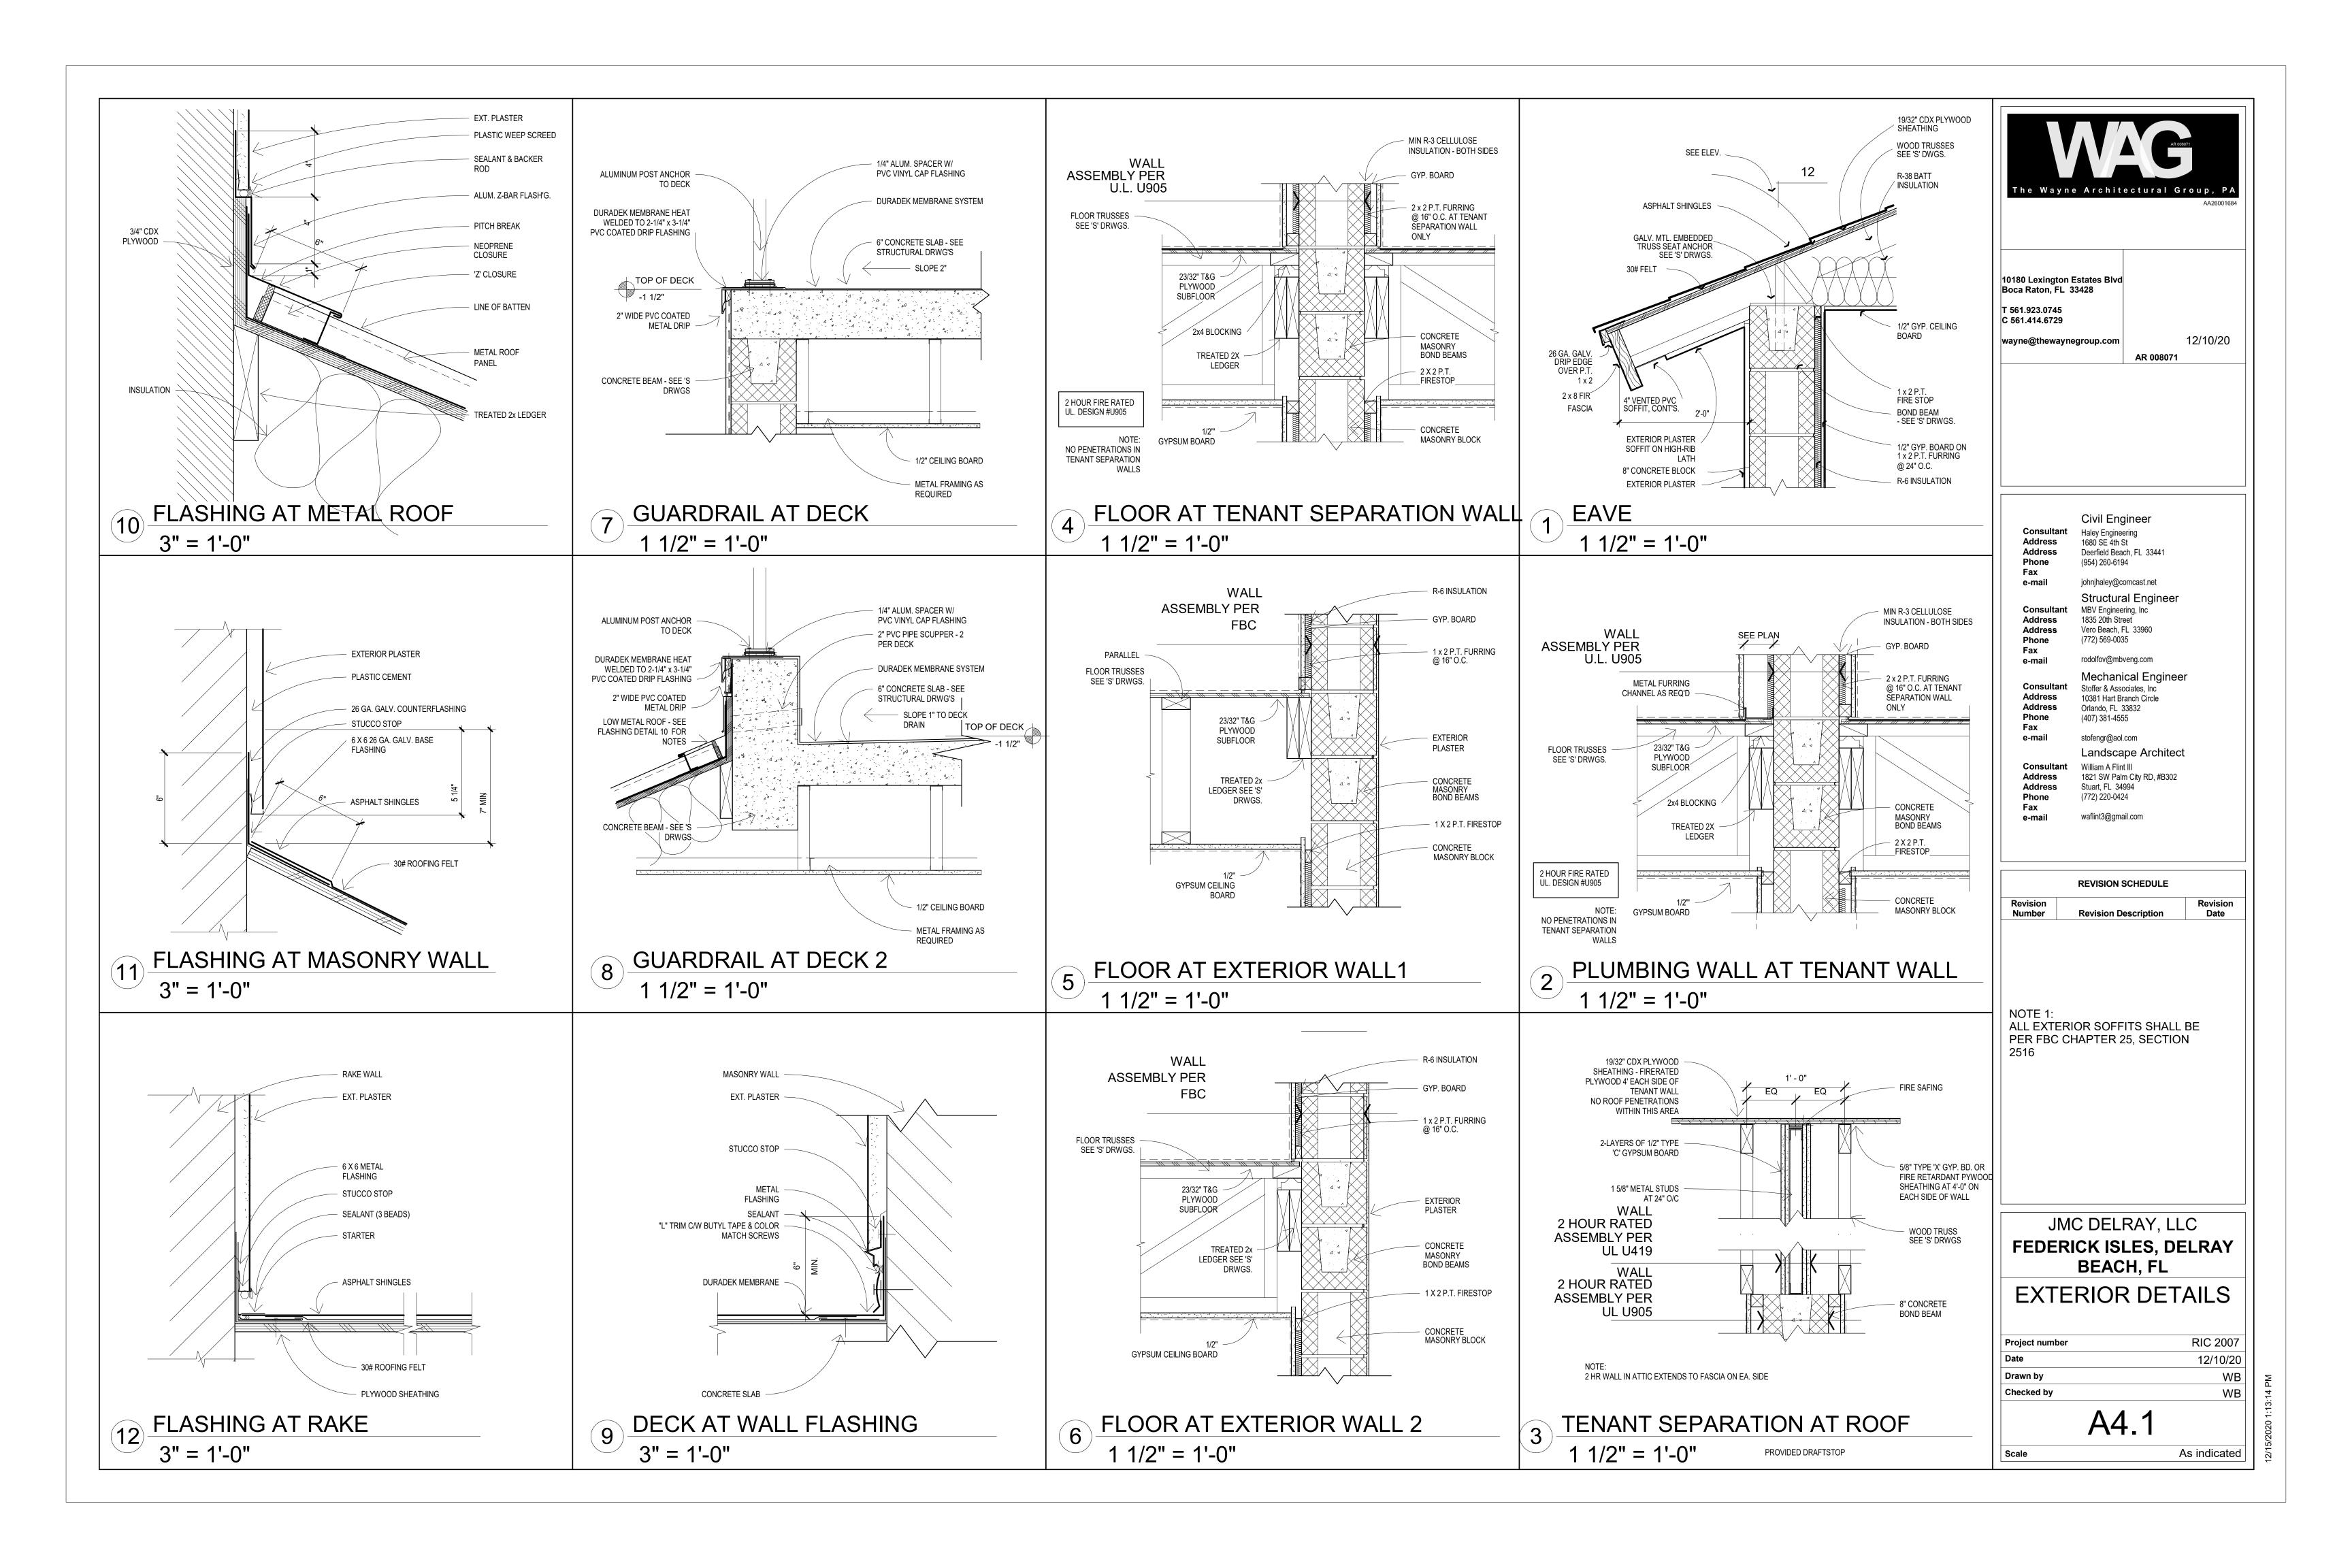


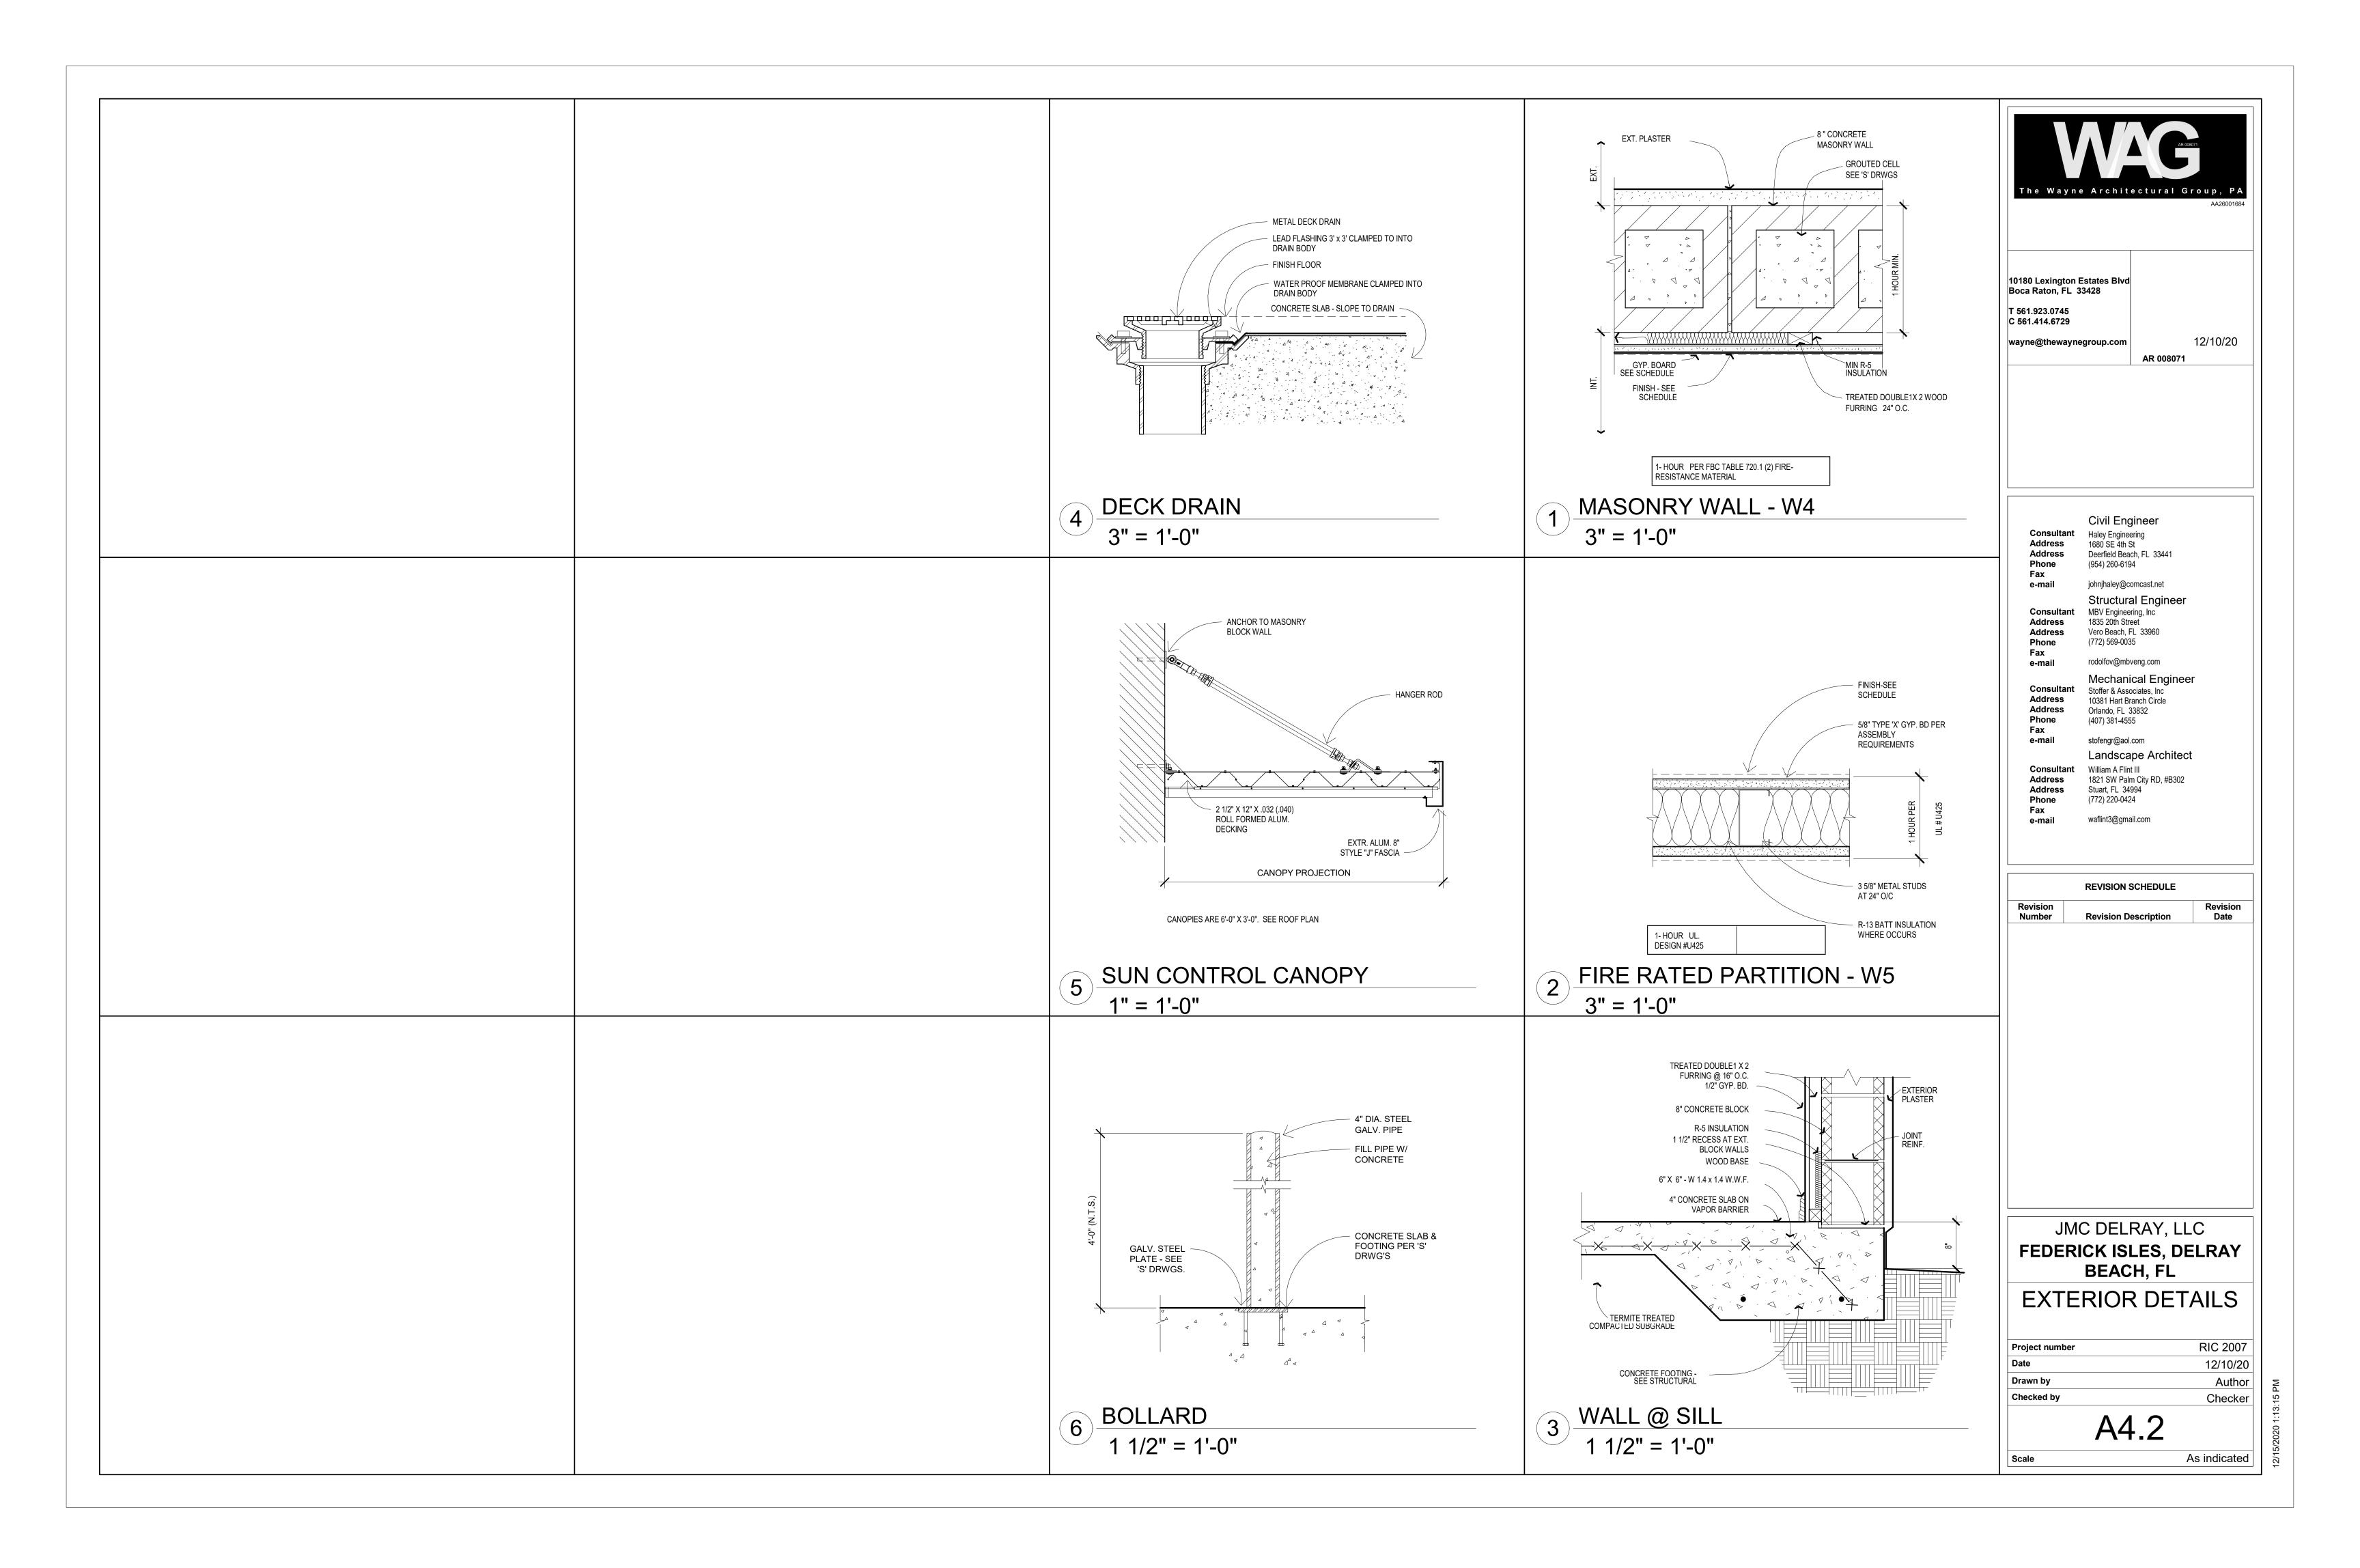


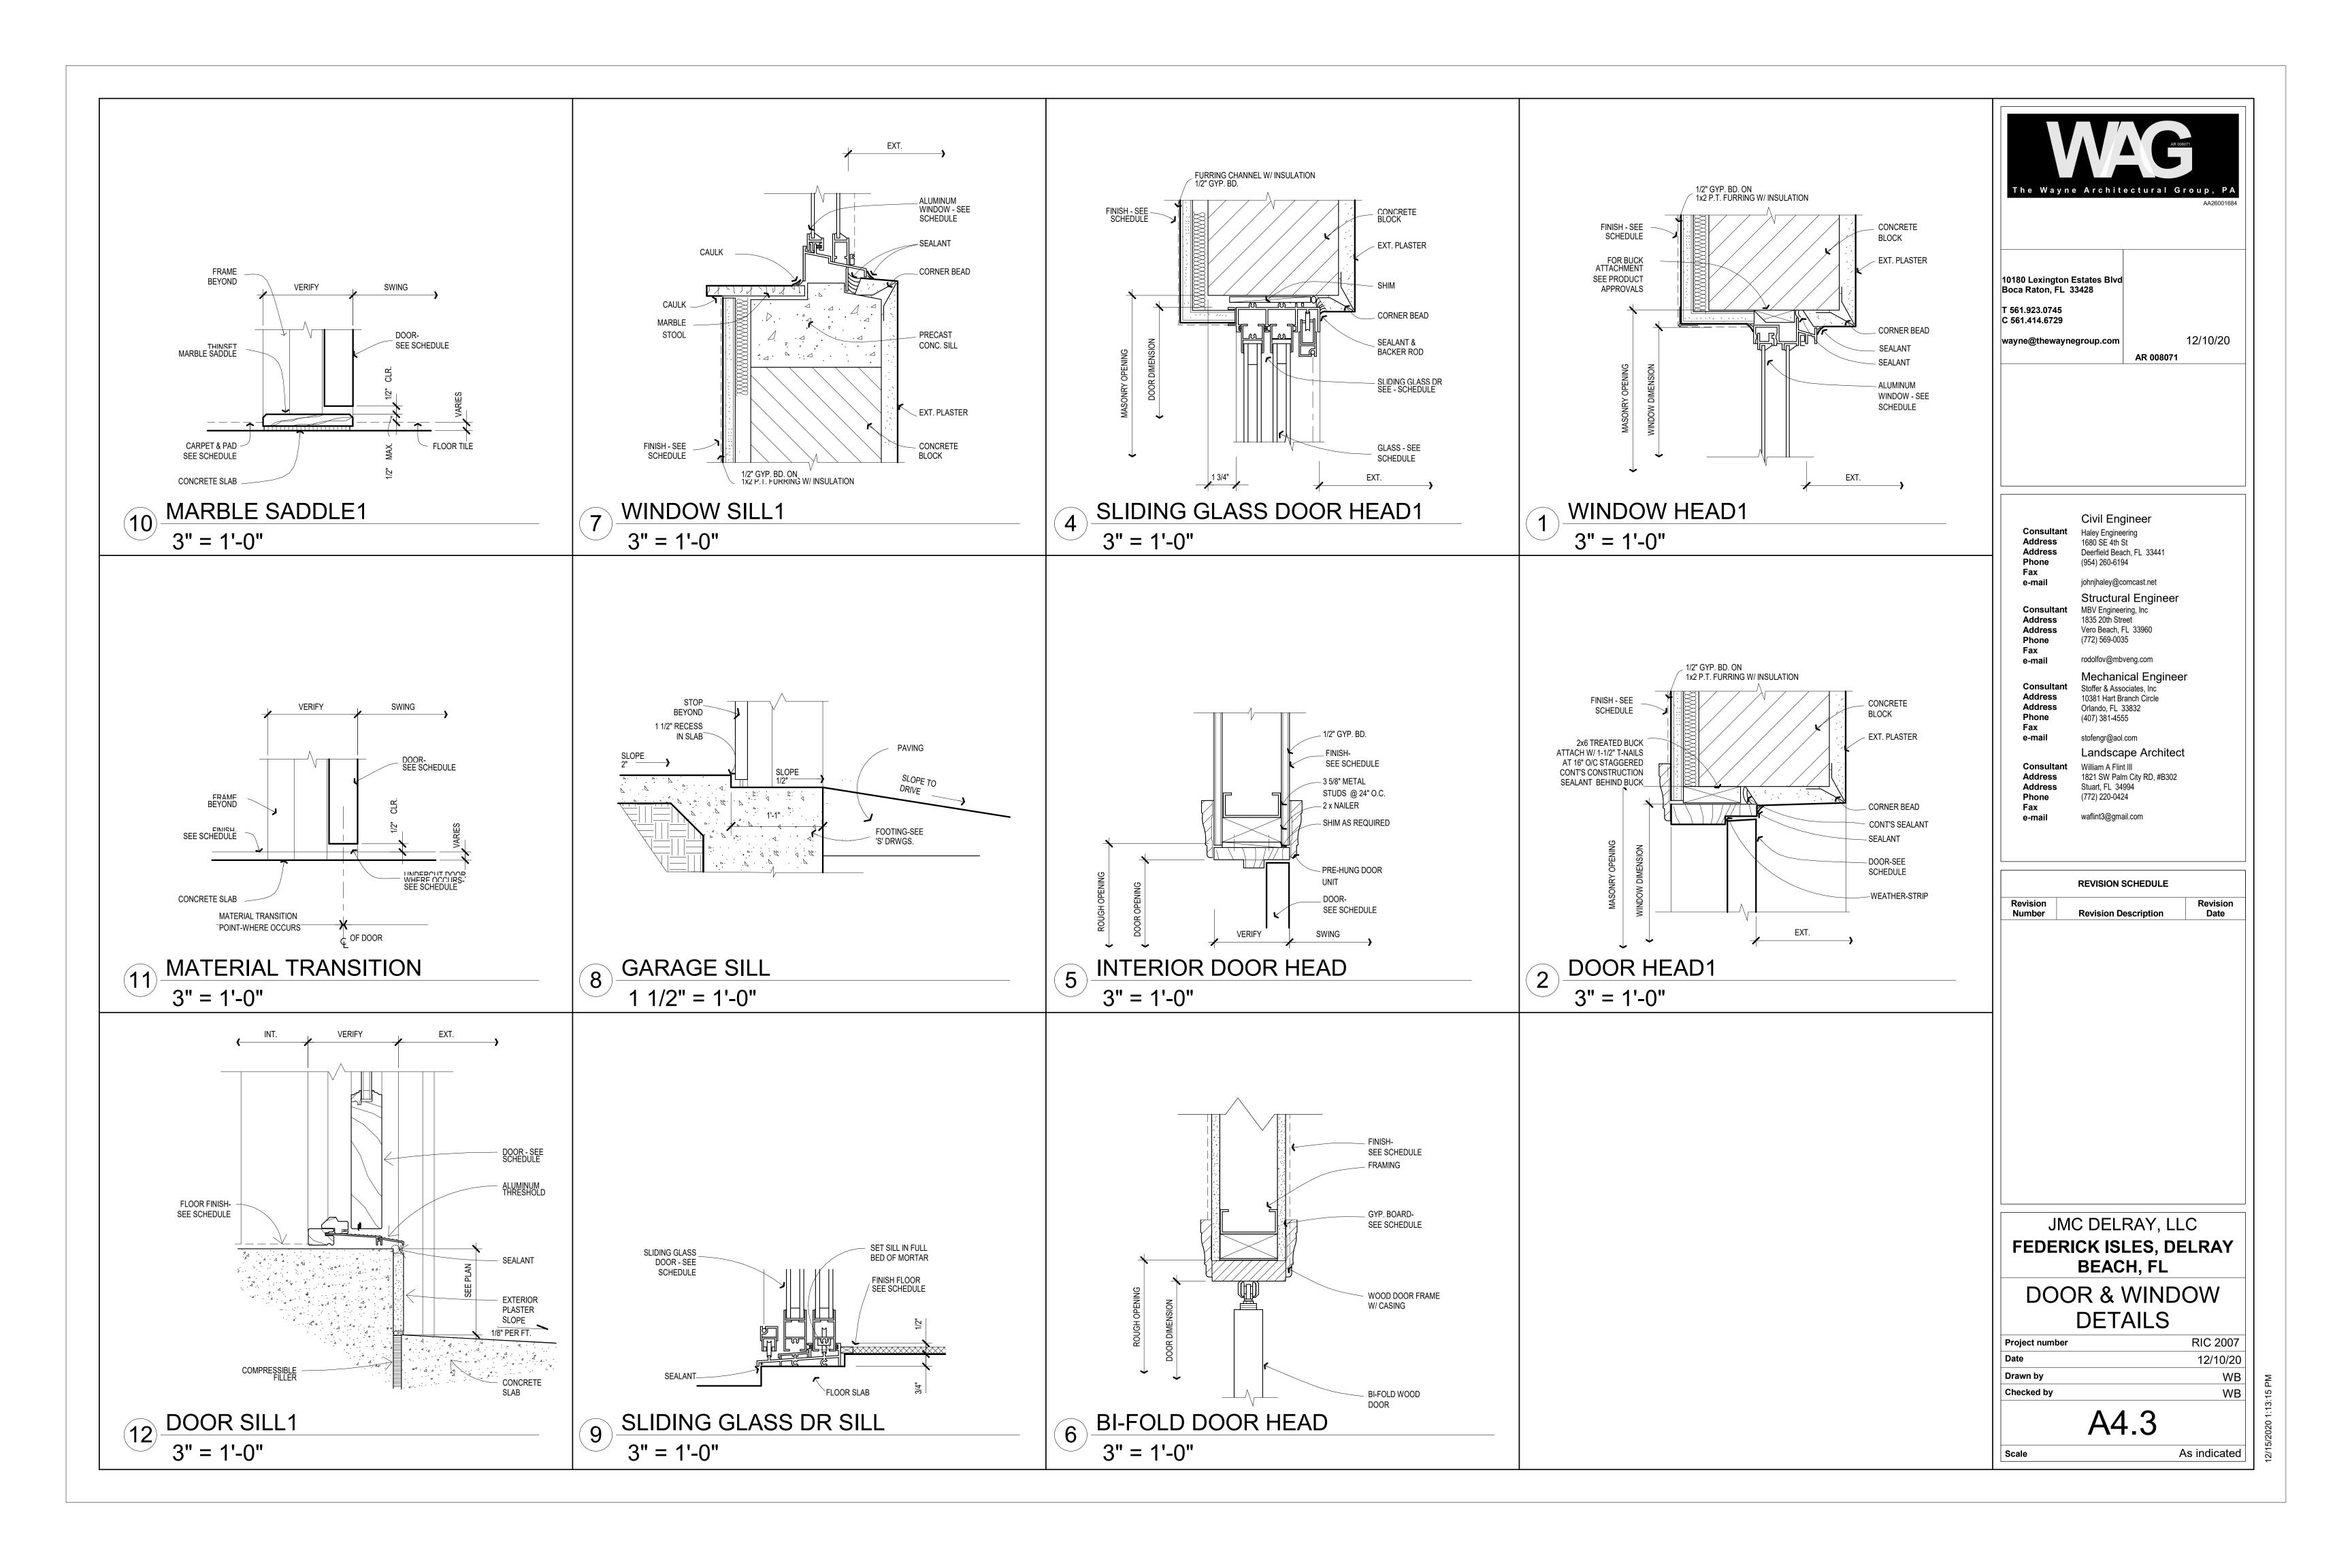

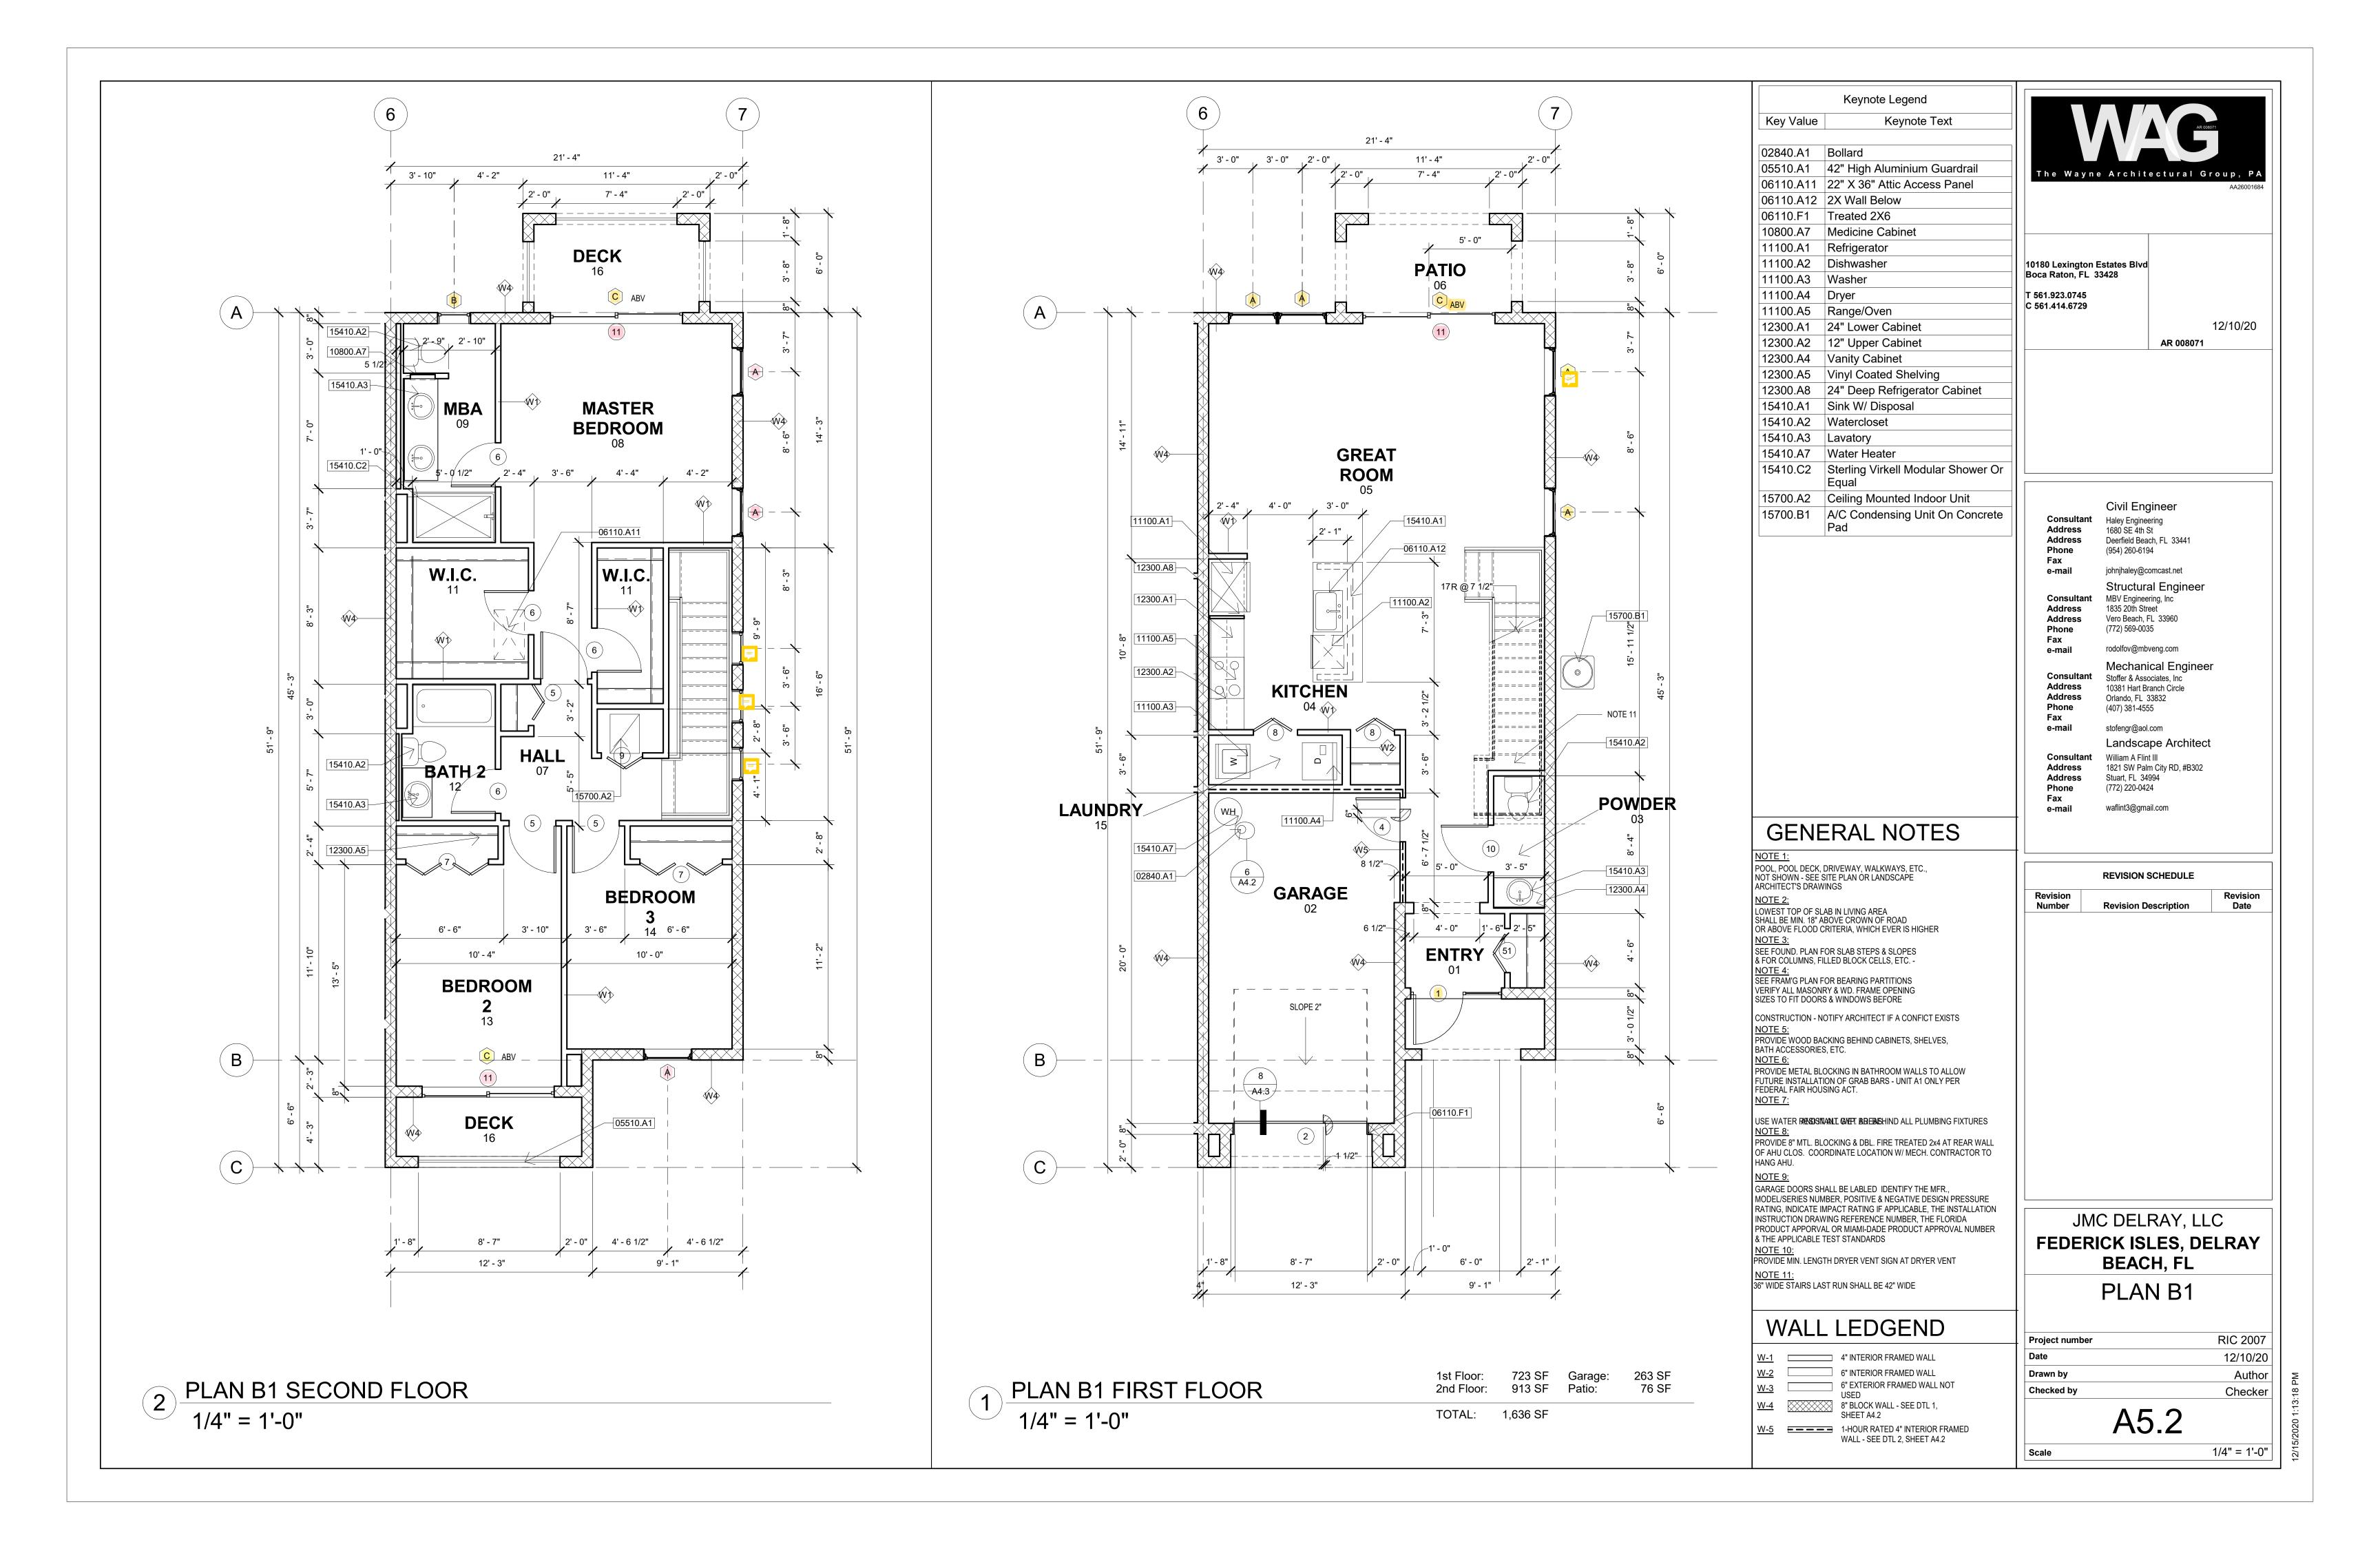


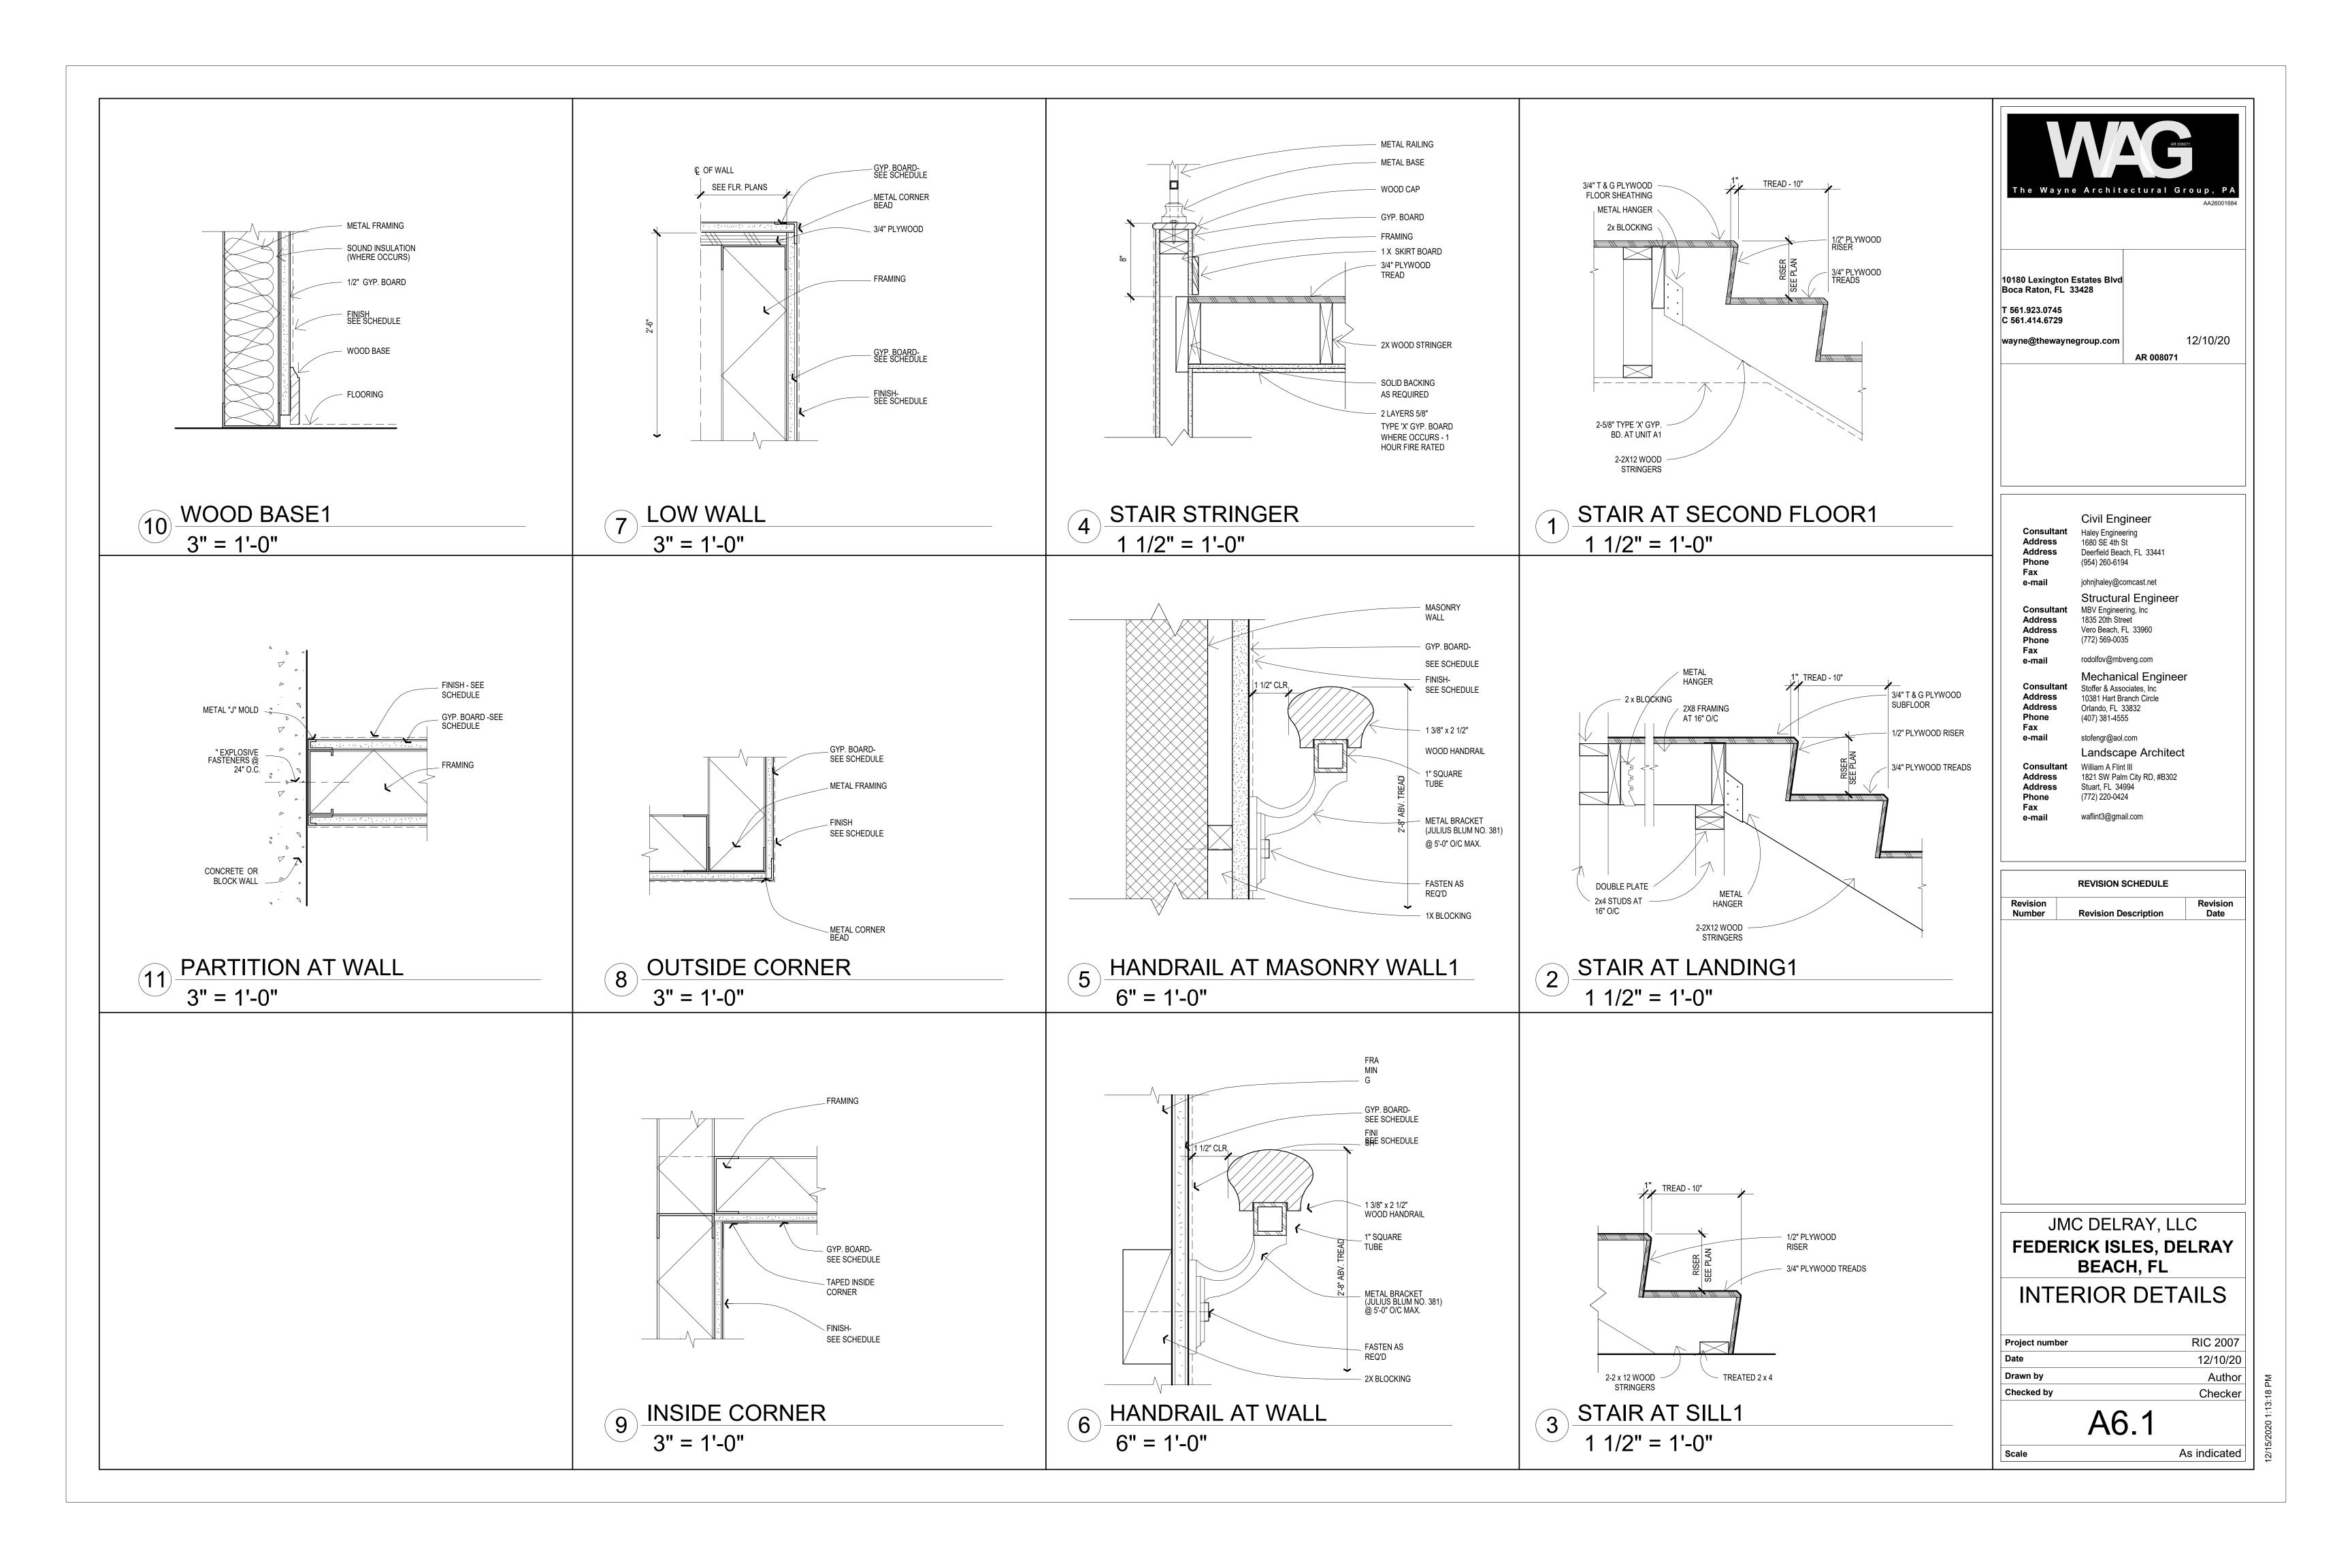

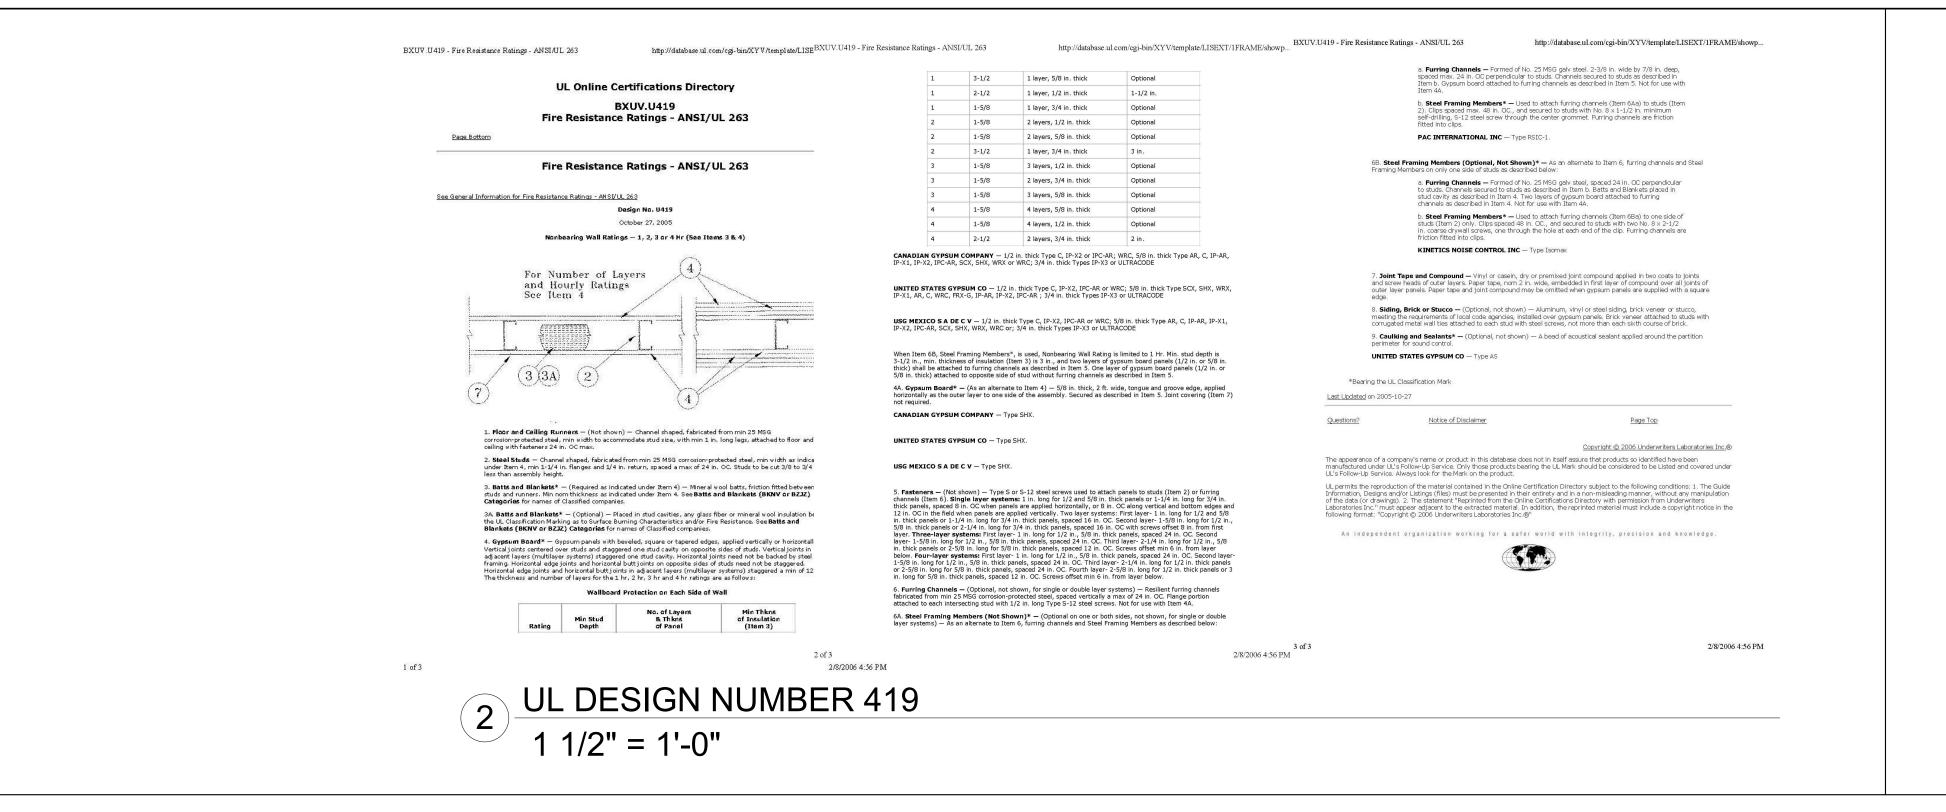

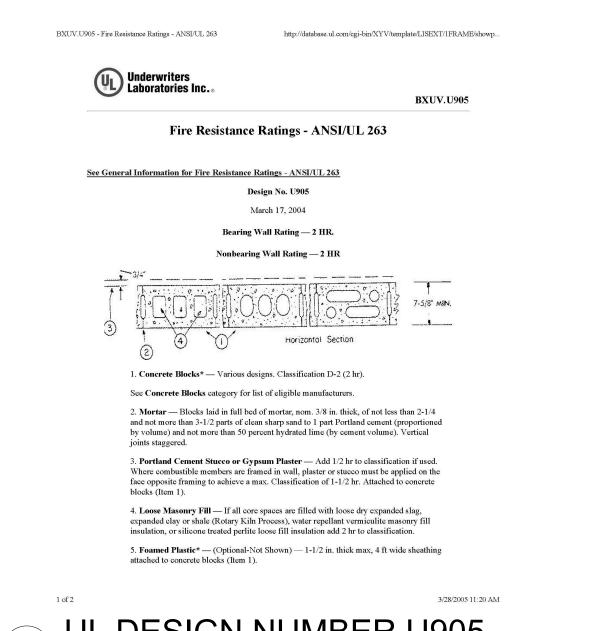


BXUV .U425 - Fire Resistance Ratings - ANSI/UL 263

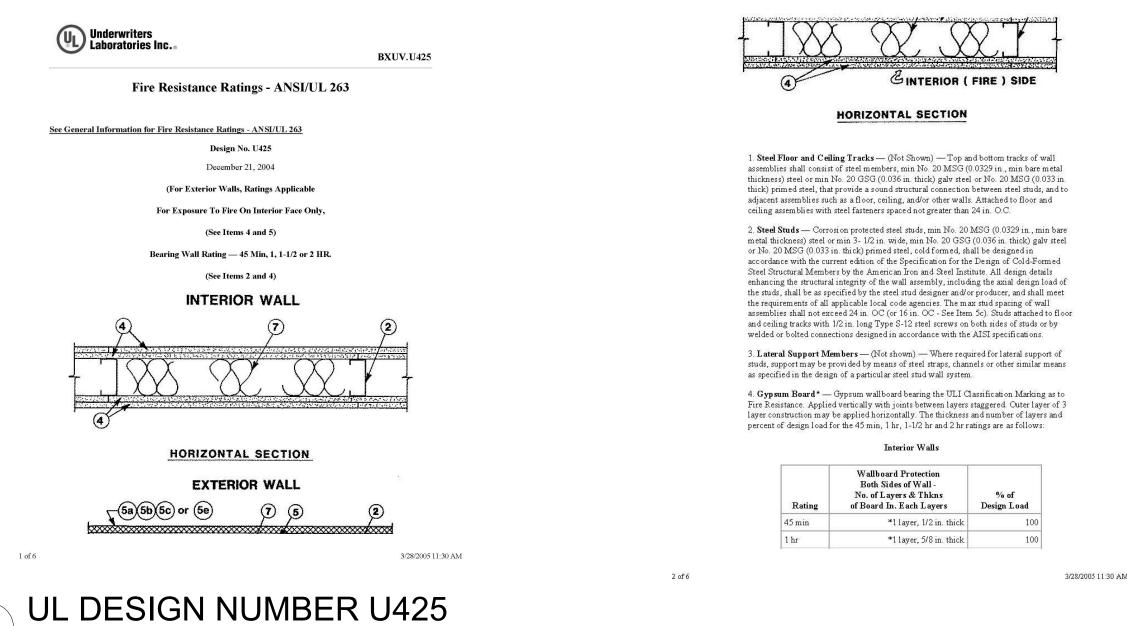


BXUV.U425 - Fire Resistance Ratings - ANSI/UL 263

1 1/2" = 1'-0"


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http://database.ul.com/cgi-bin/XYV/template/LISEXT/1FRAME/showp...

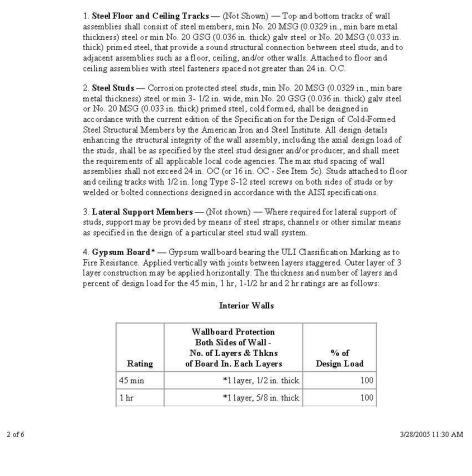

The Wayne Architectural Group, PA

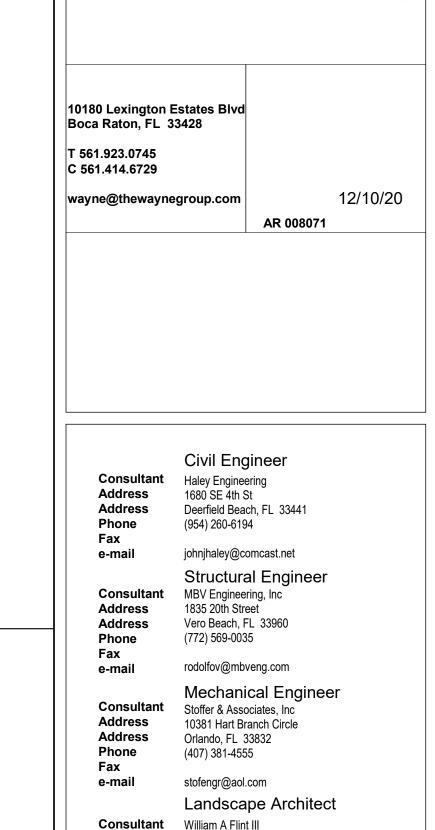

REVISION SCHEDULE

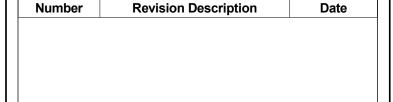Revision

1821 SW Palm City RD, #B302

Stuart, FL 34994 (772) 220-0424

Address

Address

Phone

Fax

JMC DELRAY, LLC FEDERICK ISLES, DELRAY BEACH, FL

**UL ASSEMBLIES** 

RIC 2007 **Project number** 12/10/20 Drawn by Author Checked by Checker

A6.2

Scale

1 1/2" = 1'-0"