


NYLOPLAST 12" DRAIN BASIN: 2812AG _ _ X

①②INTEGRATED DUCTILE IRON

MATCH BASIN O.D.

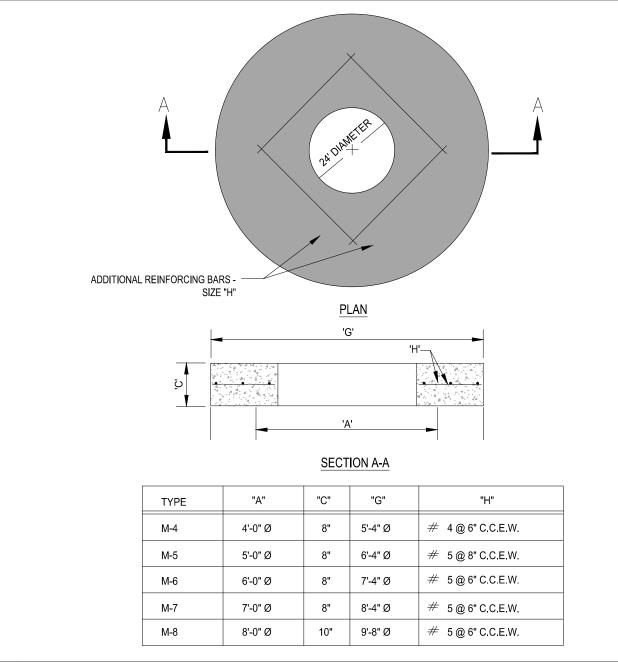

PRECAST CONCRETE-TOP SLAB FOR DRAINAGE MANHOLES PRECAST CIRCULAR DRAINAGE MANHOLE

PLAN

"F"

6'-4" Ø

7'-4" Ø


8'-4" Ø


9'-4" Ø

12" - 30" DRAIN BASIN

PRECAST CIRCULAR CATCH BASIN SCALE: NONE




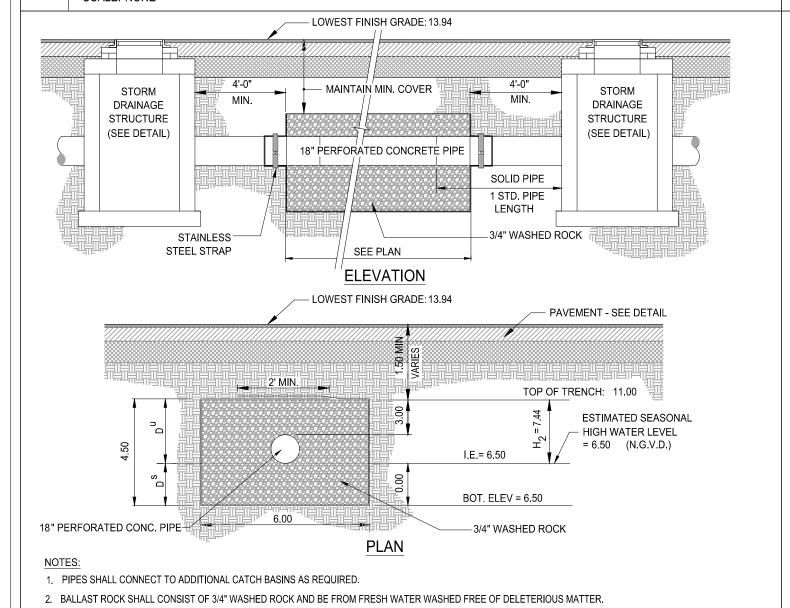

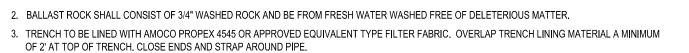

4. IN AREAS OVER TRENCH WHERE THE FULL ROADWAY SECTION CANNOT BE CONSTRUCTED, THE AREA ABOVE THE TRENCH SHALL CONSIST ENTIRELY OF LIMEROCK BASE (LBR100).



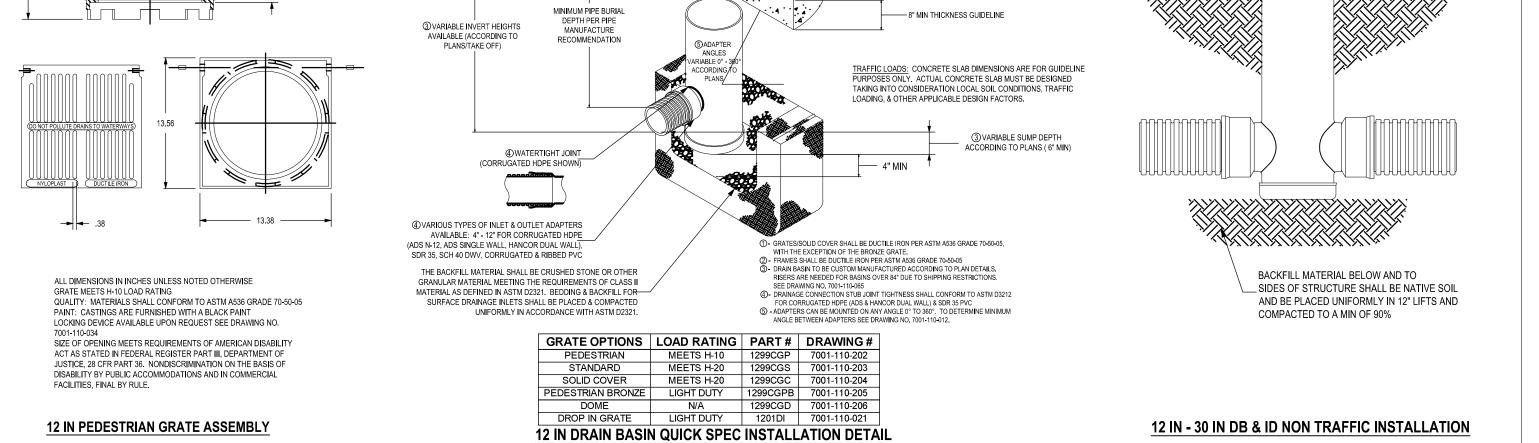

6 YARD DRAIN DETAIL

1299CGP

APPROX. DRAIN AREA = 50.60 SQ IN APPROX. WEIGHT WITH FRAME = 35.04 LBS

_HINGED GRATE

FOR EASY ACCESS





ETRAC MARKET

SAS STATION
LANTIC AVENUE &
VGRESS AVENUE
AY BEACH, FLOTT

DATE 11/23/20 SCALE DRAWN-BY DRAWING NAME: PAVING & GRADING DETAILS


SHEET NO. VERSION

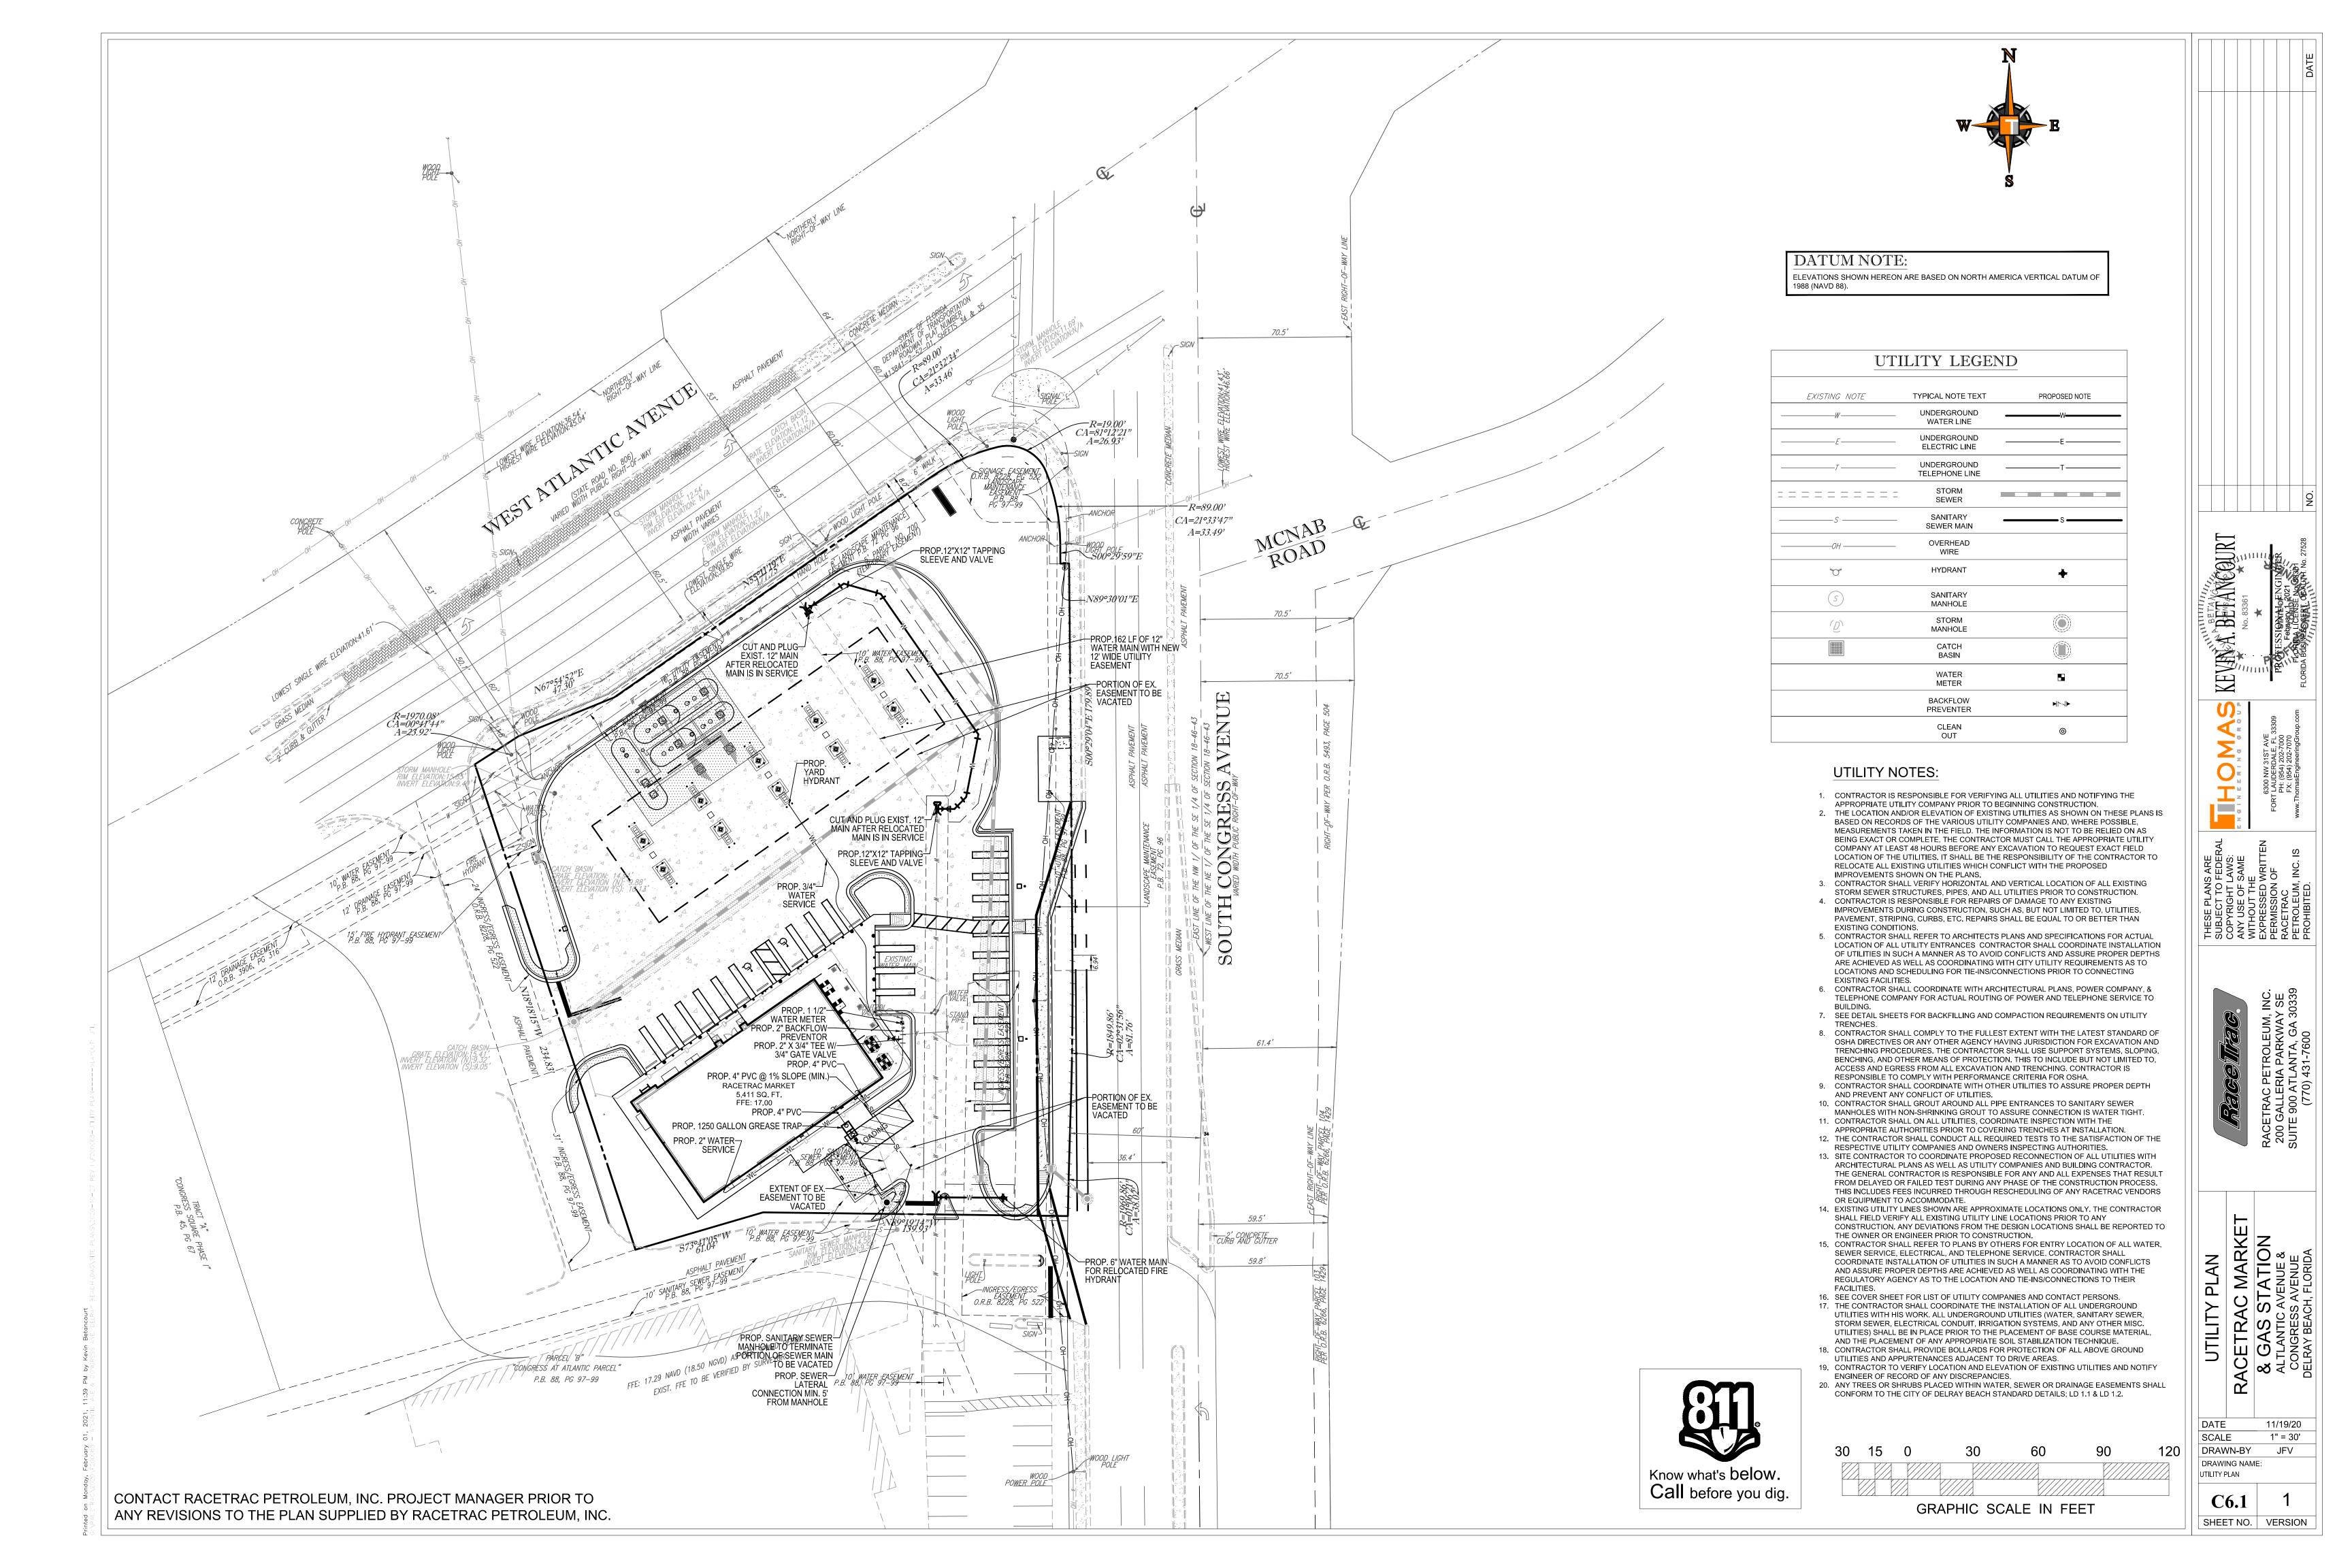


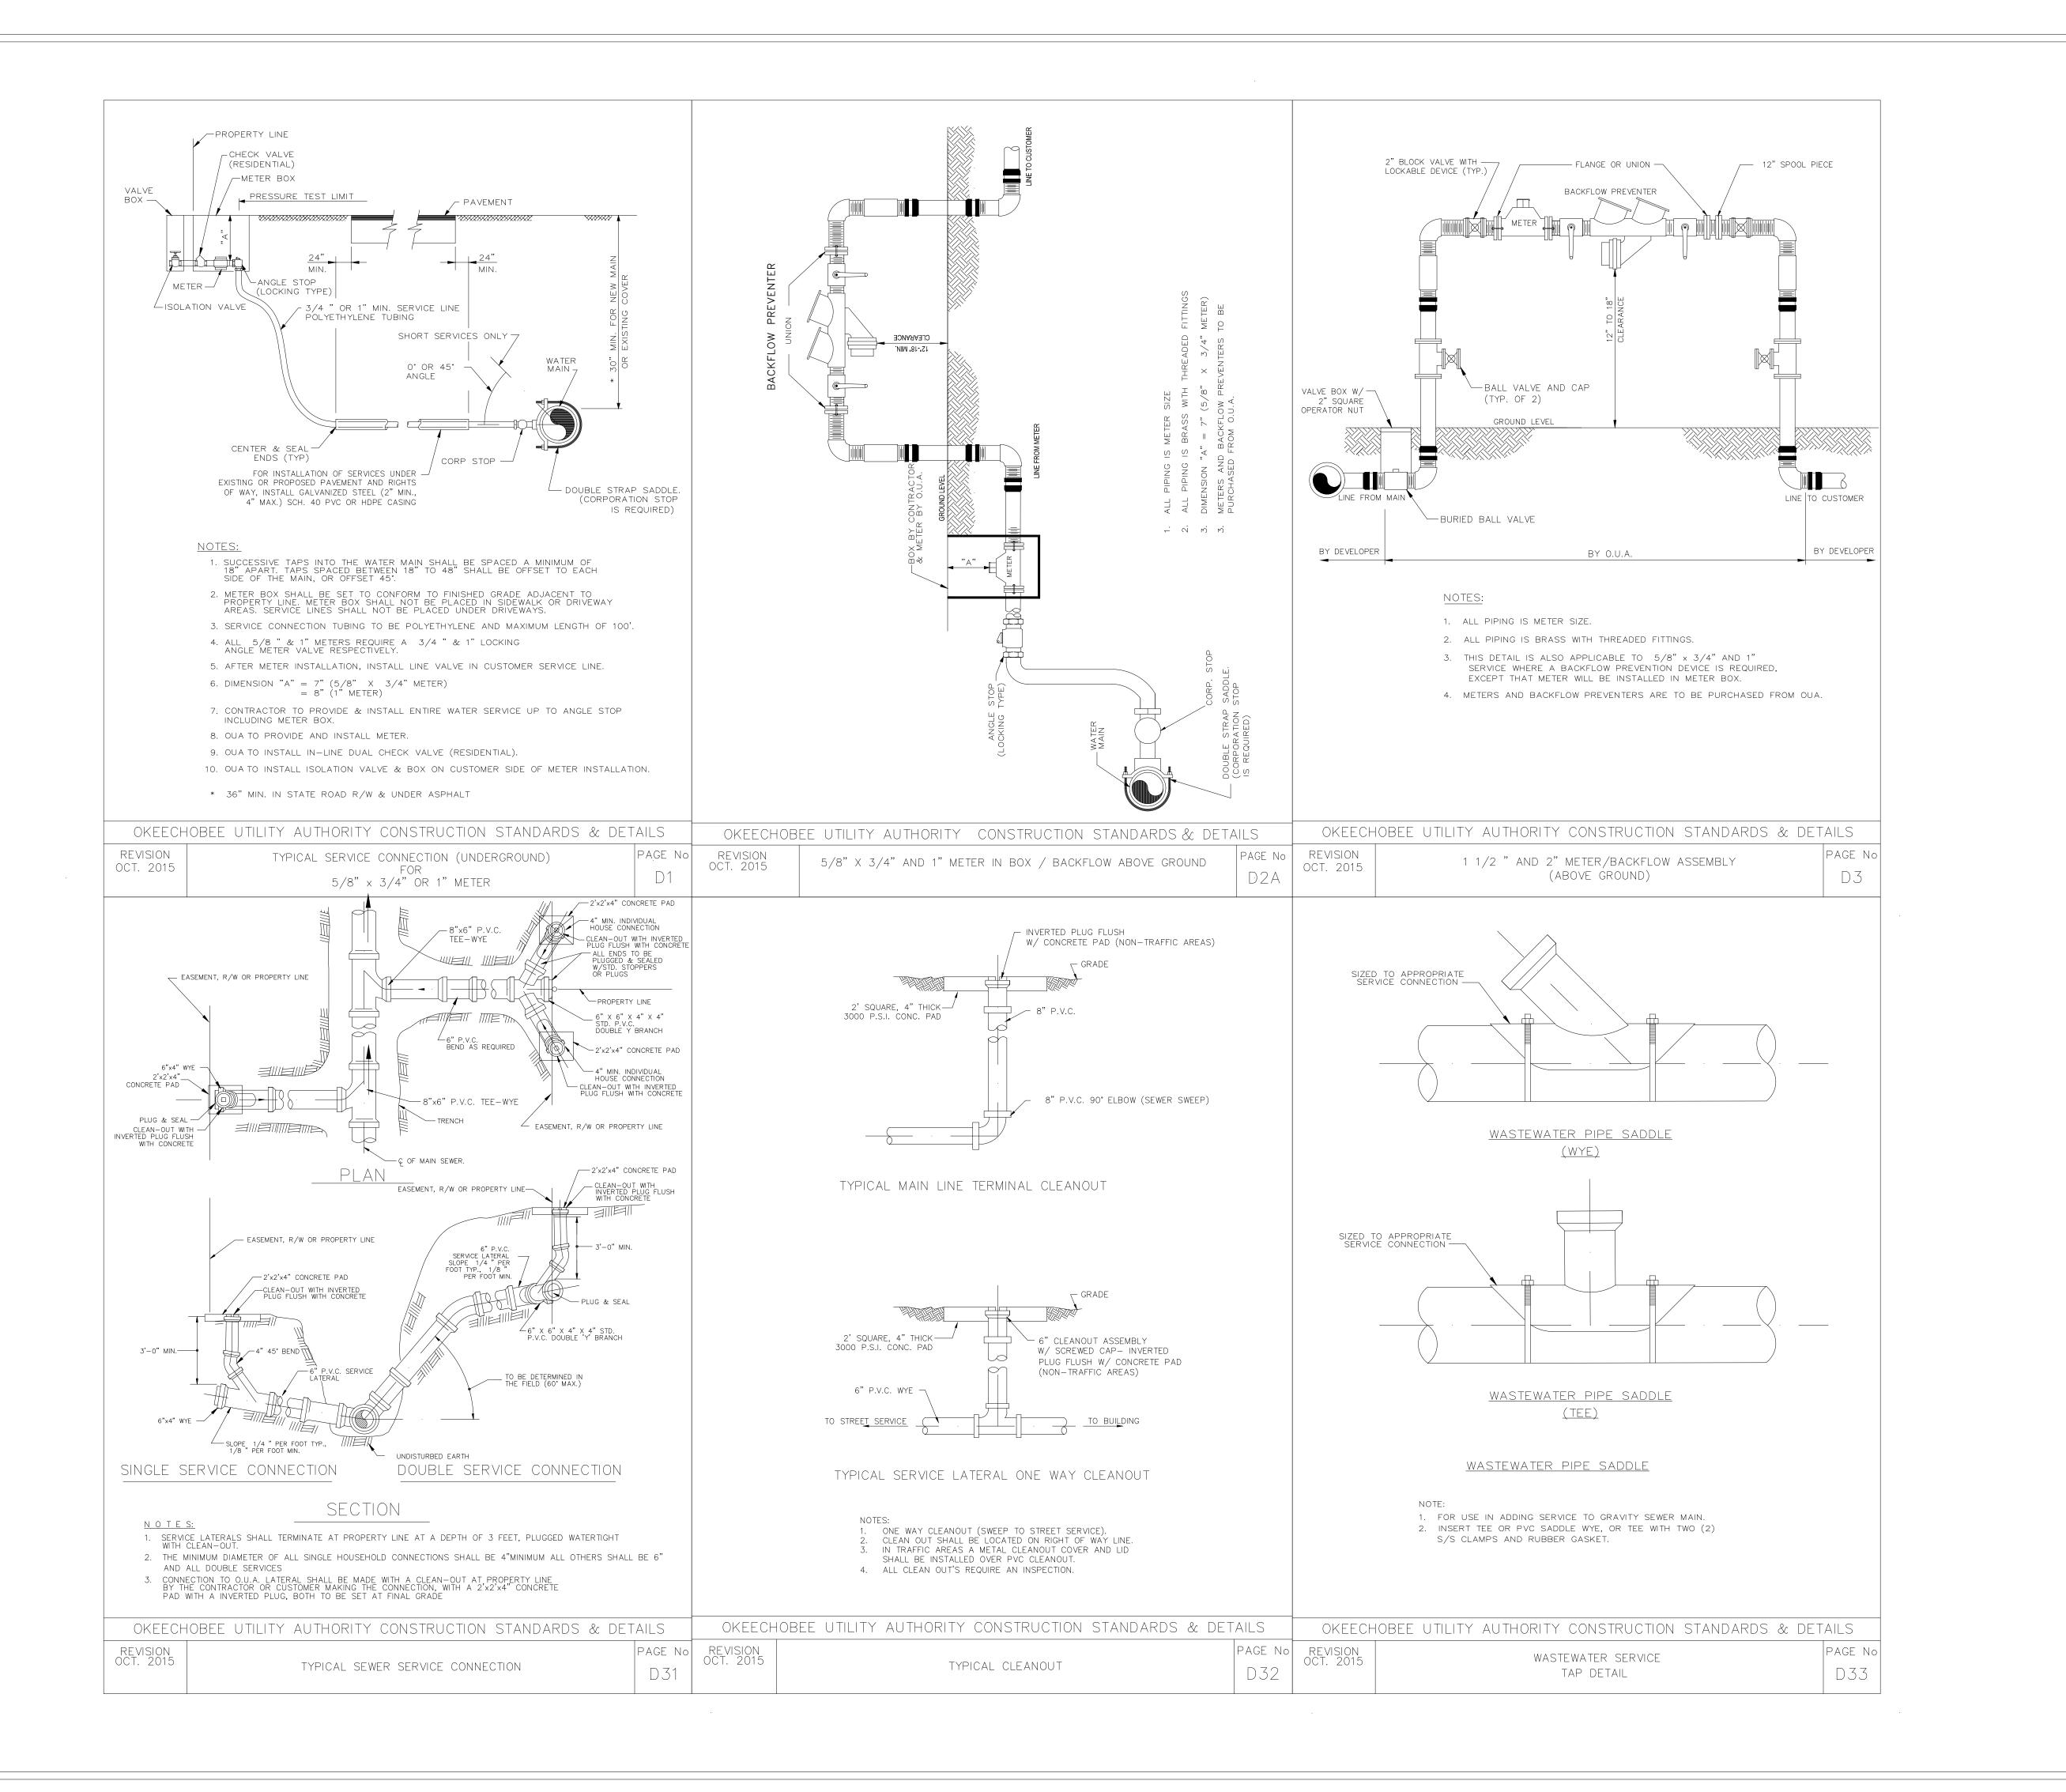

KEVINA, BETANCOU 10/27/20 SCALE DRAWN-BY DRAWING NAME: UTILITY DETAILS C 6.2

SHEET NO. VERSION

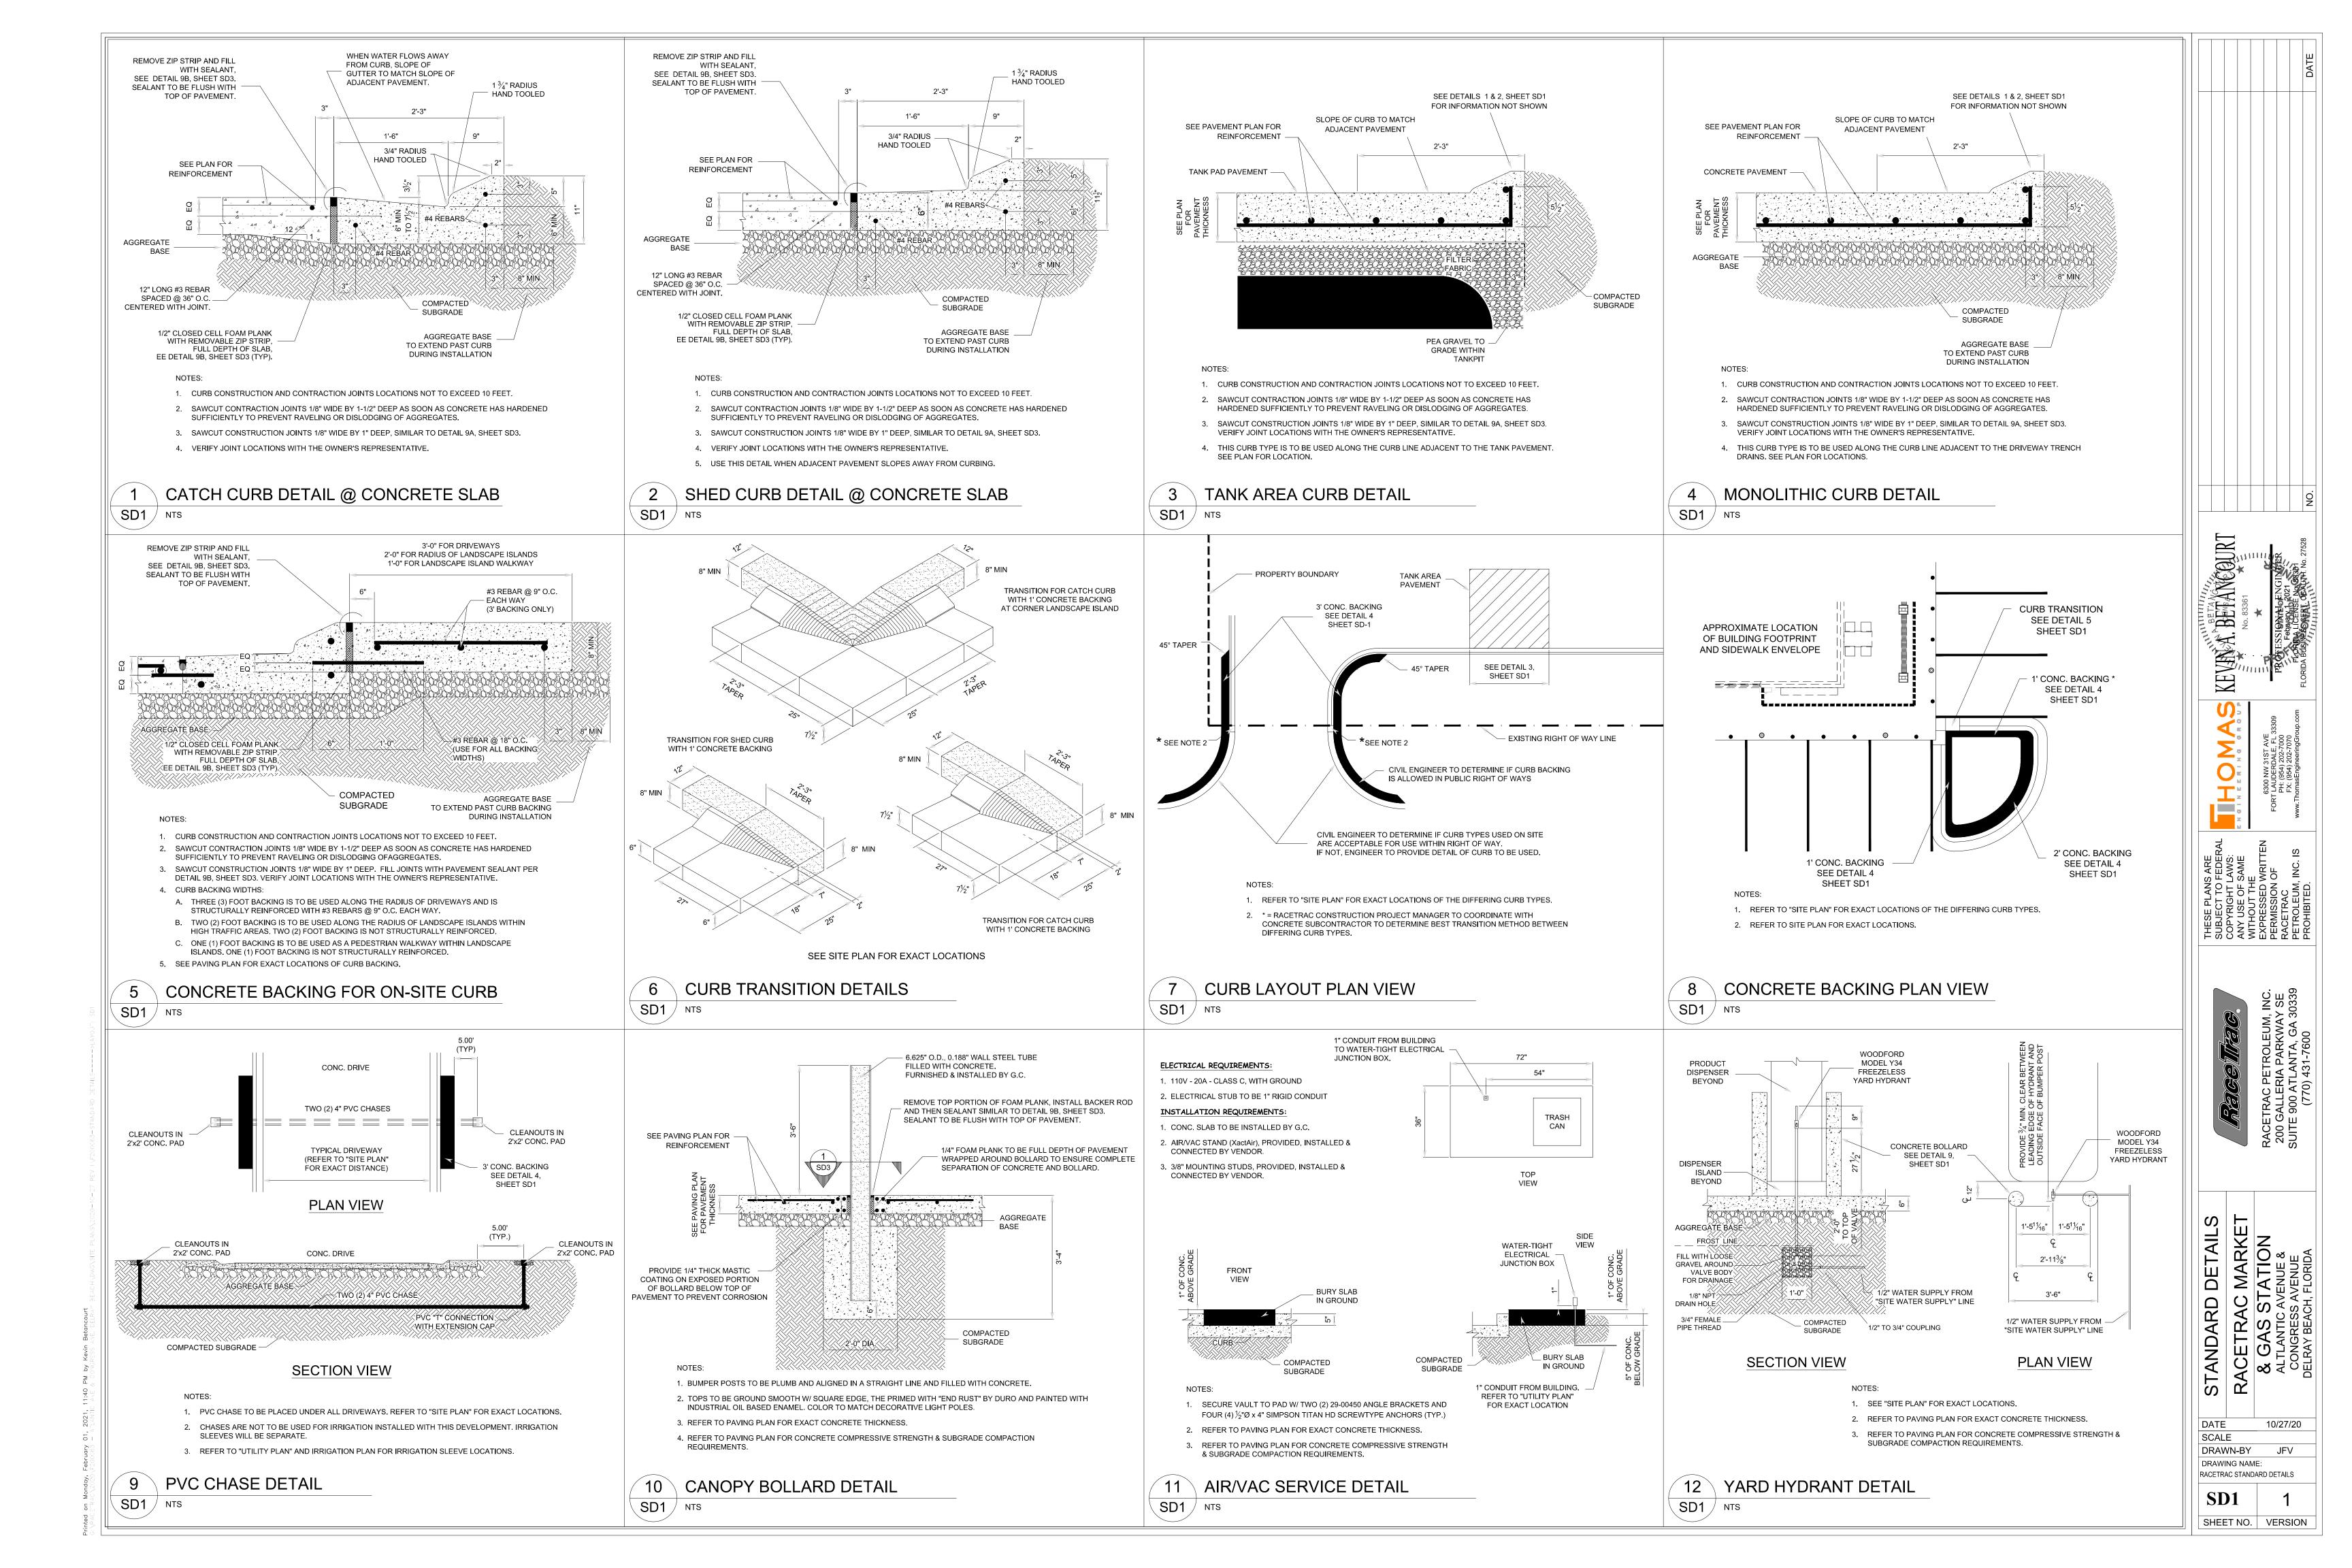

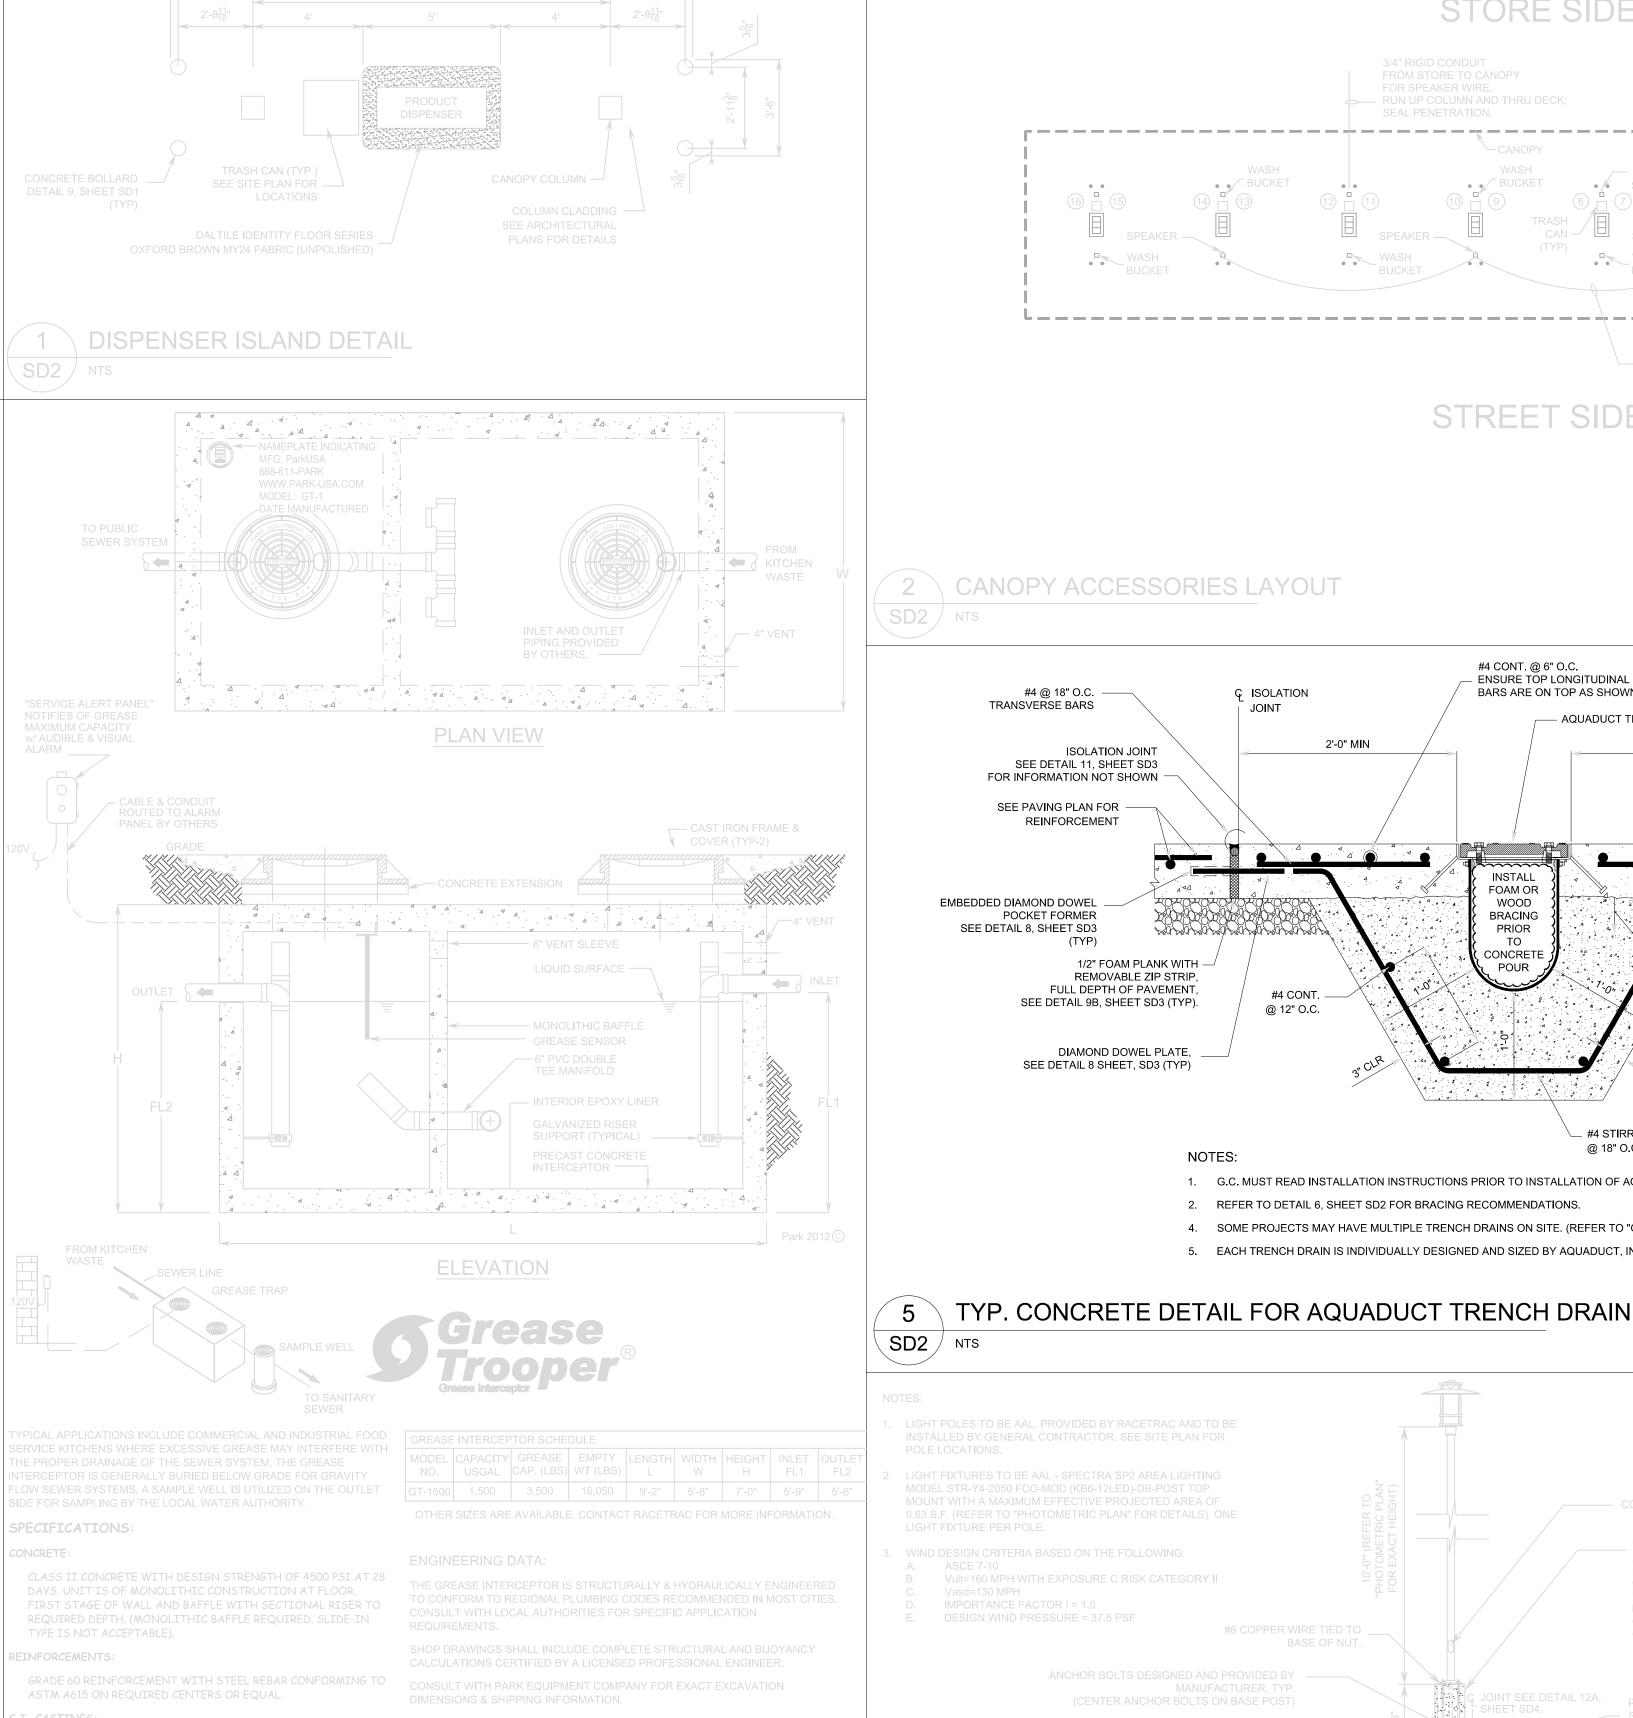

STORE SIDE


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SEAL CANOPY DECK ——


PENETRATION

CANOPY DECK





4. SOME PROJECTS MAY HAVE MULTIPLE TRENCH DRAINS ON SITE. (REFER TO "GRADING PLAN" FOR EXACT LOCATIONS.)

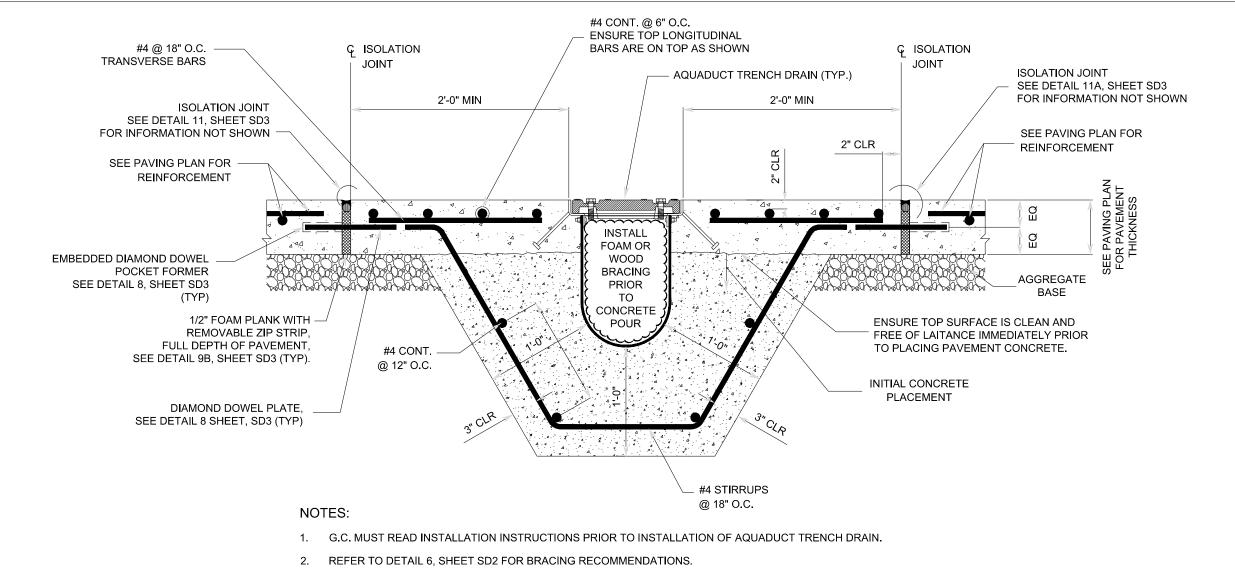5. EACH TRENCH DRAIN IS INDIVIDUALLY DESIGNED AND SIZED BY AQUADUCT, INC. (REFERE TO DESIGN SPECS FOR EXACT SIZING.)

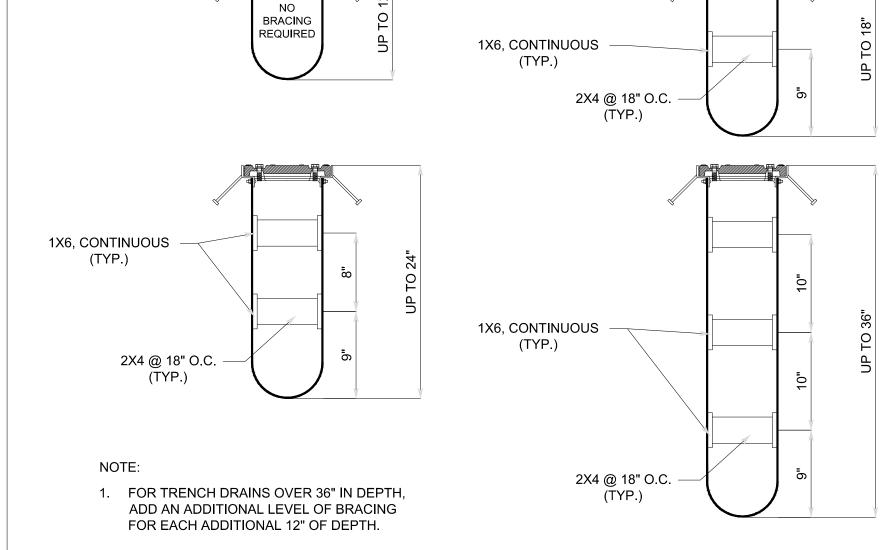

6 AQUADUCT TRENCH DRAIN BRACING LAYOUT DETAILS

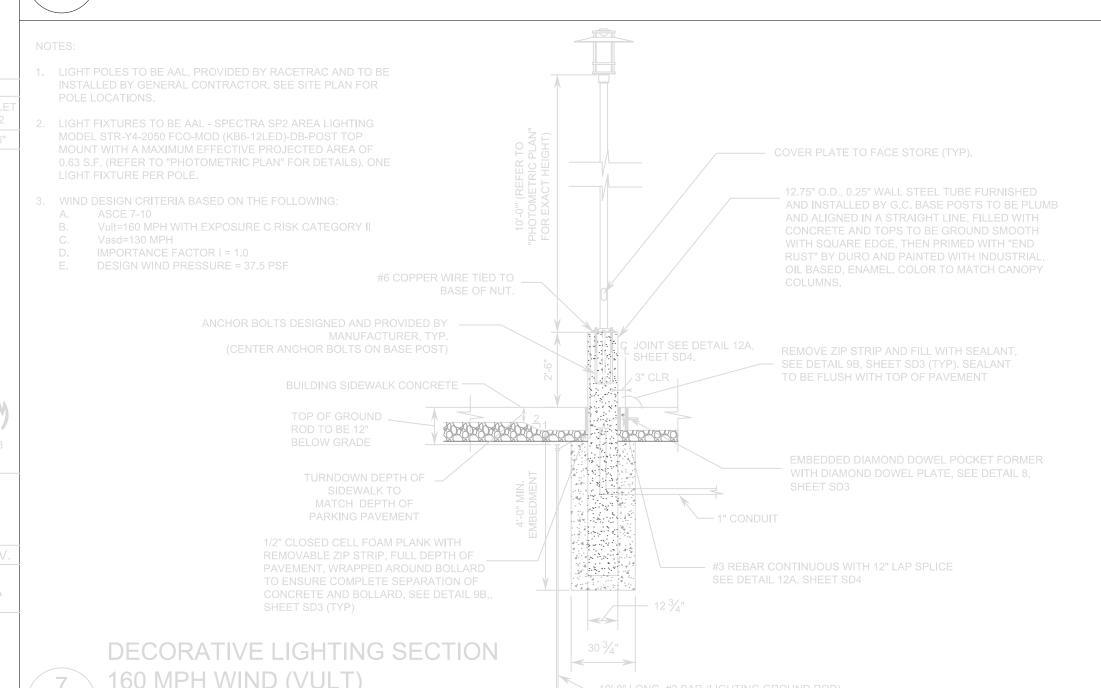

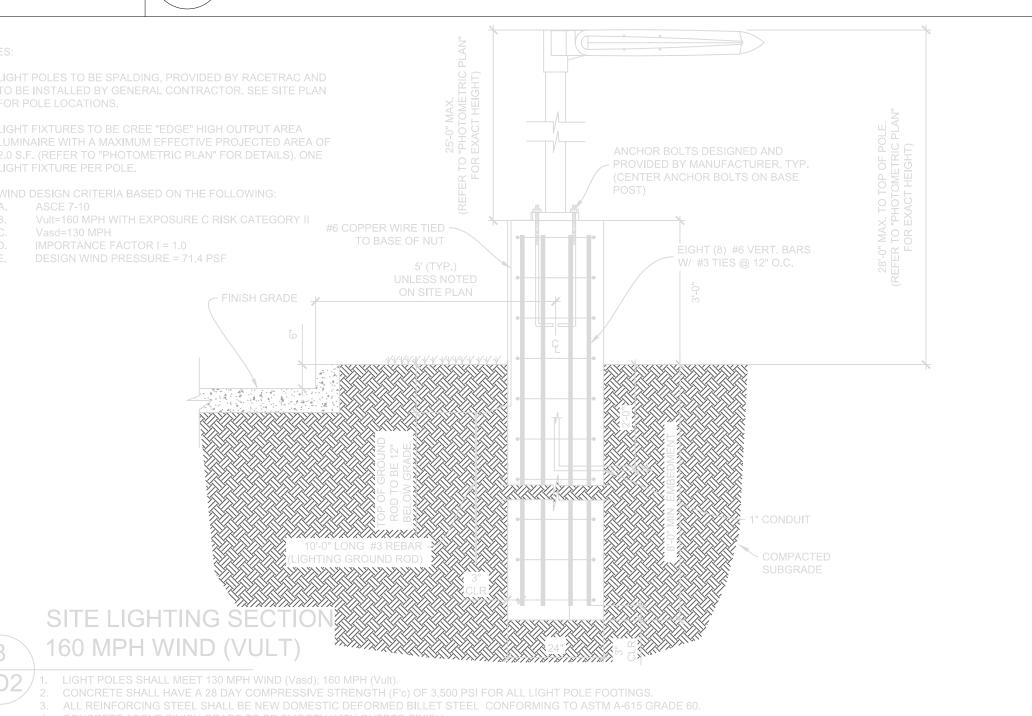

GREASE TRAP (1500 GALLON CAPACITY) 4 & SAMPLE WELL DETAILS OR "APPROVED EQUAL" SD2 / NTS

GT-1

DATE 10/27/20 SCALE DRAWN-BY

CANOPY COLUMN COLUMN WRAP REFER TO C100 FUEL CANOPY PLAN & ELEVATIONS FOR EXACT MATERIAL KEVINA, BETANGOURT

1/2" RIG**I**D - CONDUIT ON CANOPY RED-IRON


CONTINUOUS THROUGH DECKING


CANOPY DECK


12


DRAWING NAME: RACETRAC STANDARD DETAILS

SHEET NO. VERSION

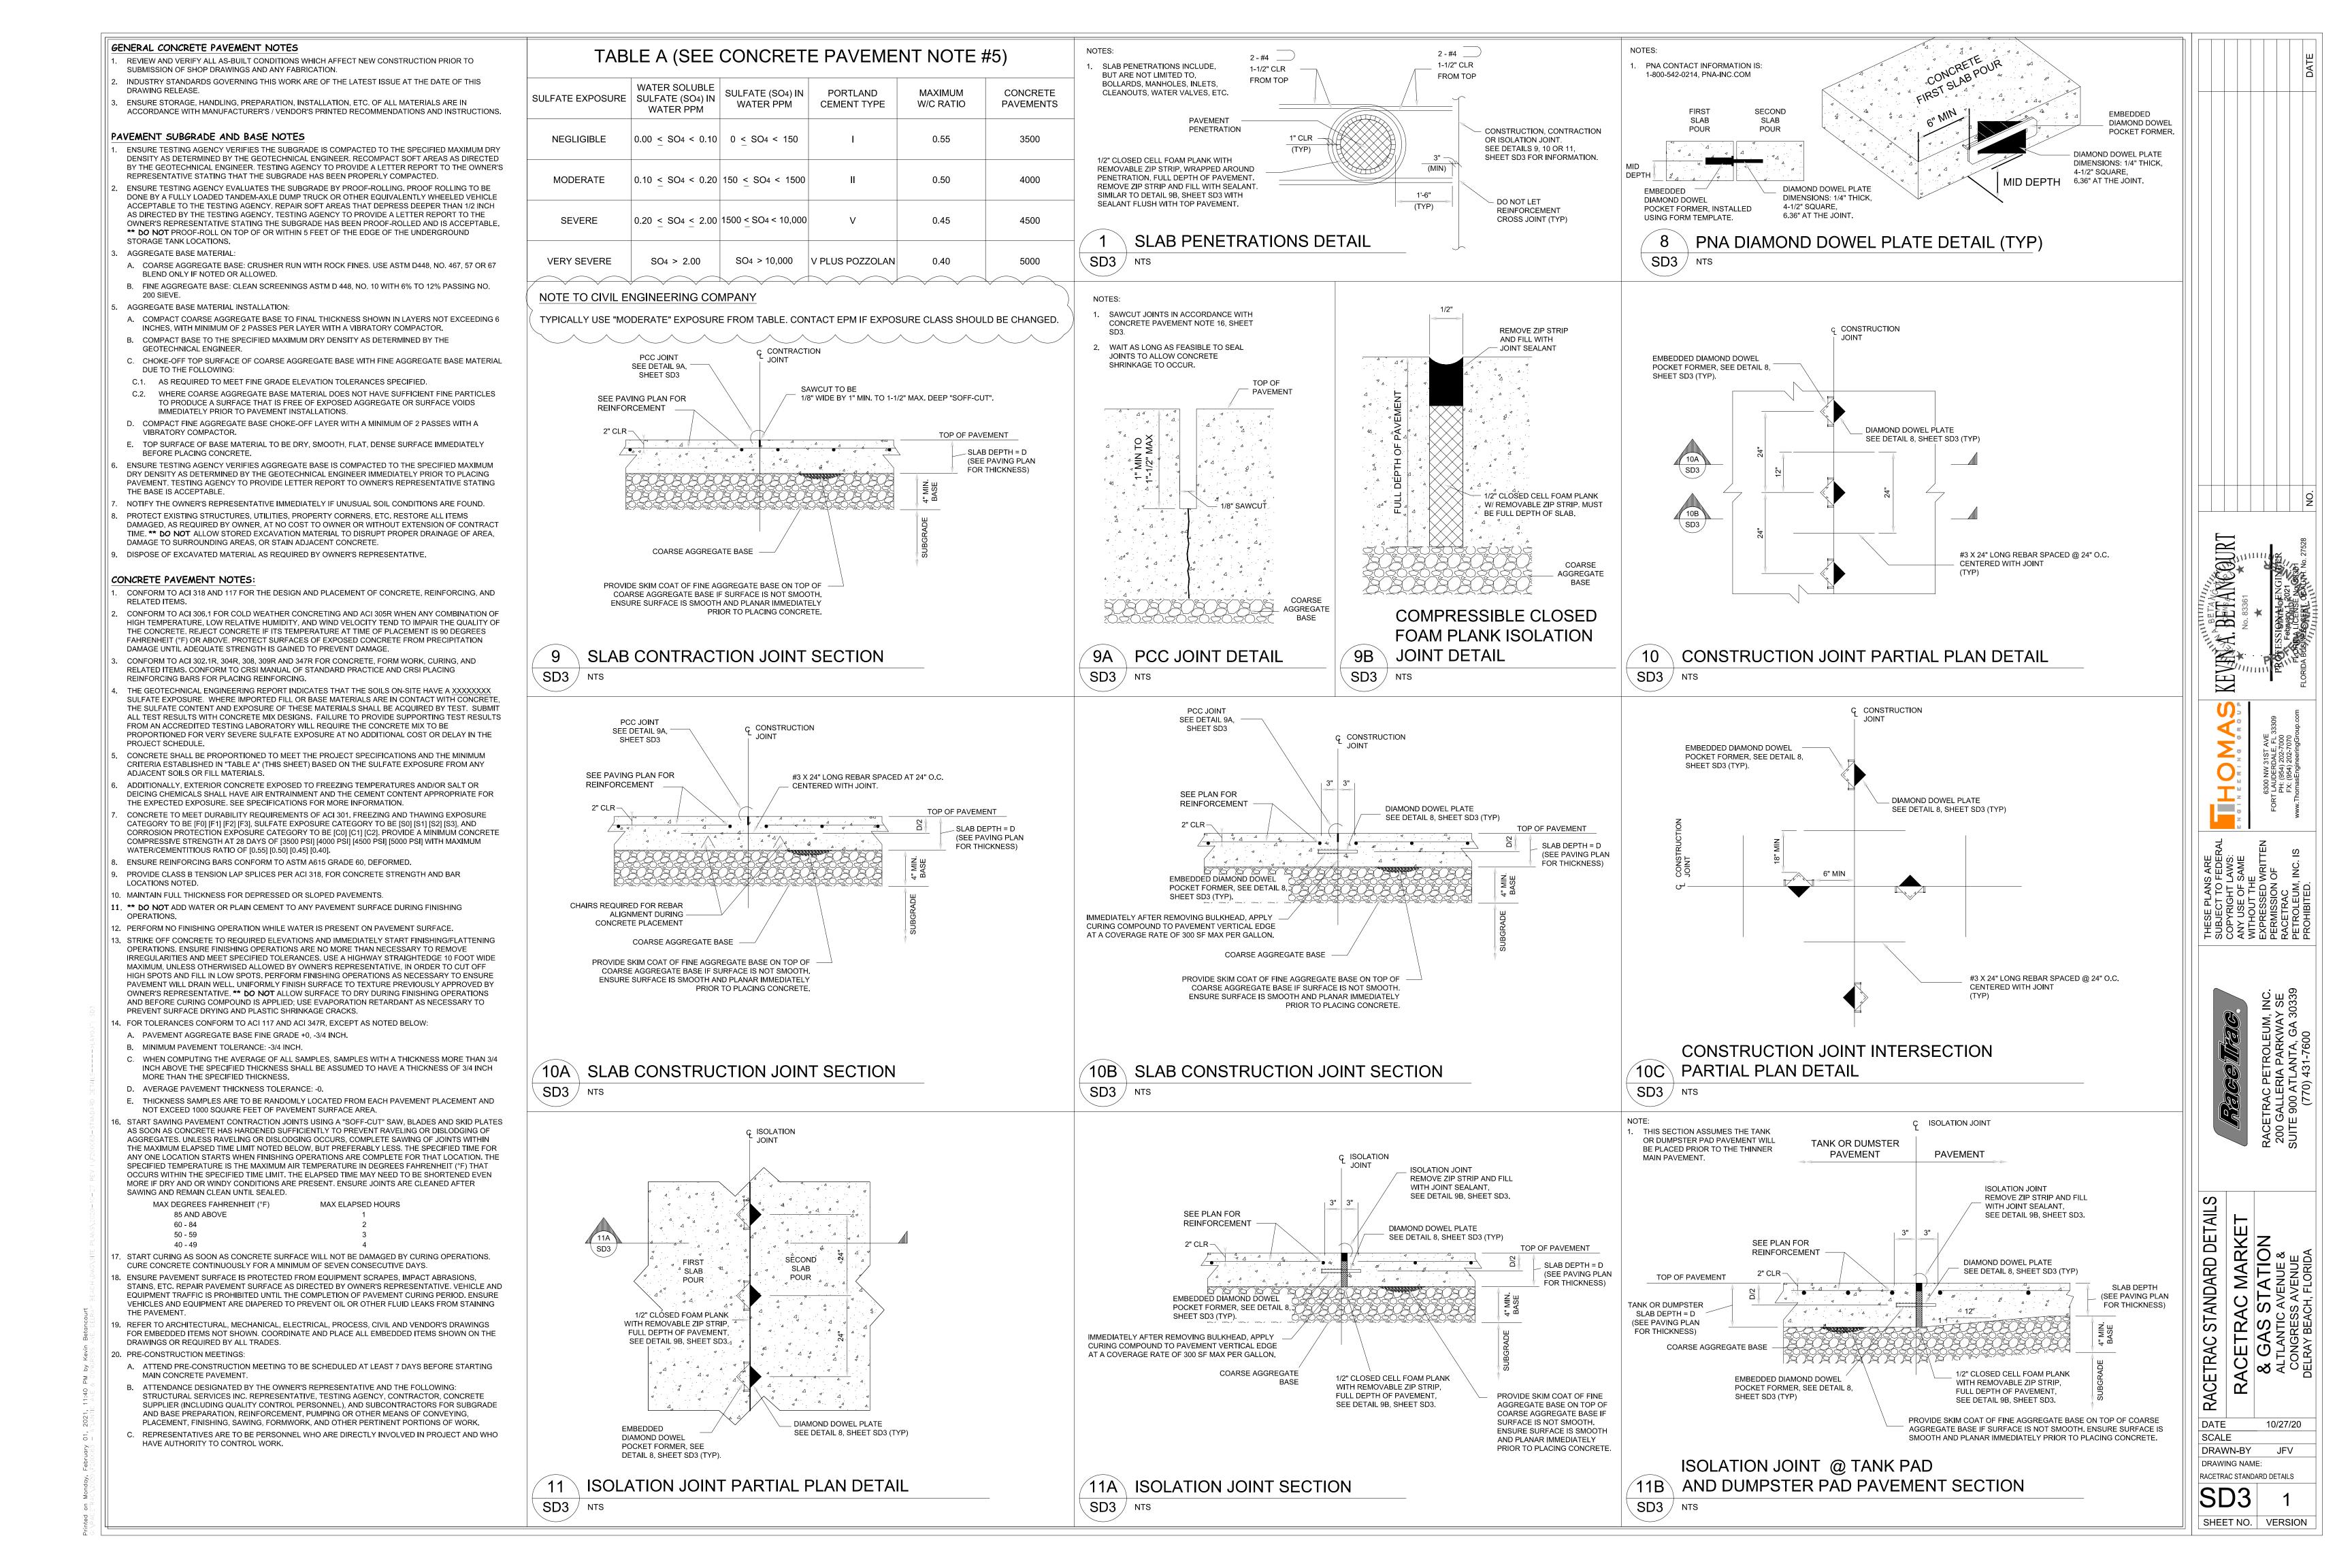

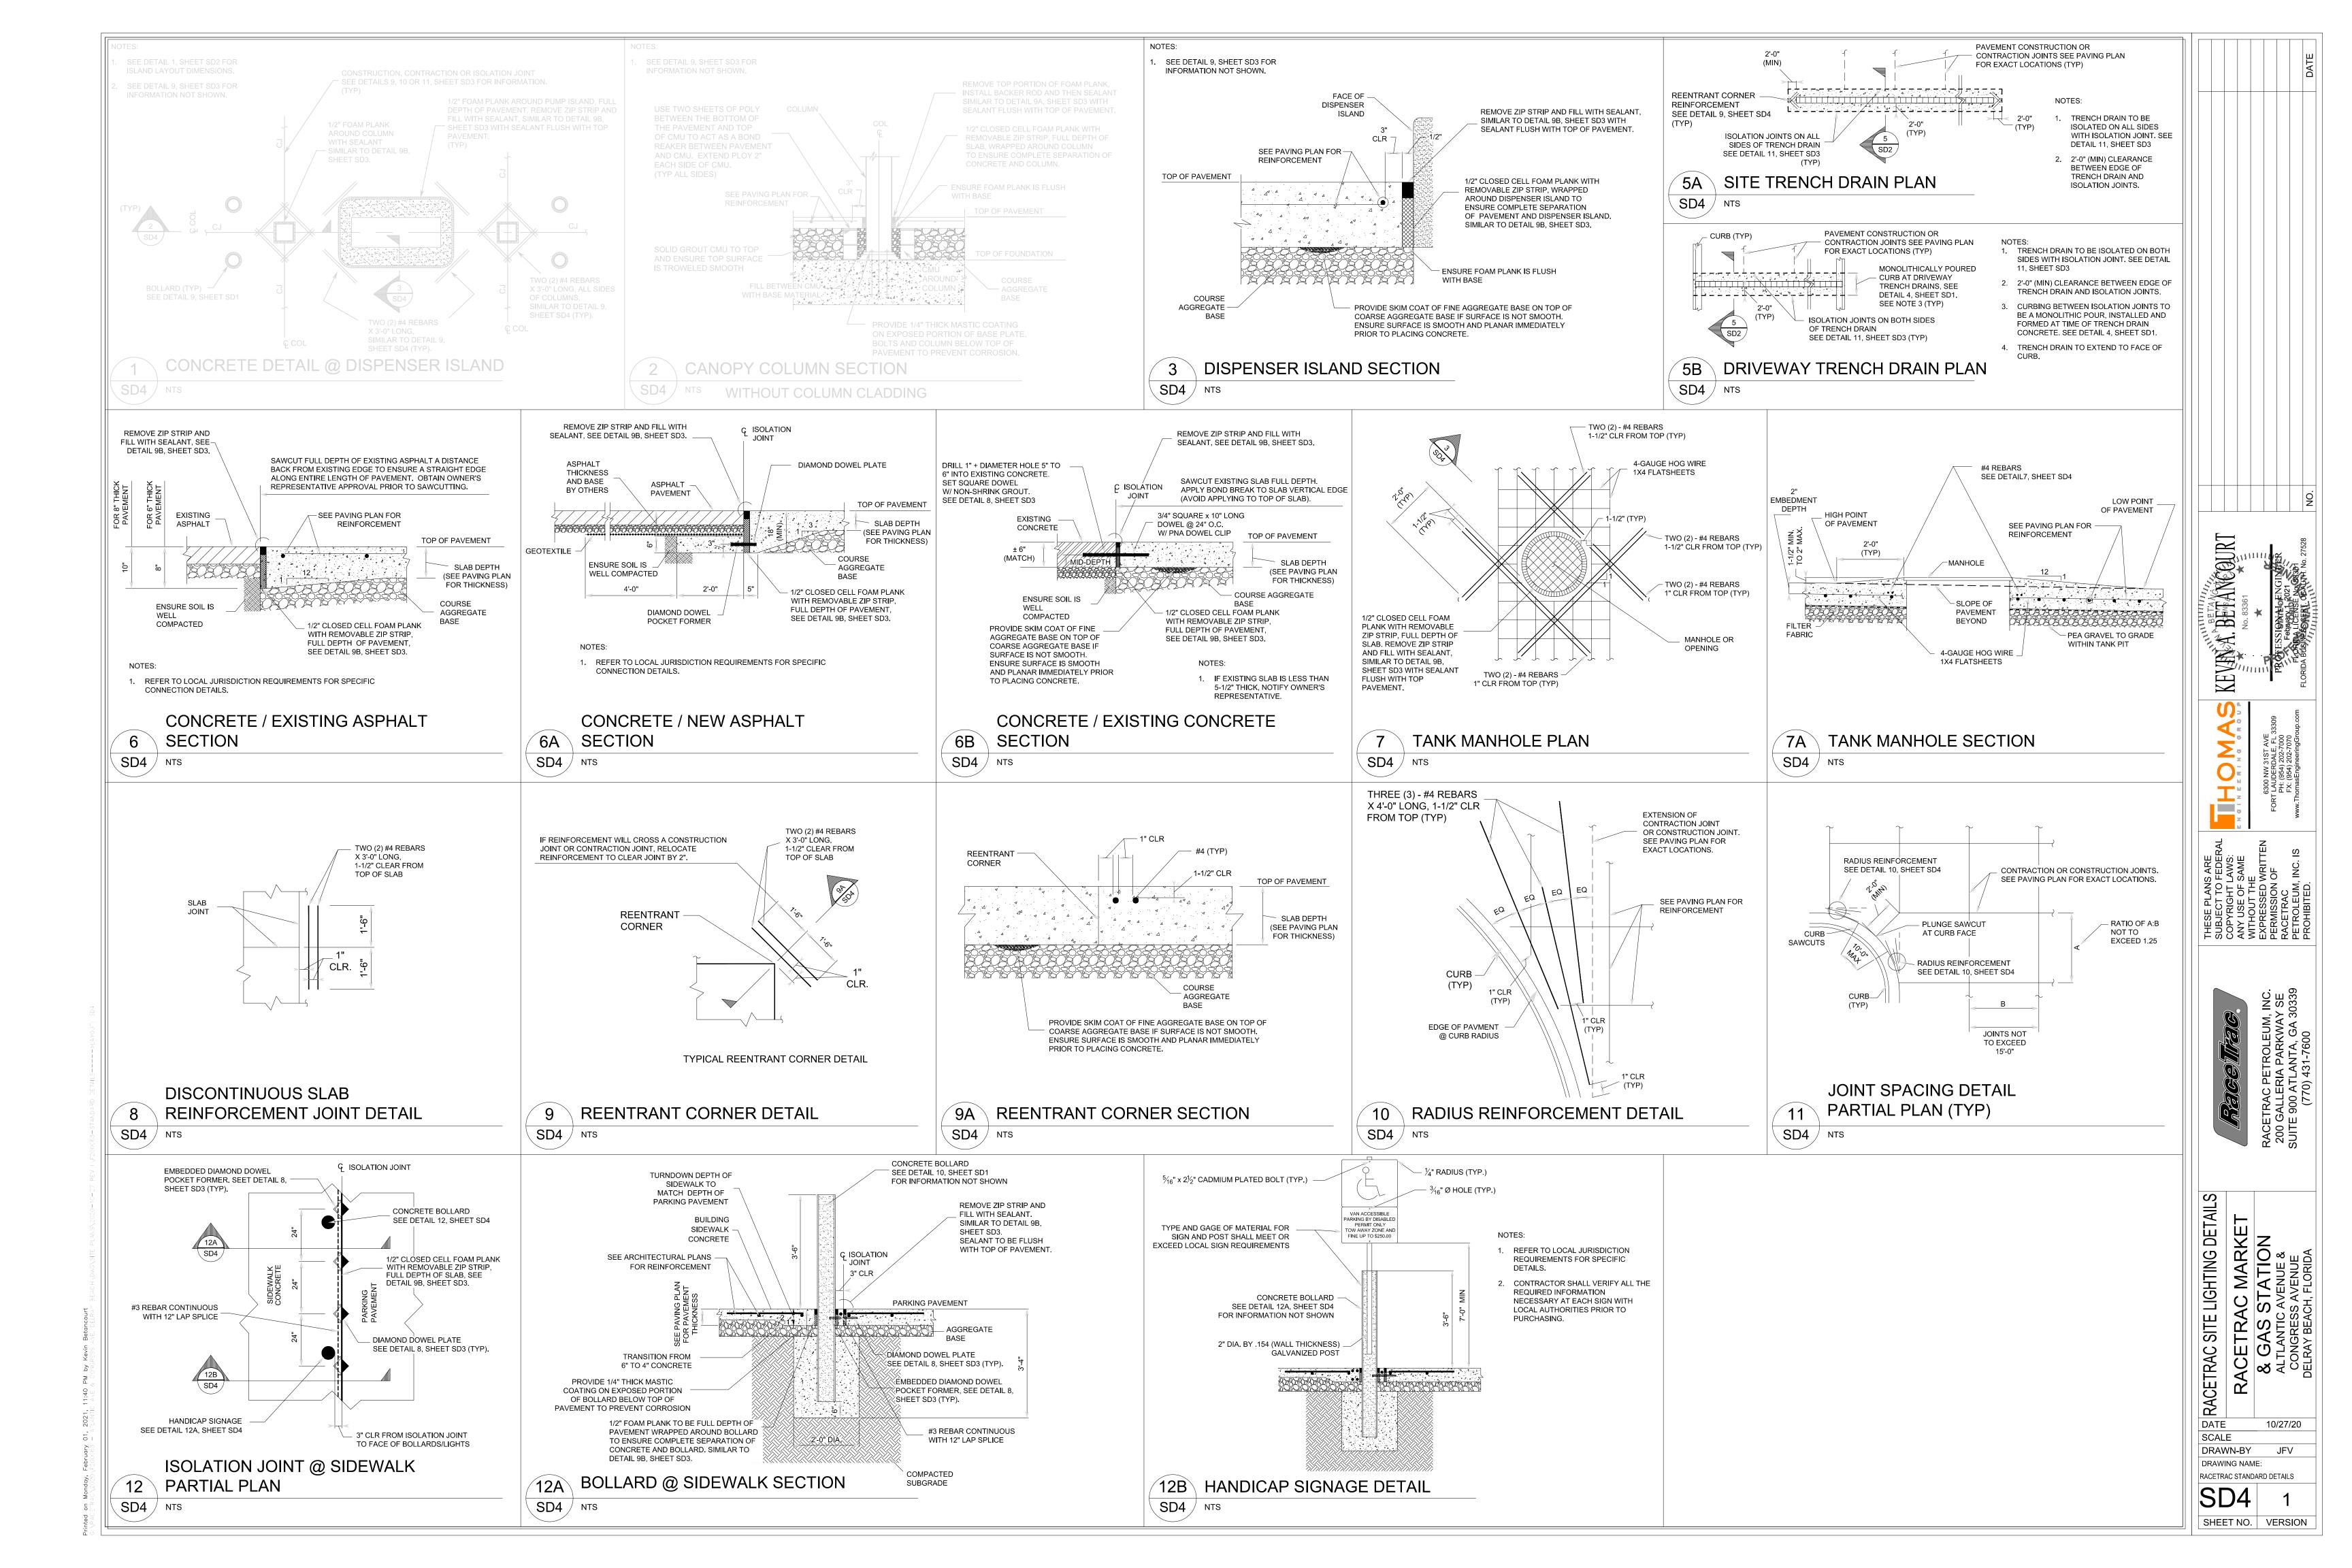

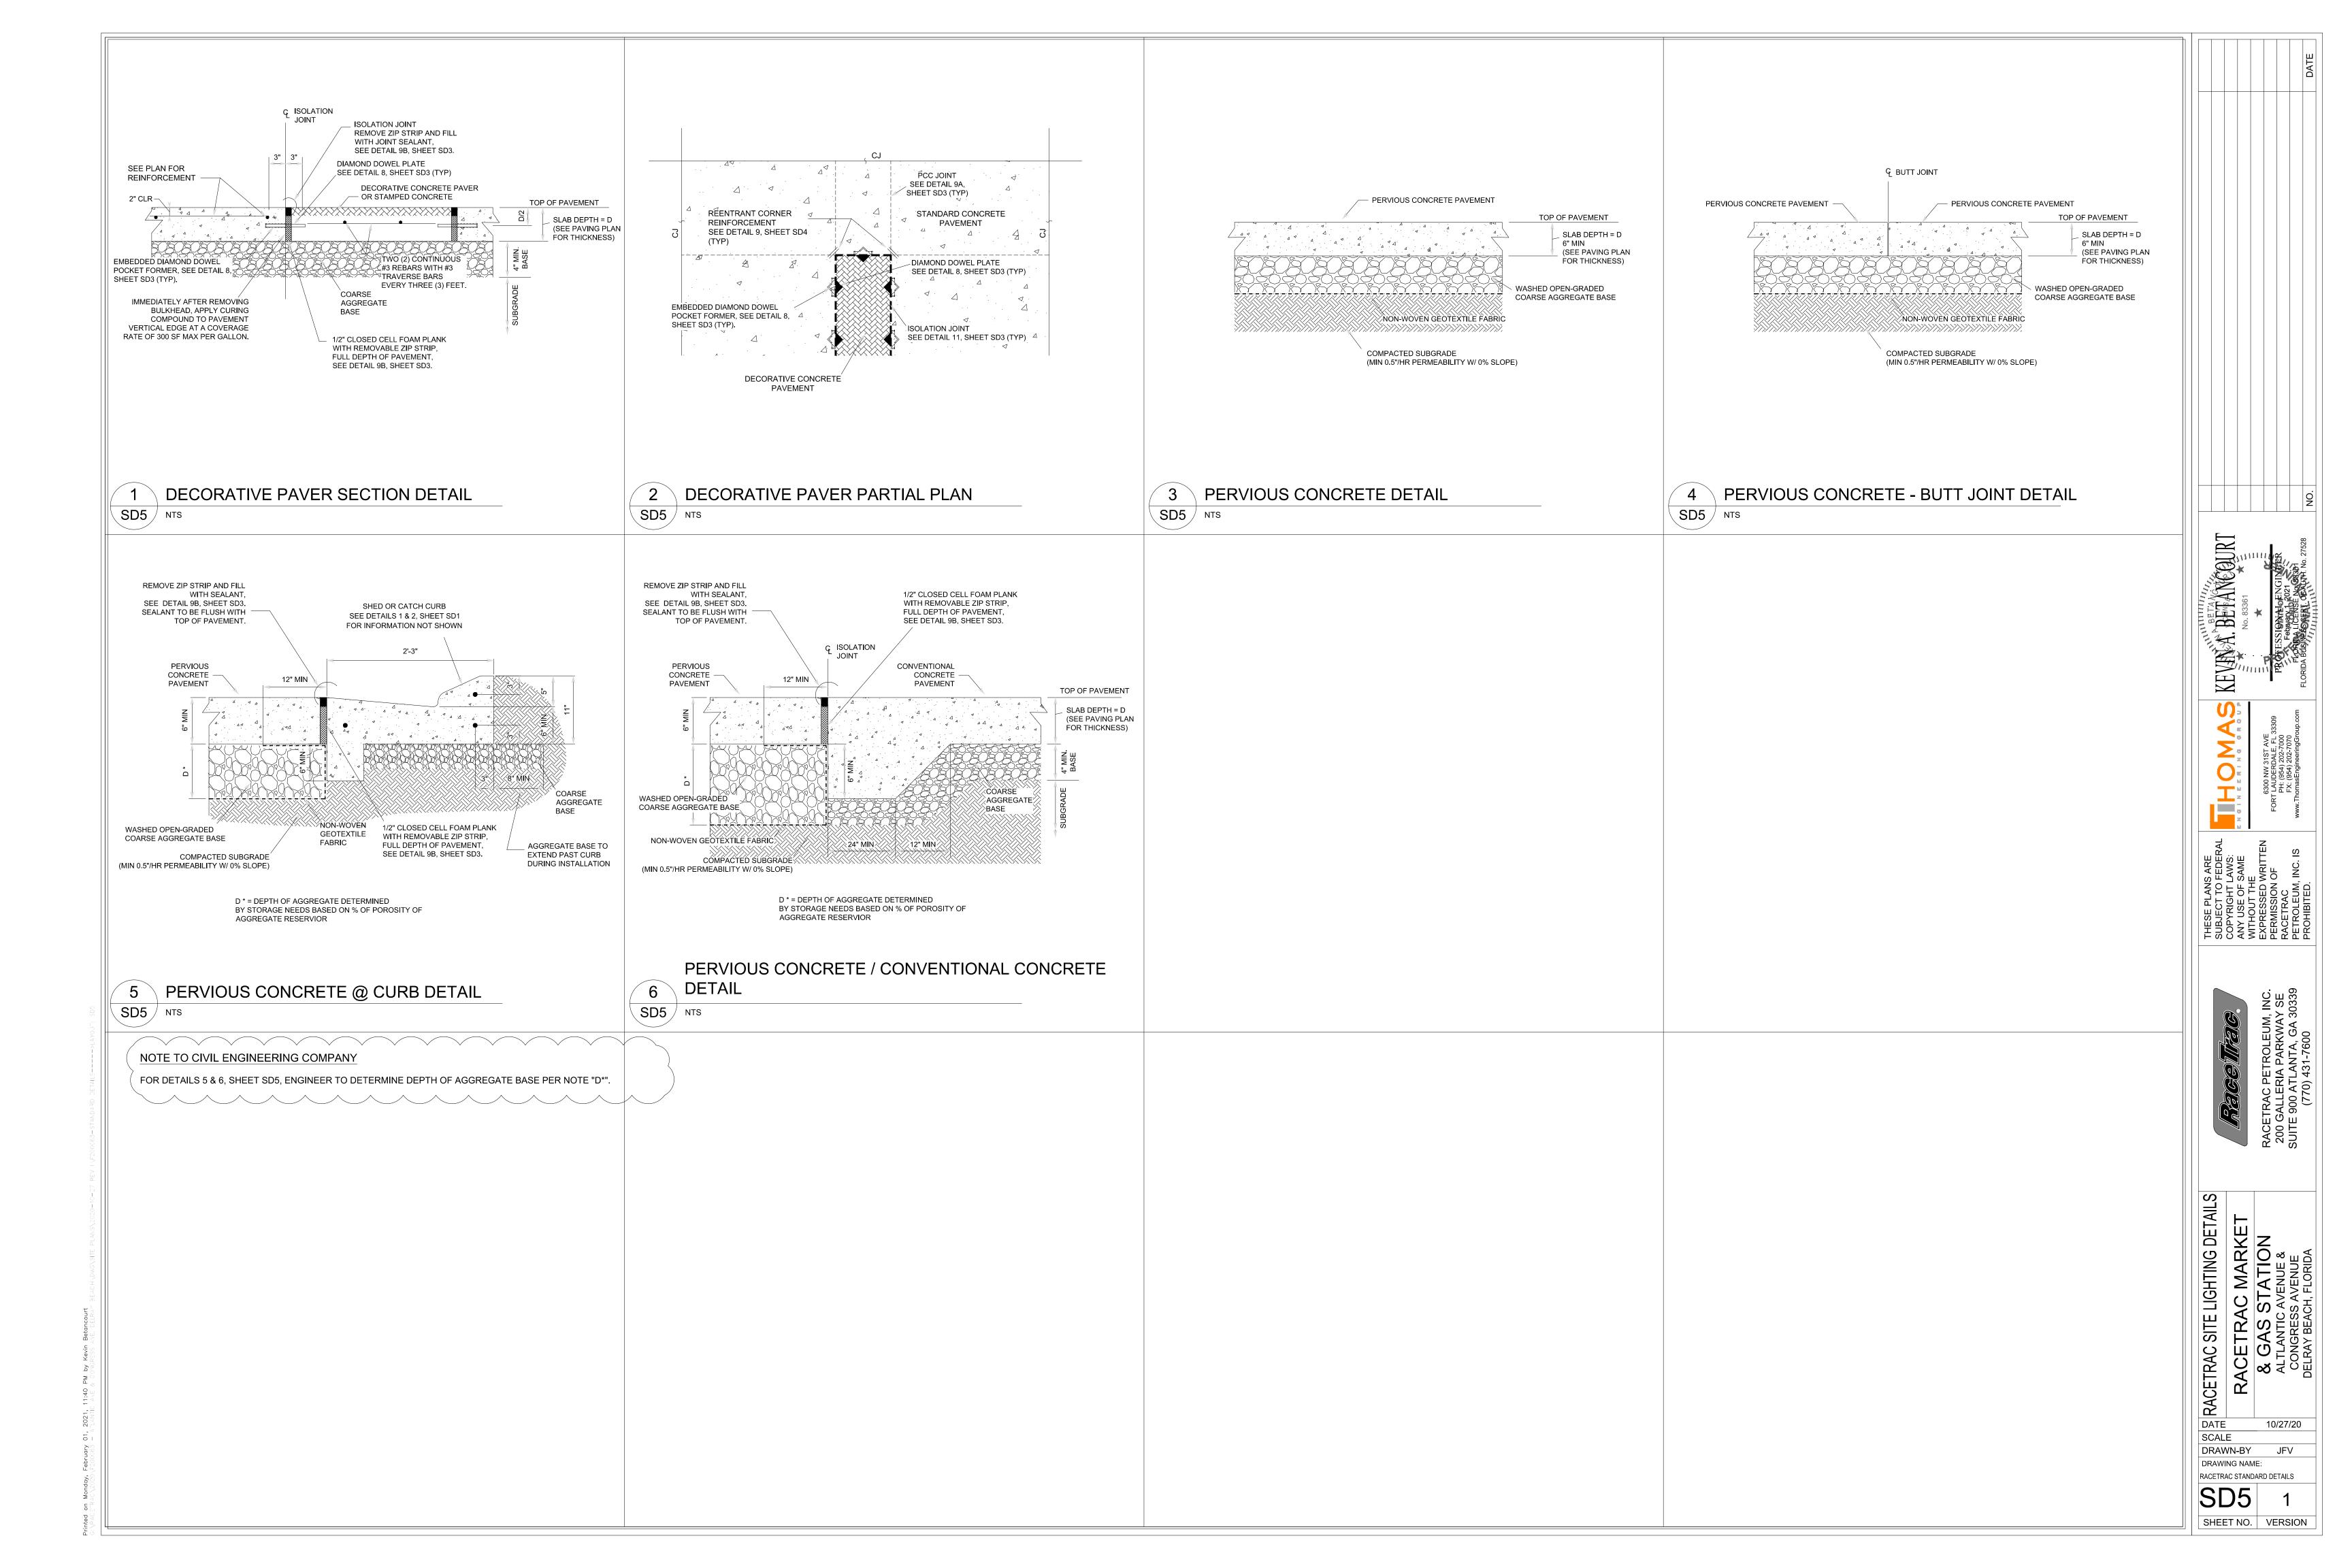

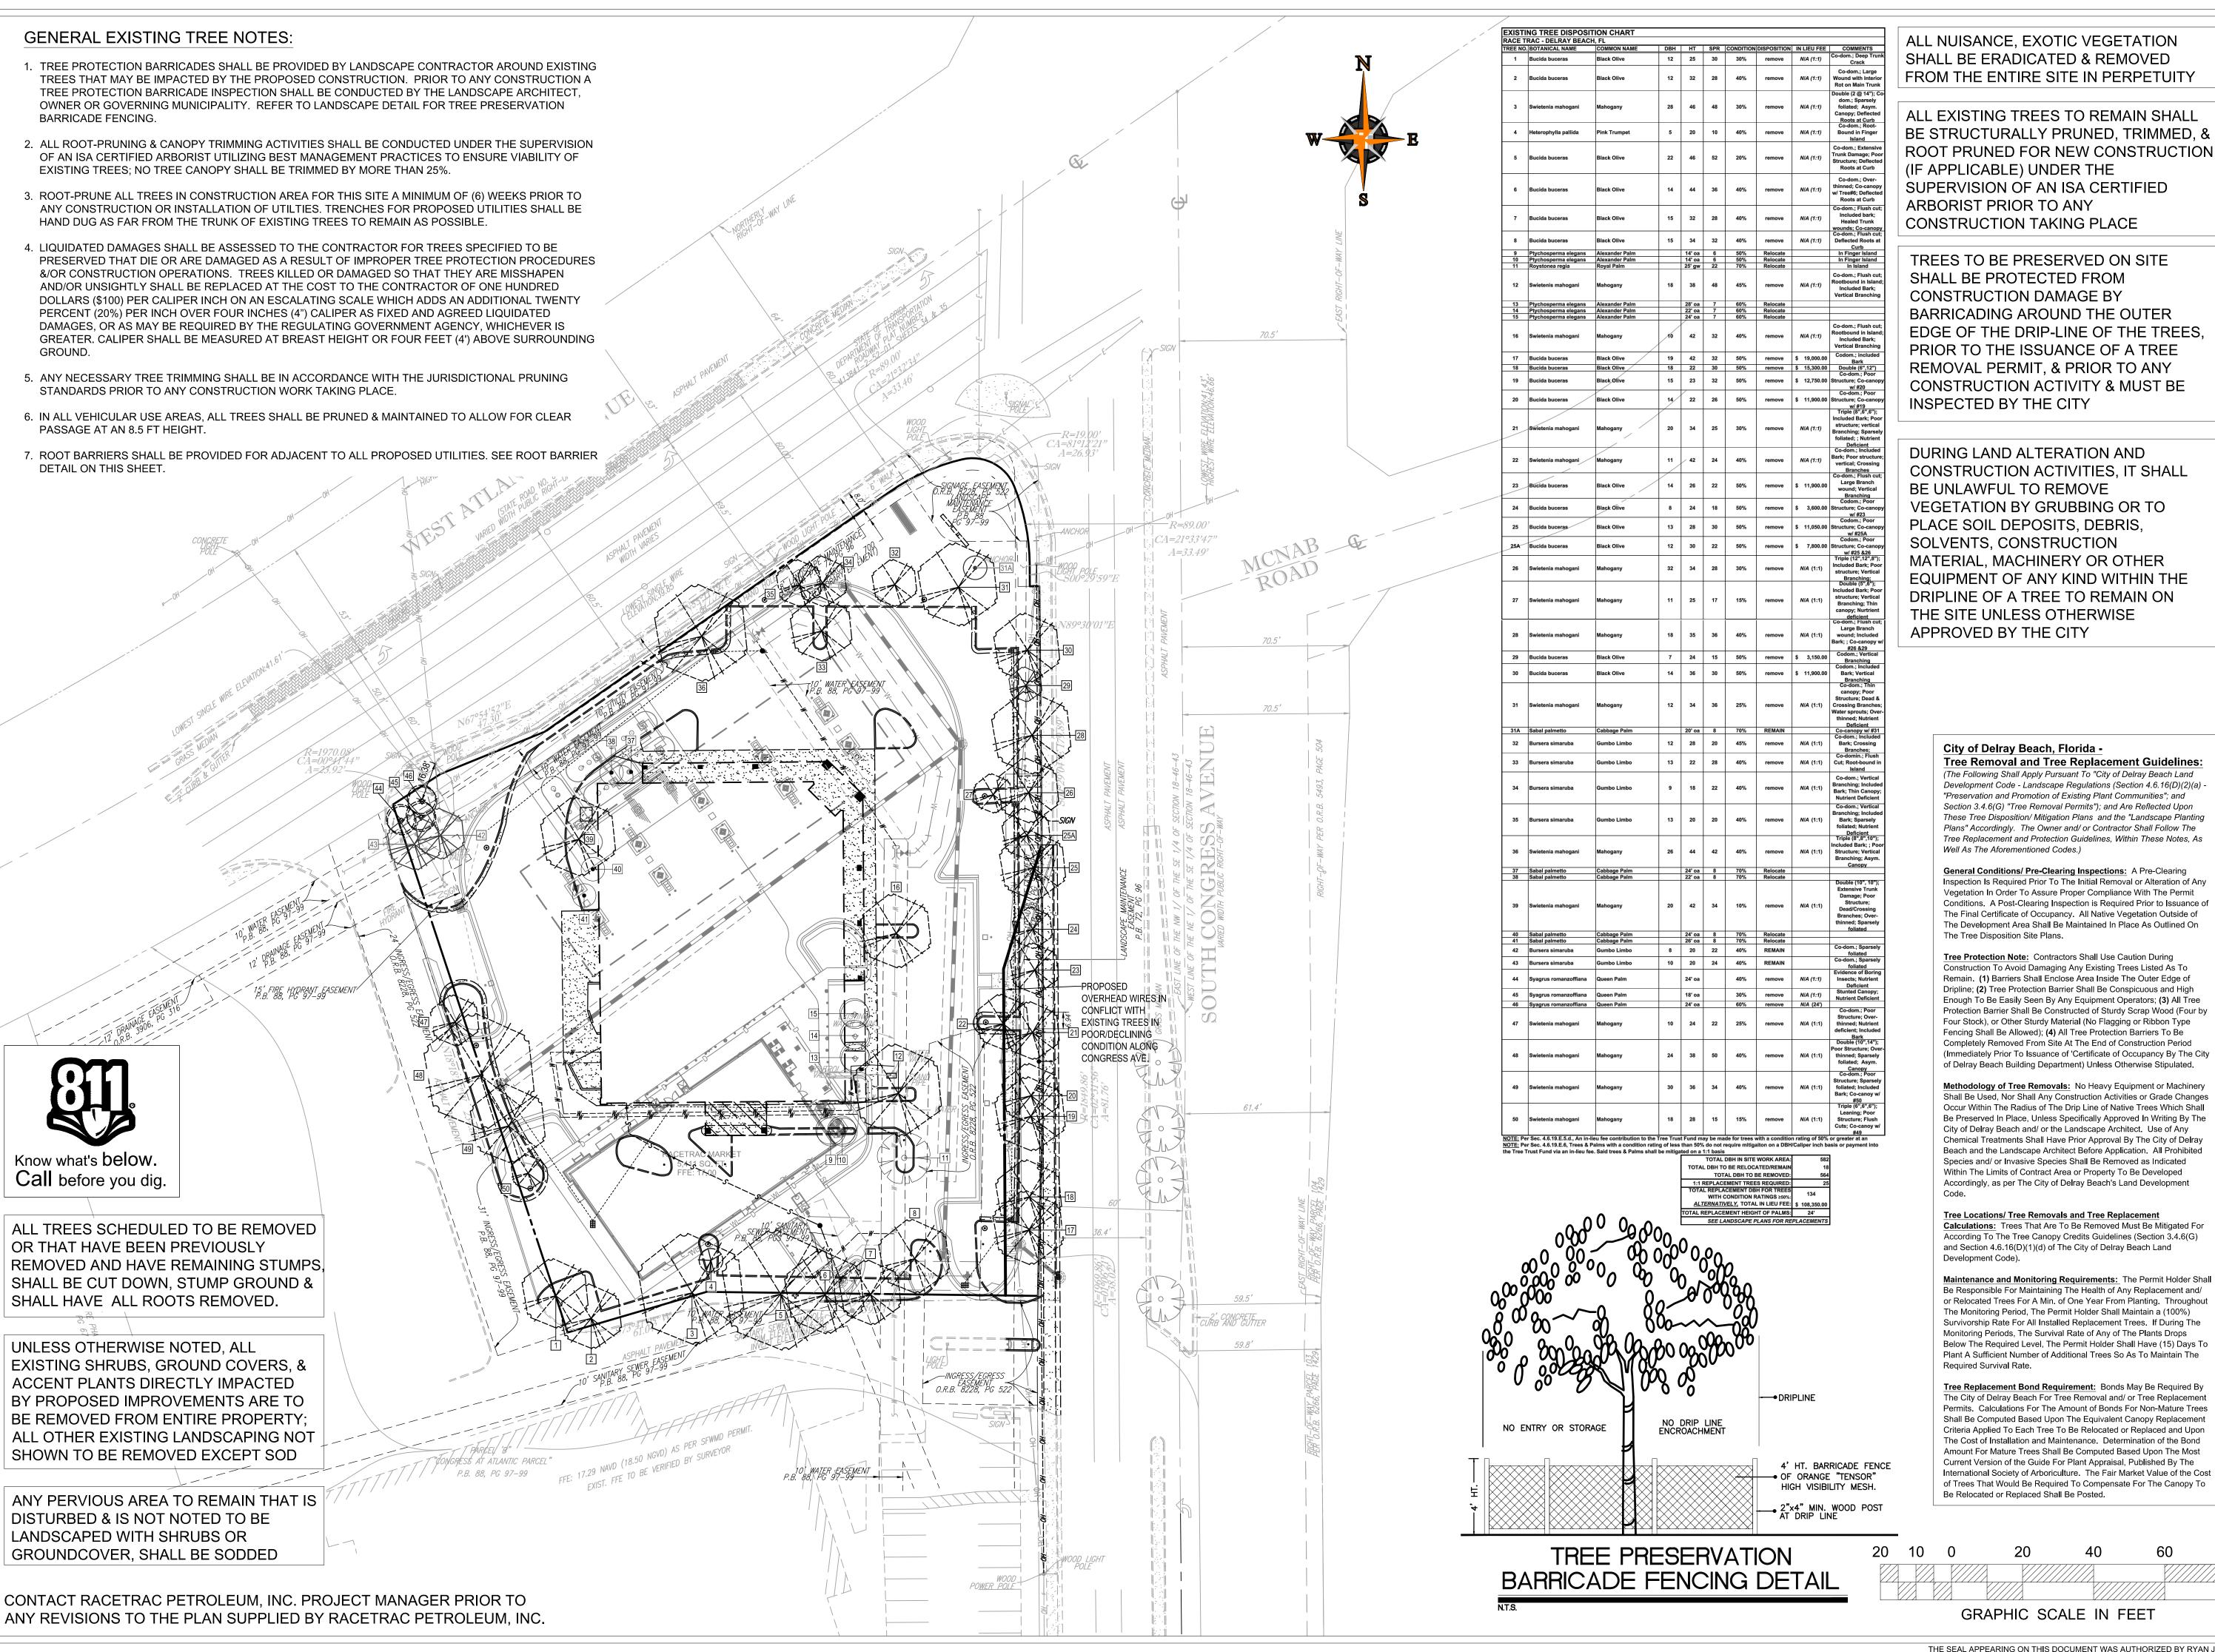

SHALL BE ERADICATED & REMOVED FROM THE ENTIRE SITE IN PERPETUITY

BE STRUCTURALLY PRUNED, TRIMMED, & ROOT PRUNED FOR NEW CONSTRUCTION SUPERVISION OF AN ISA CERTIFIED

EDGE OF THE DRIP-LINE OF THE TREES, PRIOR TO THE ISSUANCE OF A TREE CONSTRUCTION ACTIVITY & MUST BE

CONSTRUCTION ACTIVITIES, IT SHALL **EQUIPMENT OF ANY KIND WITHIN THE** DRIPLINE OF A TREE TO REMAIN ON

> (The Following Shall Apply Pursuant To "City of Delray Beach Land Development Code - Landscape Regulations (Section 4.6.16(D)(2)(a) -"Preservation and Promotion of Existing Plant Communities"; and Section 3.4.6(G) "Tree Removal Permits"); and Are Reflected Upon These Tree Disposition/ Mitigation Plans and the "Landscape Planting Plans" Accordingly. The Owner and/ or Contractor Shall Follow The Tree Replacement and Protection Guidelines, Within These Notes, As

DISP(

DATE

SCALE

DRAWN-BY

DRAWING NAME:

SHEET NO. VERSION

2/1/21

1" = 20'

General Conditions/ Pre-Clearing Inspections: A Pre-Clearing Inspection Is Required Prior To The Initial Removal or Alteration of Any Vegetation In Order To Assure Proper Compliance With The Permit Conditions. A Post-Clearing Inspection is Required Prior to Issuance of The Final Certificate of Occupancy. All Native Vegetation Outside of The Development Area Shall Be Maintained In Place As Outlined On

Construction To Avoid Damaging Any Existing Trees Listed As To Remain. (1) Barriers Shall Enclose Area Inside The Outer Edge of Dripline; (2) Tree Protection Barrier Shall Be Conspicuous and High Enough To Be Easily Seen By Any Equipment Operators; (3) All Tree Protection Barrier Shall Be Constructed of Sturdy Scrap Wood (Four by Four Stock), or Other Sturdy Material (No Flagging or Ribbon Type Fencing Shall Be Allowed); (4) All Tree Protection Barriers To Be Completely Removed From Site At The End of Construction Period (Immediately Prior To Issuance of 'Certificate of Occupancy By The City of Delray Beach Building Department) Unless Otherwise Stipulated.

Shall Be Used, Nor Shall Any Construction Activities or Grade Changes Occur Within The Radius of The Drip Line of Native Trees Which Shall Be Preserved In Place, Unless Specifically Approved In Writing By The City of Delray Beach and/ or the Landscape Architect. Use of Any Chemical Treatments Shall Have Prior Approval By The City of Delray Beach and the Landscape Architect Before Application. All Prohibited Species and/ or Invasive Species Shall Be Removed as Indicated Within The Limits of Contract Area or Property To Be Developed Accordingly, as per The City of Delray Beach's Land Development

Calculations: Trees That Are To Be Removed Must Be Mitigated For According To The Tree Canopy Credits Guidelines (Section 3.4.6(G) and Section 4.6.16(D)(1)(d) of The City of Delray Beach Land

Be Responsible For Maintaining The Health of Any Replacement and/ or Relocated Trees For A Min. of One Year From Planting. Throughout The Monitoring Period, The Permit Holder Shall Maintain a (100%) Survivorship Rate For All Installed Replacement Trees. If During The Monitoring Periods, The Survival Rate of Any of The Plants Drops Below The Required Level, The Permit Holder Shall Have (15) Days To Plant A Sufficient Number of Additional Trees So As To Maintain The

The City of Delray Beach For Tree Removal and/ or Tree Replacement Permits. Calculations For The Amount of Bonds For Non-Mature Trees Shall Be Computed Based Upon The Equivalent Canopy Replacement Criteria Applied To Each Tree To Be Relocated or Replaced and Upon The Cost of Installation and Maintenance. Determination of the Bond Amount For Mature Trees Shall Be Computed Based Upon The Most Current Version of the Guide For Plant Appraisal, Published By The International Society of Arboriculture. The Fair Market Value of the Cost of Trees That Would Be Required To Compensate For The Canopy To

THE SEAL APPEARING ON THIS DOCUMENT WAS AUTHORIZED BY RYAN J. KING EBRAHIMIAN, LA6667324 ON 2021-02-01