DERRICKSON RESIDENCE RENOVATIONS & ADDITIONS 330 NE First Avenue, Delray Beach, Florida 33444

Note: COA 2021-199 & Submitted for Historic Preservation Board Review on October 6, 2021



STRUCTURAL ENGINEER:

PENNONI, INC.

Consulting Structural Engineers
Robert Selinsky, PE, SI,
601 N. Congress Ave, Ste. 106a,
Delray Beach, FL 33445
(561) 870-8826
email: rselinsky@pennoni.com
PE # 49952

MEP ENGINEER:

ROCAMAR ENGINEERING SERVICES, INC. Mr. Bernardo Cardenal, PE 6401 Congress Ave., Ste 230 Boca Raton, FL. 33487 (561) 276-9898, cell: (561) xxxx email: bernardoc@rocamareng.com PE #38300

ARCHITECT:

SLOAN & SLOAN, INC.-ARCHITECTS & INT. DESIGNERS Dan Sloan, AIA, Project Mgr. 106 SE 7th Ave., Ste. B Delray Beach, FL 33483 (561) 243-8755 email: dan@sloandesign.biz

AR 95577 & AA26002208

CIVIL ENGINEER:

ENVIRODESIGN ASSOC., INC.-CIVIL ENGINEERS Joe Pike, PE, Project Mgr. 298 Pineapple Grove Way Delray Beach, FL 33444 (561) 274-6500 email: jpike@envdesign.Com

LANDSCAPE ARCHITECT:

Murakami Landscape Architects,Inc.-LANDSCAPE ARCHITECTS Don Murakami, LA, Project Mgr. 326 NE 1st Ave, Delray Beach, FL. 33444 (561) 276-7750 email: don@mlandscape.net LA 0001477

OCCUPANCY CLASSIFICATION: SINGLE FAMILY RESIDENTIAL

TYPE OF CONSTRUCTION:

TYPE V -Unprotected / Unsprinkled (Existing 1 Single Family Residential Structure)

APPLICABLE CODES:


2020 FLORIDA BUILDING CODE
2020 FLORIDA MECHANICAL CODE
2020 FLORIDA ELECTRICAL CODE
2020 FLORIDA PLUMBING CODE
2020FLORIDA BUILDING CODE
2008 ICC 600- std. for residential construction in high wind areas

Public Super Marks, at Concerns on the Concerns of the Concern

330 N De Zon	rickson Residence NE 1st Avenue, Delray Beach, FL PESIGN Parameters- revised 2/10/20 ing: Single Family: OSSHAD Derrickson_SiteTblns&DsnParamtrs.xls	21	
#	ITEM		-
1	OCCUPANCY: (Single Family, Multifamily, Commercial, Industrial, Institutional)	Single Family	SEC. R301.2.1.4.3 2020 FLORIDA RESIDENTIAL CODE
2	EXPOSURE CONDITION:	<u>B</u>	
3	MEAN ROOF HEIGHT: Feet (Principal Roof Form)	22.3'	(above average grade)
4	BUILDING HEIGHT: (if < or = 60' may use FBC 2020 Low Rise Provisions. If >60' use ASCE7-16		X < or = 60' Height > 60' Height
5	BUILDING DESIGNED AS:		Partly enclosed Enclosed Open Tested (Wind Tunnel)
6	IMPORTANCE FACTOR: (Determined by Building Use /Occupancy. Refer to FBC 2020 or ASCE 7-16)	<u>1.0</u>	
7	BASIC WIND VELOCITY PRESURES: FBC 2020. VI POSITIVE/VEGATIVE PRESSURE COEFFICIENTS APPLIED TO MAIN WIND FORCE RESISTING SYS ENVELOPE COMPONENTS & CLADDING AS APPLI	HAVE BEEN TEM, OR BUILD	
	FBC 2020 WIND SPEED: FBC 2020 BASIC VELOCITY PRESSURE:	<u>132</u> <u>32</u>	(Wind Speed in mph) IN PSF
	ASCE 7-16 WIND SPEED: ASCE 7-16 BASIC VELOCITY PRESSURE:	<u>170</u> n/a	(Ultimate Wind Speed in mp IN PSF
	NOTE: Actual Design Pressures for All Exterior W Garage Doors, and Similar Envelope Elements Mu Indicated on Construction Plans.		•
8	ROOF DEAD LOAD (Actual Dead Load of Materials Used for Determining Net Uplift Reactions.	<u>15</u>	LBS
9	SOIL BEARING CAPACTIY: (Supported by Soils Report from Geotechnical Engineer)	<u>2500</u>	PSF
	REVIEWED FOR SHEARWALL REQUIREMENTS:		Yes No (if no Explain why)

A1.01 Site A1.02 Site A1.03 Com A1.04 Stree	rer Sheet e Plan- Existing Configuration e Plan- New Proposed Configuration	Includes W/ Consultant List, Location Map, Drawing List Showing Setbacks, Driveway, Pool Deck Areas
A1.01 Site A1.02 Site A1.03 Com A1.04 Stree	Plan- Existing Configuration Plan- New Proposed Configuration	
A1.01 Site A1.02 Site A1.03 Com A1.04 Stree	Plan- Existing Configuration Plan- New Proposed Configuration	
A1.02 Site A1.03 Com A1.04 Stree	Plan- New Proposed Configuration	Showing Secuacks, Driveway, Pool Deck Areas
A1.03 Com A1.04 Stree		Showing New Additions, Garage, Gst Cott. Addition
A1.04 Stree	nposite Site Plan- Old/New Configurations	Showing New Additions, Garage, Gst Cott. Addition
	eetscape & Areal Photo Site Plan-	Showing Subject Property & Adj. Homes to North & South
	a Site Plan-	Showing Subject Property & Adj. Homes to North & South
	sting First Floor Plan	Showing EXTG Elements & General Notes
	nolition Plans- 1st & 2nd Floors	Showing Walls, Doors, Windows, etc. to be removed
	N First Floor Plan	
	arged Door & Window Schedules	644 : 2 : 1
	W & OLD First Floor Plans	of Main Residence
	N Outbuildings First & 2nd Floor Plans sting Second Floor Plan	For New 2 Story Garage & 1 Story Guest Cottage With Additional Notes/Details
	W Second Floor Plan	With Additional Notes/Details With Additional Notes/Details
	W & OLD Second Floor Plans	of Main Residence
	V Roof Plan	With Roofing Notes/Details/Specs
		Main Hse: Showing Extg. Windows, Doors, & Exterior Elements
		Showing Extg Home & New Additions to Home
	i	Showing Both Extg & New Elevations of Main House
	W & OLD East, & West Elevtns of Main House W Notated East Elevation	Extg & New Elevations w SIMPLIFIED RAILING DESIGN With Materials/Colors/Finishes Noted
	W North, & South Elevations of Main House	Showing Extg Home & New Additions to Home
	W & OLD North, & So. Elevtns of Main House	Showing Both Extg & New Elevations of Main House
	W & OLD North, & So. Elevtris of Main House	Extg & New Elevations w SIMPLIFIED RAILING DESIGN
	N North, South, East, West Outbldg Elevations	
A 4 0 2 NEW	W.F. Flavortion / Continue Wall at Del Lik Franck Dougle	Chausing Castion 2 9 Castion/Flavation 2
A4.02 NEW	V E. Elevation/Section "3" at Dbl.Ht.Front Porch	Showing Section "2" & Section/Elevation "3"
		Showing New Proposed French & BiFold French Doors

The Work Shown in these Plans Shall Comply with the 2020 Florida Building Code w/ any Amendments and (as applicable) the same version of the Florida Mechanical, Electrical, Plumbing, and Existing Building Code(s). Framing and Other Structural Details will also comply with ICC-600 (Previously SSTD 10-99).

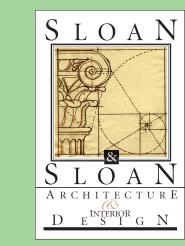

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ickson Residence
A 5/16/09 Issue Note
o. Date Issue Notes

A 5/16/09 Issue Note

No. Date Issue Notes

Daniel Sloan, AR9557

Date:

Sloan & Sloan- Architecture + L.D.

Sloan & Sloan- Architecture + I.D. 106 SE 7th Avenue, Ste. B Delray Bch, FL 33483 (561) 243-8755

Consultant

Derrickson Residence Renovations & Additions 330 NE 1st Avenue

Drawing Title COVER SHEET

D. Sloan

Drawn By
D. Sloan

Reviewed By
D. Sloan

Date

8/22/2021

CAD File Name

D. Sloan

Drawing No.

A0.00 coa

Total Sheets

Cover Sheet A0.00


DERRICKSON RESIDENCE RENOVATIONS & ADDITIONS 330 NE First Avenue, Delray Beach, Florida 33444 Note: COA 2021-199 & Submitted for Historic Preservation Board Review on October 6, 2021





View of Proposed Home from East

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Derrickson Residenc	Renovations & Additions
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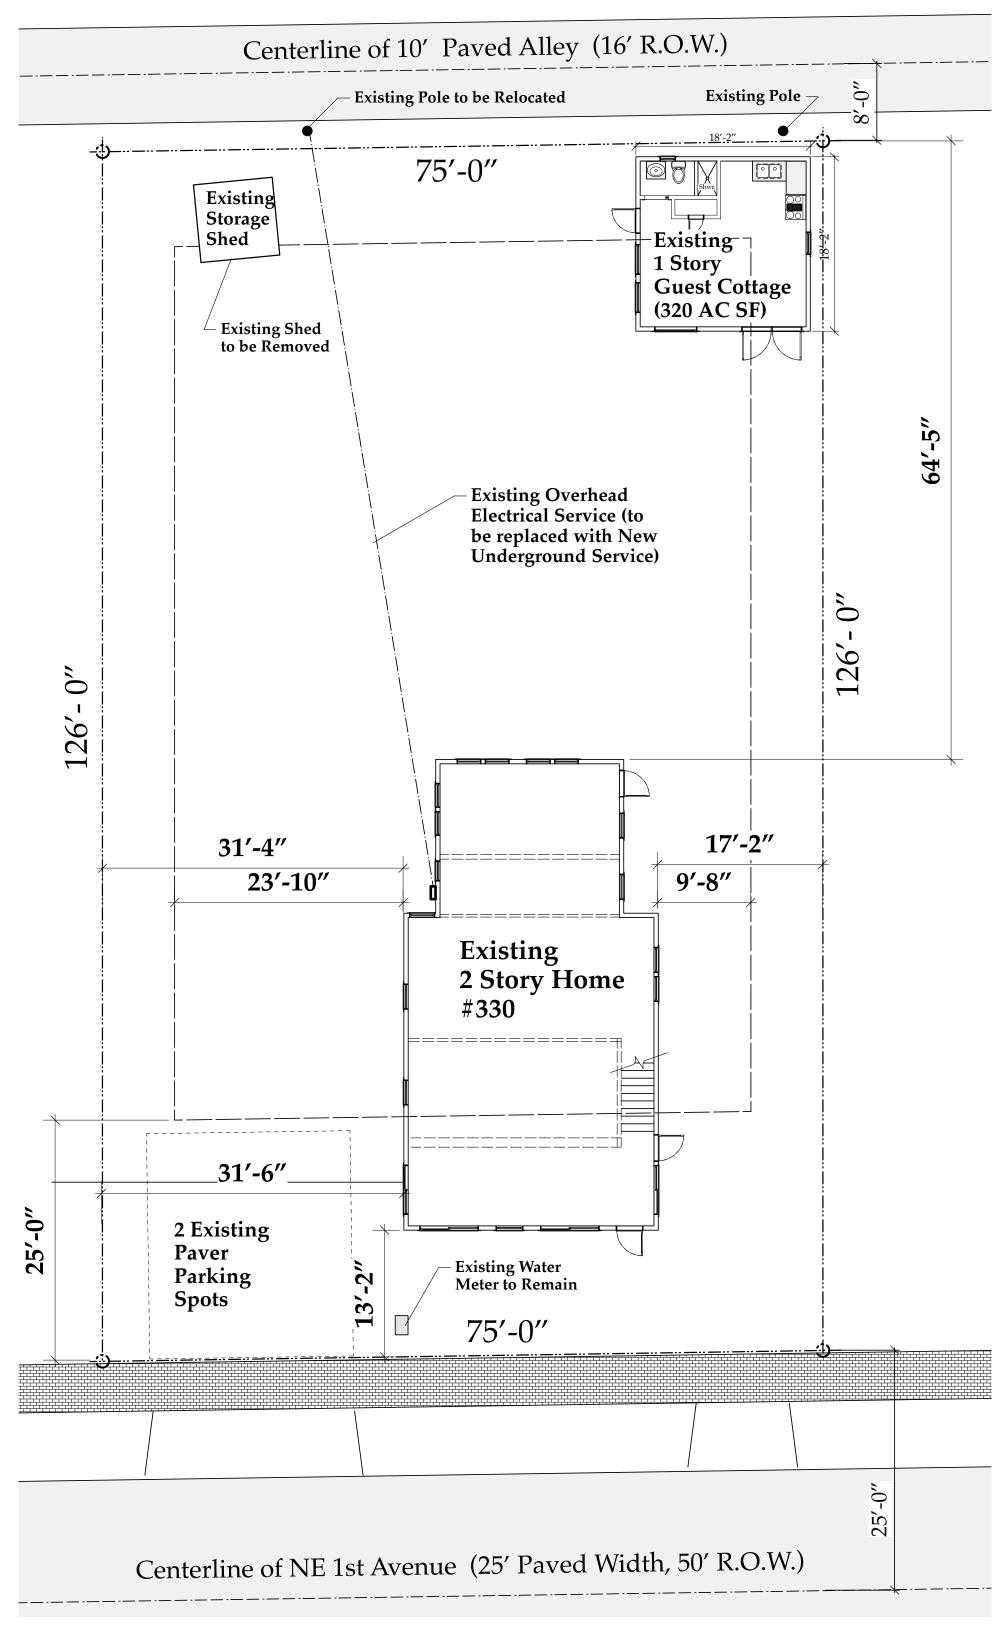
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Derrickson Residence Renovations & Additions 330 NE 1st Avenue

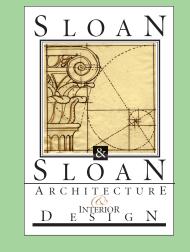Artistic Rendering-View from East of Property


Artistic Rendering A0.00rend

	Project Manager D. Sloan	Project ID Derrickson Residence Project
	Drawn By D. Sloan	Scale As Noted
	Reviewed By D. Sloan	A0.00 rend
	Date 8/22/2021	——————————————————————————————————————
Der	CAD File Name rickson_Reno_ExtgBldg.	Total Sheets vwx



EXISTING SITE PLAN
Scale: 1" = 10 ft

The Work Shown in these Plans Shall Comply with the 2020 Florida Building Code w/ any Amendments and (as applicable) the same version of the Florida Mechanical, Electrical, Plumbing, and Existing Building Code(s). Framing and Other Structural Details will also comply with ICC-600 (Previously SSTD 10-99).

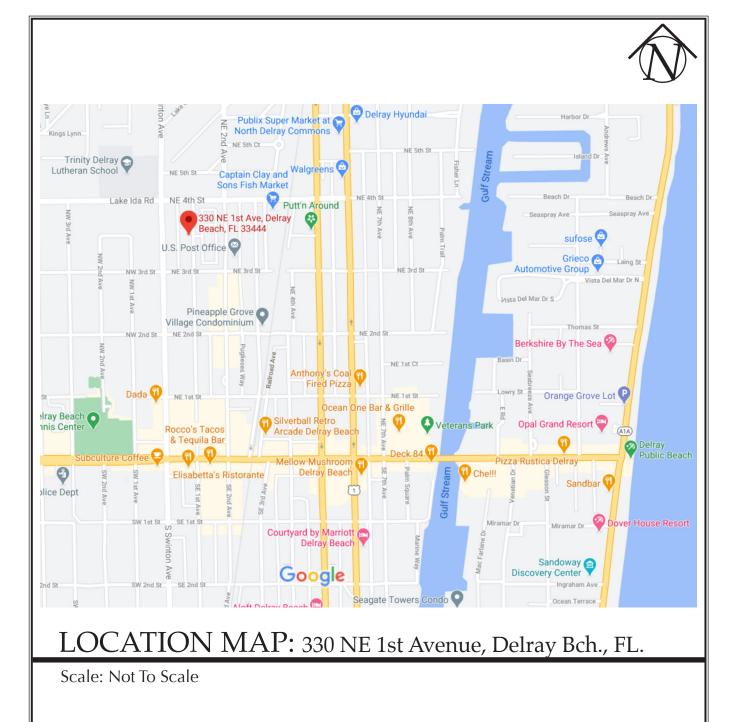



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			- -	<u>Derrickson</u> Renovations &
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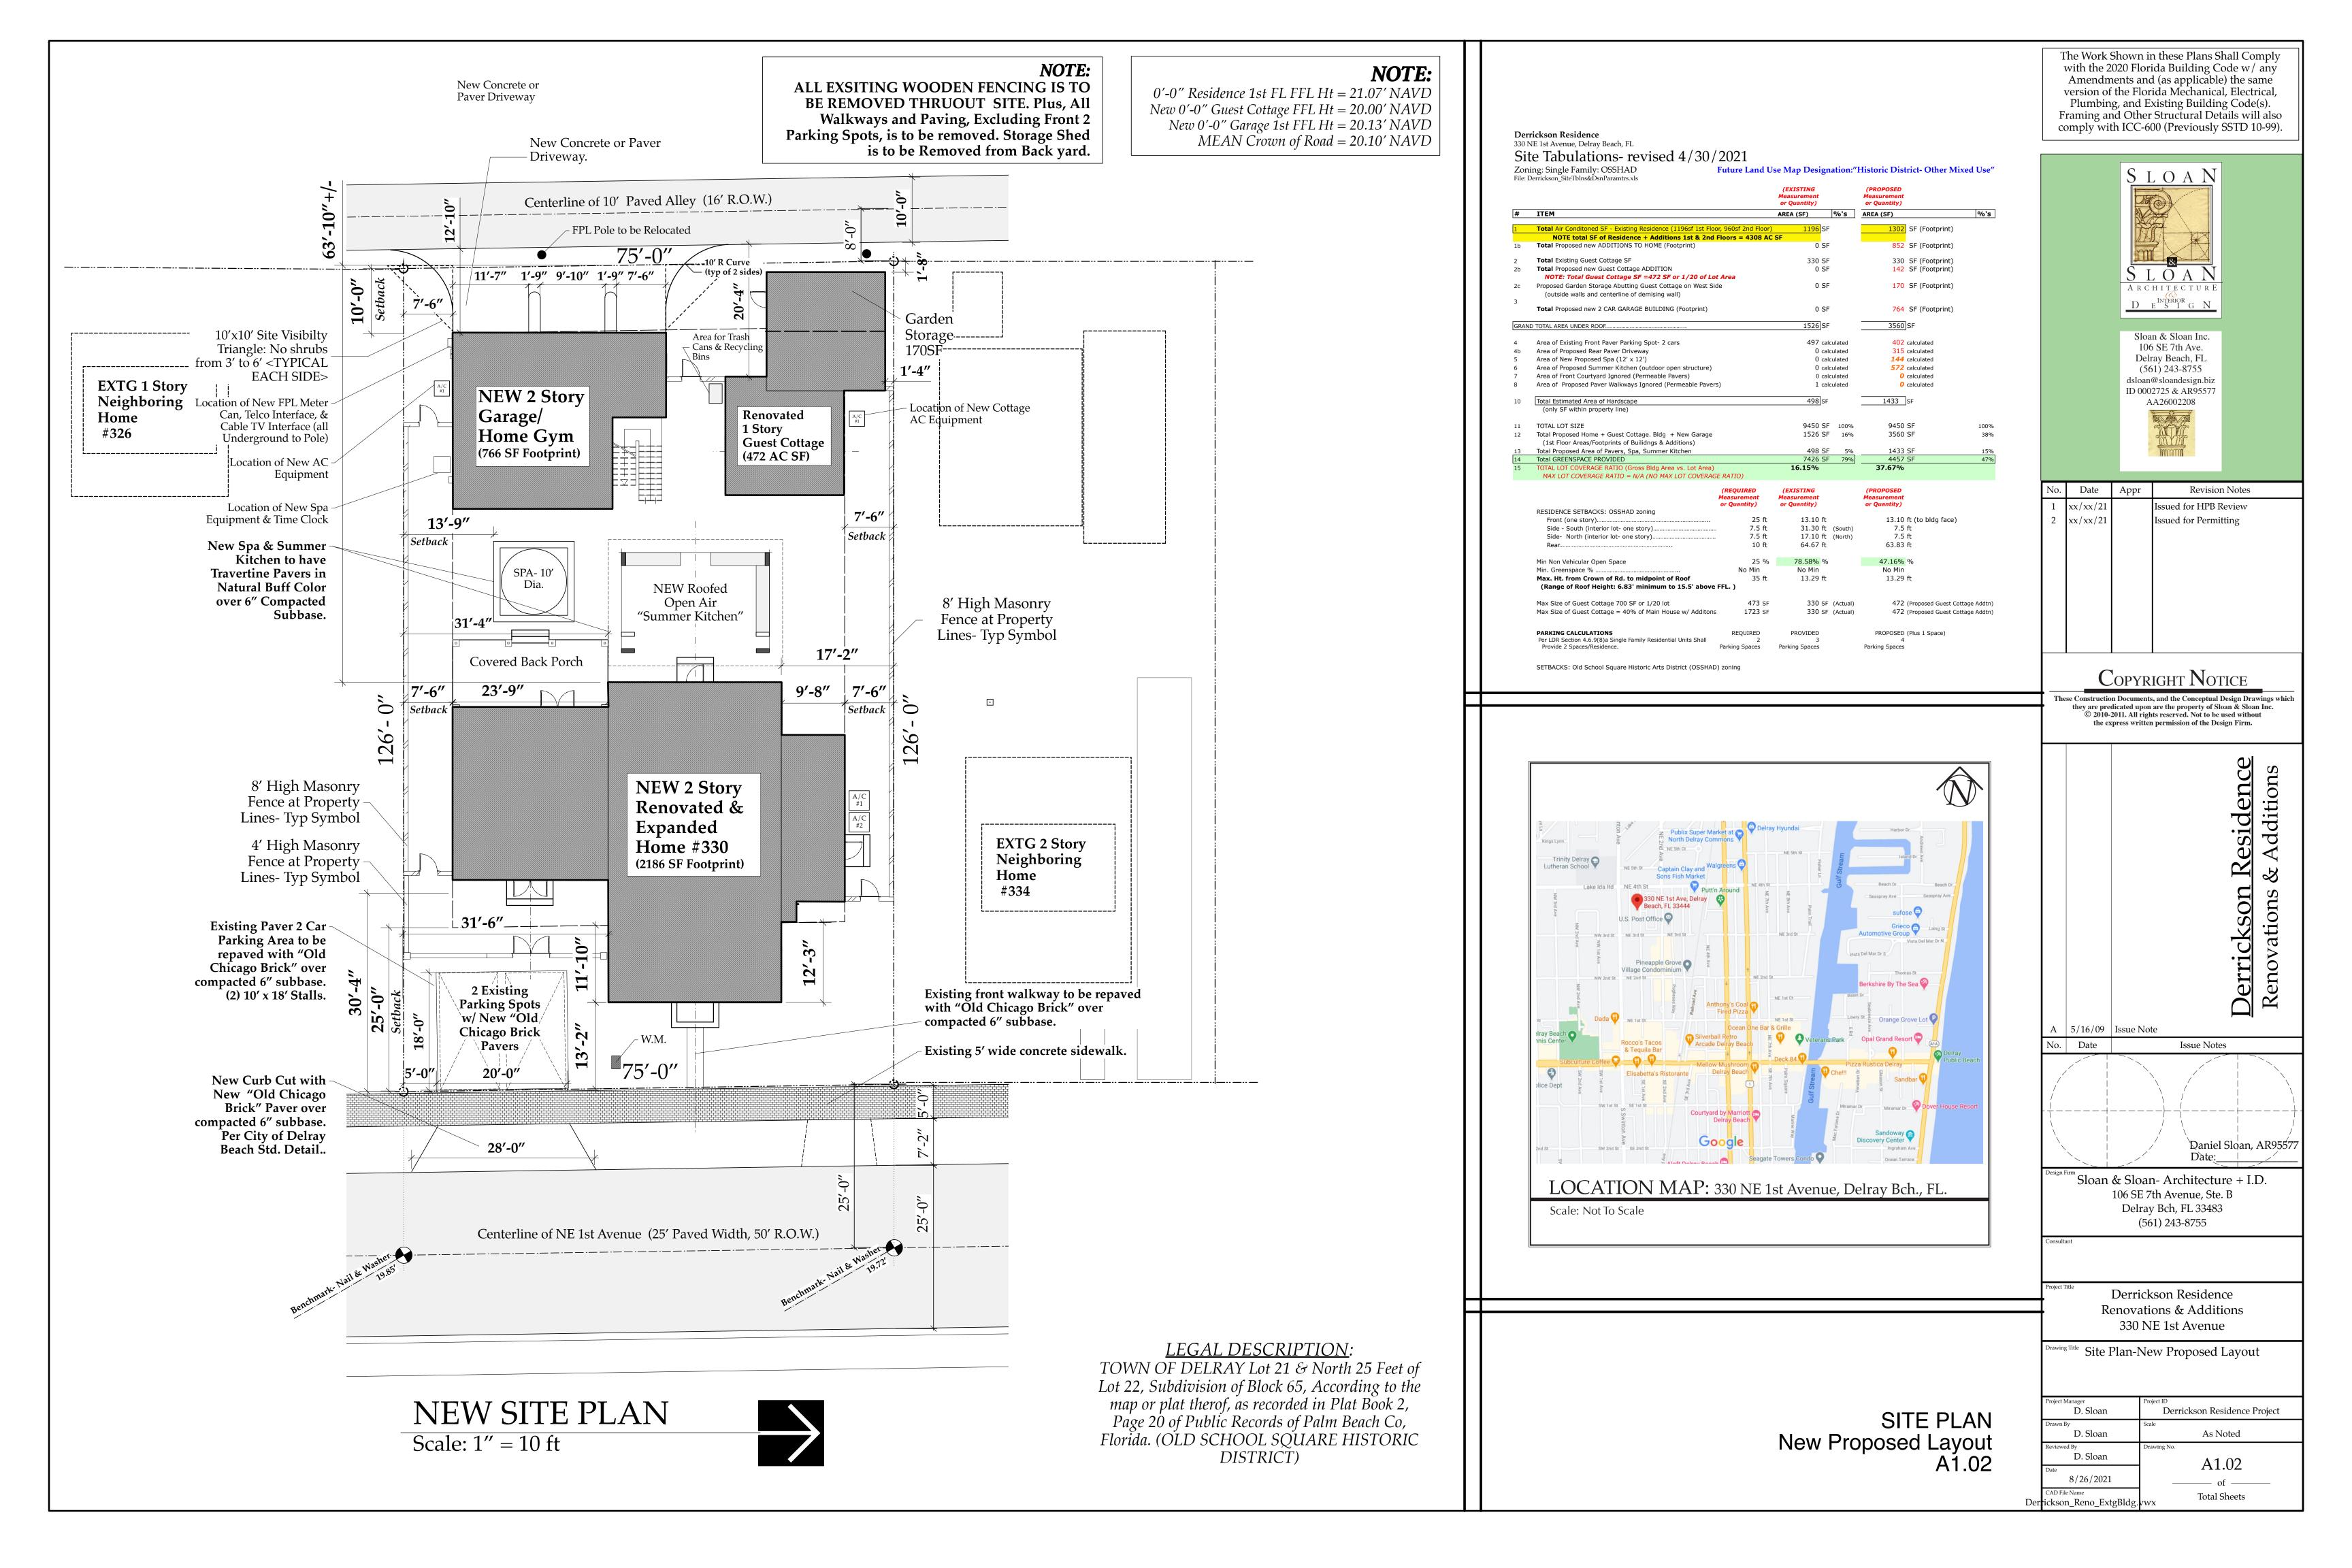
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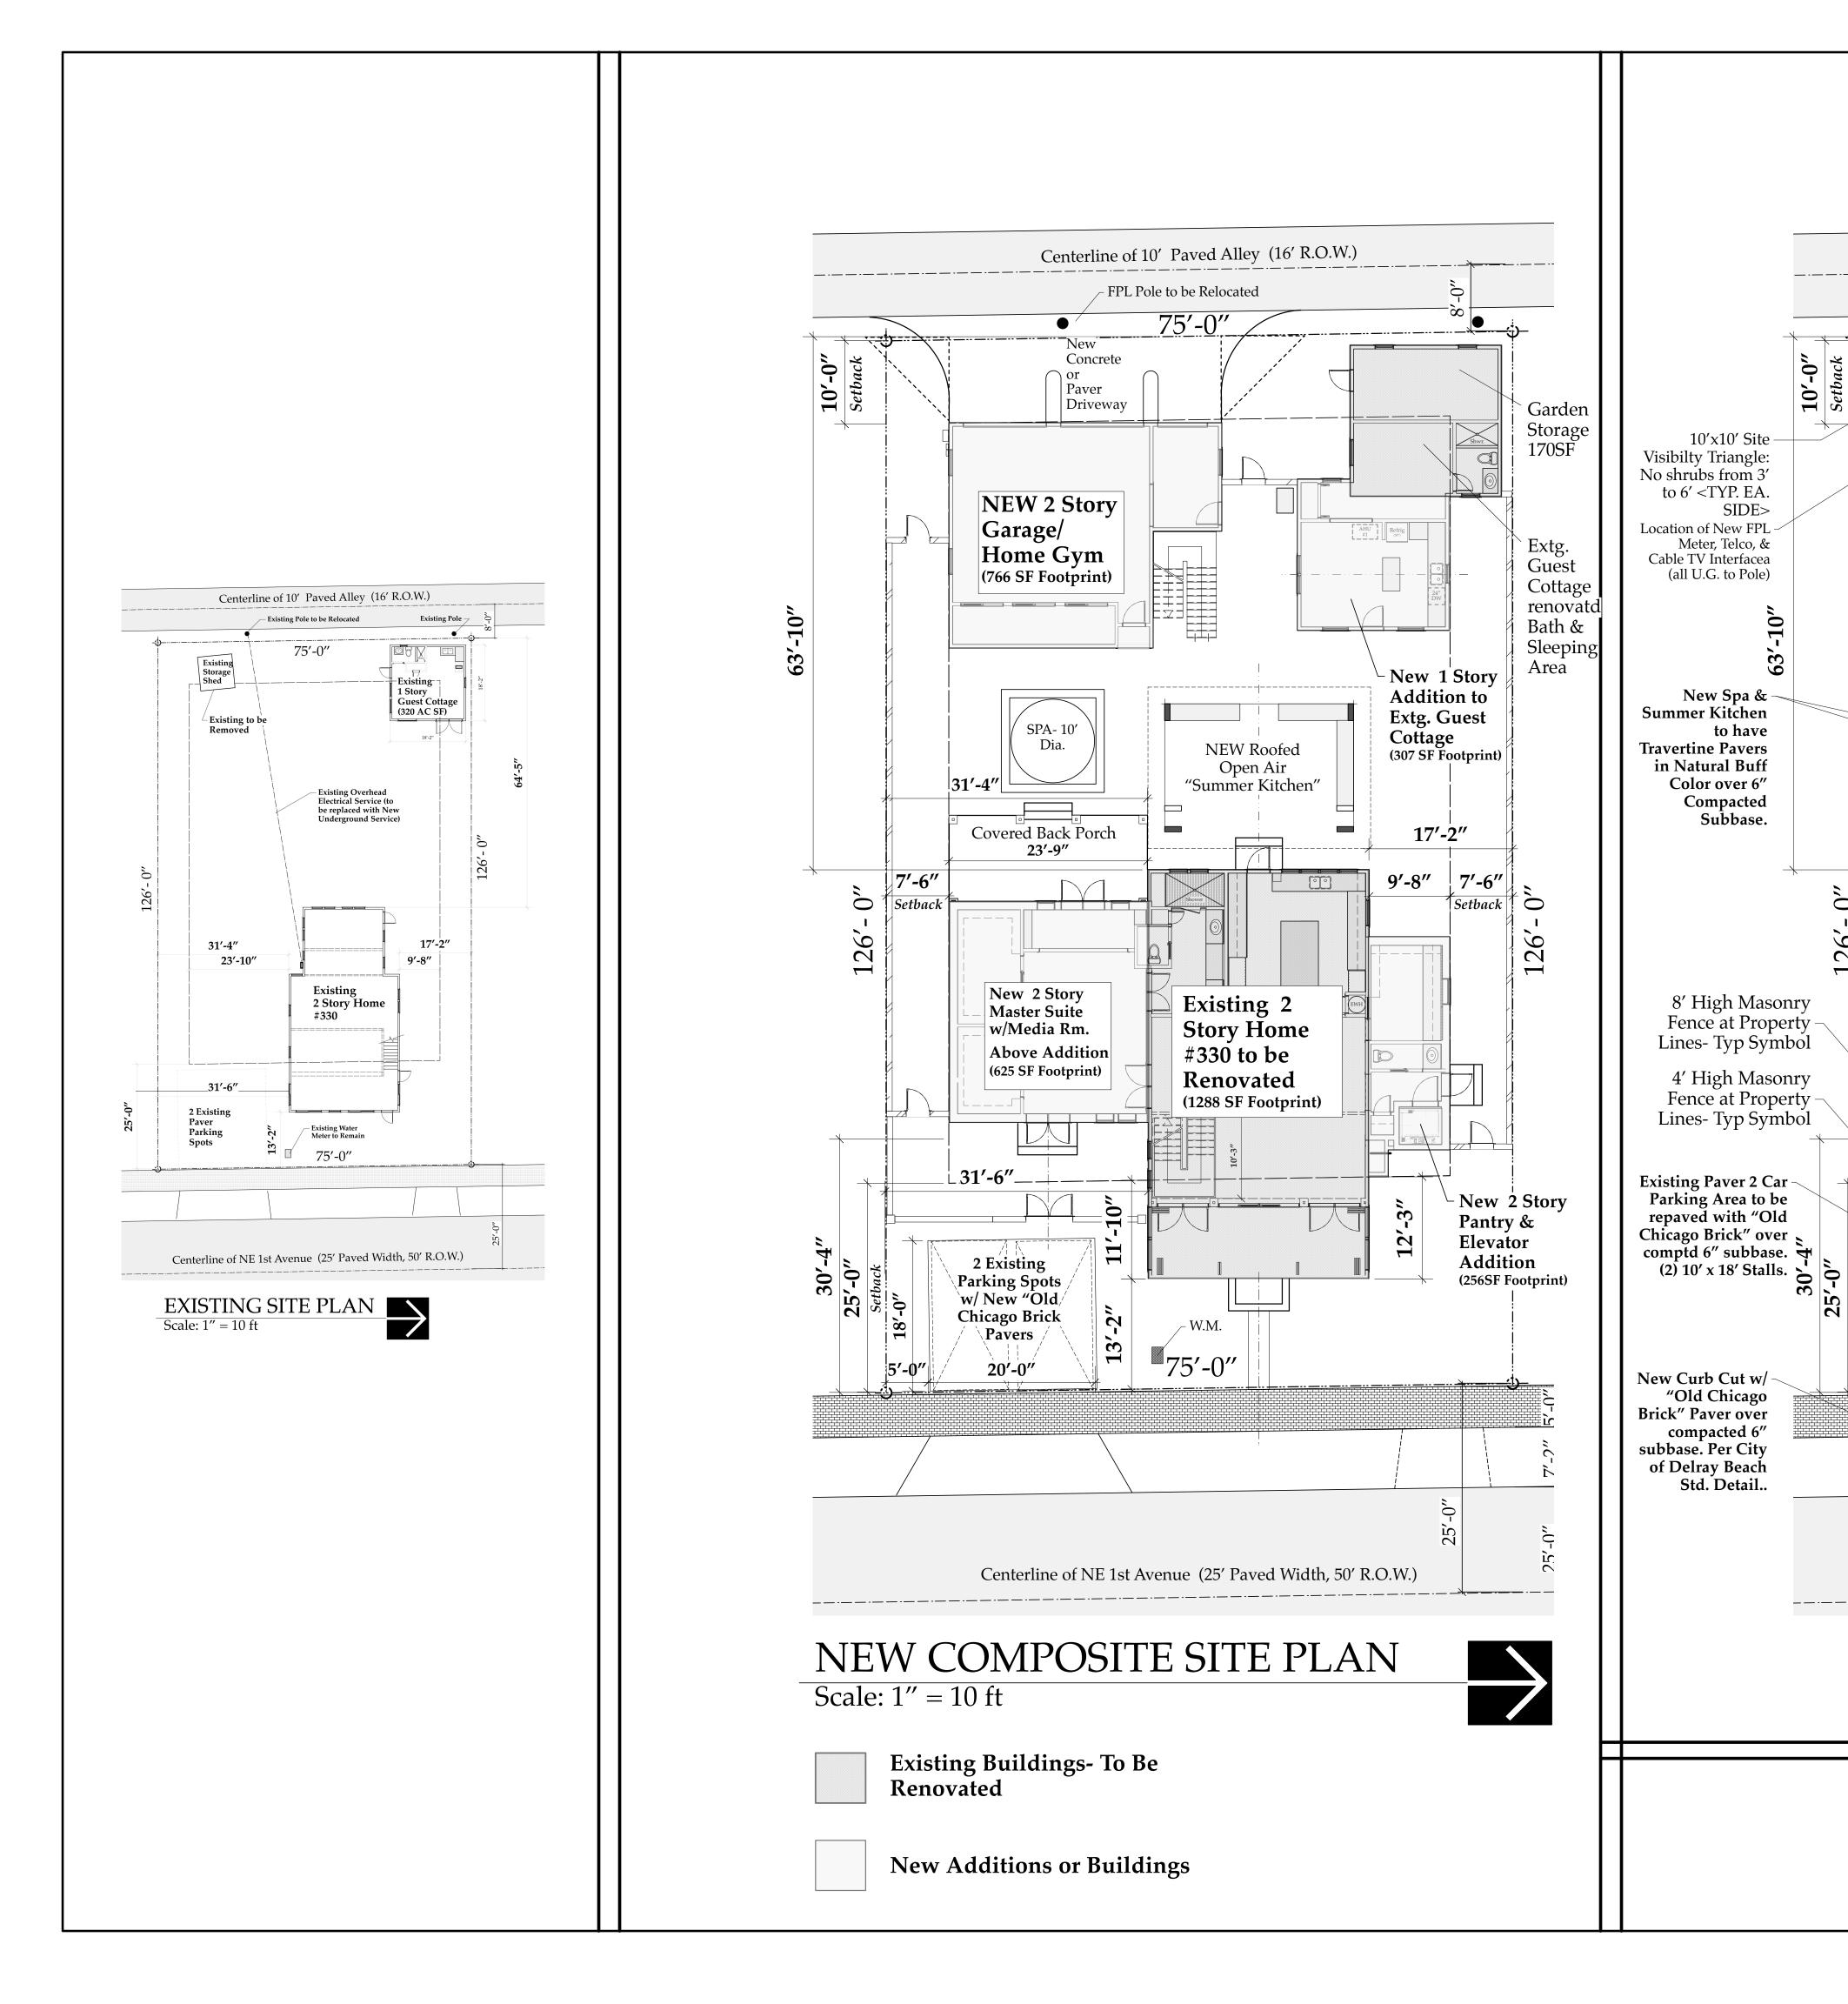
Consultant

Derrickson Residence Renovations & Additions 330 NE 1st Avenue

Site Plan-Extg Conditions

SITE PLAN Exsiting Conditions A1.01





Garden

Storage

0'-0" Residence 1st FL FFL Ht = 21.07' NAVD *New 0'-0" Guest Cottage FFL Ht* = 20.00' *NAVD* New 0'-0" Garage 1st FFL Ht = 20.13' NAVD MEAN Crown of Road = 20.10' NAVD

Centerline of 10' Paved Alley (16' R.O.W.)

FPL Pole to be Relocated

75′-0′

- Cans & Recycling

NEW Roofed

Open Air

"Summer Kitchen"

NEW 2 Story

Renovated &

Expanded

¹75'-0''

Centerline of NE 1st Avenue (25' Paved Width, 50' R.O.W.)

Old Curb Cut- to be

removed

Home #330

(2186 SF Footprint)

Renovated

(472 AC SF)

Guest Cottage

17'-2"

Existing front walkway to

be repayed with "Old Chicago Brick" over

compacted 6" subbase

26'

Concrete

Driveway

Paver

NEW 2 Story

Home Gym

(766 SF Footprint)

SPA- 10'

Covered Back Porch

∟31′**-**6″

2 Existing

Parking Spots w/ New "Old/

Chicago Brick

Pavers

20'-0"

23'-9"

.0.

Garage/

 $\frac{10'}{Setb}$


Ó

26′

to have

with the 2020 Florida Building Code w/ any Amendments and (as applicable) the same version of the Florida Mechanical, Electrical, Plumbing, and Existing Building Code(s). Framing and Other Structural Details will also comply with ICC-600 (Previously SSTD 10-99).

The Work Shown in these Plans Shall Comply

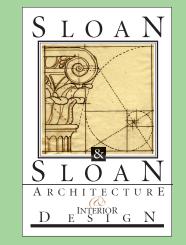

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> > Derrickson Residence Renovations & Additions 330 NE 1st Avenue

Composite Site Plan-Extg & New Proposed Layouts

Derrickson Residence Project D. Sloan D. Sloan As Noted D. Sloan A1.03 8/22/2021 **Total Sheets** Derrickson_Reno_ExtgBld

NEW SITE PLAN Scale: 1'' = 10 ft

LEGAL DESCRIPTION: TOWN OF DELRAY Lot 21 & North 25 Feet of

Lot 22, Subdivision of Block 65, According to the map or plat therof, as recorded in Plat Book 2, Page 20 of Public Records of Palm Beach Co, Florida. (OLD SCHOOL SQUARE HISTORIC DISTRICT)

COMPOSITE SITE PLAN Existing & Proposed Layouts A1.03




Aerial Photo: 326 thru 338 NE 1st Avenue, Delray Beach



326 NE 1st Avenue- East Facade (View from Street)



330 NE 1st Avenue- East Facade (View from Street)

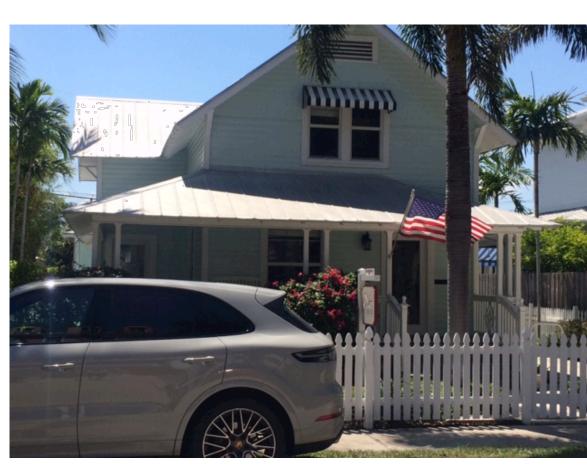


334NE 1st Avenue- East Facade (View from Street)



338 NE 1st Avenue- East Facade (View from Street)

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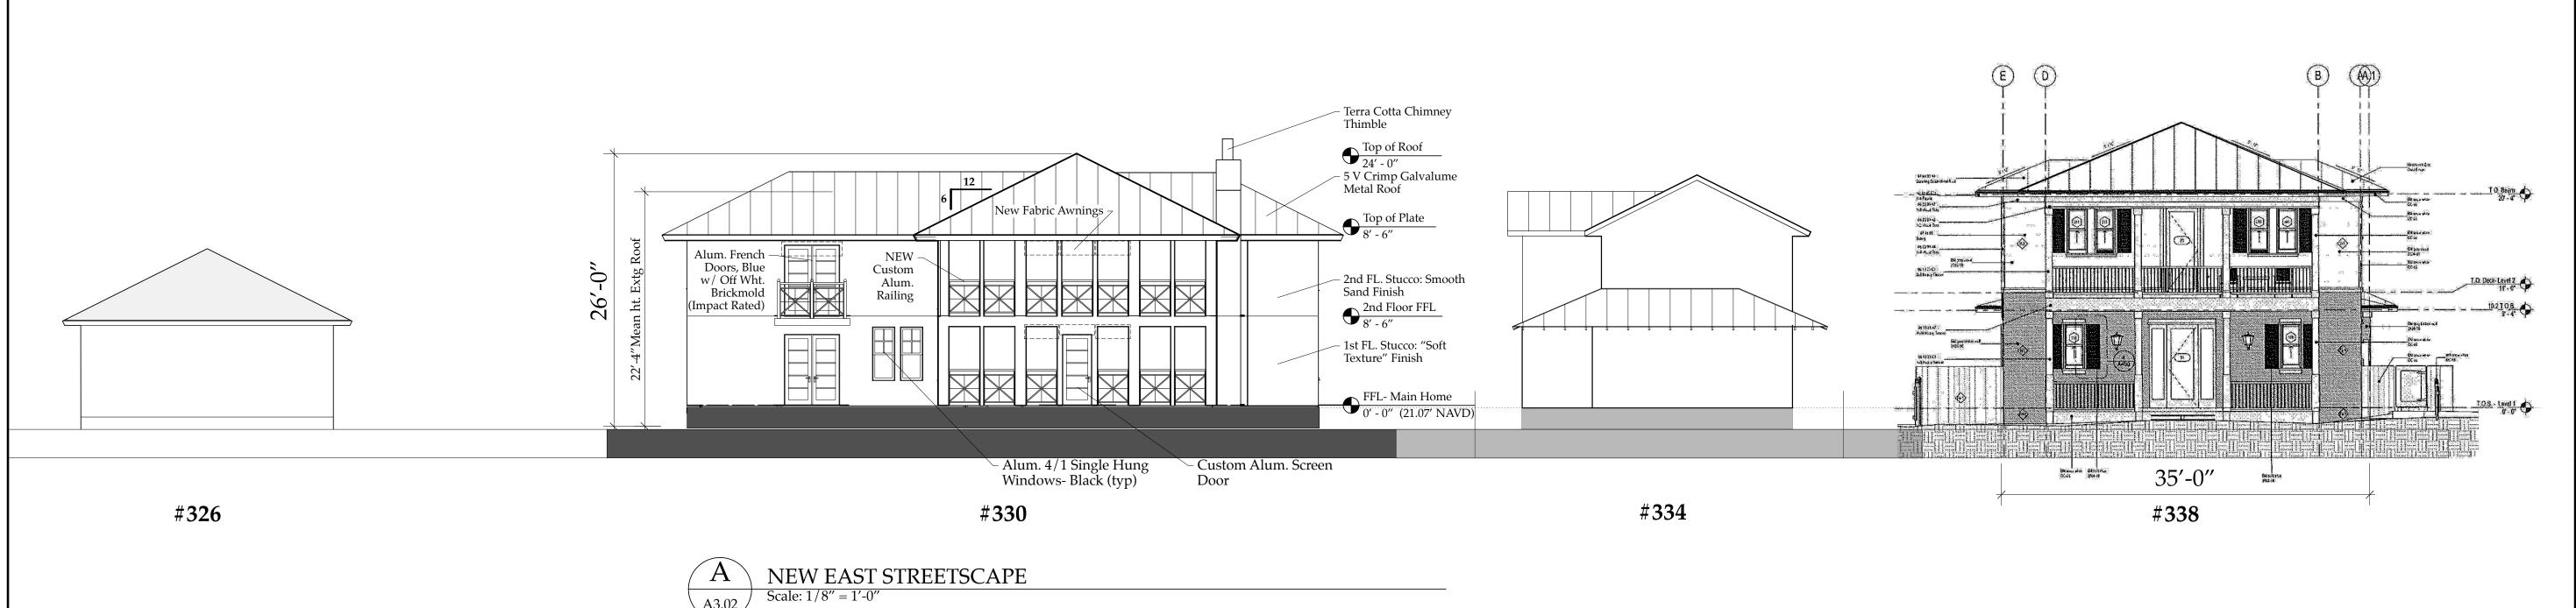
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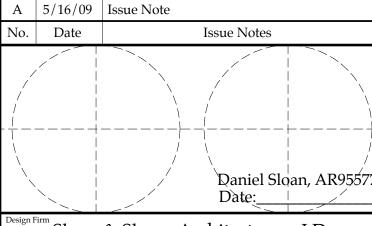
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SITE VIEWS & New Proposed Streetscape A1.04

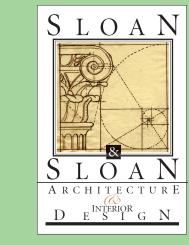




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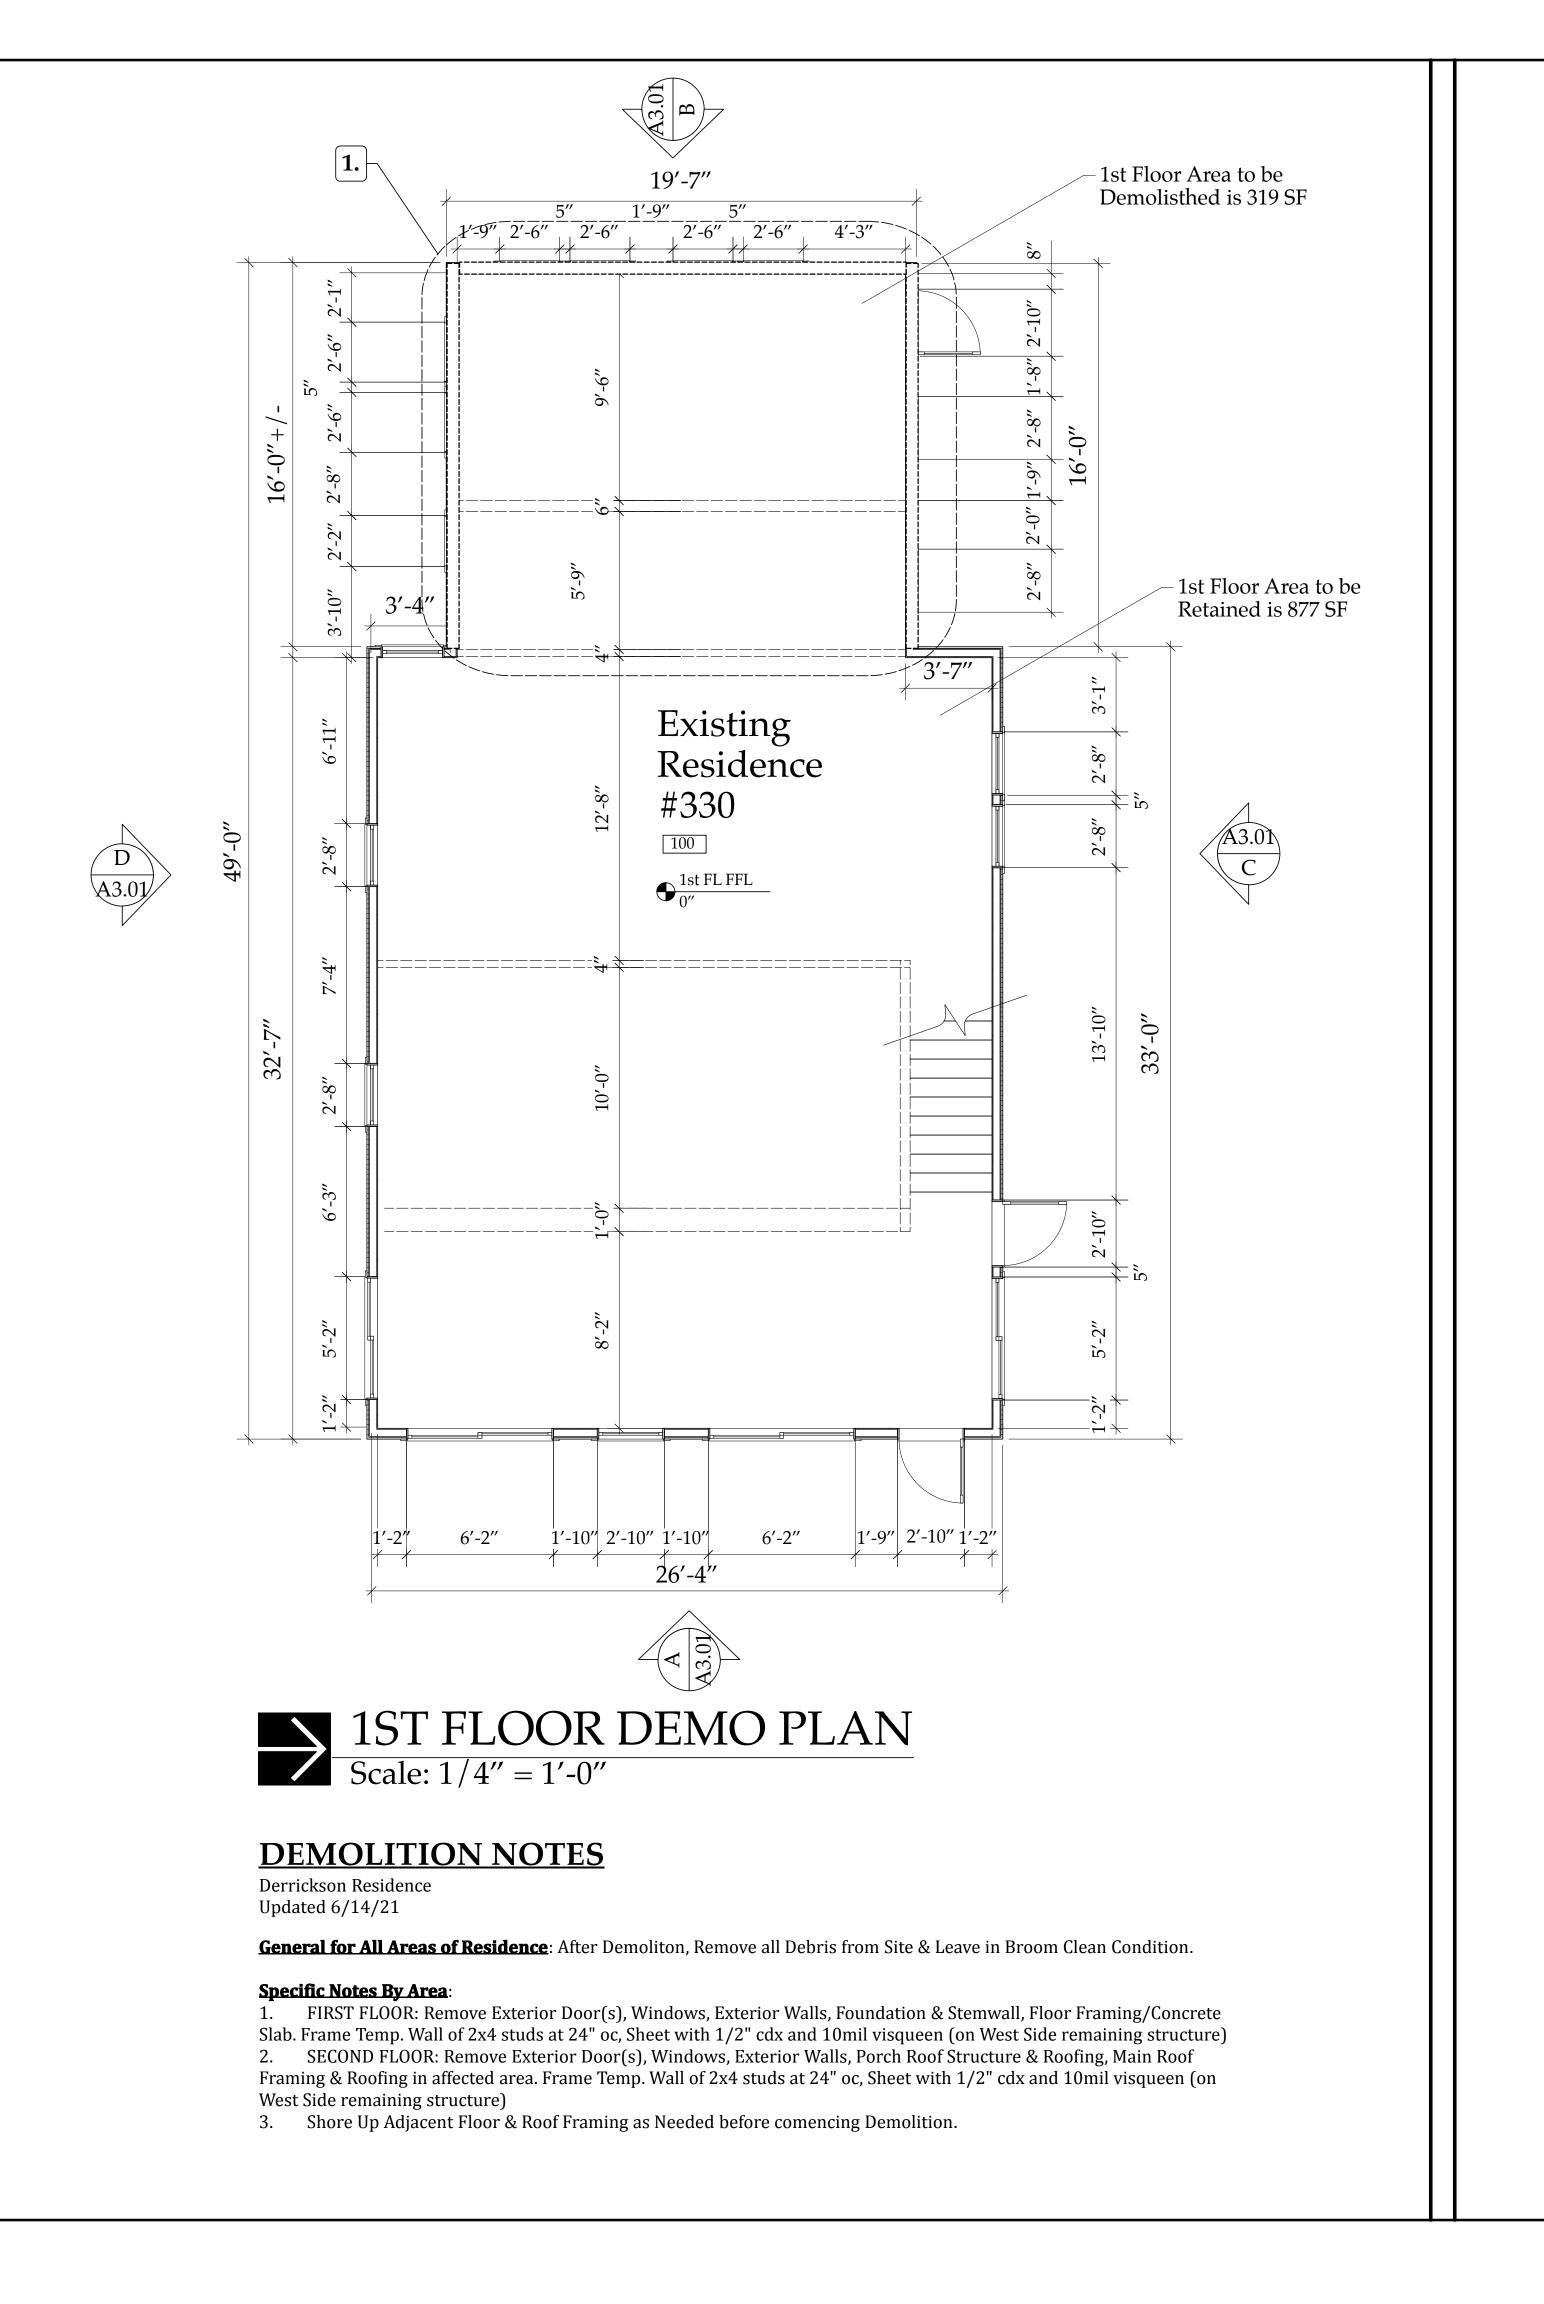
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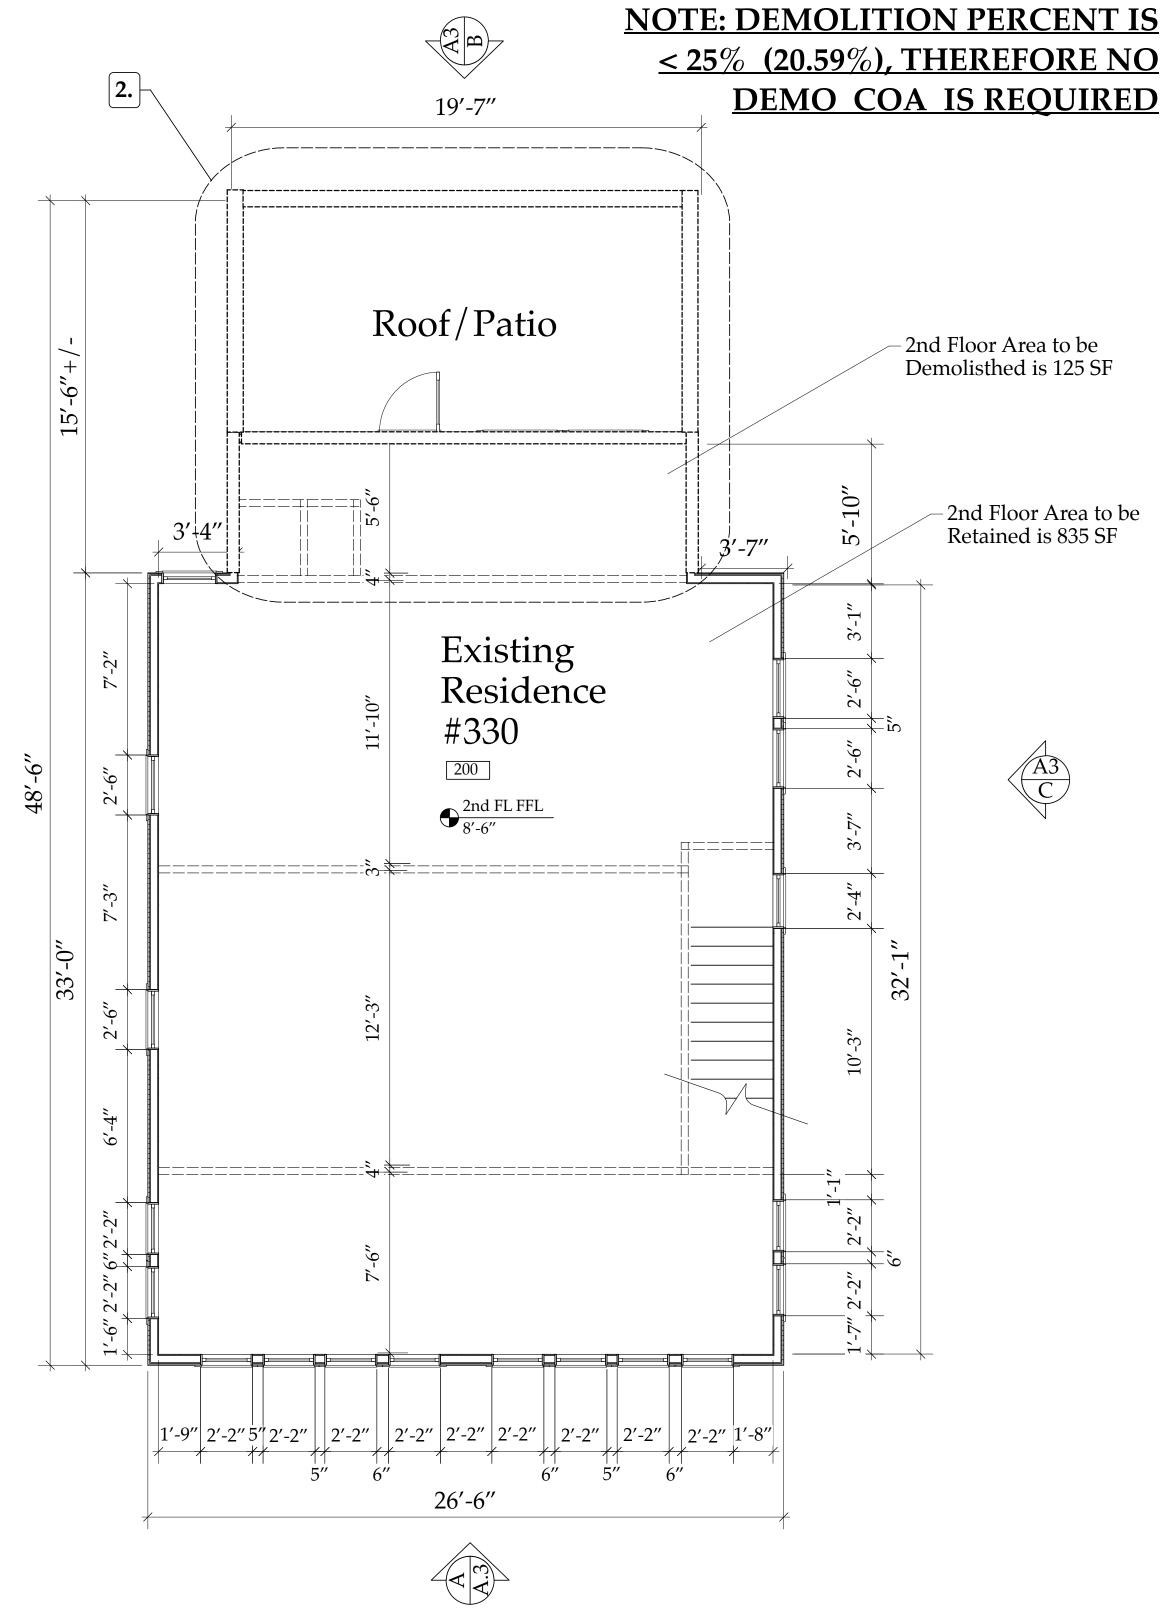
Derrickson Residence Renovations & Additions 330 NE 1st Avenue

Proposed Streetscape
-NE 1st Ave View
328 to 338 NE 1st Ave Homes

	D. Sloan	Derrickson Residence Project
	Drawn By D. Sloan	Scale As Noted
	Reviewed By D. Sloan	Drawing No. $A1.04$
	Date 8/22/2021	———— of ————
Der	CAD File Name rickson_Reno_ExtgBldg.	Total Sheets





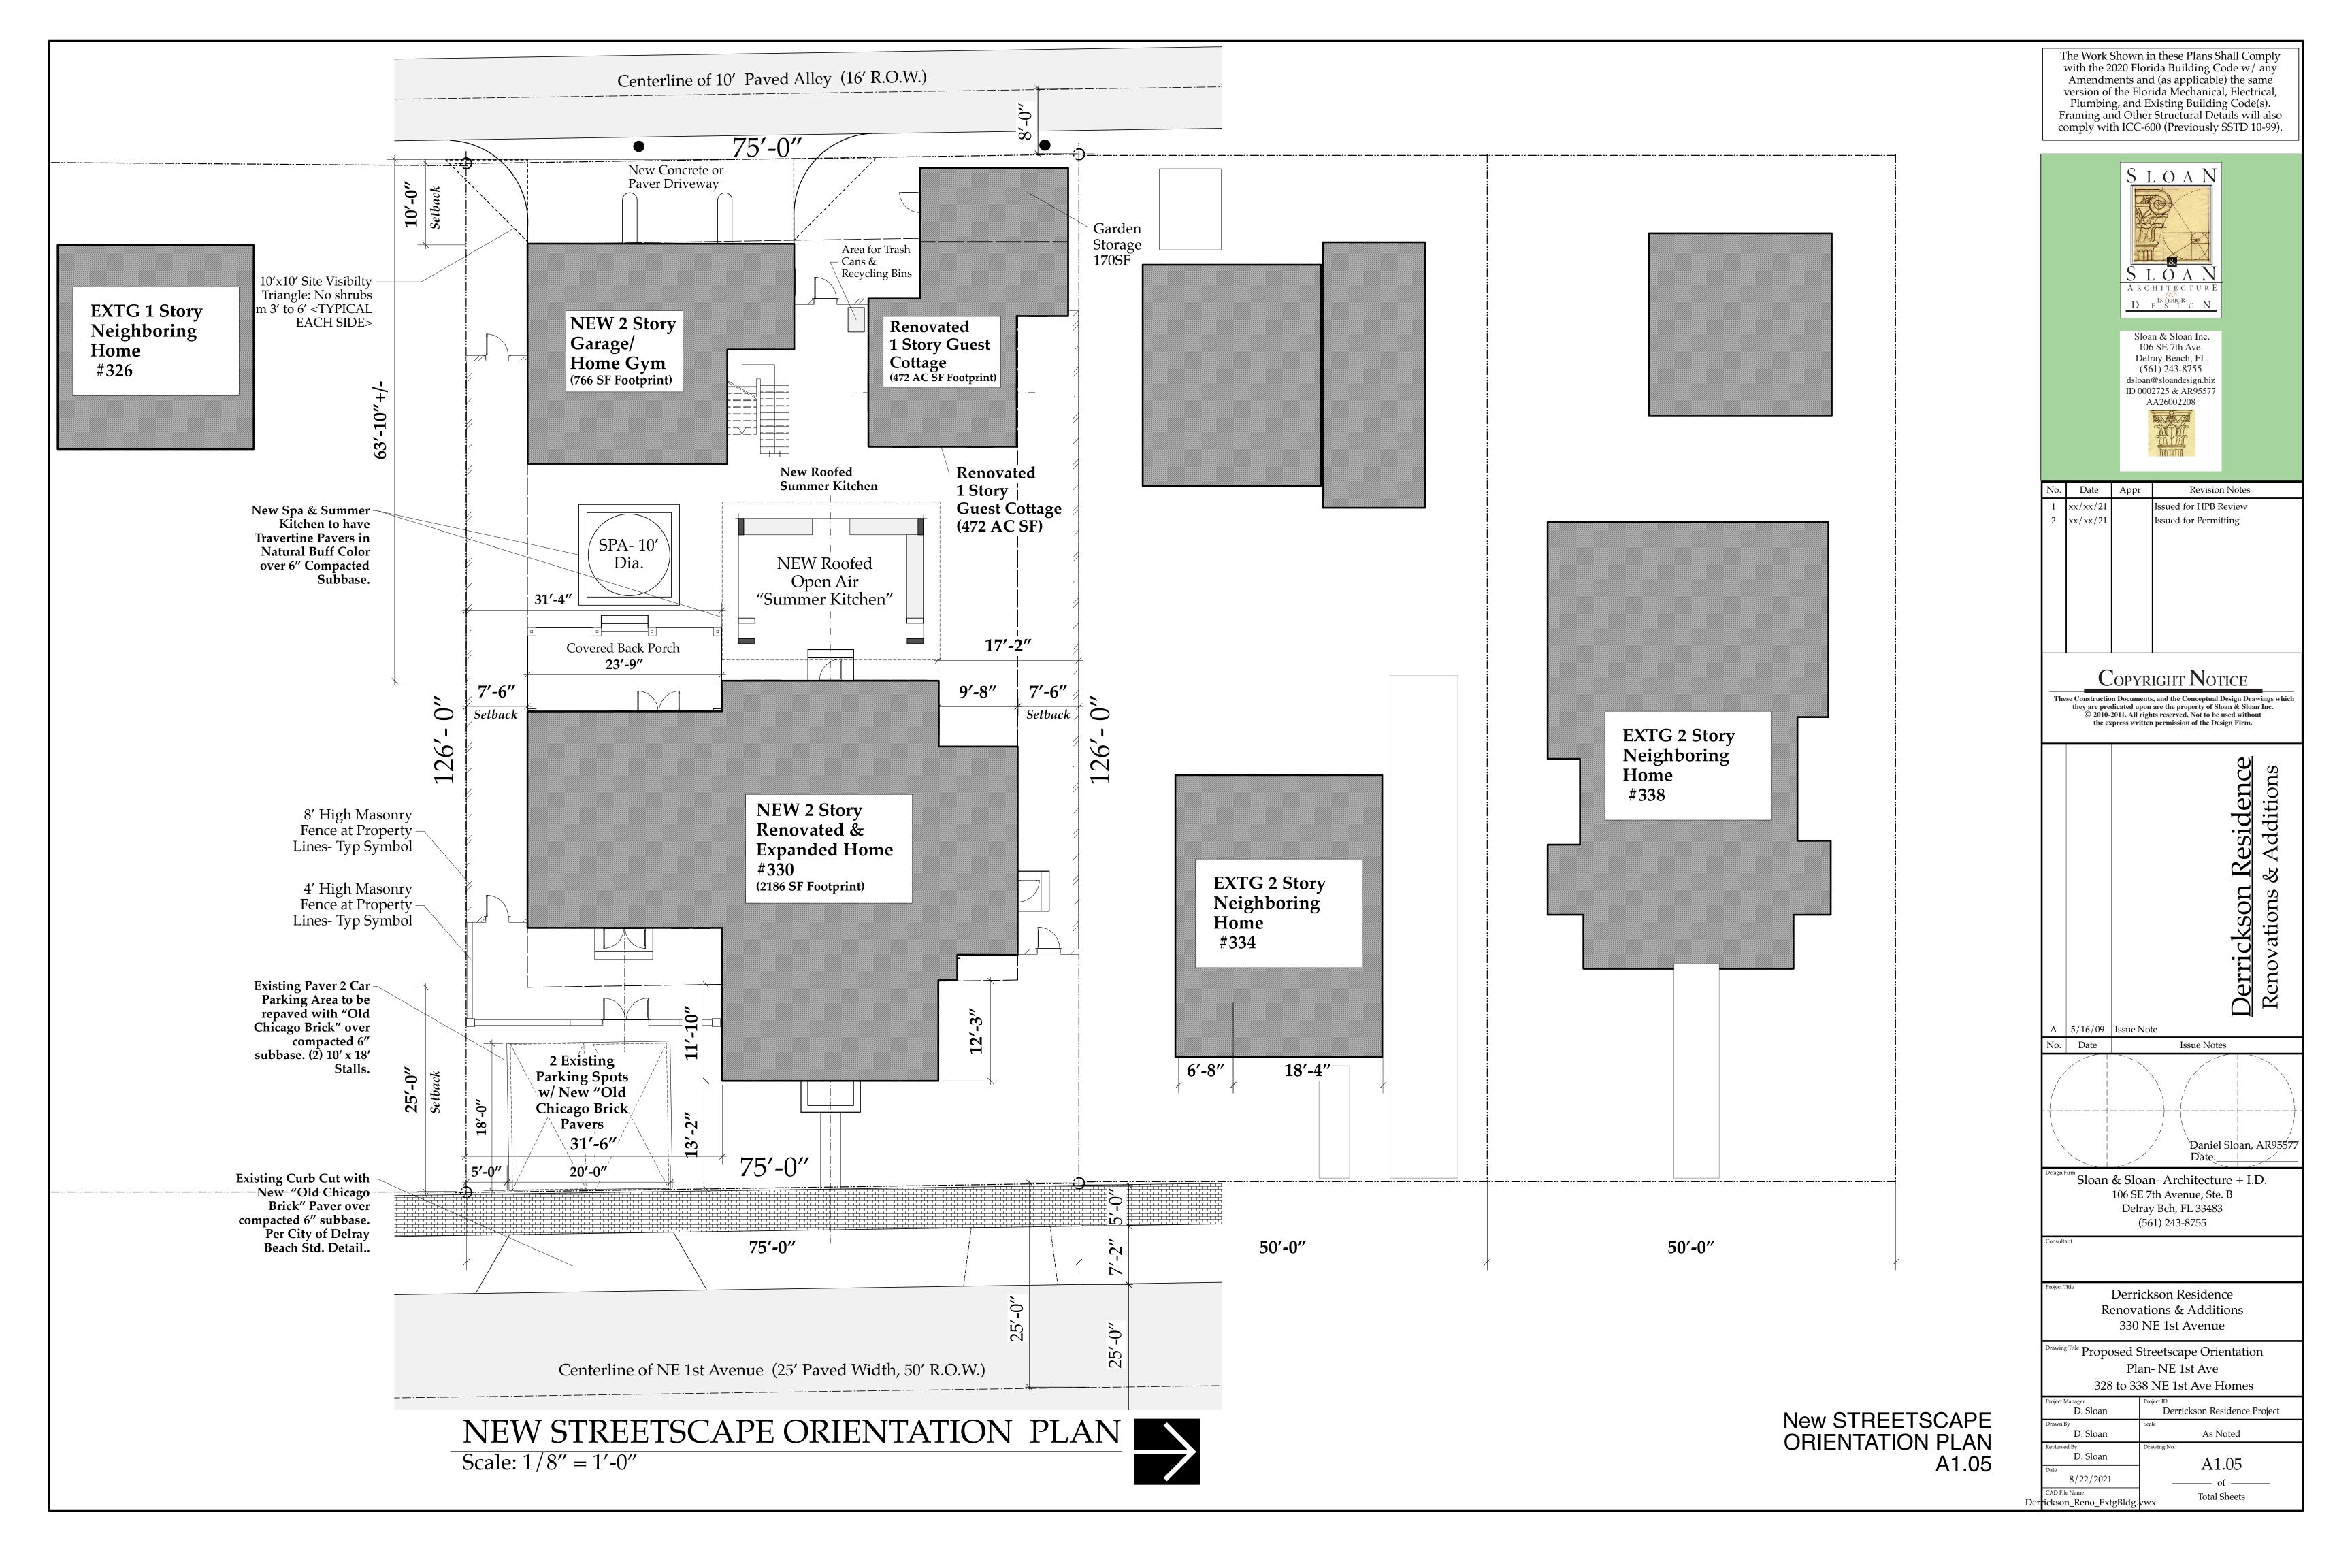

SECOND FLOOR DEMO PLAN

Scale: 1/4" = 1'-0"

Derrickson Residence 330 NE 1st Avenue, Delray Beach, FL Demolition Tabulations- revised 8/14/2021 Zoning: Single Family: OSSHAD File: Derrickson_SiteTblns&DsnParamtrs.xls

(EXISTING Measurement or Quantity) # ITEM AREA (SF)


1 Existing First Floor Area 1196 SF 2 Existing Second Floor Area 960 SF 3 Grand Total Existing Floor Area Under Roof 2156 SF 319 SF 4 Proposed First Floor Area to be DEMOLISHED 5 Proposed 2nd Floor Area to be DEMOLISHED 125 SF 6 Grand Total Floor Area To be DEMOLISHED 444 SF

PECENT OF BUILDING TO BE DEMOLISHED IS..... 20.59%

NOTE: Reframe all Window & Door Openings as needed to Accomodate New Floor **Plan Configuration**

Demolition Plans

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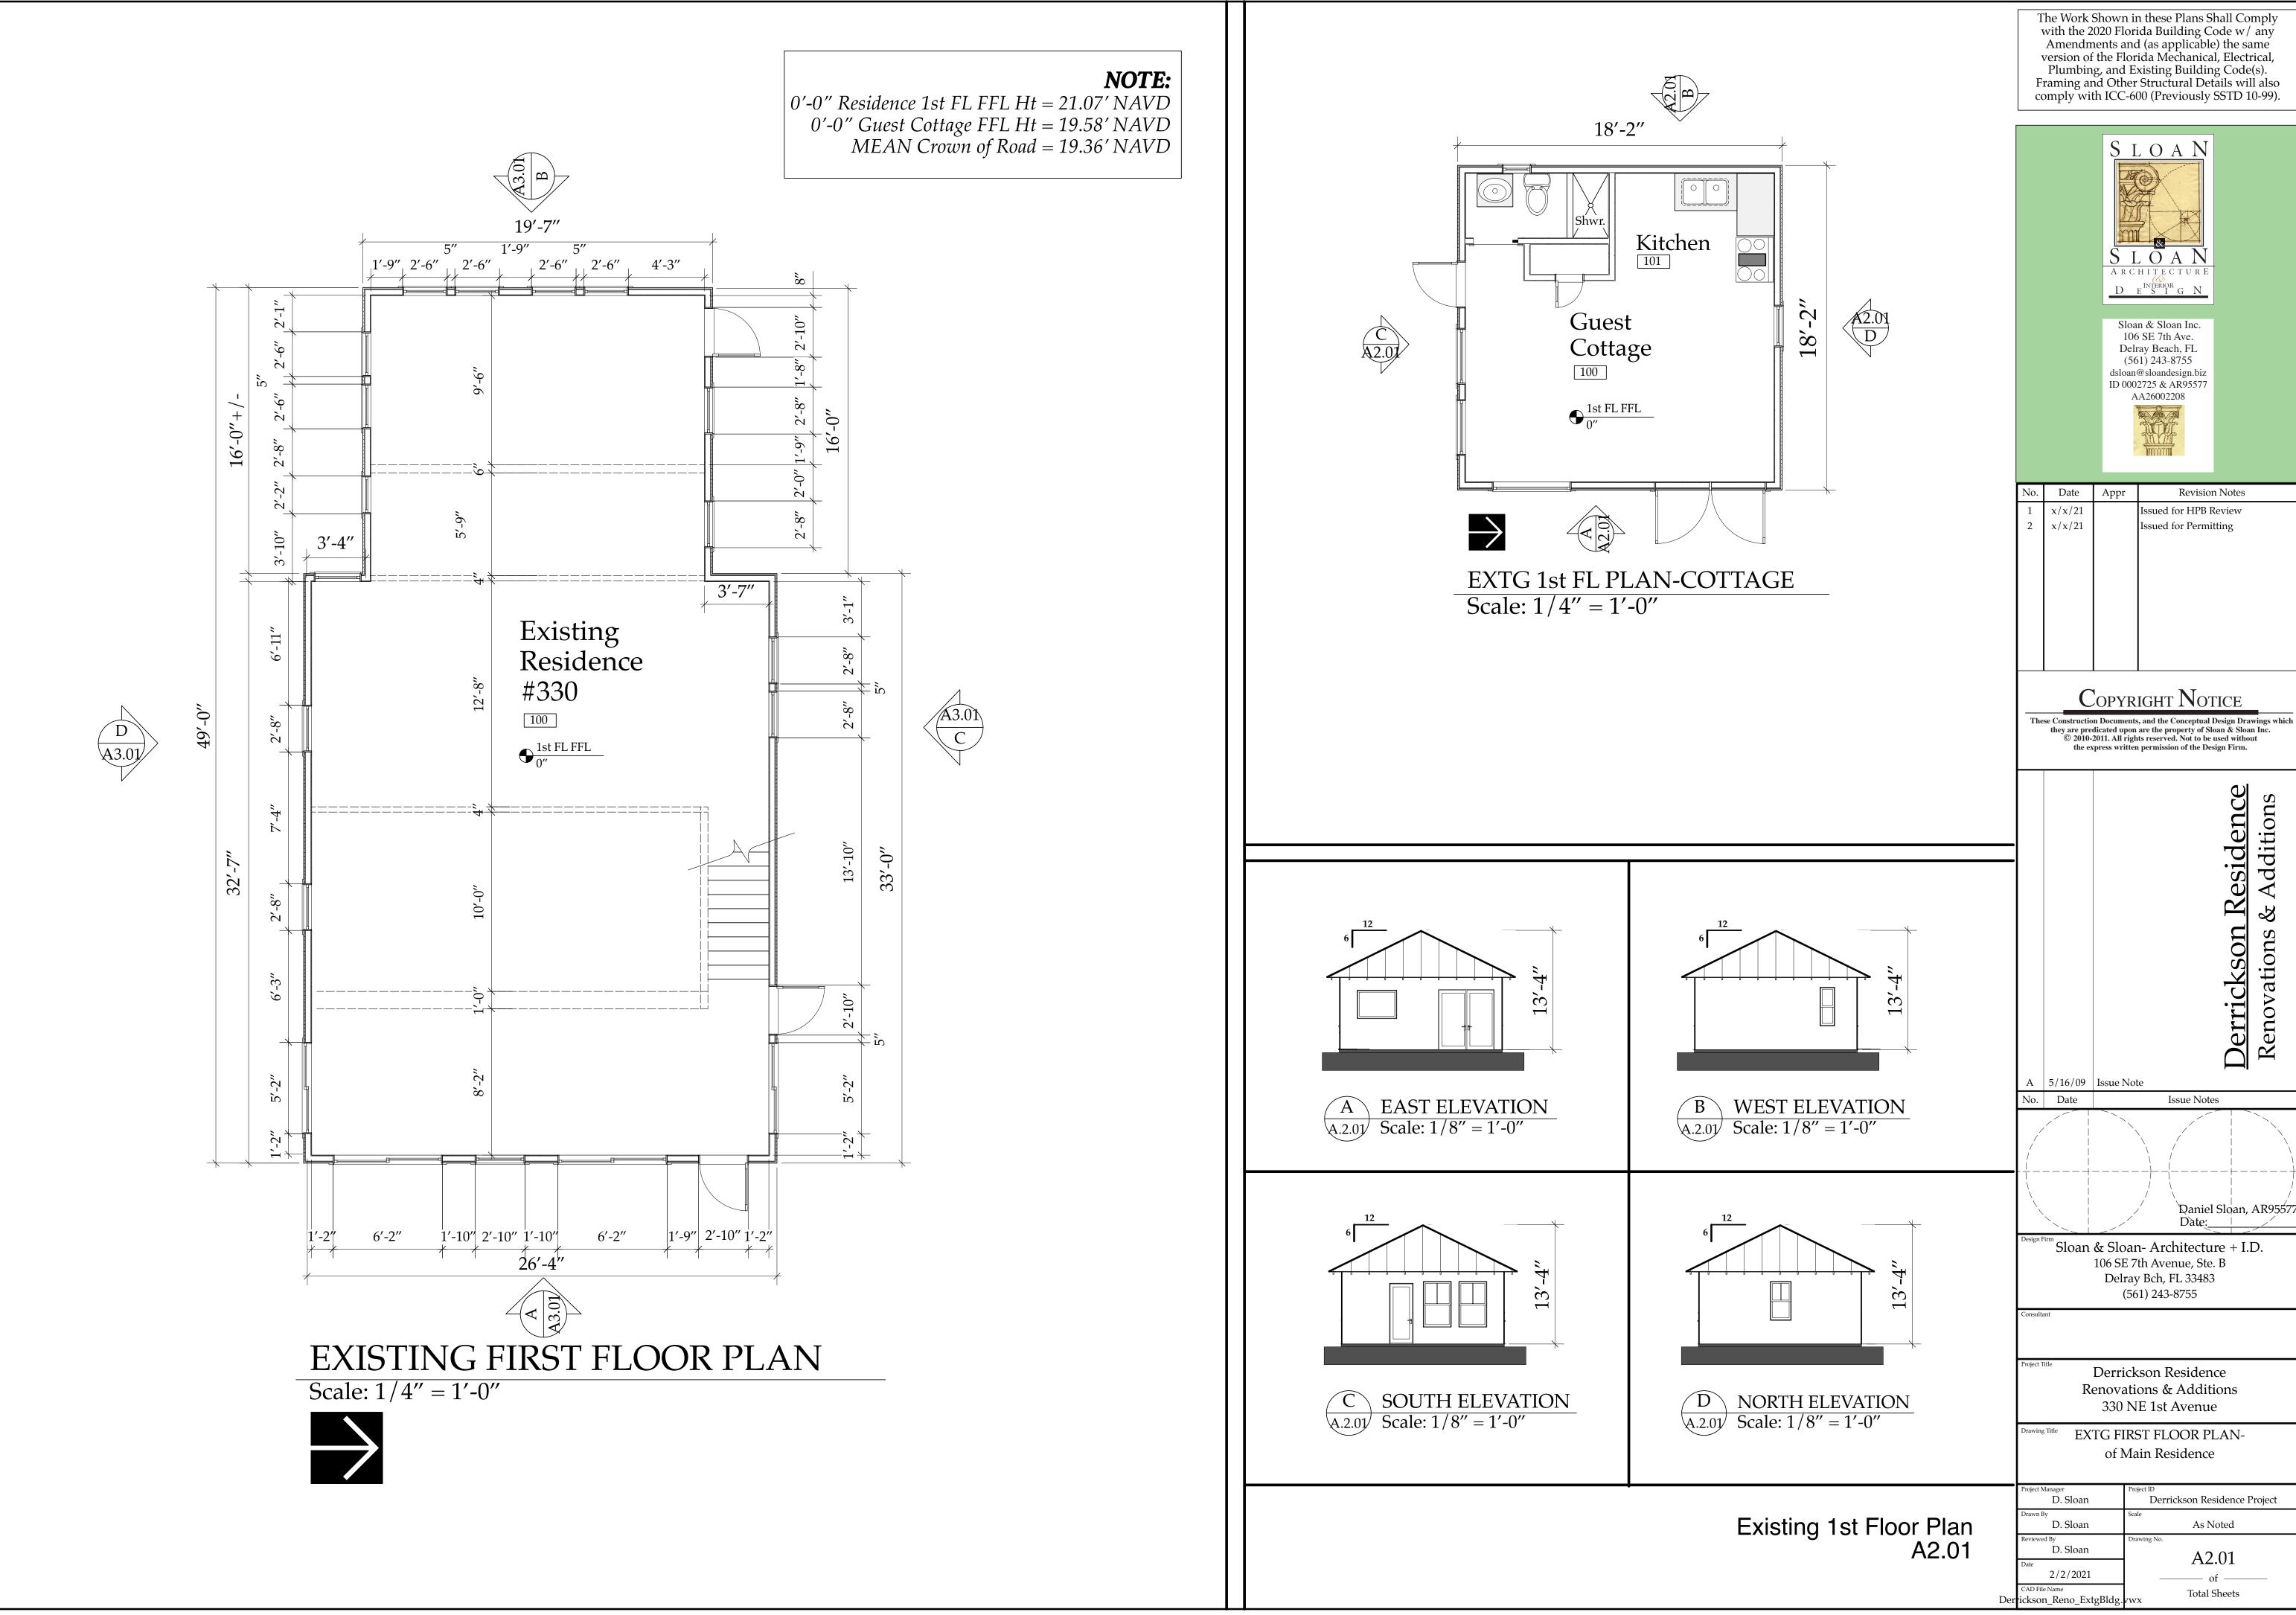
Derrickson Residence Renovations & Additions

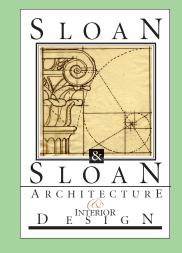330 NE 1st Avenue

DEMOLITION PLANSof Main Residence

D. Sloan Derrickson Residence Project D. Sloan As Noted D. Sloan A2.01.1 8/16/2021 **Total Sheets** Der ickson_Reno_ExtgBlds

A2.01.1




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2	x/x/21 $x/x/21$		Issued for Permitting

Daniel Sloan, AR95577 Date:

Project Manager	Project ID
D. Sloan	Derrickson Residence Project
Drawn By	Scale
D. Sloan	As Noted
Reviewed By	Drawing No.
D. Sloan	A2.01
Date	A2.01
2/2/2021	of
CAD File Name	m + 1.01 +



0'-0'' Residence 1st FL FFL Ht = 21.07' NAVDNew 0'-0" Guest Cottage FFL Ht = 20.00' NAVD New 0'-0" Garage 1st FFL Ht = 20.13' NAVD MEAN Crown of Road = 20.10' NAVD The Work Shown in these Plans Shall Comply with the 2020 Florida Building Code w/ any Amendments and (as applicable) the same version of the Florida Mechanical, Electrical, Plumbing, and Existing Building Code(s). Framing and Other Structural Details will also comply with ICC-600 (Previously SSTD 10-99).

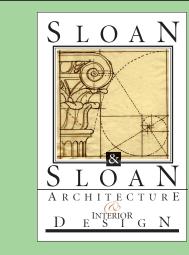


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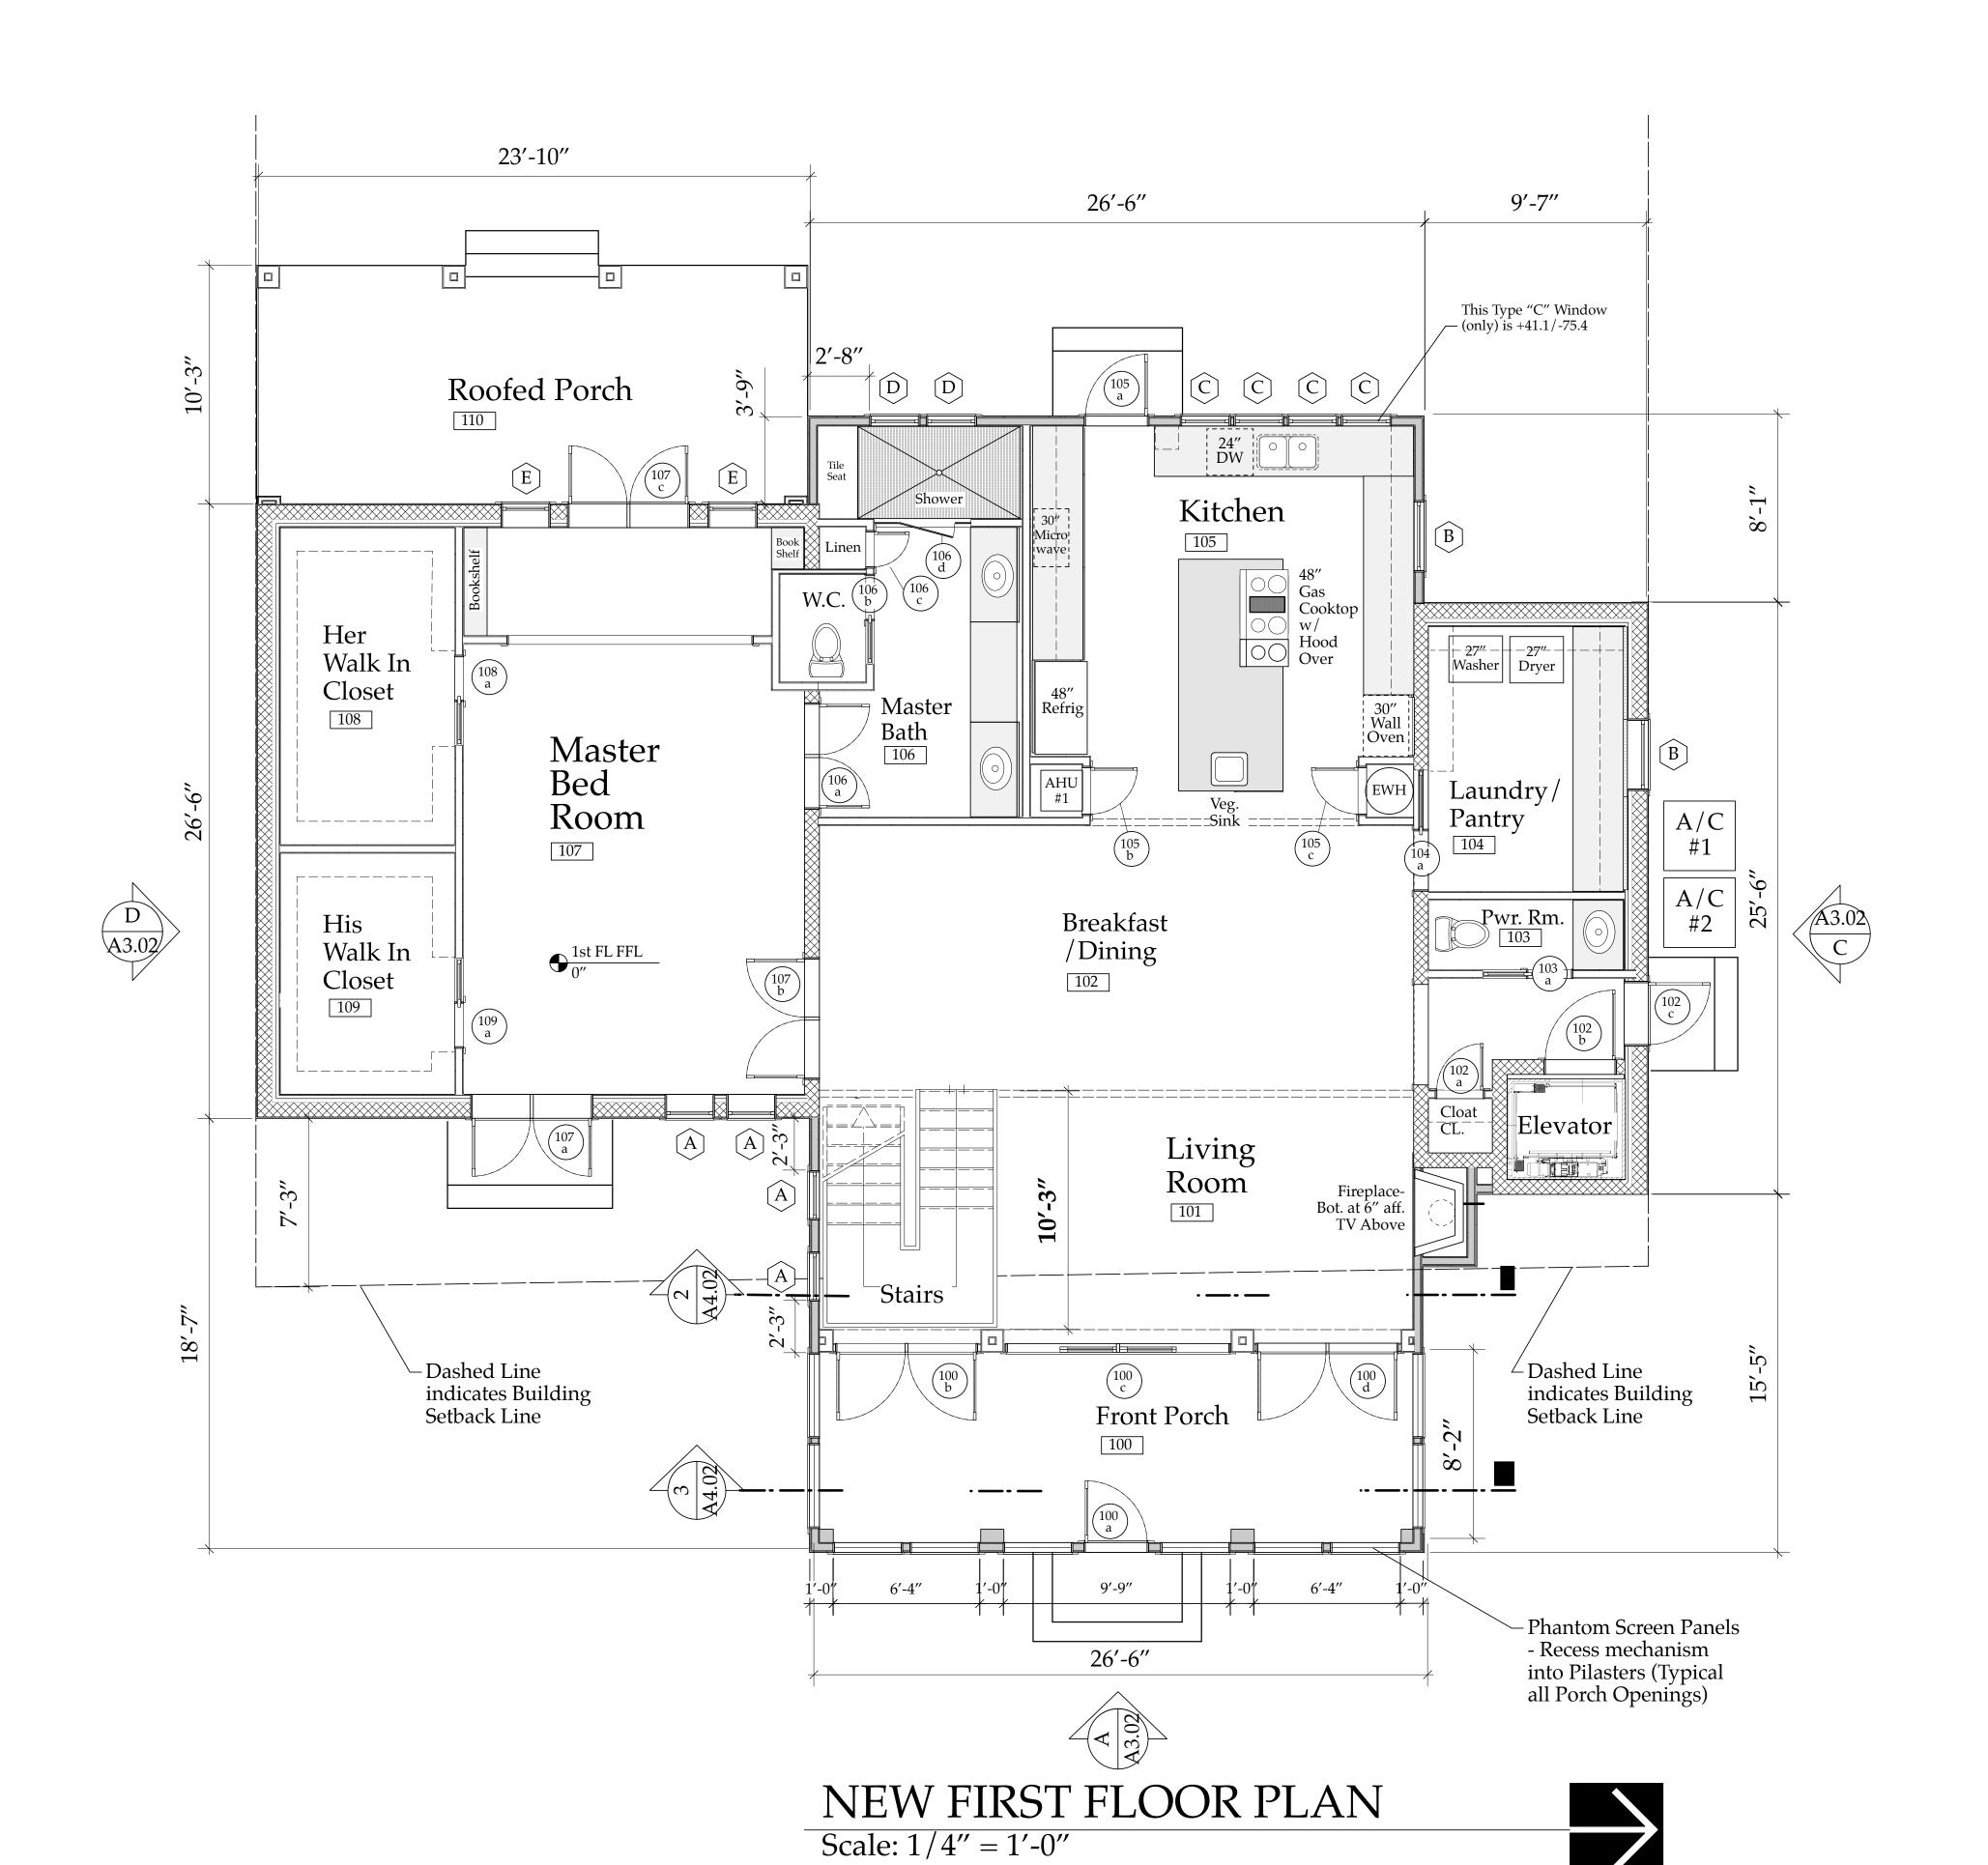
New 1st Floor Plan-MAIN RESIDENCE A2.02

No. Date

Derrickson Residence Renovations & Additions 330 NE 1st Avenue

NEW FIRST FLOOR PLANof Main Residence

Project Manager D. Sloan	Project ID Derrickson Residence Project
Drawn By D. Sloan	Scale As Noted
Reviewed By D. Sloan	Drawing No. A2.02
Date 8/22/2021	——— of ———
CAD File Name Perrickson_Reno_ExtgBldg.	Total Sheets

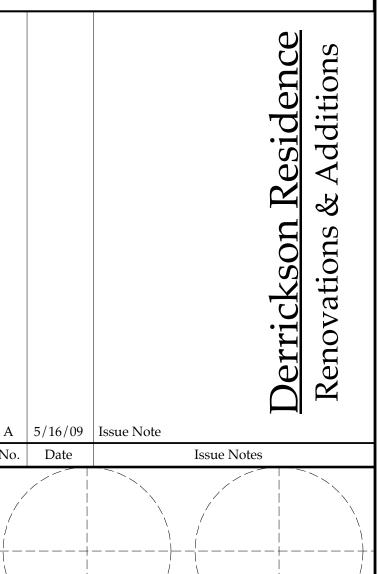

2:11 PM 6/18/21 Derrickson_DOOR Schedule.xls

30 N	E 1st Avenue, Delray Beach, I	FL [Door "DP"	Actual Wind
OOR#	DOOR SIZE/TYPE	DOOR MANF.	CONST.		FRAME MATERIAL	Hardware TYPE	Hardware Style & Finish	HINGES			Pressure on
00a	2868 Prehung Screen Door	Cusom	1 1/8" Composite	Painted-Dk Blue Hales Navy HC154	3/4 Composite Wd. prehung	TBS	TBS	TBS		N/A	N/A
00b	Double 3068 Alum. French Doors w/ 1 Light- IMPACT RATED	PGT Window Co. Mod. FD750	"Energy Max" Low E, Laminated		Alum.: install w/	EMTEK (model TBS)	EMTEK (model TBS) Lever & Dummy on	PGT Factory Installed	Impact Rated- Provide	+70/-80	+37.1/-65.
	W/ Light- IVII ACT NATED	"WinGuard"	Insulated Glass	Finish		Schlage Keyway (Lever & Deadbolt)	Inactive side	installed	INOA.		
00c	9868 Alum. BiFold French Doors w/ 1 Light- IMPACT RATED	Marvin "Coastline" 4 panel Bi-Fold		Powdercoated Black Factory		EMTEK (model TBS) Plate in SS	EMTEK (model TBS) Lever & Dummy on	Marvin Factory Installed	Impact Rated- Provide NOA.	+70/-80	+40.5/-45.
	(Custom to Fit Exact RO)	French Door	Insulated Glass	Finish		Schlage Keyway (Lever & Deadbolt)	Inactive side				
00d	Doubl 3068 Alum. French Doors w/ 1 Light- IMPACT RATED	Mod. FD750	"Energy Max" Low E, Laminated	Powdercoated Black Factory	SS Tapcons	EMTEK (model TBS) Plate in SS	EMTEK (model TBS) Lever & Dummy on	PGT Factory Installed	Impact Rated- Provide NOA.	+70/-80	+37.1/-65.
		"WinGuard"	Insulated Glass	Finish	per NOA	Schlage Keyway (Lever & Deadbolt)	Inactive side				
02a	2068 Prehung Door	Plantation Style 2" Lvrd	1 3/8" SOLID CORE	Painted- Color TBS	3/4 wood prehung	Passage Set	TBS	Bright Chr. US26	Casing TBS	N/A	N/A
02b	3068 Prehung Door	TBS	1 3/8" SOLID CORE	Painted- Color TBS	3/4 wood prehung	Passage Set	TBS	Bright Chr. US26 (5) 4" Hinges	Inside Face to be Built out per Elevtr Code	N/A	N/A
02c	2868 Prehung Door Plaspro DRS2b IMPACT RATED	PlasPro 2 Panel Composite	1 3/4" SOLID CORE	Painted-Dk Blue Hales Navy HC154		EMTEK (model TBS) (Lever & Deadbolt)	TBS	Bright SS	Casing TBS/2" Composite	+75/-75	+40.5/-45.
03a	2068 Pocket Door	TBS	1 3/8" SOLID	Painted-	3/4 wood	TBS:: Flush Edge Pull	TBS		Casing TBS	N/A	N/A
 04a	in Cased Opening 2868 Pocket Door	TBS	CORE 1 3/8" SOLID	Color TBS Painted-	prehung 3/4 wood	PRIVACY SET TBS:: Flush Edge Pull	TBS		Casing TBS	N/A	N/A
	in Cased Opening		CORE	Color TBS	Frame	Passage SET					
05a	2868 Alum. French Door w/ 5 Light- IMPACT RATED	PGT Window Co. Mod. FD750 "WinGuard"	"Energy Max" Low E, Laminated Insulated Glass		SS Tapcons	EMTEK (model TBS) Plate in SS Schlage Keyway	EMTEK (model TBS) Lever & Dummy on Inactive side	PGT Factory Installed	Impact Rated- Provide NOA.	+70/-80	+37.1/-65.
				on Outer Face		(Lever & Deadbolt)					
05b	2068 Prehung Door	TBS- Solid Core W/ Weatherstrip'g	1 3/8" SOLID CORE	Painted- Color TBS	3/4 wood prehung	Passage Set	TBS	Bright Chr. US26	Casing TBS w/ Gasketed Threshold	N/A	N/A
05c	2068 Prehung Door	Plantation Style 2" Lvrd	1 3/8" SOLID CORE	Painted- Color TBS	3/4 wood prehung	Passage Set	TBS	Bright Chr. US26	Casing TBS	N/A	N/A
06a	Double 2268 Doors w/ T Astragal	TBS	1 3/8" SOLID CORE	Painted- Color TBS	3/4 wood prehung	TBS:: Privicay Lock w/	TBS	Bright Chr. US26	Casing TBS	N/A	N/A
06b	2068 Pocket Door	TBS	1 3/8" SOLID	Painted-	3/4 wood	TBS:: Flush Edge Pull	TBS		Casing TBS	N/A	N/A
06c	in Cased Opening 1668 Prehung Door	Plantation Style	CORE 1 3/8" SOLID	Color TBS Painted-	Frame 3/4 wood	PRIVACY SET Passage Set	TBS	Bright Chr. US26	Casing TRS	N/A	N/A
	(linen closet)	2" Lvrd	CORE	Color TBS	prehung	_	103				
06d	26" Frameless Shower Door w/Side Lights	Custom	Clear 1/2" Glass w/ sandblasted mo	desty Panel		D Handle Bright Chrome		Bright Chrome hinges and clips	By Shower Door Co.	N/A	N/A
07a	Dbl 2668 Alum. French Door w/ 5 Light- IMPACT RATED	PGT Window Co. Mod. FD750	"Energy Max" Low E, Laminated	Painted-Dk Blue	SS Tapcons	EMTEK (model TBS) Plate in SS	EMTEK (model TBS) Lever & Dummy on	PGT Factory Installed	Impact Rated- Provide NOA.	+70/-80	+40.5/-45
		"WinGuard"	Insulated Glass	Hales Navy HC154 on Outer Face	per NOA	Schlage Keyway (Lever & Deadbolt)	Inactive side				
07b	Double 2668 Doors w/ T Astragal	TBS	1 3/8" SOLID CORE	Painted- Color TBS	3/4 wood prehung	TBS:: Privicay Lock w/ matching dummy	TBS	Bright Chr. US26	Casing TBS	N/A	N/A
07c	Dbl 2668 Alum. French Door	PGT Window Co. Mod. FD750	"Energy Max" Low E, Laminated	Factory Black, Painted-Dk Blue	Alum.: install w/	EMTEK (model TBS) Plate in SS	EMTEK (model TBS) Lever & Dummy on	PGT Factory Installed	Impact Rated- Provide	+70/-80	+40.5/-45.
	w/ 5 Light- IMPACT RATED	"WinGuard"	Insulated Glass	Hales Navy HC154 on Outer Face		Schlage Keyway (Lever & Deadbolt)	Inactive side	Installed	INOA.		
08a	2068 Pocket Door in Cased Opening	TBS	1 3/8" SOLID CORE	Painted- Color TBS	3/4 wood Frame	TBS:: Flush Edge Pull Passage Set	TBS		Casing TBS	N/A	N/A
09a	2068 Pocket Door	TBS	1 3/8" SOLID	Painted-	3/4 wood	TBS:: Flush Edge Pull	TBS		Casing TBS	N/A	N/A
	in Cased Opening		CORE	Color TBS	Frame	Passage Set					
00a	Double 3068 Alum. French Doors w/ 1 Light- IMPACT RATED	PGT Window Co. Mod. FD750	"Energy Max" Low E, Laminated	Powdercoated Black Factory	SS Tapcons	EMTEK (model TBS) Plate in SS	EMTEK (model TBS) Lever & Dummy on	PGT Factory Installed	Impact Rated- Provide NOA.	+70/-80	+37.1/-65.
		"WinGuard"	Insulated Glass	Finish	per NOA	Schlage Keyway (Lever & Deadbolt)	Inactive side				
00b	9868 Alum. BiFold French Doors w/ 1 Light- IMPACT RATED	4 panel Bi-Fold	Low E, Laminated	Black Factory	SS Tapcons	Plate in SS	EMTEK (model TBS) Lever & Dummy on	Marvin Factory Installed	Impact Rated- Provide NOA.	+70/-80	+40.5/-45.
	(Custom to Fit Exact RO)	French Door	Insulated Glass	Finish	per NOA	Schlage Keyway (Lever & Deadbolt)	Inactive side				
00c	Doubl 3068 Alum. French Doors w/ 1 Light- IMPACT RATED	PGT Window Co. Mod. FD750	"Energy Max" Low E, Laminated	Powdercoated Black Factory	SS Tapcons		EMTEK (model TBS) Lever & Dummy on	PGT Factory Installed	Impact Rated- Provide NOA.	+70/-80	+37.1/-65.
		"WinGuard"	Insulated Glass	Finish	per NOA	Schlage Keyway (Lever & Deadbolt)	Inactive side				
01a	2868 Glass Door- Tempered	1/2" Frameless Glass Door	1/2" Temp. Glass w/ Sidelights		TBS	Privacy Set	TBS	Bright Chr. US26	Casing TBS	N/A	N/A
01b	3068 Prehung Door	TBS	1 3/8" SOLID	Painted- Color TBS	3/4 wood prehung	Passage Set	TBS		Inside Face to be Built out per Elevtr Code	N/A	N/A
01c	2068 Prehung Door	TBS- Solid Core	1 3/8" SOLID	Painted-	3/4 wood	Passage Set	TBS	Bright Chr. US26	Casing TBS	N/A	N/A
03a	2068 Prehung Door	W/ Weatherstrip'g TBS	1 3/8" SOLID	Color TBS Painted-	prehung 3/4 wood	Privacy Set	TBS	Bright Chr. US26	w/ Gasketed Threshold	N/A	N/A
			CORE	Color TBS	prehung						
04a	2068 Prehung Door	TBS	1 3/8" SOLID CORE	Painted- Color TBS	3/4 wood prehung	Privacy Set	TBS	Bright Chr. US26	Casing TBS	N/A	N/A
0.41.	BiPass Shower Door	TBS	Clear 3/8" Glass w/ sandblasted mo	desty Panel	Frameless	D Handle Bright Chrome		Bright Chrome rails and clips	By Shower Door Co.	N/A	N/A
04b	2868 Prehung Door	TBS	1 3/8" SOLID CORE	Painted- Color TBS	3/4 wood prehung	 Privacy Set 	TBS	Bright Chr. US26	Casing TBS	N/A	N/A
04b 05a			1 3/8" SOLID	Painted-	3/4 wood	Passage Set	TBS	Bright Chr. US26	Casing TBS	N/A	N/A
	2668 Prehung Door	Plantation Style		Color TBS	prehung 3/4 wood	Privacy Set	TBS	Bright Chr. US26	Casing TRS	N/A	N/A
05a 05b]	2" Lvrd	CORE	Painted-		11114403 000		Bright Sim. 6626	loading 120		
05a 05b 06a	2068 Prehung Door	2" Lvrd TBS	1 3/8" SOLID CORE	Painted- Color TBS	prehung			5	D 6:	N/A	N/A
05a 05b]	2" Lvrd	1 3/8" SOLID	Color TBS	prehung Frameless	D Handle Bright Chrome		Bright Chrome rails and clips	By Shower Door Co.		
05a 05b 06a	2068 Prehung Door	2" Lvrd TBS	1 3/8" SOLID CORE Clear 3/8" Glass	Color TBS	prehung Frameless		TBS			N/A	N/A
05a 05b 06a	2068 Prehung Door BiPass Shower Door 2868 Prehung Door Dbl 3068 BiPass Closet Door	Z" Lvrd TBS TBS TBS Plantation Style	1 3/8" SOLID CORE Clear 3/8" Glass w/ sandblasted mo 1 3/8" SOLID CORE 1 3/8" SOLID	desty Panel Painted- Color TBS Painted-	Frameless 3/4 wood prehung 3/4 wood	Bright Chrome Privacy Set JOHNSON 100	TBS TBS	rails and clips	Casing TBS	N/A N/A	N/A N/A
05a 05b 06a 06b	2068 Prehung Door BiPass Shower Door 2868 Prehung Door Dbl 3068 BiPass Closet Door Double 2668 Doors	Z" Lvrd TBS TBS TBS	1 3/8" SOLID CORE Clear 3/8" Glass w/ sandblasted mo 1 3/8" SOLID CORE 1 3/8" SOLID CORE	desty Panel Painted- Color TBS Painted- Color TBS Painted- Painted- Painted- Painted-	prehung Frameless 3/4 wood prehung 3/4 wood prehung 3/4 wood prehung 3/4 wood	Bright Chrome Privacy Set JOHNSON 100 Series Track & Cars TBS:: Privicay Lock w/	TBS	rails and clips Bright Chr. US26	Casing TBS Casing TBS		
05a 05b 06a 06b 07a 07b	2068 Prehung Door BiPass Shower Door 2868 Prehung Door Dbl 3068 BiPass Closet Door Double 2668 Doors w/ T Astragal	Z" Lvrd TBS TBS TBS Plantation Style Z" Lvrd TBS	1 3/8" SOLID CORE Clear 3/8" Glass w/ sandblasted mo 1 3/8" SOLID CORE 1 3/8" SOLID CORE 1 3/8" SOLID CORE	desty Panel Painted- Color TBS Painted- Color TBS Painted- Color TBS Painted- Color TBS	prehung Frameless 3/4 wood prehung 3/4 wood prehung 3/4 wood prehung 3/4 wood prehung	Bright Chrome Privacy Set JOHNSON 100 Series Track & Cars TBS:: Privicay Lock w/ matching dummy	TBS TBS	Bright Chr. US26 Bright Chr. US26 Bright Chr. US26 Bright Chr. US26	Casing TBS Casing TBS Casing TBS	N/A N/A	N/A N/A
05a 05b 06a 06b 07a	2068 Prehung Door BiPass Shower Door 2868 Prehung Door Dbl 3068 BiPass Closet Door Double 2668 Doors w/ T Astragal	Z" Lvrd TBS TBS TBS Plantation Style Z" Lvrd	1 3/8" SOLID CORE Clear 3/8" Glass w/ sandblasted mo 1 3/8" SOLID CORE 1 3/8" SOLID CORE	desty Panel Painted- Color TBS Painted- Color TBS Painted- Color TBS Painted- Color TBS Factory Black, Painted-Dk Blue Hales Navy HC154	prehung Frameless 3/4 wood prehung 3/4 wood prehung 3/4 wood prehung Alum.: install w/ SS Tapcons	Bright Chrome Privacy Set JOHNSON 100 Series Track & Cars TBS:: Privicay Lock w/ matching dummy EMTEK (model TBS) Plate in SS Schlage Keyway	TBS	rails and clips Bright Chr. US26 Bright Chr. US26	Casing TBS Casing TBS	N/A	N/A N/A
05a 05b 06a 06b 07a 07b	2068 Prehung Door BiPass Shower Door 2868 Prehung Door Dbl 3068 BiPass Closet Door Double 2668 Doors w/ T Astragal Dbl 2668 Alum. French Door w/ 5 Light- IMPACT RATED	Z" Lvrd TBS TBS Plantation Style Z" Lvrd TBS PGT Window Co. Mod. FD750 "WinGuard"	1 3/8" SOLID CORE Clear 3/8" Glass w/ sandblasted mo 1 3/8" SOLID CORE 1 3/8" SOLID CORE 1 3/8" SOLID CORE 1 3/8" SOLID CORE "Energy Max" Low E, Laminated Insulated Glass	Color TBS desty Panel Painted- Color TBS Painted- Color TBS Painted- Color TBS Factory Black, Painted-Dk Blue Hales Navy HC154 on Outer Face	prehung Frameless 3/4 wood prehung 3/4 wood prehung 3/4 wood prehung Alum.: install w/ SS Tapcons per NOA	Bright Chrome Privacy Set JOHNSON 100 Series Track & Cars TBS:: Privicay Lock w/ matching dummy EMTEK (model TBS) Plate in SS Schlage Keyway (Lever & Deadbolt)	TBS TBS EMTEK (model TBS) Lever & Dummy on Inactive side	Bright Chr. US26 Bright Chr. US26 Bright Chr. US26 Bright Chr. US26 PGT Factory Installed	Casing TBS Casing TBS Casing TBS Impact Rated- Provide NOA.	N/A N/A +70/-80	N/A N/A +40.5/-45
05a 05b 06a 06b 07a 07b	2068 Prehung Door BiPass Shower Door 2868 Prehung Door Dbl 3068 BiPass Closet Door Double 2668 Doors w/ T Astragal Dbl 2668 Alum. French Door w/ 5 Light- IMPACT RATED	Z" Lvrd TBS TBS TBS Plantation Style Z" Lvrd TBS PGT Window Co. Mod. FD750	1 3/8" SOLID CORE Clear 3/8" Glass w/ sandblasted mo 1 3/8" SOLID CORE 1 3/8" SOLID CORE 1 3/8" SOLID CORE 1 3/8" SOLID CORE "Energy Max" Low E, Laminated	Color TBS desty Panel Painted- Color TBS Painted- Color TBS Painted- Color TBS Factory Black, Painted-Dk Blue Hales Navy HC154 on Outer Face Factory Black, Painted-Dk Blue Hales Navy HC154	prehung Frameless 3/4 wood prehung 3/4 wood prehung 3/4 wood prehung Alum.: install w/ SS Tapcons per NOA Alum.: install w/ SS Tapcons	Bright Chrome Privacy Set JOHNSON 100 Series Track & Cars TBS:: Privicay Lock w/ matching dummy EMTEK (model TBS) Plate in SS Schlage Keyway (Lever & Deadbolt) EMTEK (model TBS) Plate in SS Schlage Keyway	TBS TBS EMTEK (model TBS) Lever & Dummy on	Bright Chr. US26 Bright Chr. US26 Bright Chr. US26 Bright Chr. US26	Casing TBS Casing TBS Casing TBS Impact Rated- Provide	N/A N/A	N/A N/A
5b 5b 6a 6b 7a 7b	2068 Prehung Door BiPass Shower Door 2868 Prehung Door Dbl 3068 BiPass Closet Door Double 2668 Doors w/ T Astragal Dbl 2668 Alum. French Door w/ 5 Light- IMPACT RATED Dbl 2668 Alum. French Door w/ 5 Light- IMPACT RATED	Z" Lvrd TBS TBS TBS Plantation Style 2" Lvrd TBS PGT Window Co. Mod. FD750 "WinGuard" PGT Window Co. Mod. FD750 "WinGuard"	1 3/8" SOLID CORE Clear 3/8" Glass w/ sandblasted mo 1 3/8" SOLID CORE 1 3/8" SOLID CORE 1 3/8" SOLID CORE "Energy Max" Low E, Laminated Insulated Glass "Energy Max" Low E, Laminated	Color TBS desty Panel Painted- Color TBS Painted- Color TBS Painted- Color TBS Factory Black, Painted-Dk Blue Hales Navy HC154 on Outer Face Factory Black, Painted-Dk Blue Hales Navy HC154 on Outer Face	prehung Frameless 3/4 wood prehung 3/4 wood prehung 3/4 wood prehung Alum.: install w/ SS Tapcons per NOA Alum.: install w/ SS Tapcons per NOA	Bright Chrome Privacy Set JOHNSON 100 Series Track & Cars TBS:: Privicay Lock w/ matching dummy EMTEK (model TBS) Plate in SS Schlage Keyway (Lever & Deadbolt) EMTEK (model TBS) Plate in SS	TBS TBS EMTEK (model TBS) Lever & Dummy on Inactive side EMTEK (model TBS) Lever & Dummy on	Bright Chr. US26 Bright Chr. US26 Bright Chr. US26 Bright Chr. US26 PGT Factory Installed	Casing TBS Casing TBS Casing TBS Impact Rated- Provide NOA. Impact Rated- Provide	N/A N/A +70/-80	N/A N/A +40.5/-4

The Work Shown in these Plans Shall Comply with the 2020 Florida Building Code w/ any 6/18/21 12:30 PM Derrickson_WINDOW Schedule_8_8_19.xls

DER	RICK.	SON	RES :: PGT WINDO	N S	CHED	OULE ::	: NEW A	Vlumi	nium	Vindo	WS			
OB ADDRI	ESS: 330 N	IE 1st Ave	nue, Delray Beach, FL, Revised 6/18/21											
		Quantity			Exterior	Exterior			WOOD FRAME	WOOD FRAME		Head Ht. above		Actual Wind
	MULL	of this		GLASS	FRAME	SASH			R. Opening	R. Opening		FFL of that	Wind Pressure	Pressure on
/INDOW #	PATTERN	type	DESCRIPTION	TYPE	FINISH	FINISH	MANUF.	MODEL #	Width (in)	Height (in)		Room	Rating per manf	Door (Exp. B
M	AIN RES	IDENCE	Windows											
4	4/1	4	Alum. Single Hung Window: SH7700A Series	Note #1	Black	Black	PGT Windguard	H35	26"	62.5"	Clear Low E Glass	7'- 6"	+65/-80	+43.4/-47
3	4/1	2	Alum. Single Hung Window: SH7700A Series	Note #1	Black	Black	PGT Windguard	24	36.5"	52.125"	Clear Low E Glass	6'- 10"	+65/-80	+43.4/-47
,	4/1	14	Alum. Single Hung Window: SH7700A Series	Note #1	Black	Black	PGT Windguard	H34	26"	52.125"	Clear Low E Glass	6'- 10"	+65/-80	+44.9/-48
		†			<u> </u>							NOT	ΓΕ: (1) type C is	'+41.1/-75
)	4/1	2	Alum. Single Hung Window: SH7700A Series	Note #1	Black	Black	PGT Windguard	H34	26"	52.125"	Clear Low E Glass	6'- 10"	+65/-80	+41.1/-7
											& Frosted			
	4/1	1	Alum. Single Hung Window: SH7700A Series	Note #1	Black	Black	PGT Windguard	H36	26"	75.5"	Clear Low E Glass	6'- 10"	+65/-80	+43.4/-47
:	4/1	2	Alum. Single Hung Window: SH7700A Series	Note #1	Black	Black	PGT Windguard	H35	26"	62.5"	Clear Low E Glass	sill at 8"	+65/-80	+43.4/-47
	1., .	-	J 3 3 3 3 3 3 3 3 3 3 3 3 3 3 3 3 3 3 3		- Index					+	0.00. 20.0 2 0.000		100, 00	
					-									
		-	GENERAL NOTE: Can Substitute Marvin "Coa	stline Se	ries" Sinale	Hung iZ4 Ser	ies In Black if PGT	 Backorde	red. (use Sam	Low E Lamin	nated Insulated G	lass)		
			Note #1: All windows IMPACT RESISTANT, FI						land (ase same					
	<u> </u>		Use High Performance Impact Rate						rgy Star Max")					
			Note #2: All windows to have GWB interior	returns (Price Option	to Case Out	Interior),							
			IF Sill is 24" or less provide ASTM											
			All Simulated Divided Lights to ha	ve 3/4"	Dimensional	Grilles OUTSII	DE & Low Profile (Ogee Inside	2					
			Note #3: Must Comply with all Local Codes	for Stre	ngth & Insta	allation technic	ques. Also Windov	w Installer t	to follow manu	ıfacturers inst	allation and			
			flashing directions. Window Instal											
			Note #4: Verify all Wood & Masonry Opening											
	ļ		to Create Rough Opening for Fin F										<u></u>	
			Note #5: ALL Windows to have screens; colonote #6: PGT & Marvin Windows are Powde					Colonial	outside/low p	TOTILE COLONIAL	inside; match inte	rior/exterior finis	n.	
			Note #6. PGT & Marvin Windows are Powde	Coat or	Kyriai Finisi	i. Color as Not	Lea on Elevations			-				
				1			1	1	1	1	1	1	4	11

Plumbing, and Existing Building Code(s). Framing and Other Structural Details will also comply with ICC-600 (Previously SSTD 10-99).

Amendments and (as applicable) the same version of the Florida Mechanical, Electrical,

SLOAN

SLOAN ARCHITECTURE D E S I G N

Sloan & Sloan Inc. 106 SE 7th Ave. Delray Beach, FL (561) 243-8755 dsloan@sloandesign.biz ID 0002725 & AR95577 AA26002208

Date **Revision Notes** x/xx/202sued for HPB Review x/xx/2021Issued for Permitting

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	ckson Residence

A 5/16/09 Issue Note

А	3/10/09	issue ivote		
No.	Date		Issue Notes	
/				
			Daniel Slo Date:	an, AR9557

Sloan & Sloan- Architecture + I.D. 106 SE 7th Avenue, Ste. B Delray Bch, FL 33483 (561) 243-8755

Derrickson Residence Renovations & Additions 330 NE 1st Avenue

rawing Title NEW Door & Window Schedules & General Notes

	D. Sloan	Derrickson Residence Project
	Drawn By D. Sloan	As Noted
	Reviewed By D. Sloan	Drawing No. A2.02b
	Date 8/22/2021	——— of ———
Der	CAD File Name rickson_Reno_ExtgBldg.	Total Sheets

GENERAL CONSTRUCTION NOTES-

Derrickson Residence New Single Family Home Project

1. All dimensions, Specifications, and Notes provided herein shall be verified by each Subcontractor and Vendor prior to performance of the work, any discrepancies shall be immediately brought to the attention of the GC/Project Manager and Architect. Written dimensions shall take precedence over scale dimensions at all times. The work shall conform to the Florida Building Code latest edition and County/Municipalities Interpretations thereof. *Included in the work is Submitting* Samples/Specifications/Colors/Paperwork as may be required to obtain City of Delray Beach Historic Preservation Board or HOA Board Pre-Approval for any items or assemblies where such approval is required such as WINDOWS and EXTERIOR DOORS.

2. DRAWINGS: These Drawings are diagrammatic only. It is not the intent of these drawings to show every minor detail of construction. The Subcontractor and Vendor shall furnish and install all items needed for a complete building system and provide all requirements for the equipment to be placed in proper working order. Prior to submission of bids, Contractor, Subcontractors, and Vendors shall visit the site and bring any descrepencies at the stie, with the plans, and specs to the attention of the Architect and shall verify that their final bid includes all items and assembiles needed to commply with the FBC, PBC, and City requirements, codes, and rules and the intent depicted in these drawings. A complete set of approved, signed and sealed drawings, together with approved "Change Order" sheets, addenda, Shop Drawings, and Supplemental Information, along with all permit copies shall be maintained at the jobsite at all times.

3. Work shall include all items (building and site) indicated on these drawings unless otherwise noted. (co-ordinate with written specifications, as applicable)

4. Shop drawings shall be submitted for approval for the following items:

1. Trusses	\underline{XX}	6. Stairs	\underline{XX}
2. Wall Panels		7. Structural Connections	\underline{XX}
3. A/C	\underline{XX}	8. Plumbing Riser	
4. Windows/Store	efront XX	9. Electrical Riser	
5. Doors	\underline{XX}	10. Cabinets	\underline{XX}
		11. Other	

5. ____ General Contractor or XX Owner: shall maintain Temporary Electrical, Water, and Sanitary Facilities for the duration of construction unless Specifically otherwise provided for in the Construction Contract.

6. Deposits and Fees: Deposits for Water Meter, Telephone, Water, if applicable, shall be billed to Owner at GC net cost.

7.All trades shall be responsible for cleaning up and bringing their own trash and scrap materials to the on site dumpster each day. Jobsite shall be cleaned daily by each Subcontractor. If not done, GC may backcharge Subcontractor for the cost of such cleanup as

8. Every Subcontractor and Vendor shall carry adequate Public Liability and Workers Comp Insurance for the duration of the work. SEE RFP for any limits required above the Statutory Requirements. All work shall be in accordance with applicable National, State, and local Codes, rules, and ordinances. Each Subcontractor shall have Conch Custom Homes added as an Additional Named Insured and furnish GC a Certificate of Insurance attesting to same.

9. TRUSS MANUFACTURER; co-ordinate truss profiles to accommodate HVAC Ductwork per Sheet M-1 & M.2 (as applicable). All Truss to Truss Metal connectors shall be furnished by Truss Manf. as part of Truss Package.

10. All Demolition Work accomplished by Subcontractor shall follow latest EPA Leadsafe Workplace Standards for containment and removal of possible lead paint in any residential structure constructed prior to 1979, unless such demolition work was accomplished by the Owner acting as "Owner/Builder".


11. No Contractor, Subcontractor, or Vendor shall bring onto the site or incorporate into the building any material containing Aebestos or PCBs. If the project is a renovation project the observation of either substance shall immediately be brought to the attention of the Architect and GC so that they can be appropriatley remediated or removed.


12. Each Subcontractor, Speciality Contractor, and Vensdor shall install his/her portion of the work in a neat, workmanlike manner and in accordance with the highest standards and methods promulgated by their appropriate trade group. See Written Specs for added information. Each Contractor will protect the work of other Contractors during the installation of their materials or assemblies. If one Contractor damages the work of antother Contractor the Contractor causing such damage shall be responsible for the costs of repair of such damage. Any such conflicts shall immedialty be brought to the attention of the GC.


13. MILLWORK: Contractor shall coordinate the Millwork/Cabinetry Installer with Electrical, Plumbing, and Gas trades for device & fixture locations prior to roughing in for devices, fixtures, or equipment. All millwork shall have finished interiors be fabricated and installed in accordance with the Architectural Millwork Institute "Premium Grade" standard. No Urea Formaldahyde Glues or VOC containing Stains or Finishes shall be utilized. SEE INTERIOR DESIGN DRAWINGS & WRITTEN SPECS FOR ADDITIONAL INFORMATION.

14: GREEN PROJECT: (ONLY IF STIPULATED IN BIDDING DOCUMENTS) This project is going to be submitting for Green Certification thru the Florida Green Builidng Coaliiton, or the USGBC's LEED program, or Green Globes program. As such, All Vendors, Suppliers, and Subcontractaors shall warrant that they shall not utilize paints, sealants, glues, adhesives, primers, finishes, and other such materials containing VOC's or utilize urea formaldahyde glues (particularly in millwork and cabinetry) SEE WRITTEN SPECS for more information. If in Doubt about a particular item, ask the GC and Green Certification Constultant in advance of ordering or utilizing any such item.


Door & Window Schedules

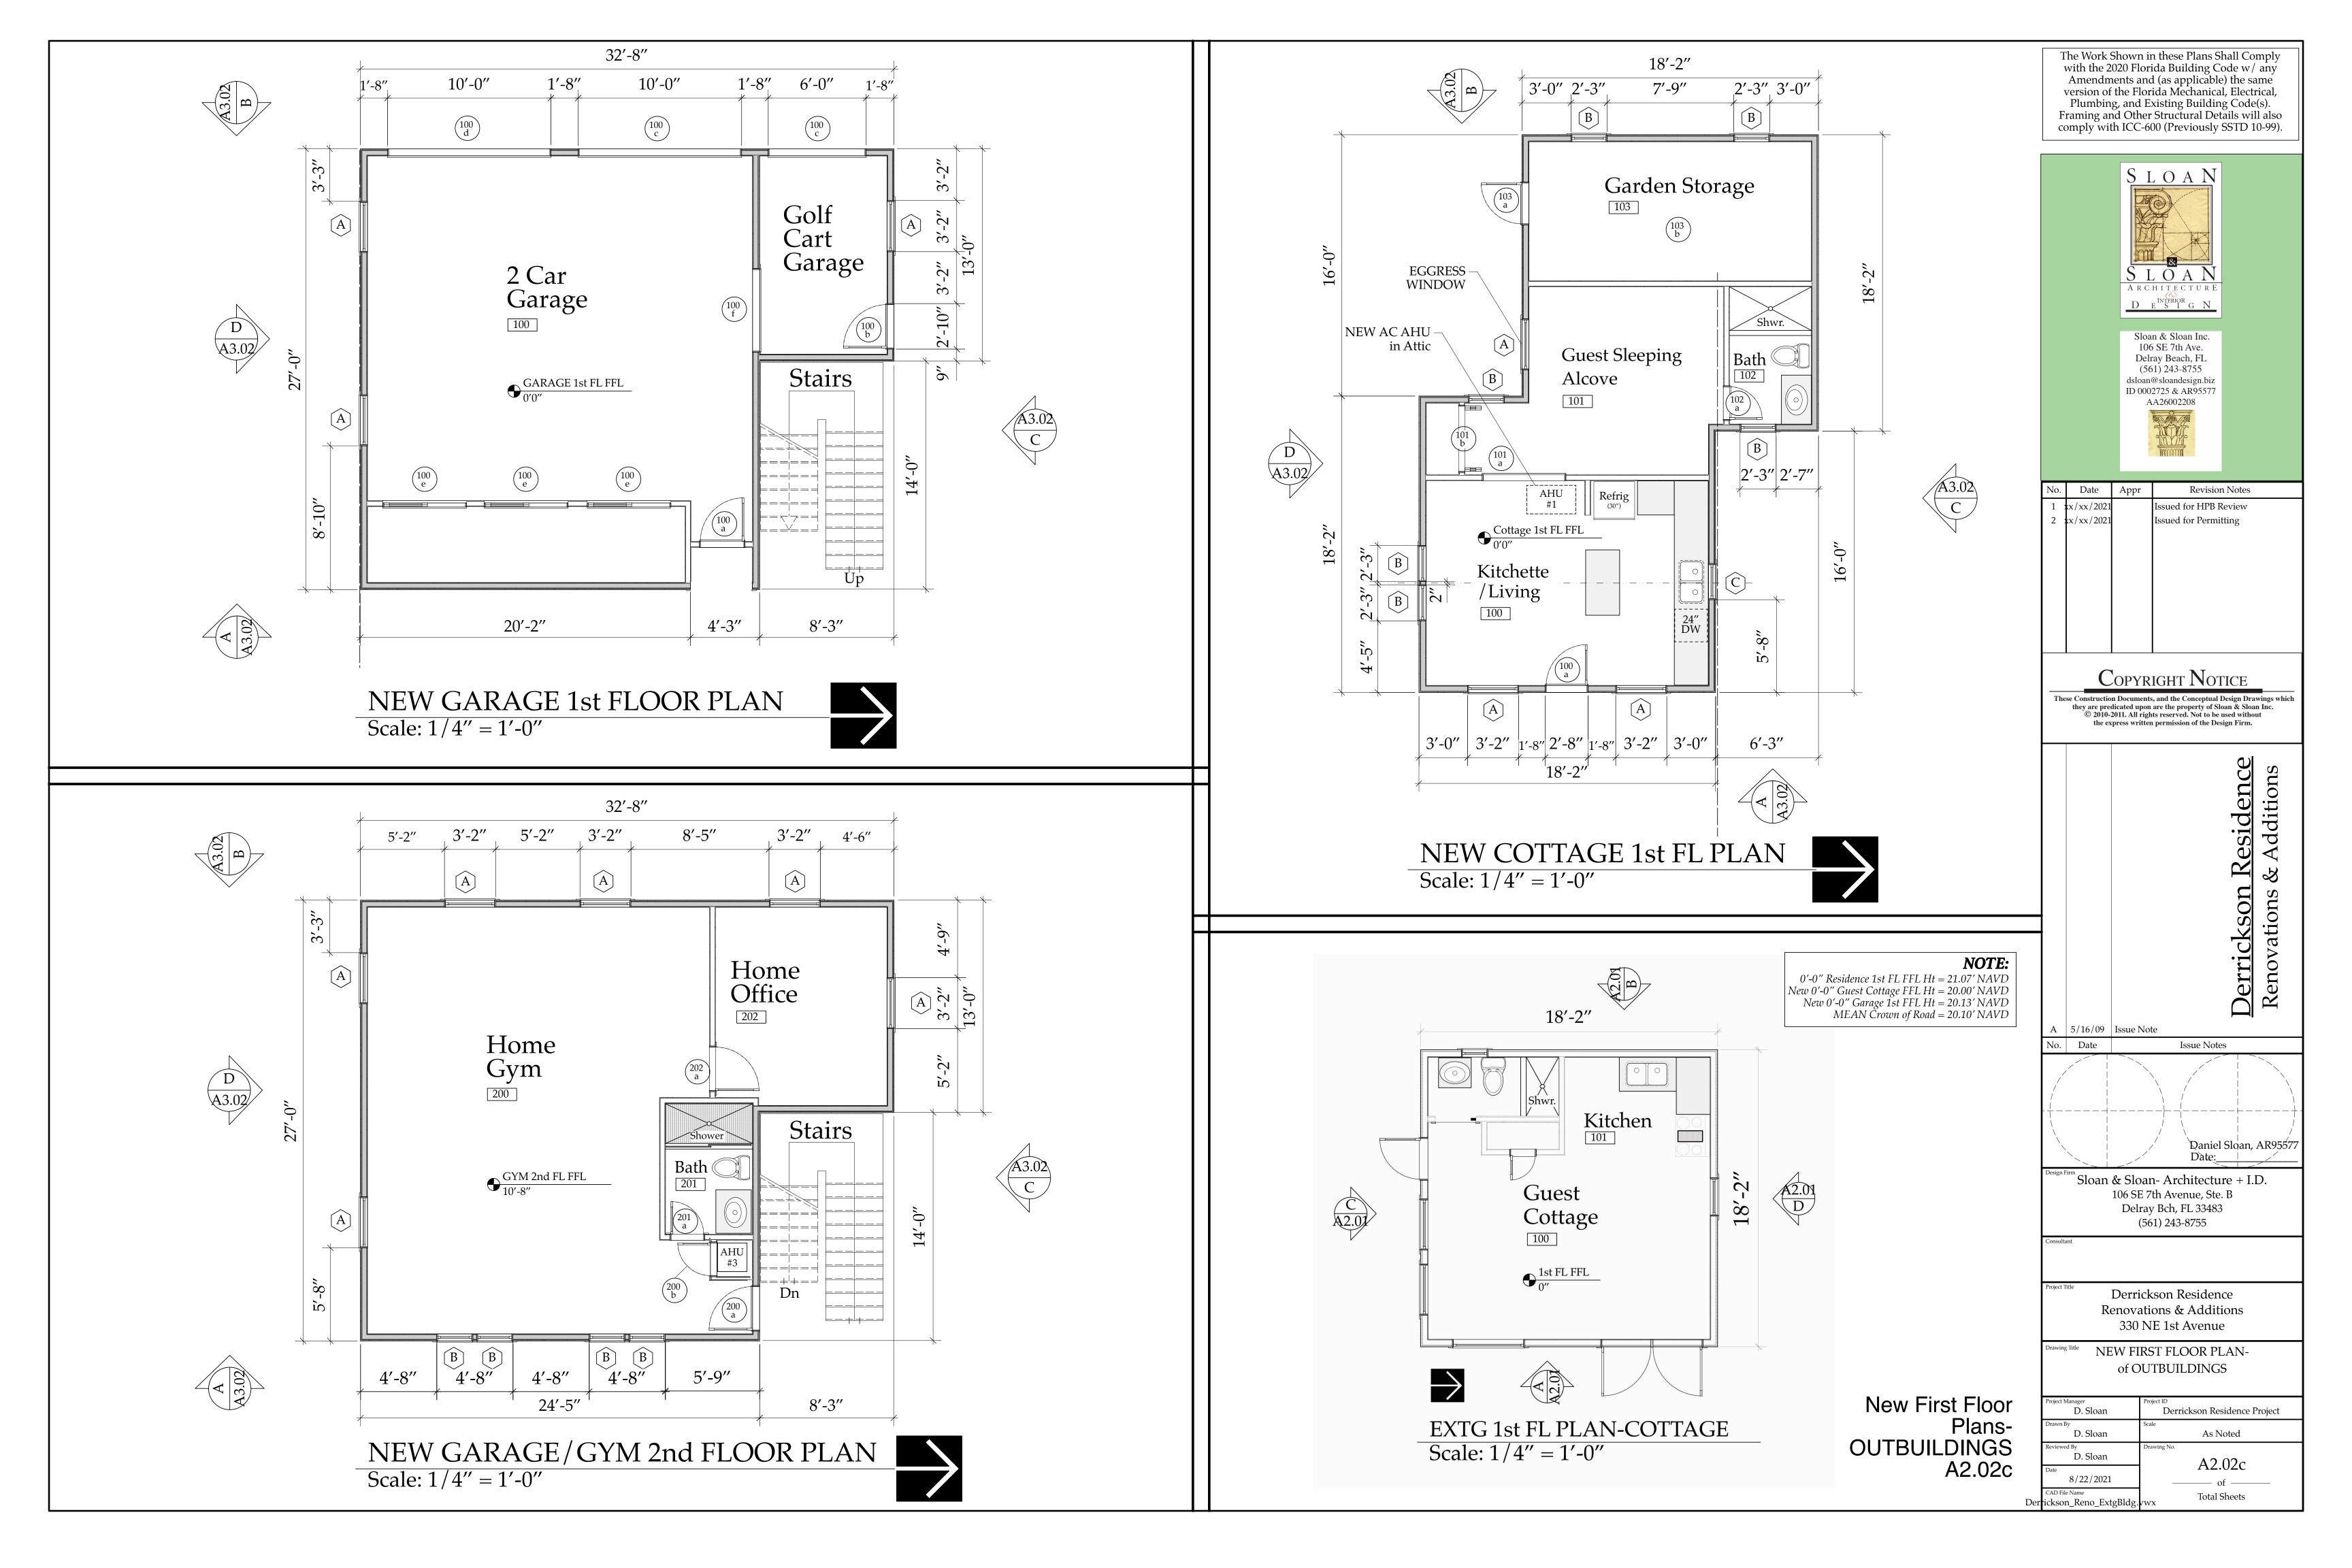

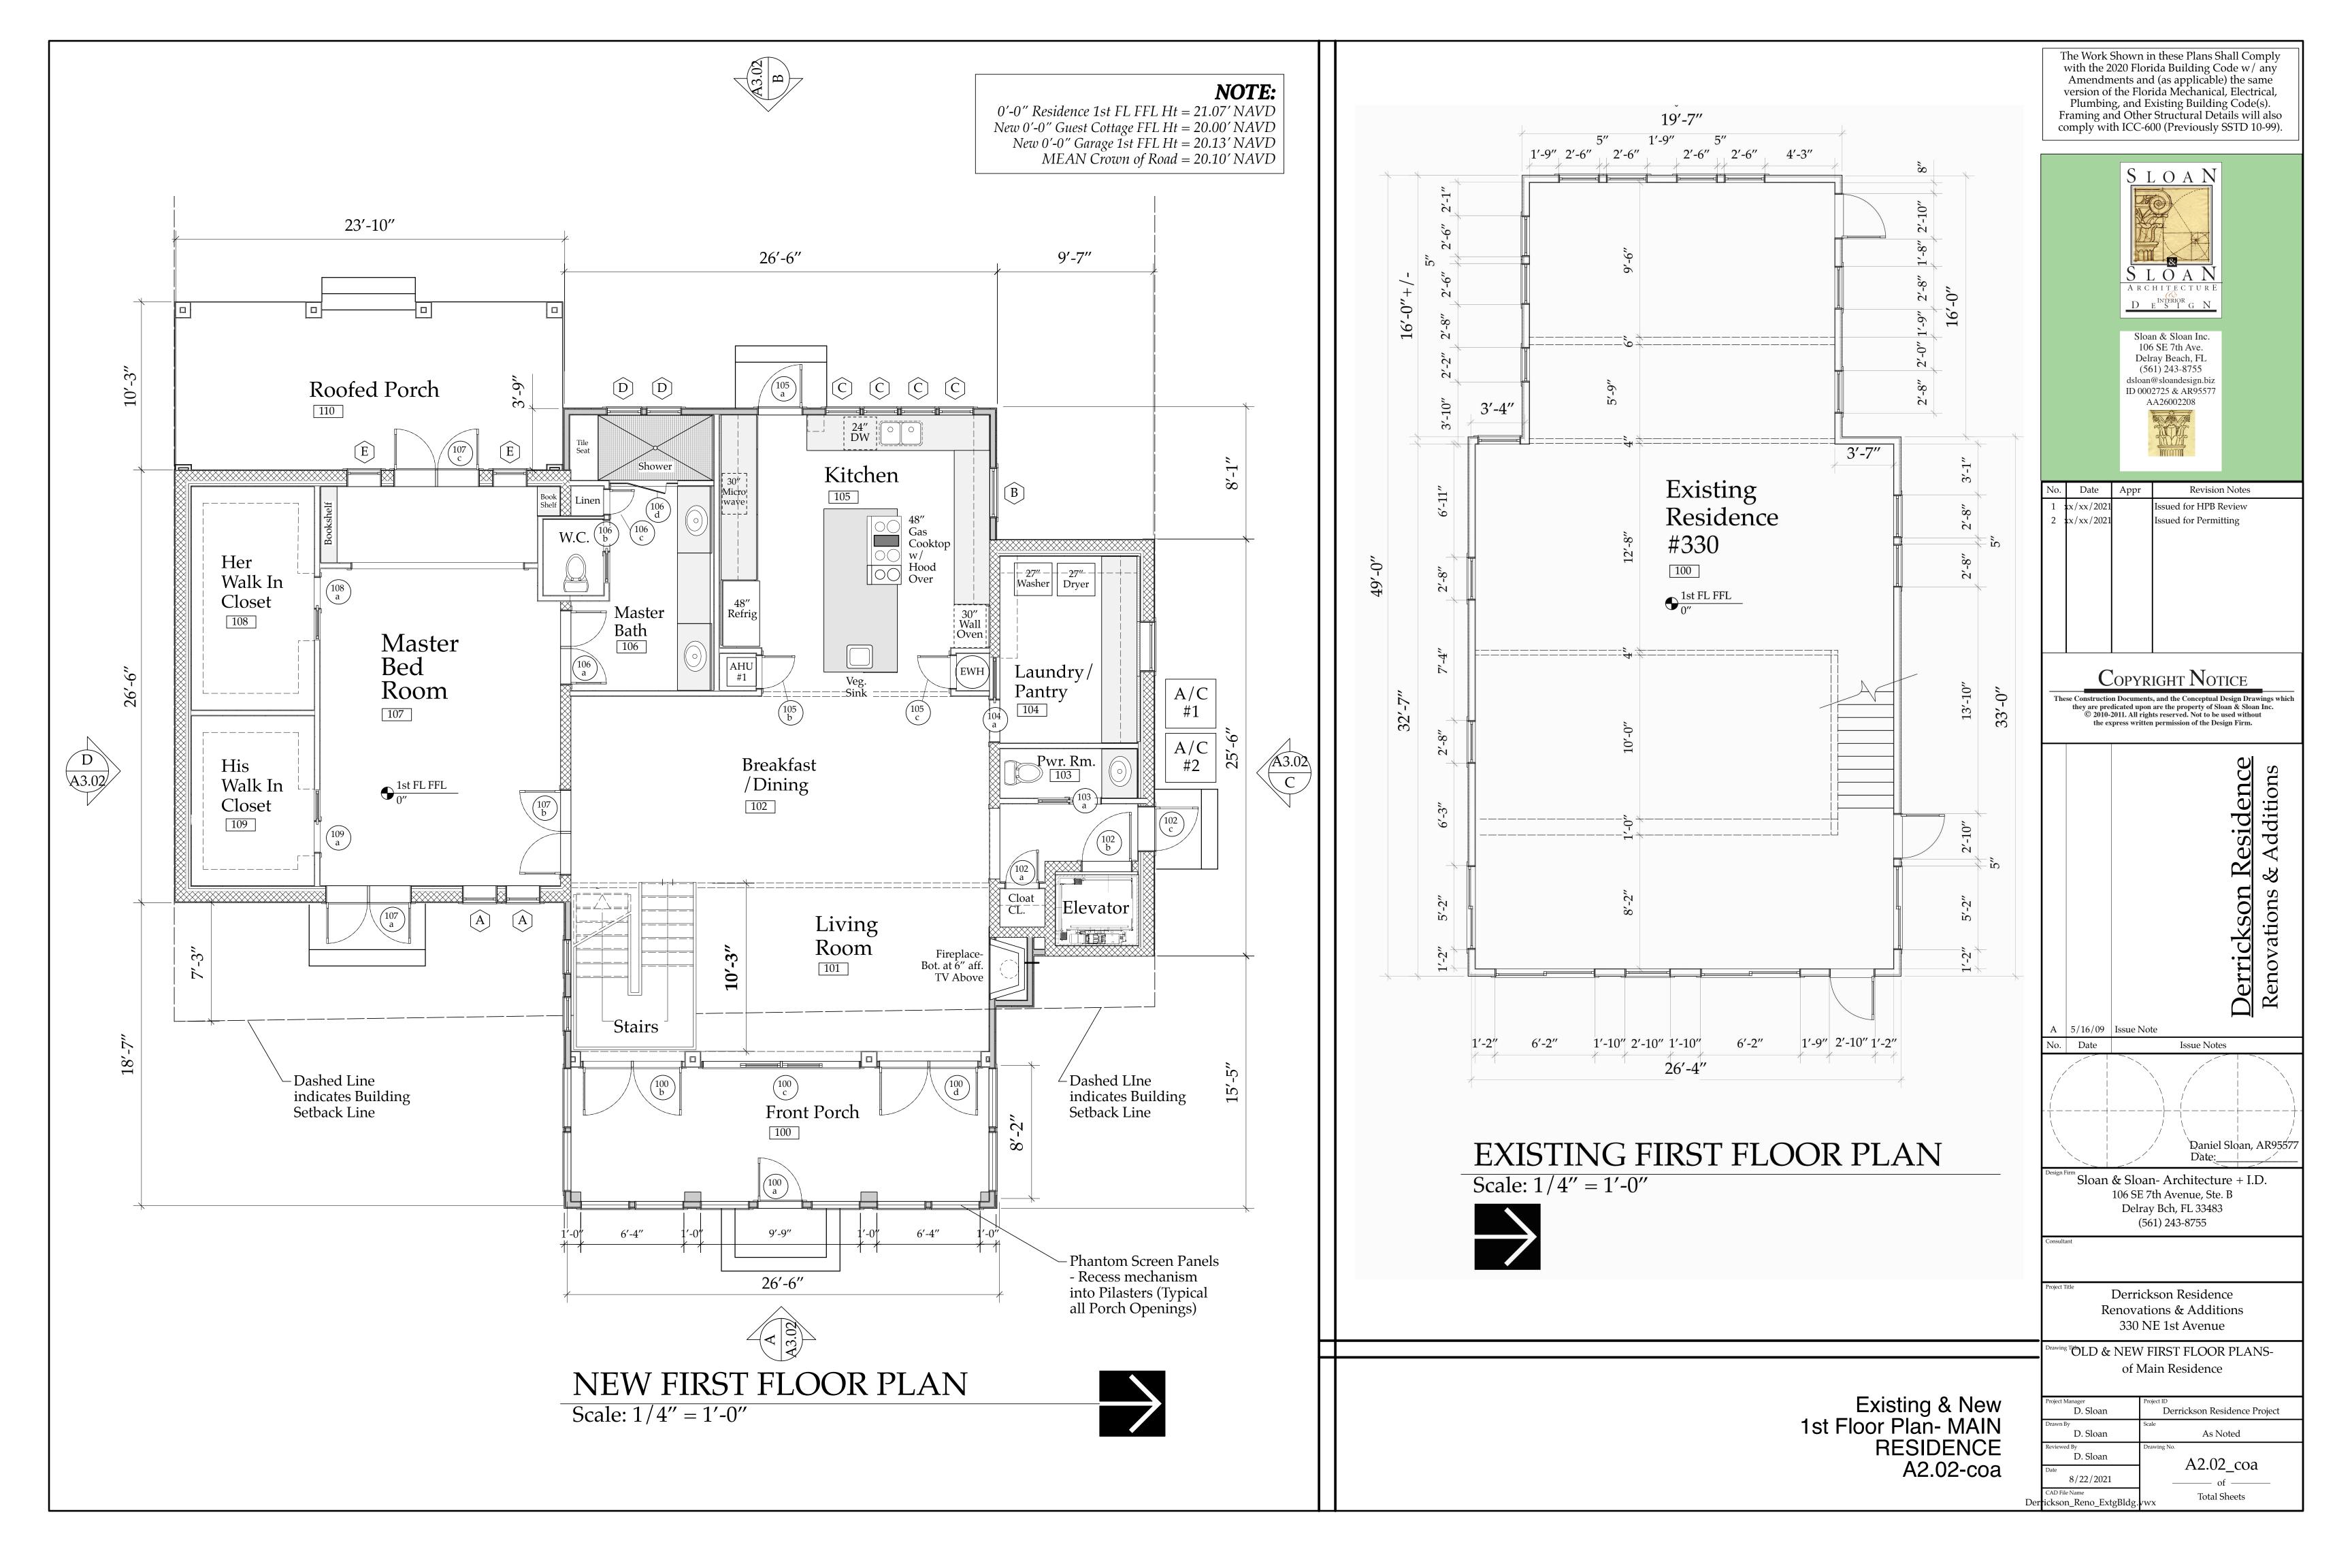

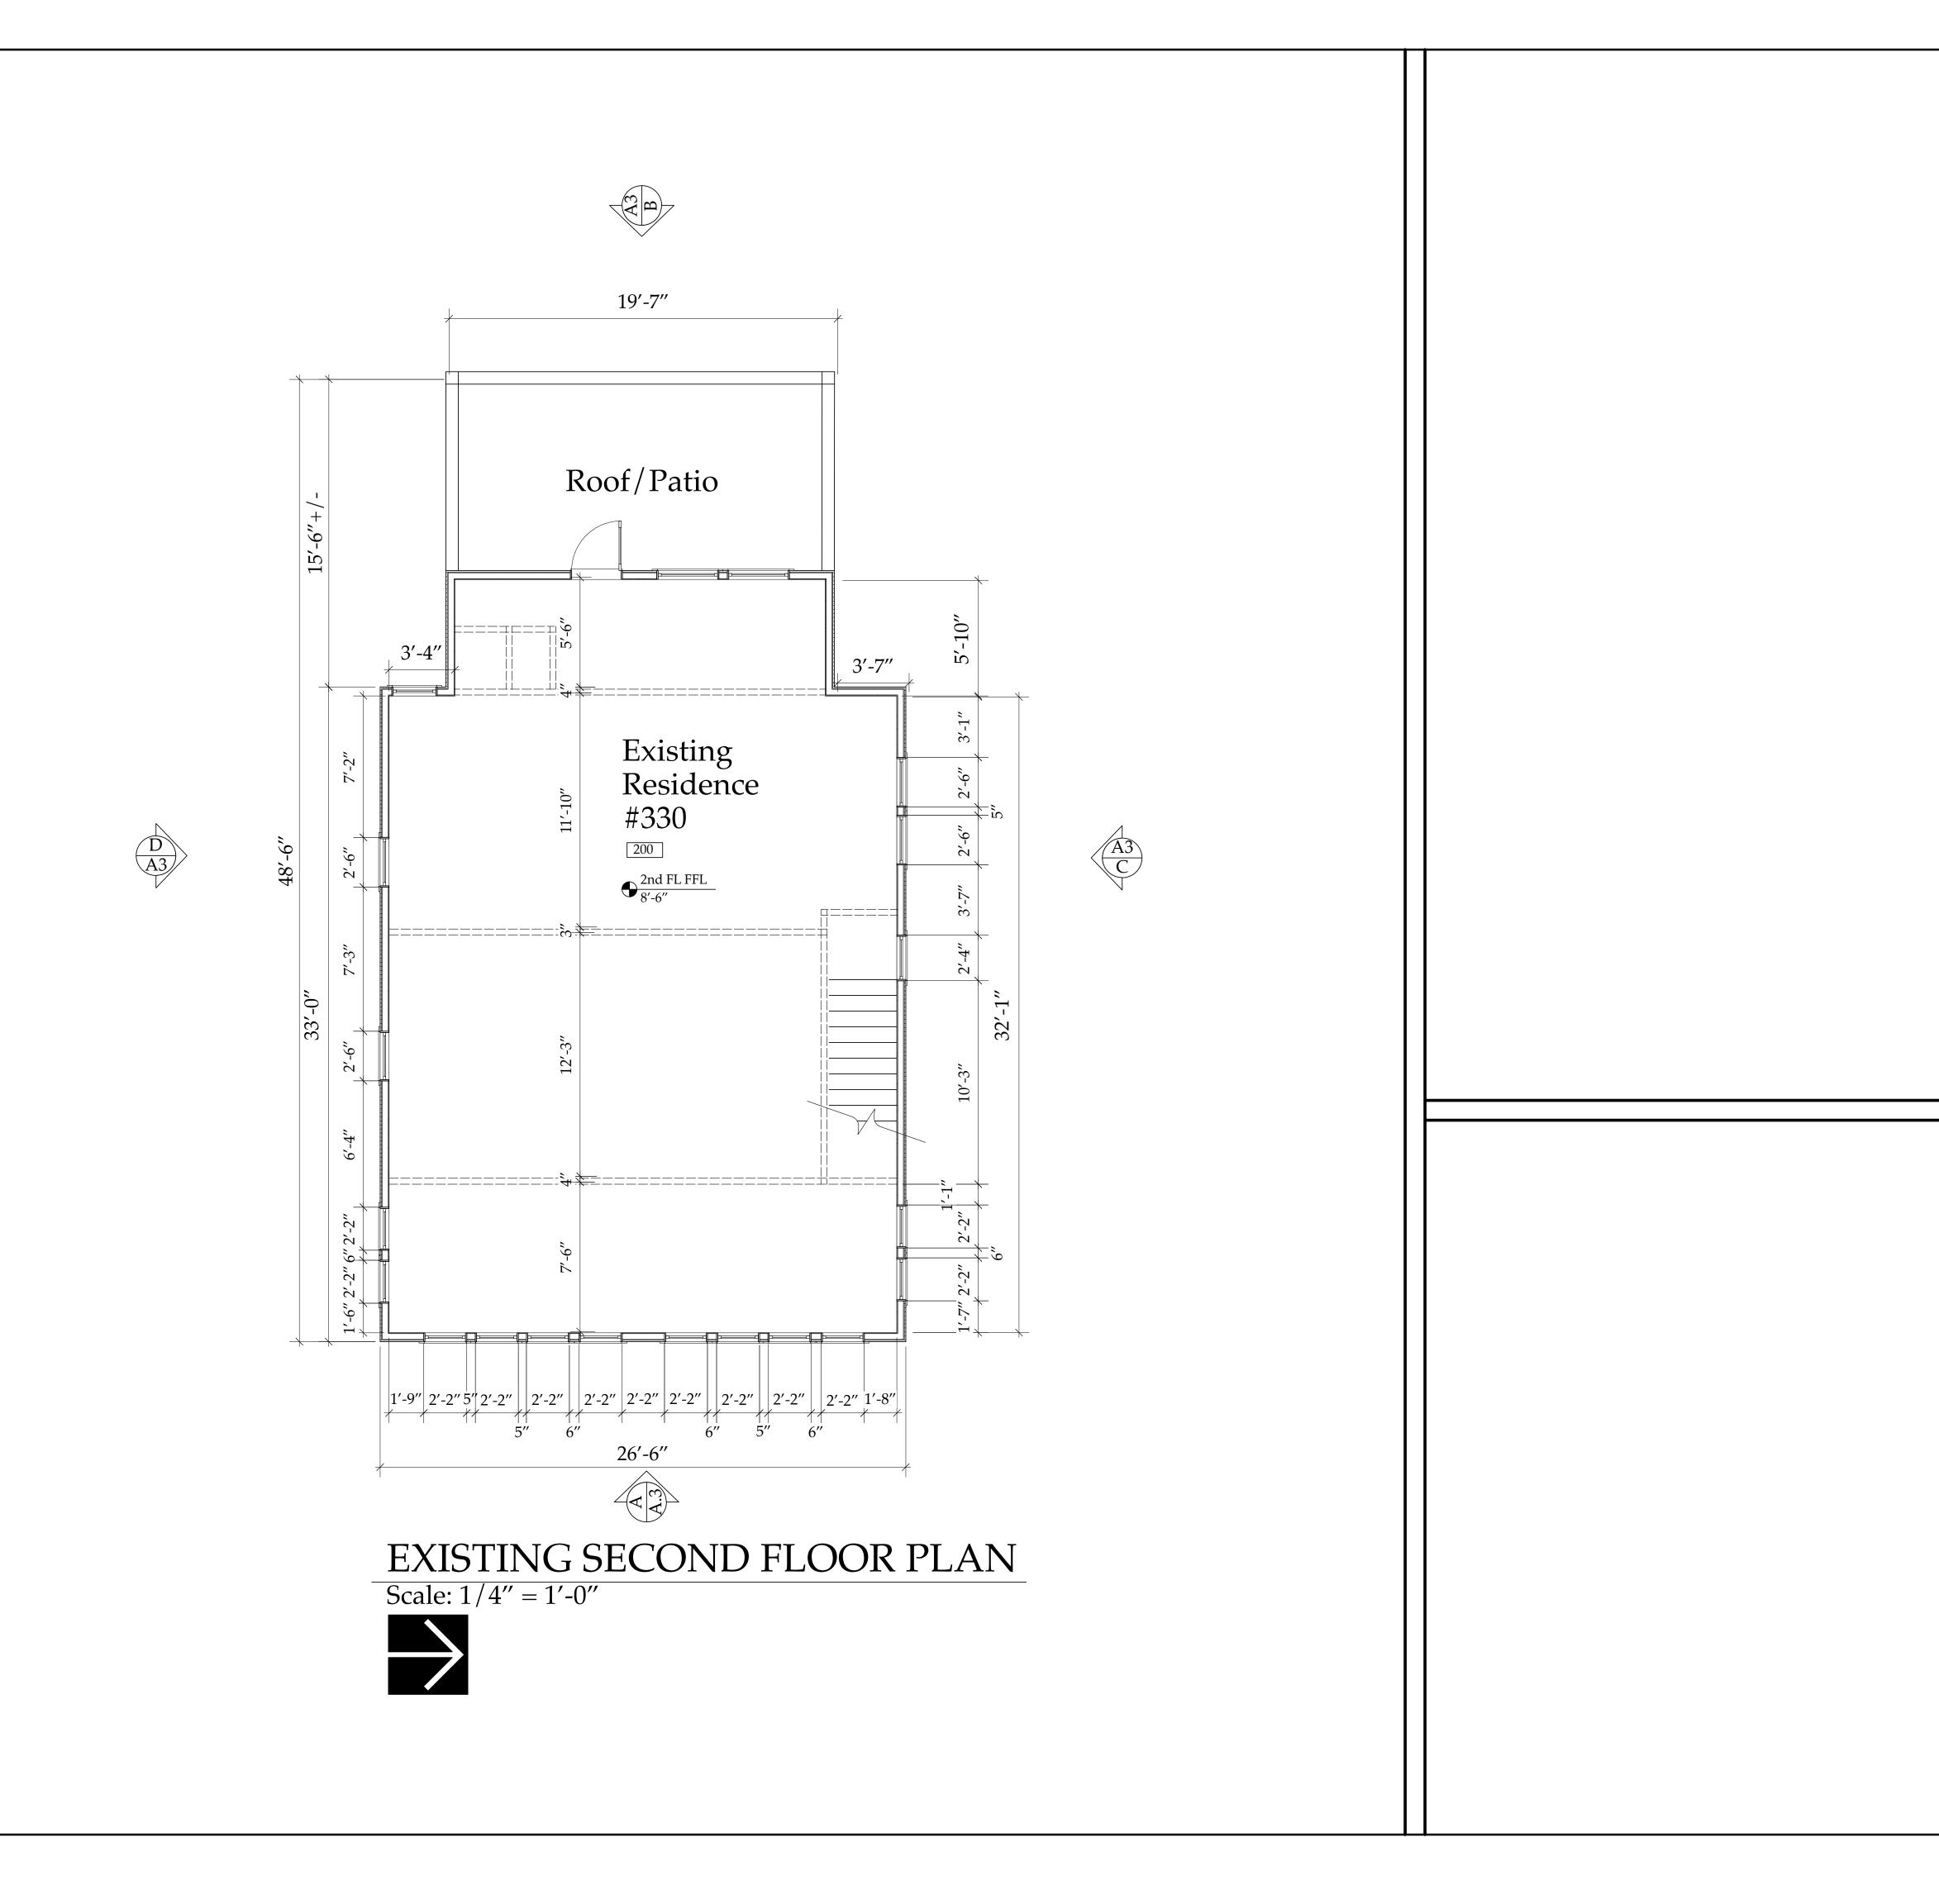

The Work Shown in these Plans Shall Comply with the 2020 Florida Building Code w/ any Amendments and (as applicable) the same version of the Florida Mechanical, Electrical, Plumbing, and Existing Building Code(s). Framing and Other Structural Details will also comply with ICC-600 (Previously SSTD 10-99).

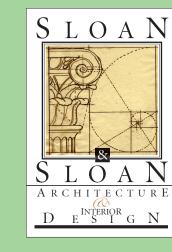

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No.	Date	Appr	Revision Notes
1	xx/xx/21 xx/xx/21		Issued for HPB Review
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^m Sloan & Sloan- Architecture + I.D. 106 SE 7th Avenue, Ste. B Delray Bch, FL 33483 (561) 243-8755

Extg 2nd Floor Plan A2.03


Derrickson Residence Renovations & Additions 330 NE 1st Avenue

rawing Title EXTG SECOND FLOOR PLANof Main Residence

Derrickson Residence Project D. Sloan D. Sloan As Noted D. Sloan A2.03 6/16/2021 **Total Sheets**



0'-0" Residence 1st FL FFL Ht = 21.07' NAVD New 0'-0" Guest Cottage FFL Ht = 20.00' NAVD New 0'-0" Garage 1st FFL Ht = 20.13' NAVD MEAN Crown of Road = 20.10' NAVD The Work Shown in these Plans Shall Comply with the 2020 Florida Building Code w/ any Amendments and (as applicable) the same version of the Florida Mechanical, Electrical, Plumbing, and Existing Building Code(s). Framing and Other Structural Details will also comply with ICC-600 (Previously SSTD 10-99).

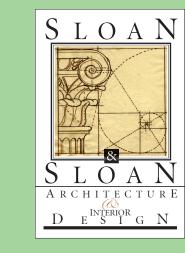


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Daniel Sloan, AR9557.

Date:

Sloan & Sloan- Architecture + I.D.

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Delray Bch, FL 33483

(561) 243-8755

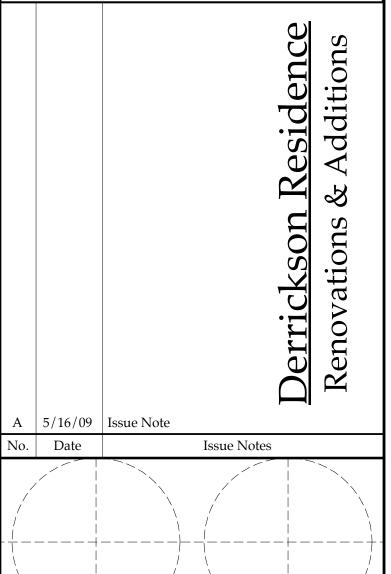
Consultant

New Second Floor Plan A2.04 Derrickson Residence Renovations & Additions 330 NE 1st Avenue


Orawing Title NEW SECOND FLOOR PLAN-


of Main Residence

	Project Manager D. Sloan	Project ID Derrickson Residence Project
	Drawn By D. Sloan	Scale As Noted
	Reviewed By D. Sloan	Drawing No. A2.04
	Date 8/22/2021	———— of ————
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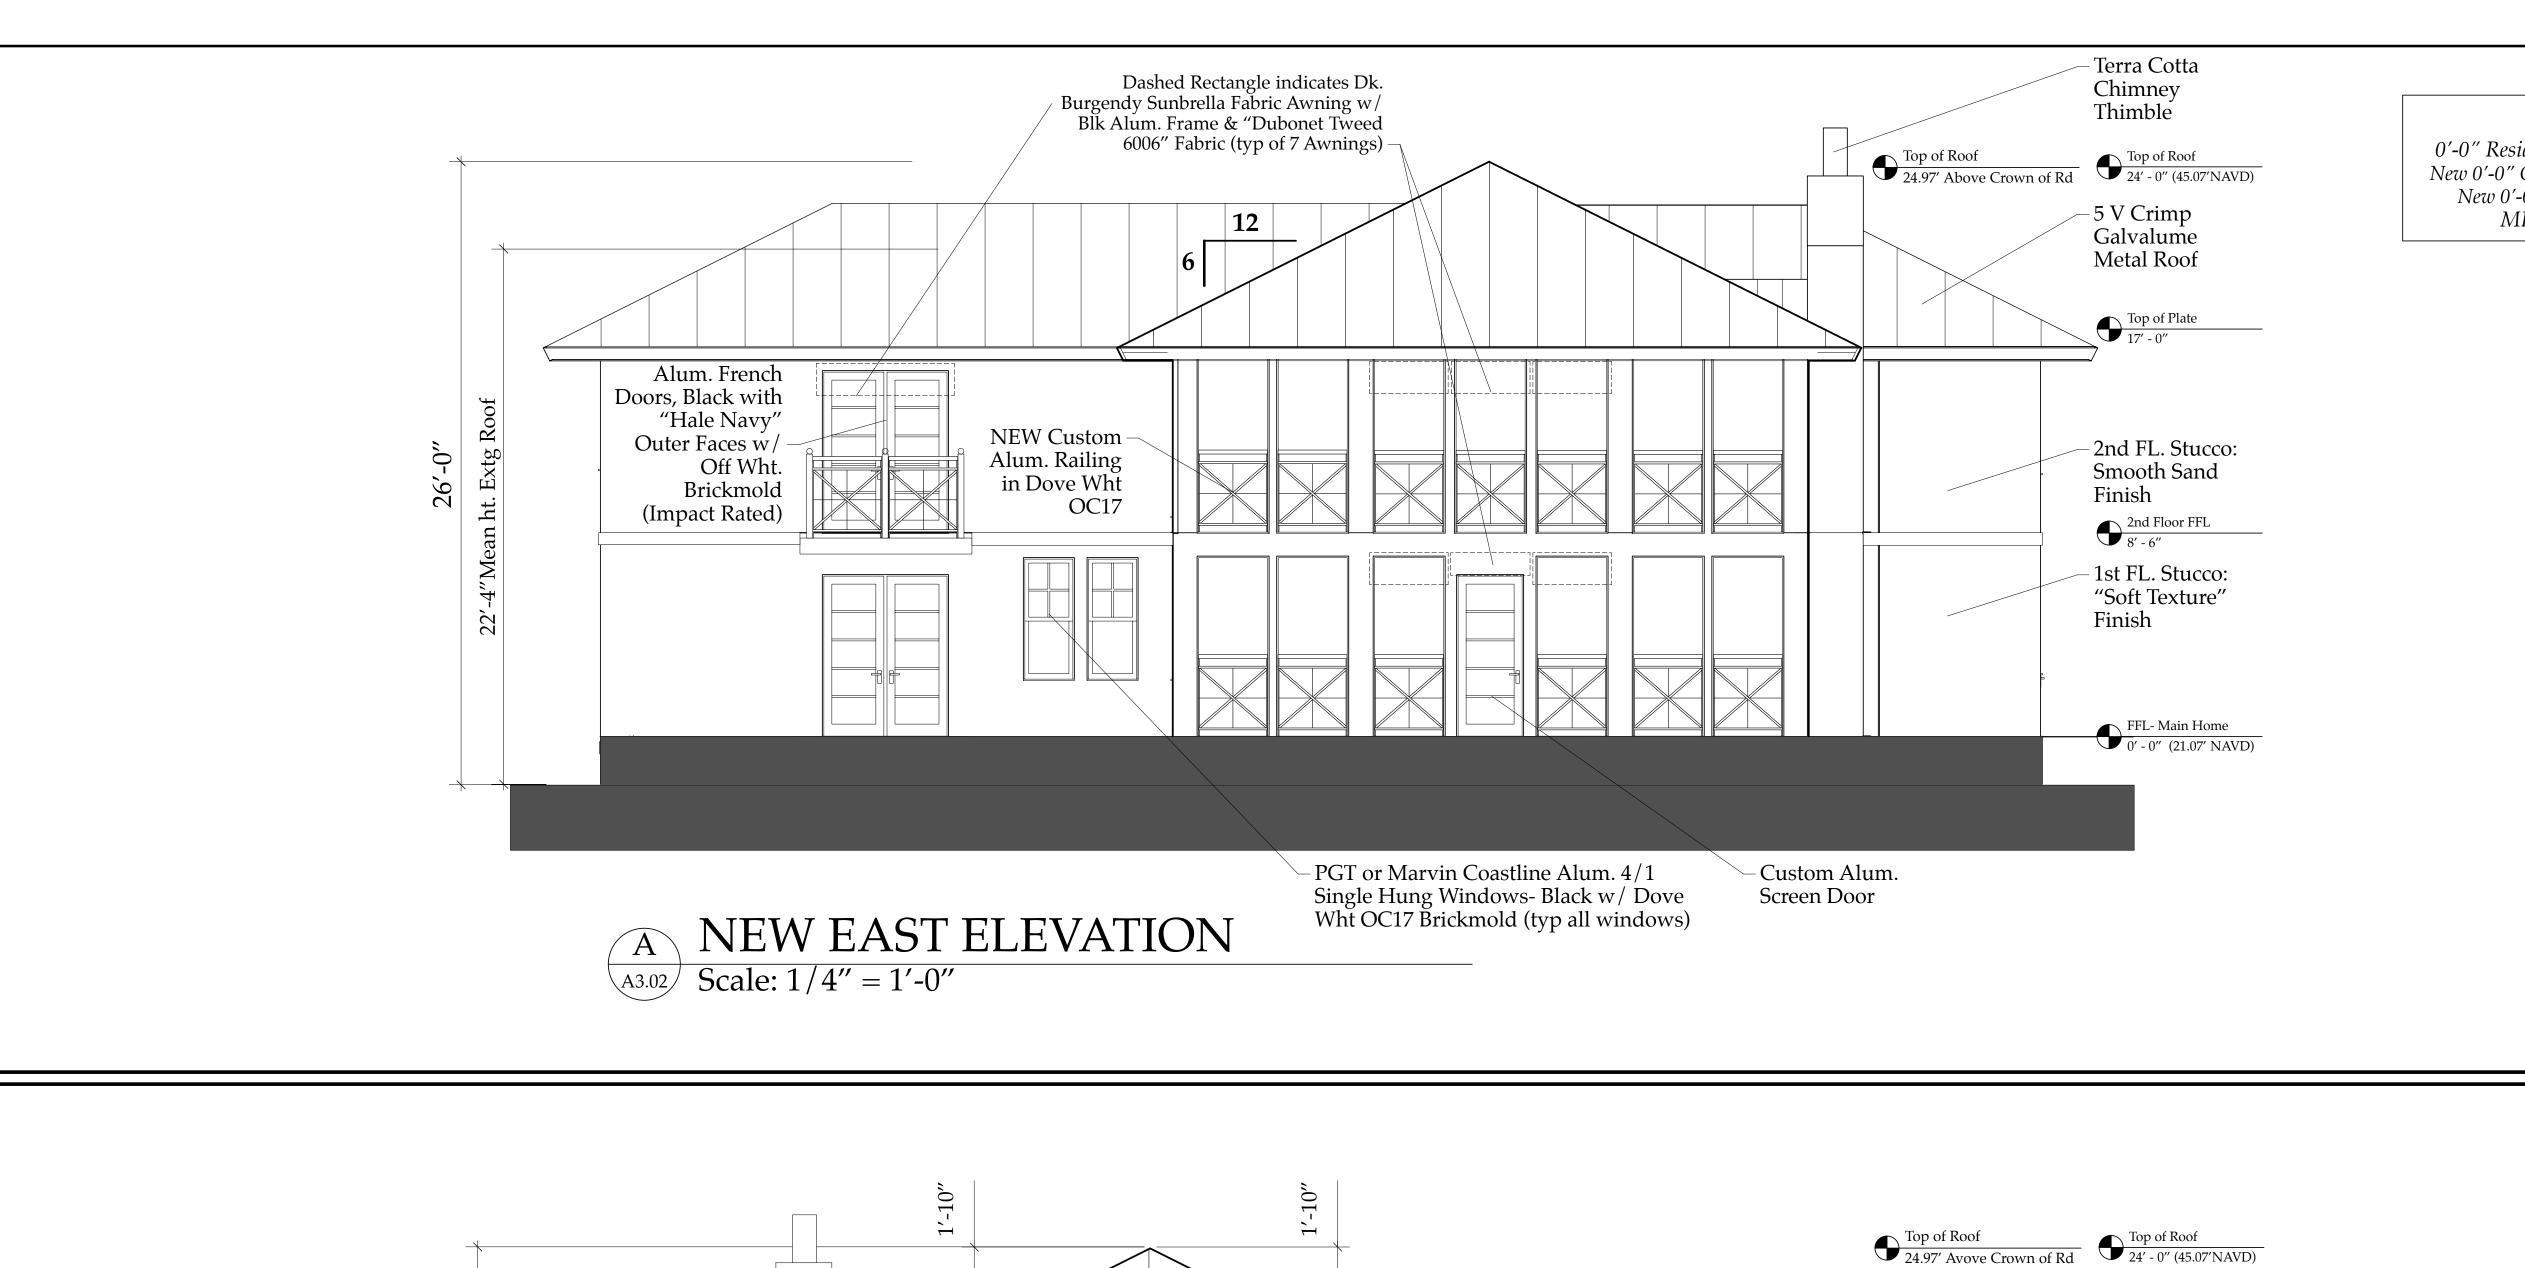


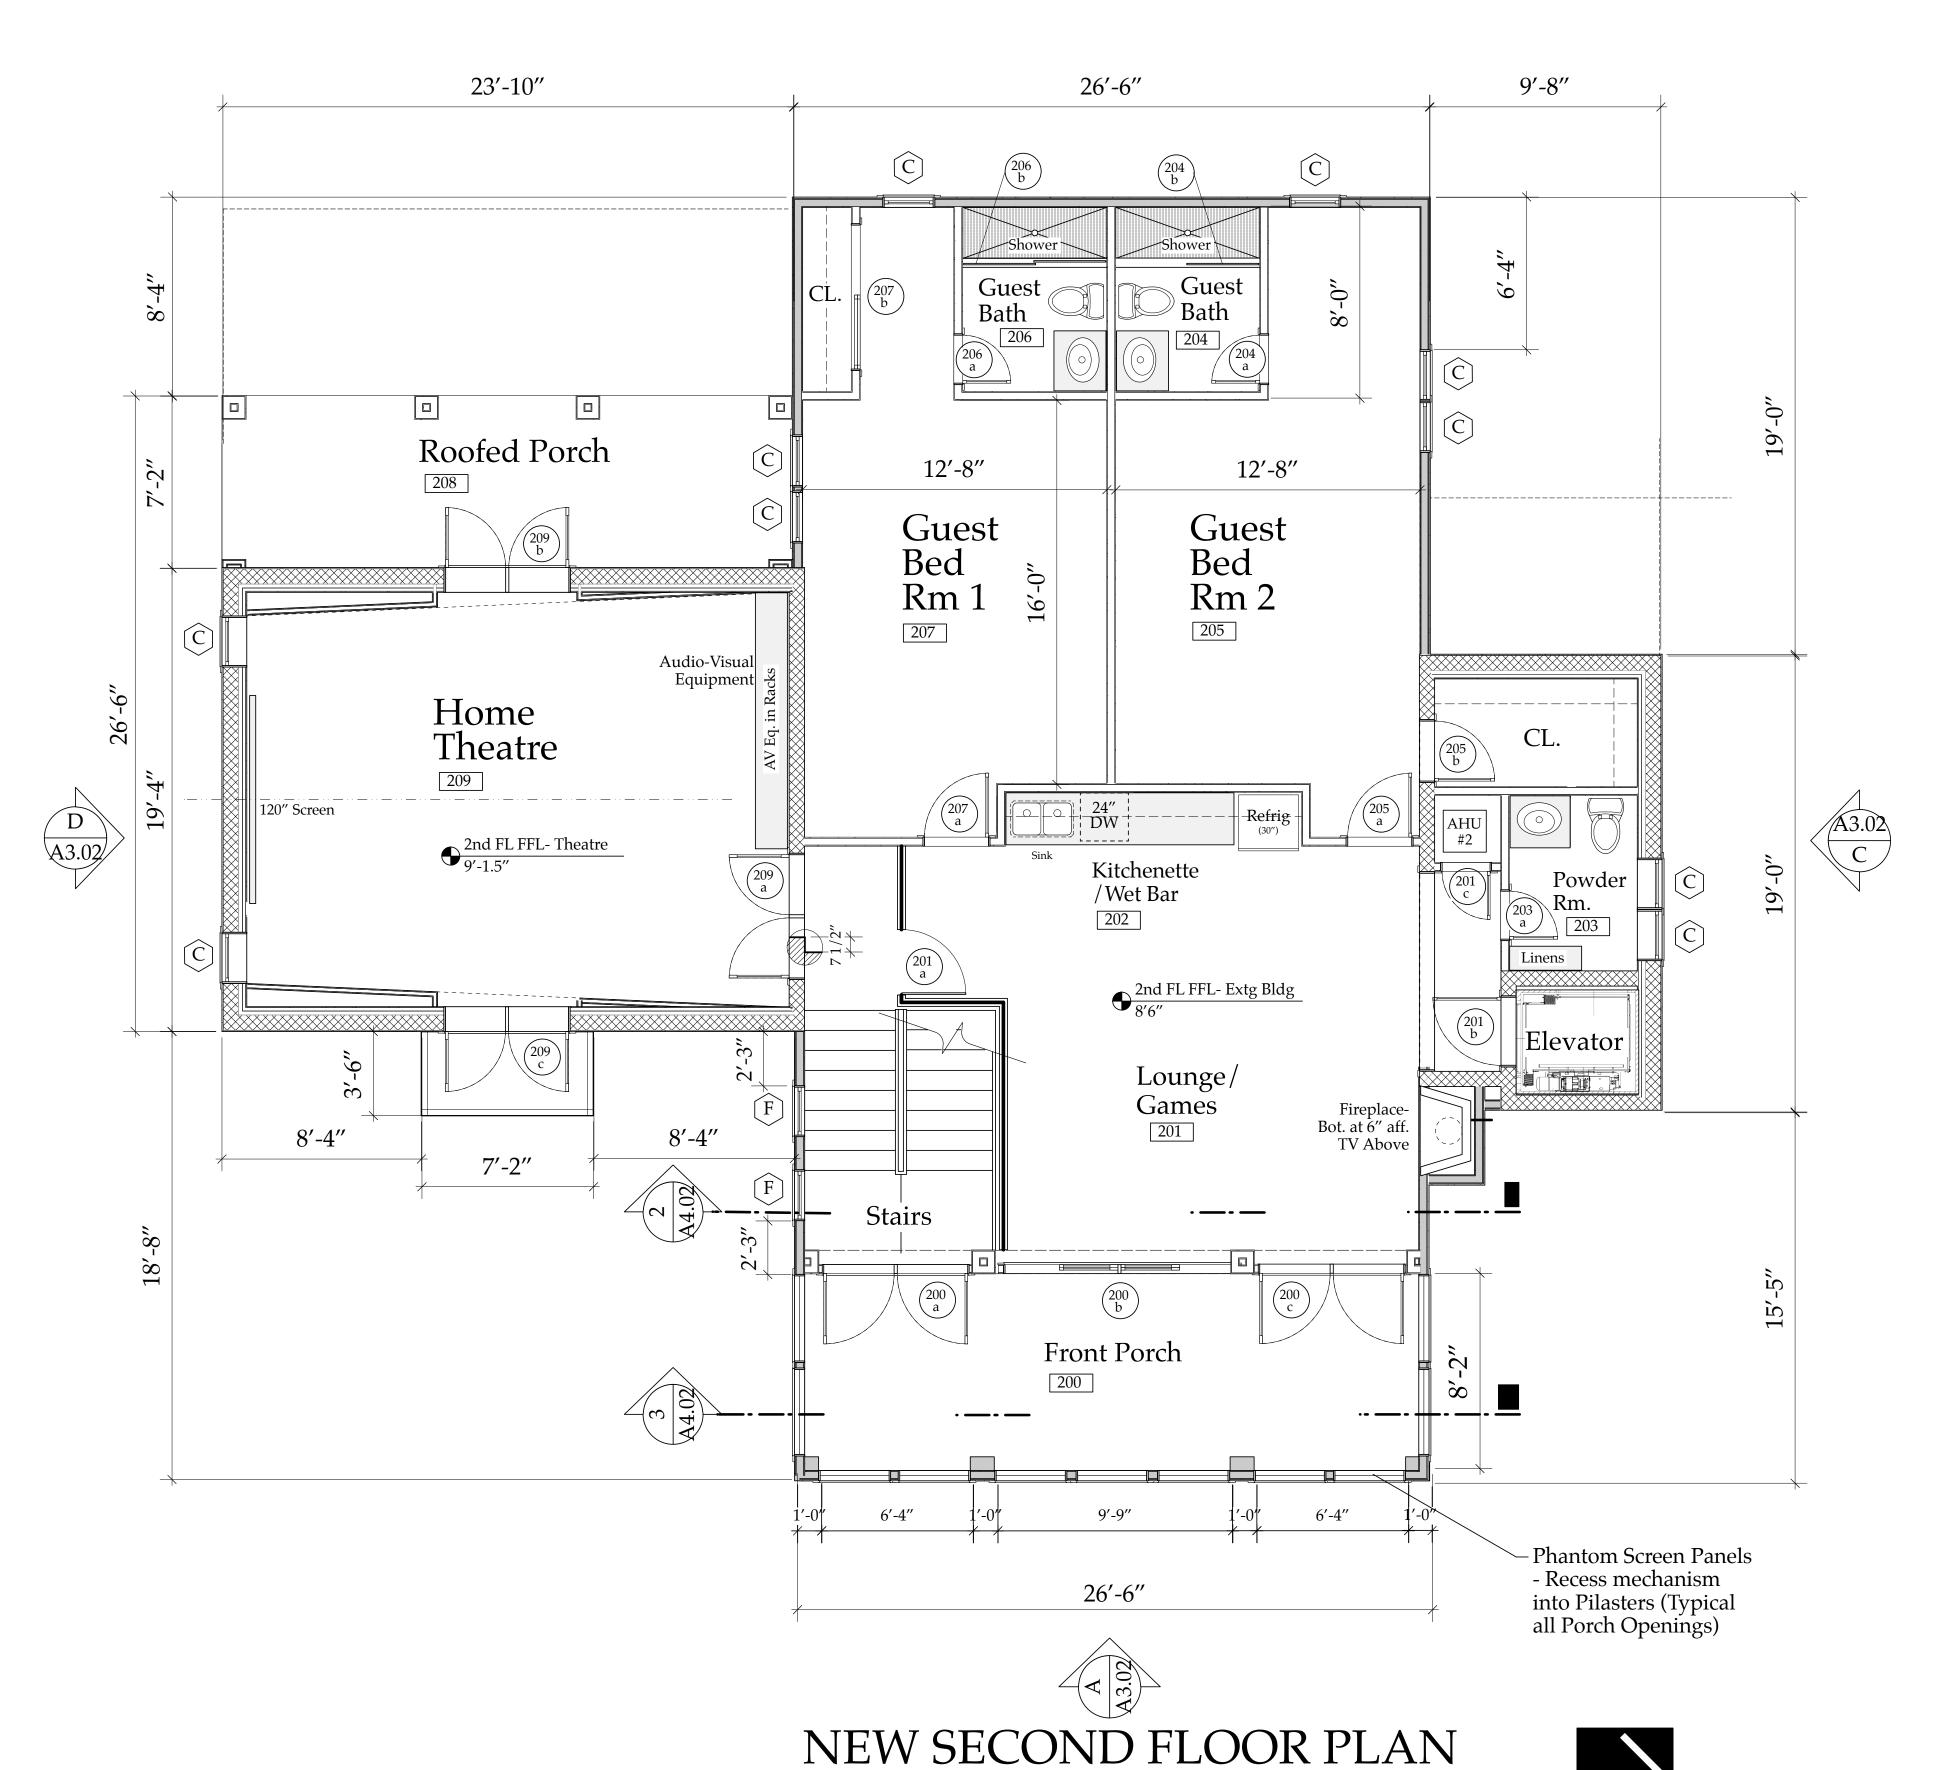Scale: 1/4'' = 1'-0''




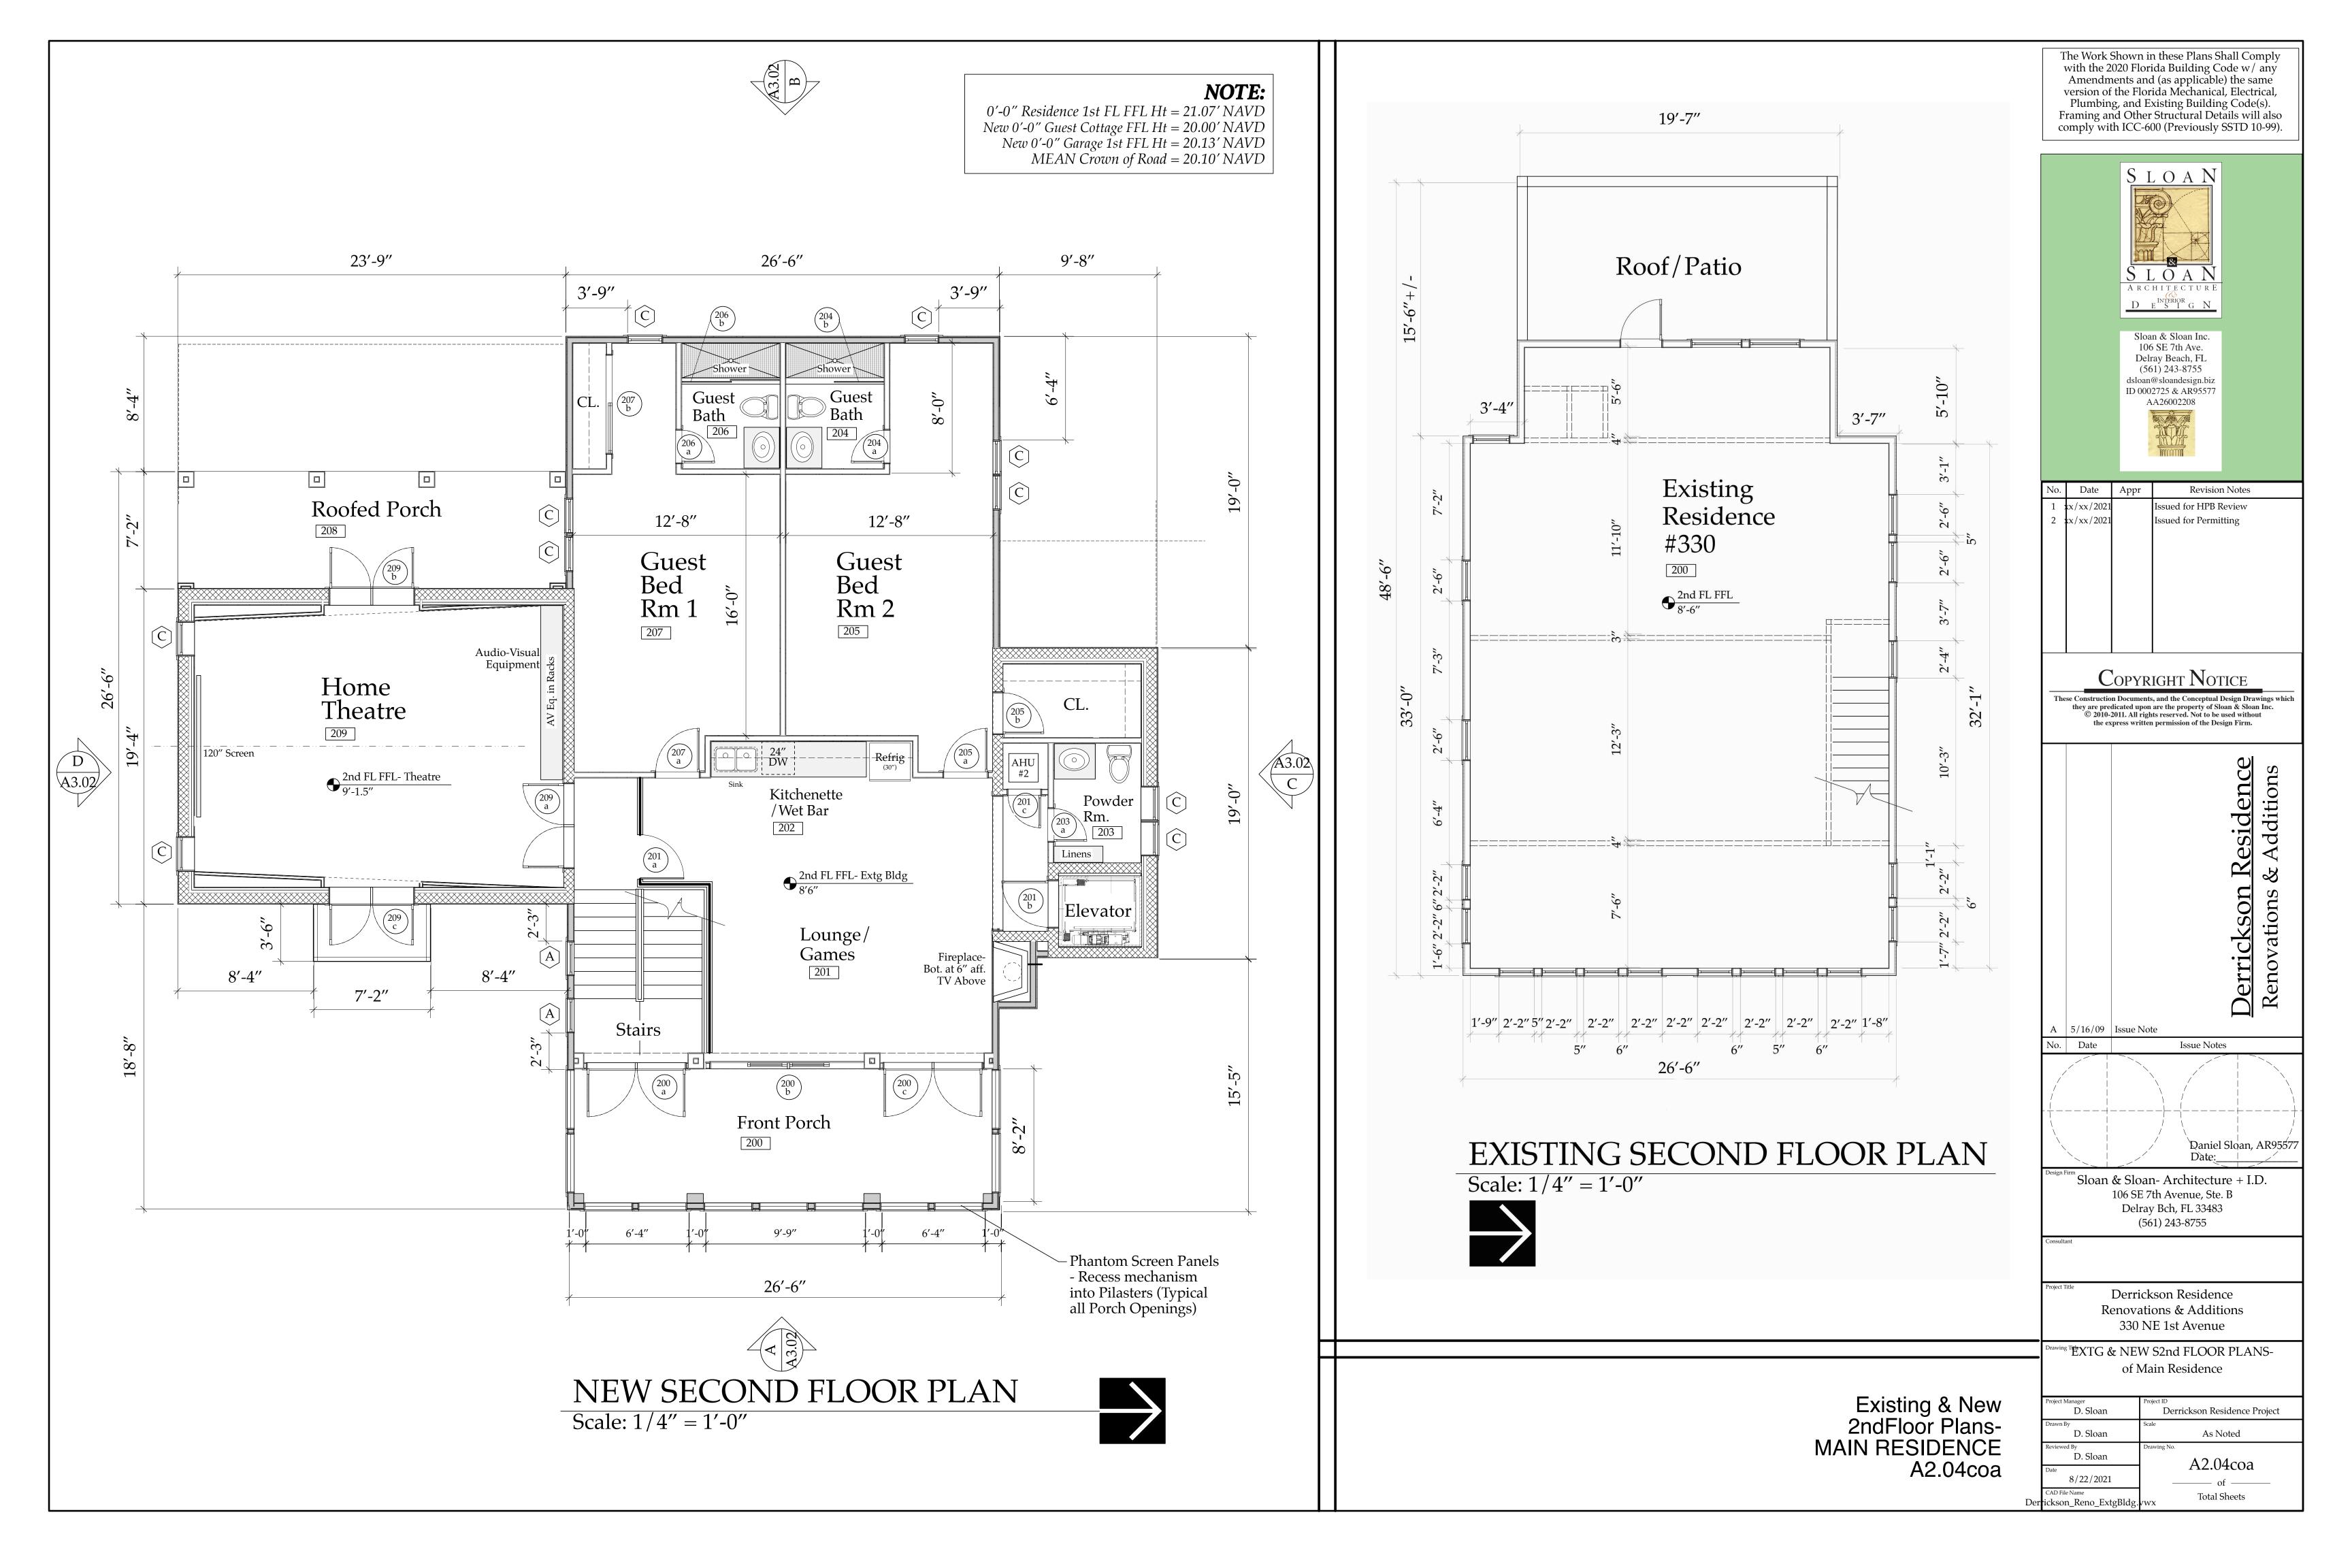

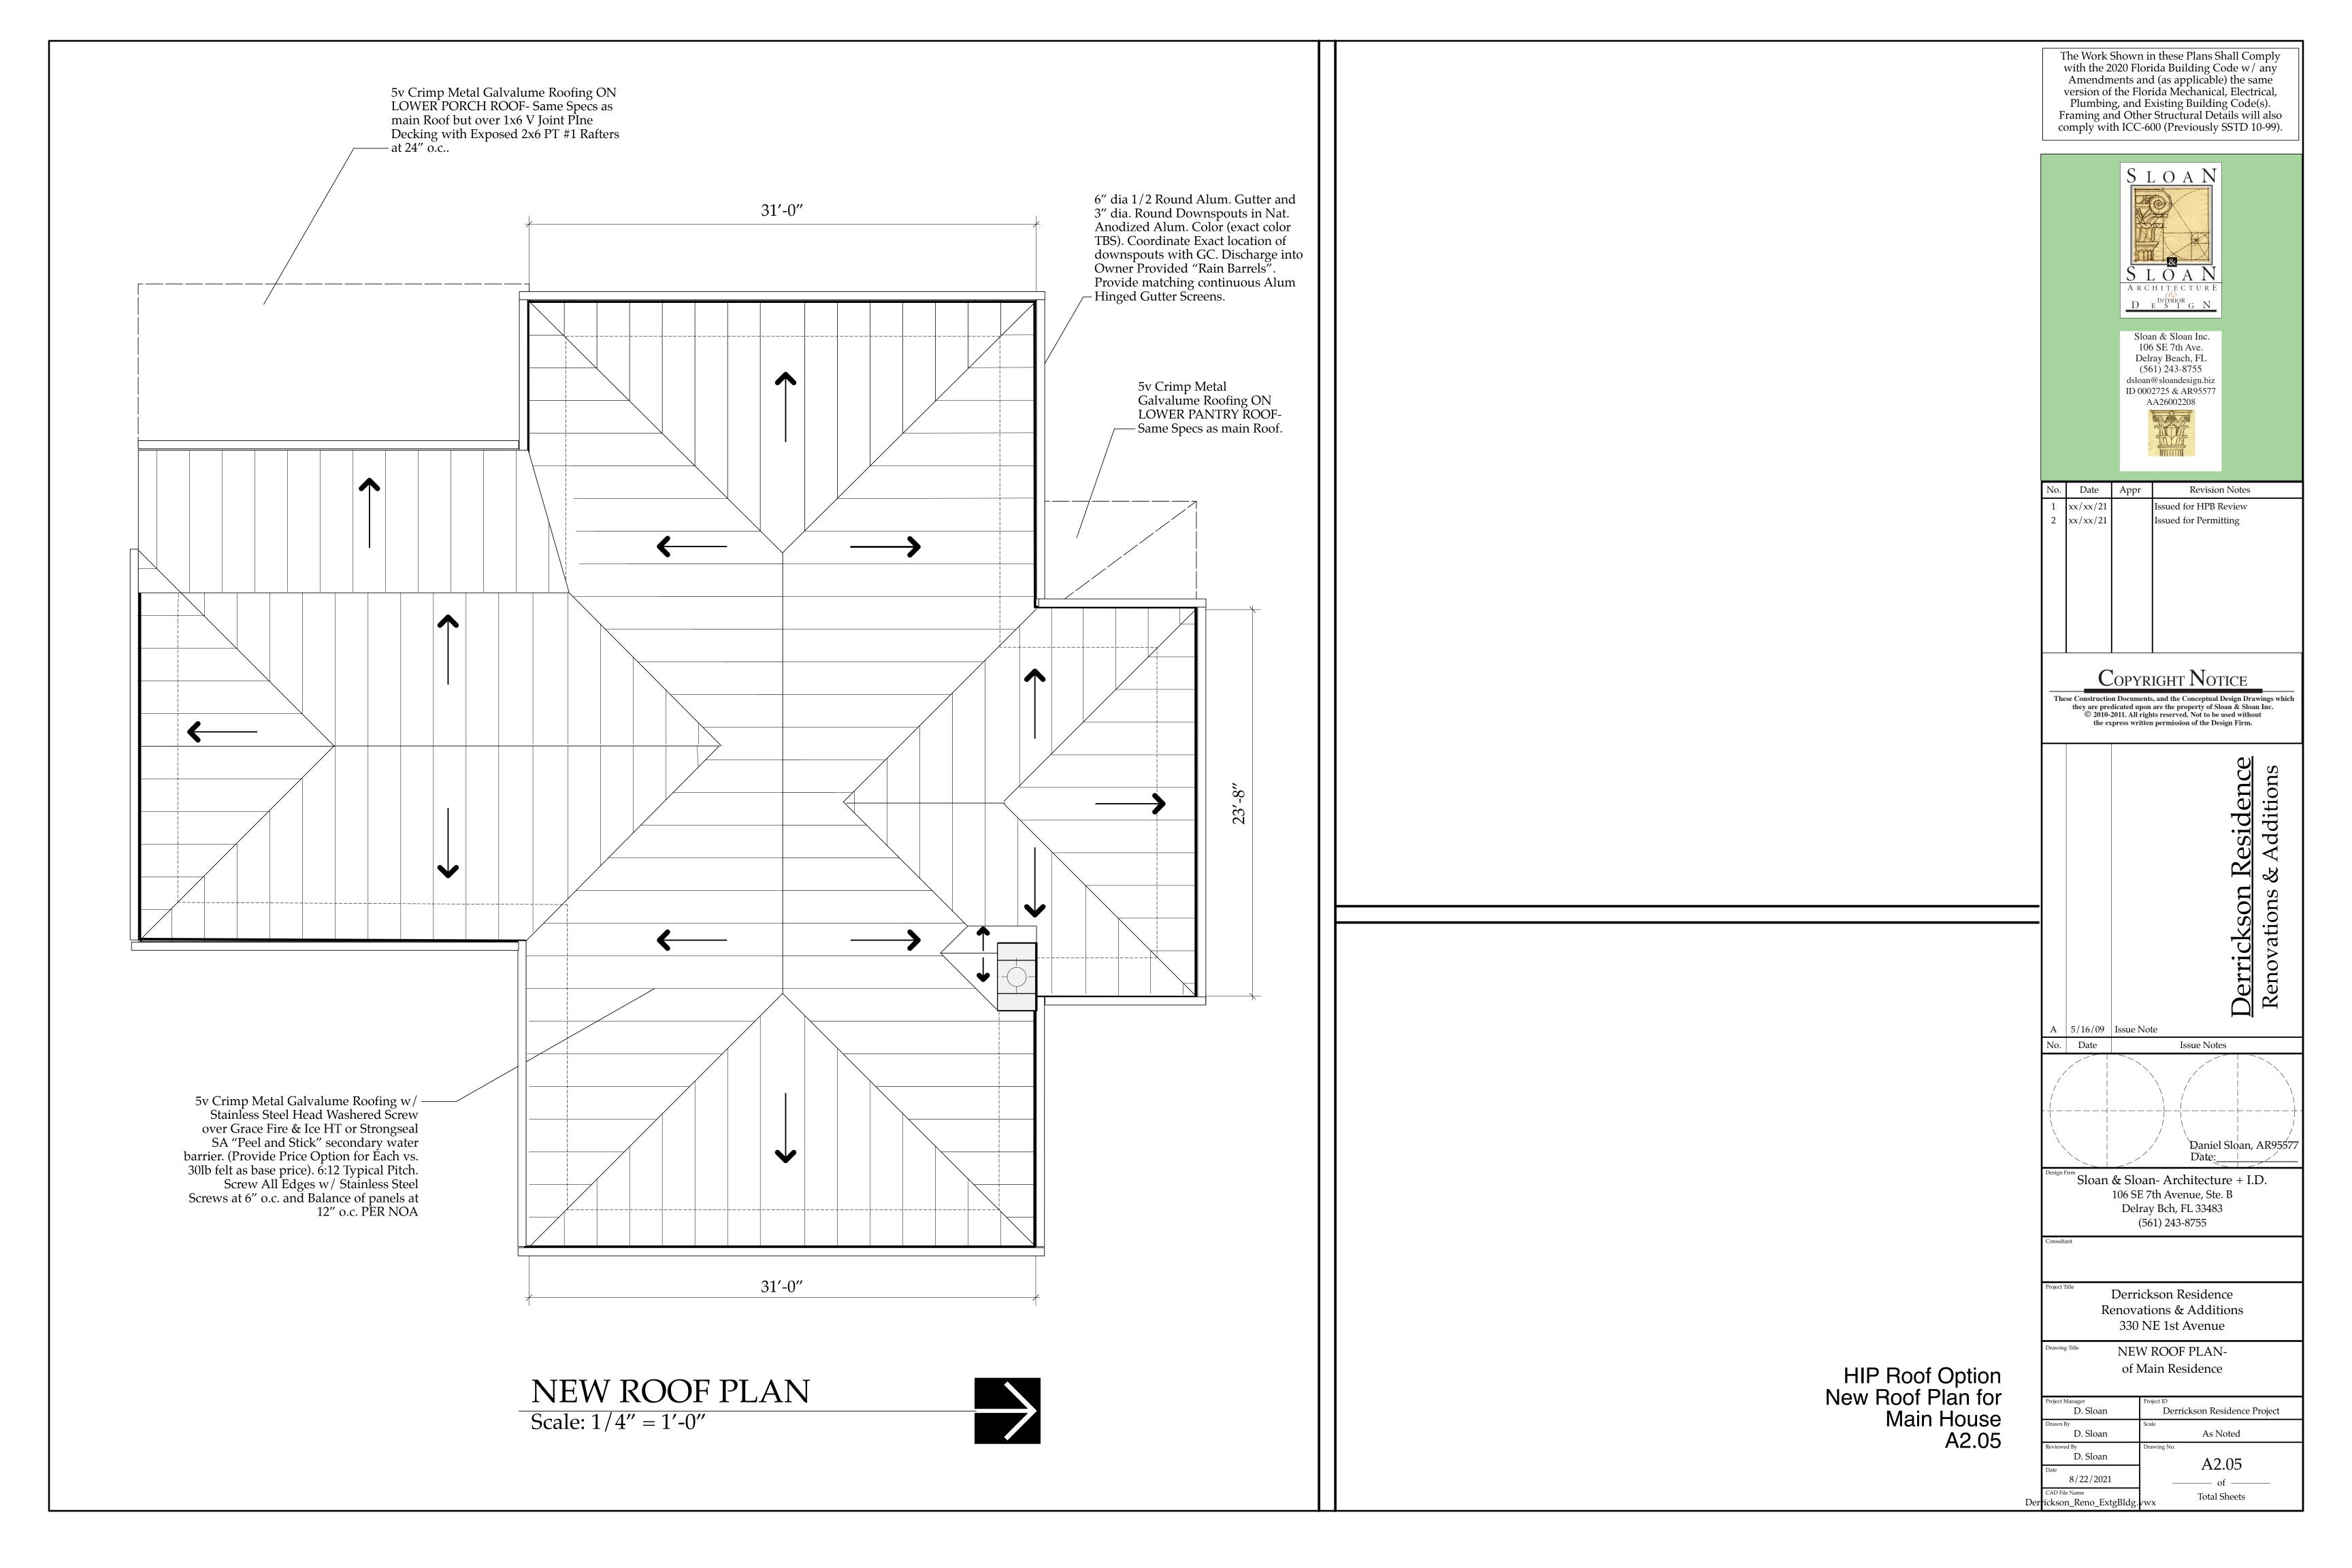



0'-0" Residence 1st FL FFL Ht = 21.07' NAVD New 0'-0" Guest Cottage FFL Ht = 20.00' NAVD New 0'-0" Garage 1st FFL Ht = 20.13' NAVD MEAN Crown of Road = 20.10' NAVD The Work Shown in these Plans Shall Comply with the 2020 Florida Building Code w/ any Amendments and (as applicable) the same version of the Florida Mechanical, Electrical, Plumbing, and Existing Building Code(s). Framing and Other Structural Details will also comply with ICC-600 (Previously SSTD 10-99).

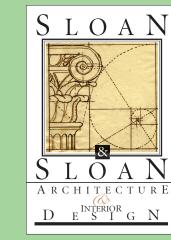

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B NEW WEST ELEVATION

A3.02 Scale: 1/4" = 1'-0"

NEW East & West Elevations-MAIN HOUSE Derrickson Reside
Renovations & Additi

A 5/16/09 Issue Note

No. Date Issue Notes

Qaniel Sloan, AR9557
Date:

Sloan & Sloan- Architecture + I.D.

106 SE 7th Avenue, Ste. B

Delray Bch, FL 33483

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Consultant

Derrickson Residence Renovations & Additions 330 NE 1st Avenue

of Main Residence

 Project Manager
 Project ID

 D. Sloan
 Derrickson Residence Project


 Drawn By
 Scale


 D. Sloan
 1/4" = 1'-0"


 Reviewed By
 Drawing No.

 Date
 A.3.02

 CAD File Name
 Total Sheets

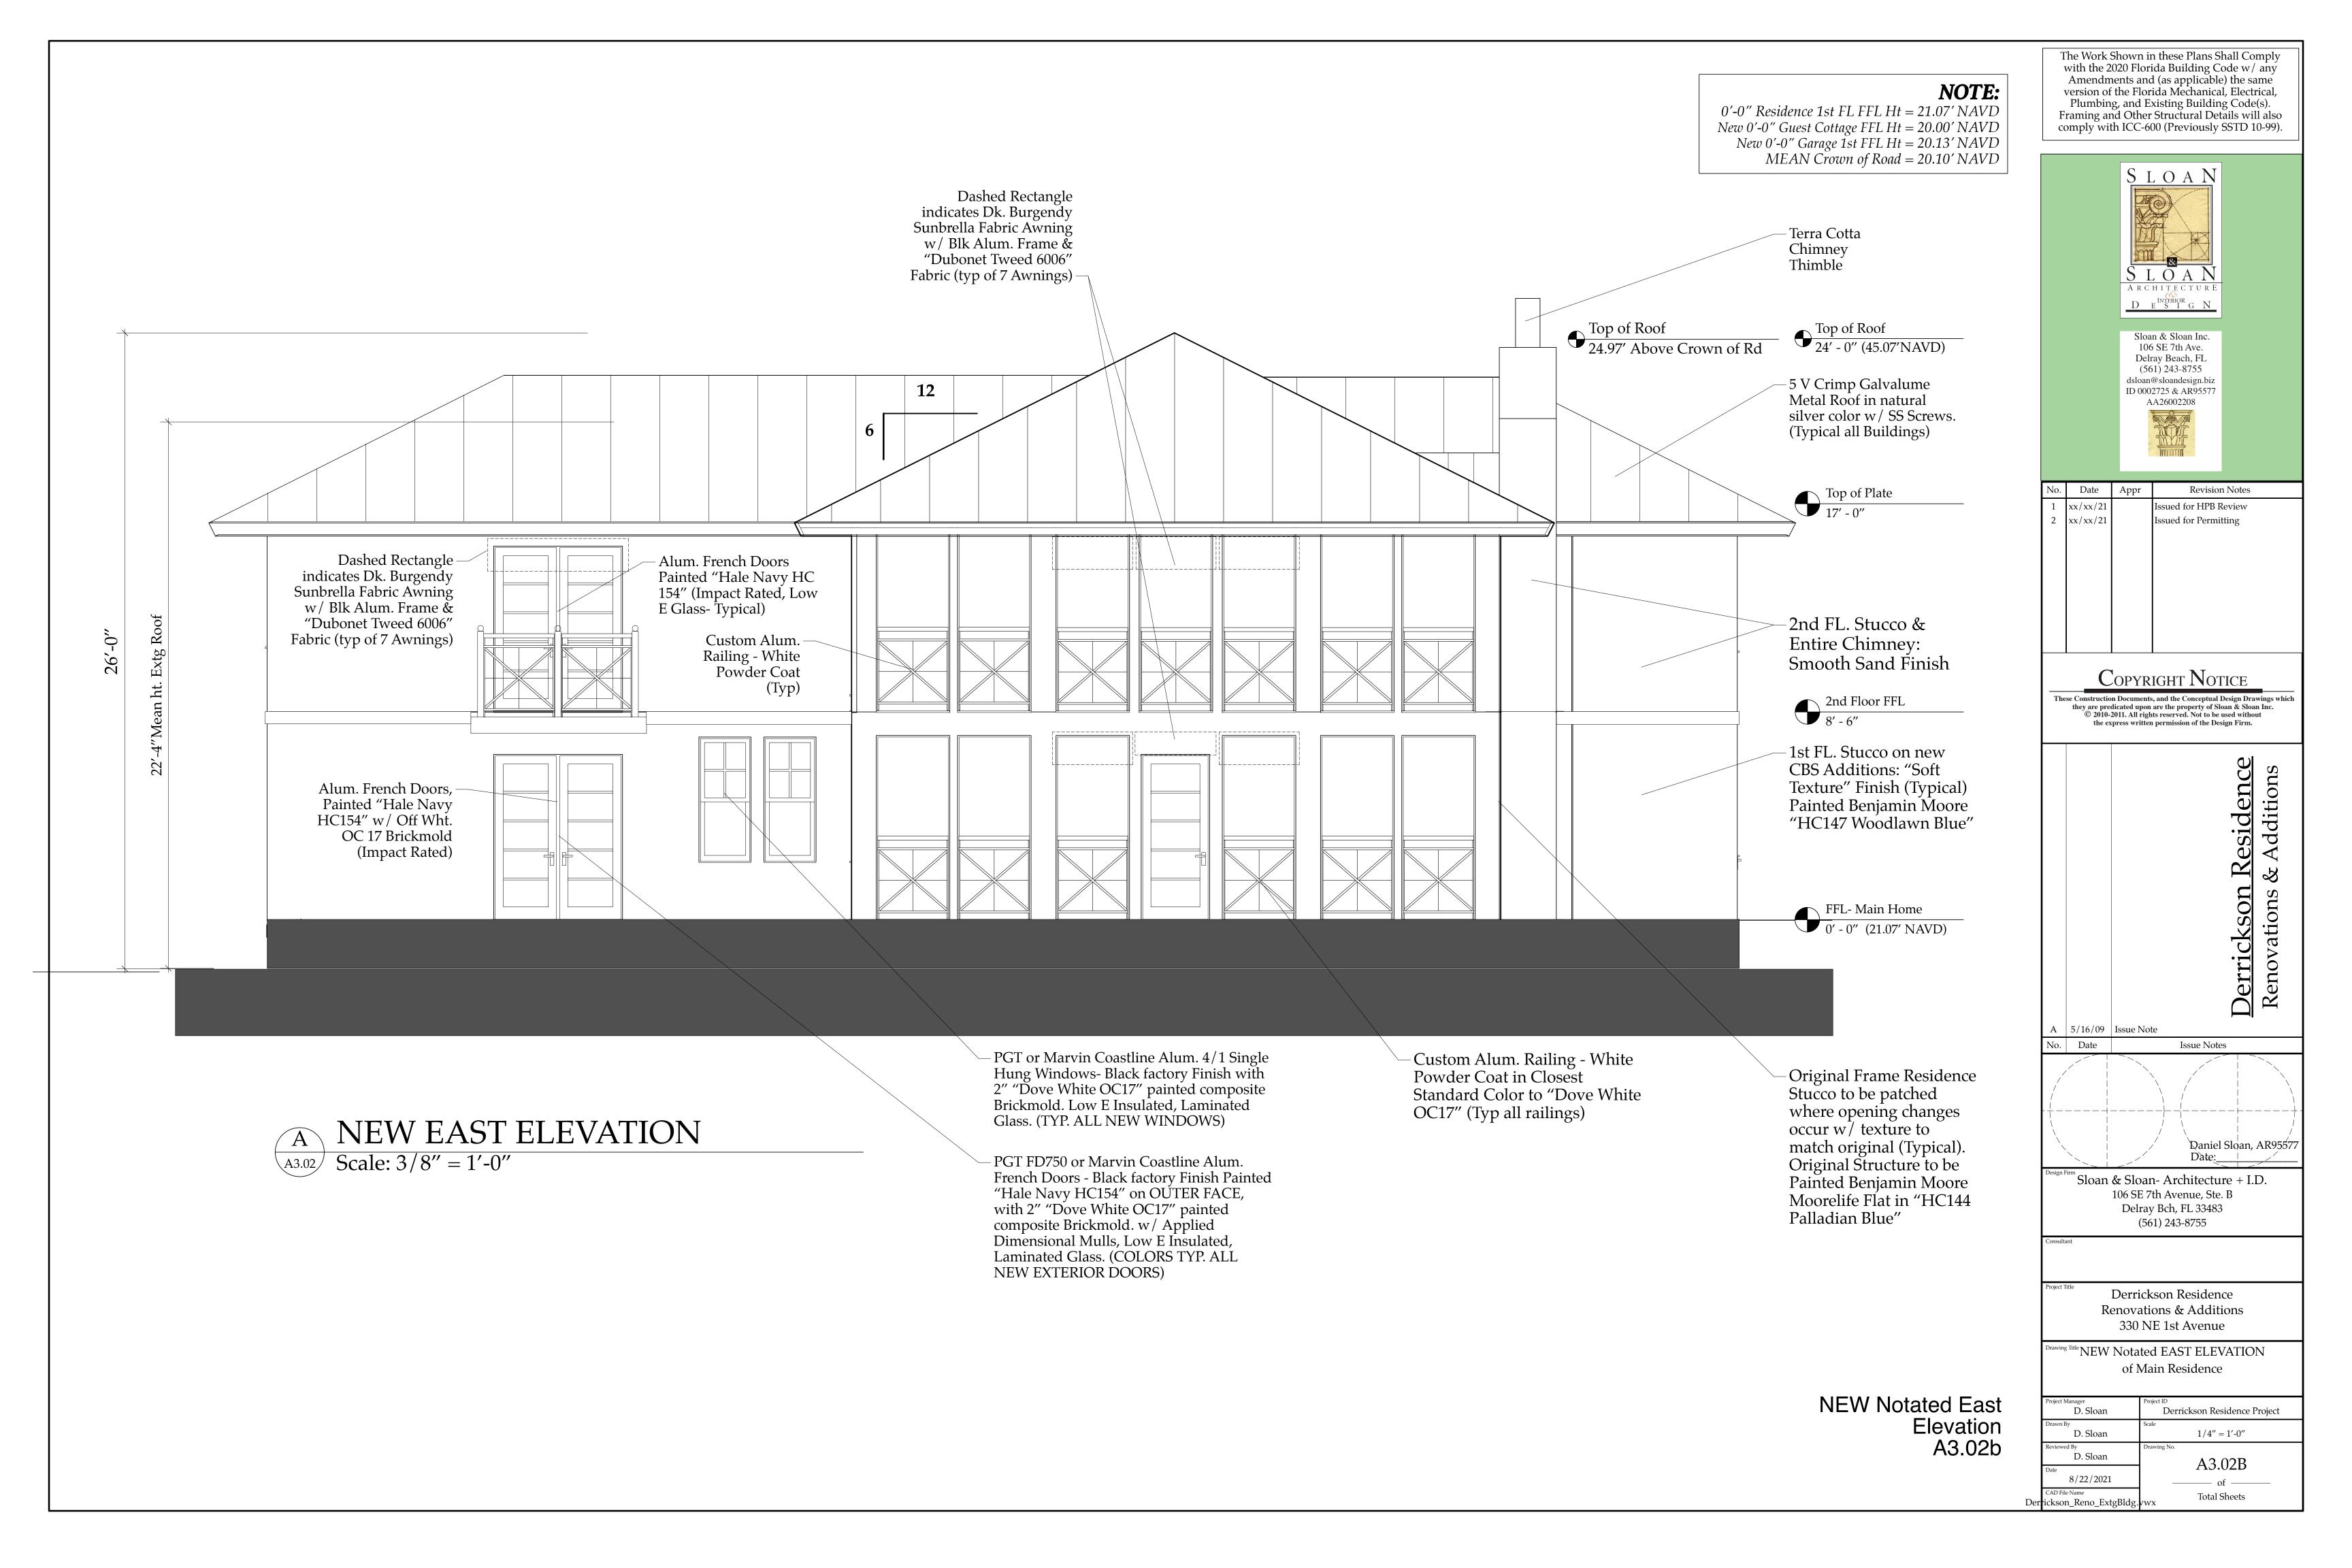


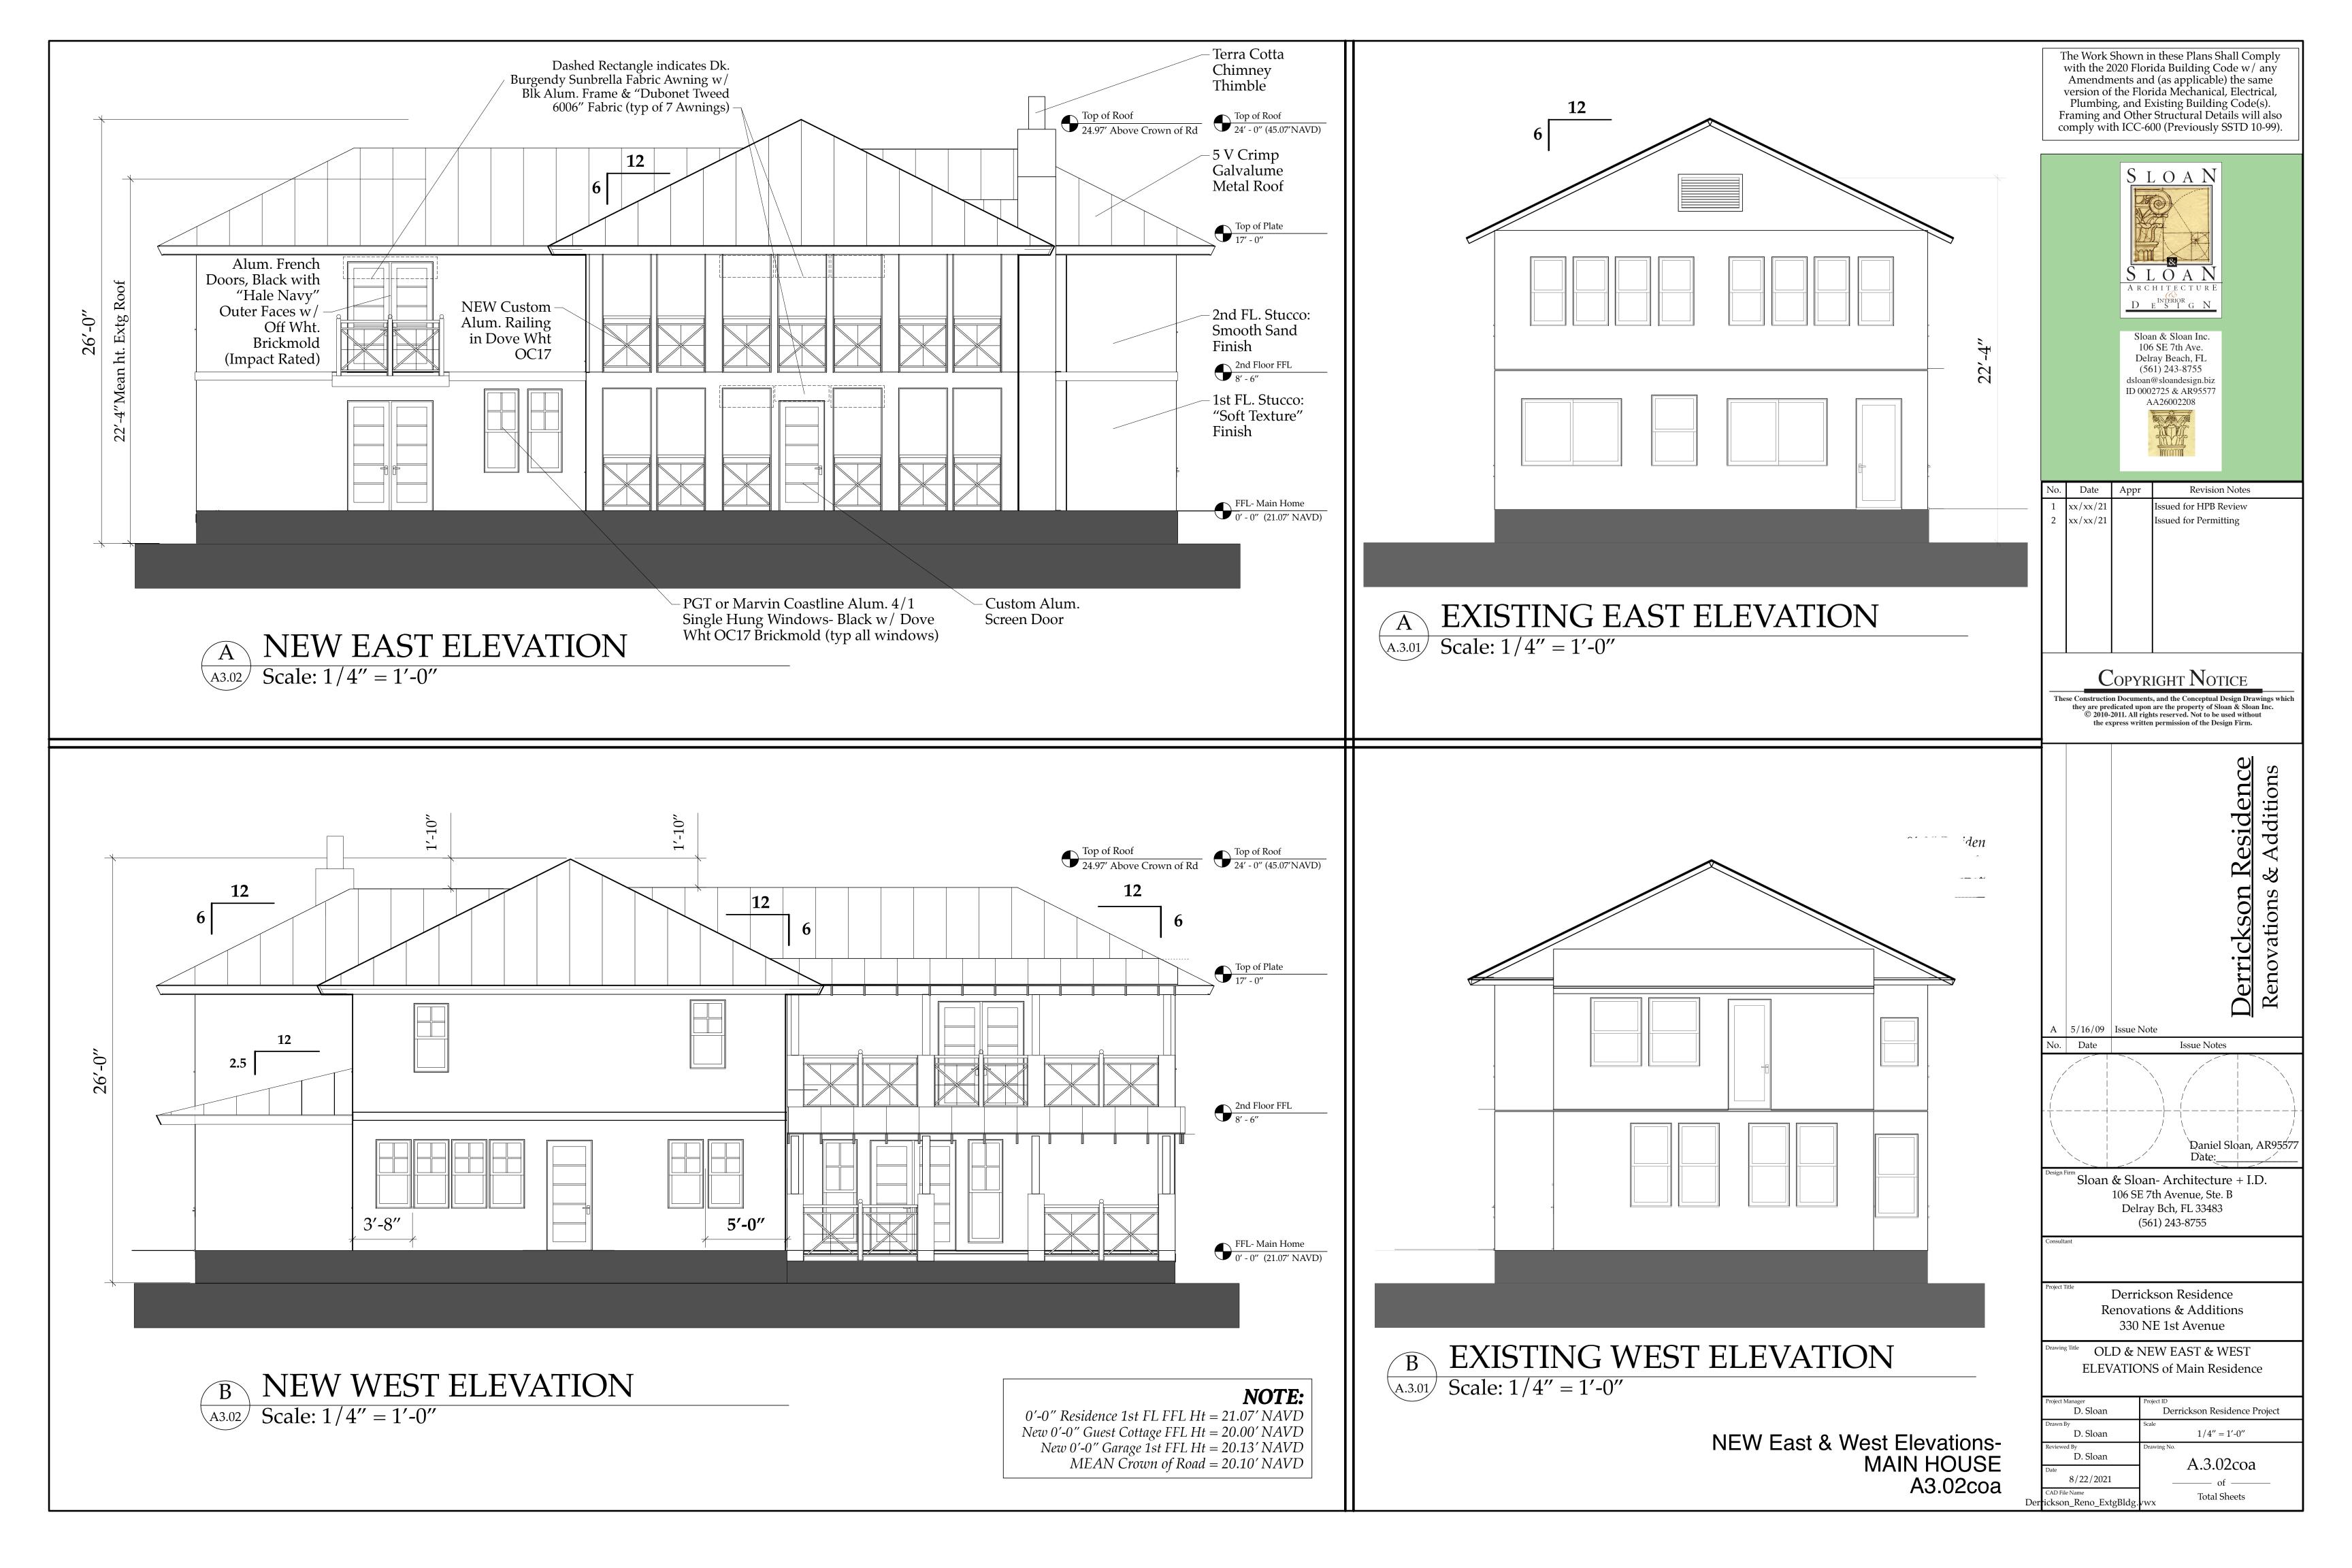

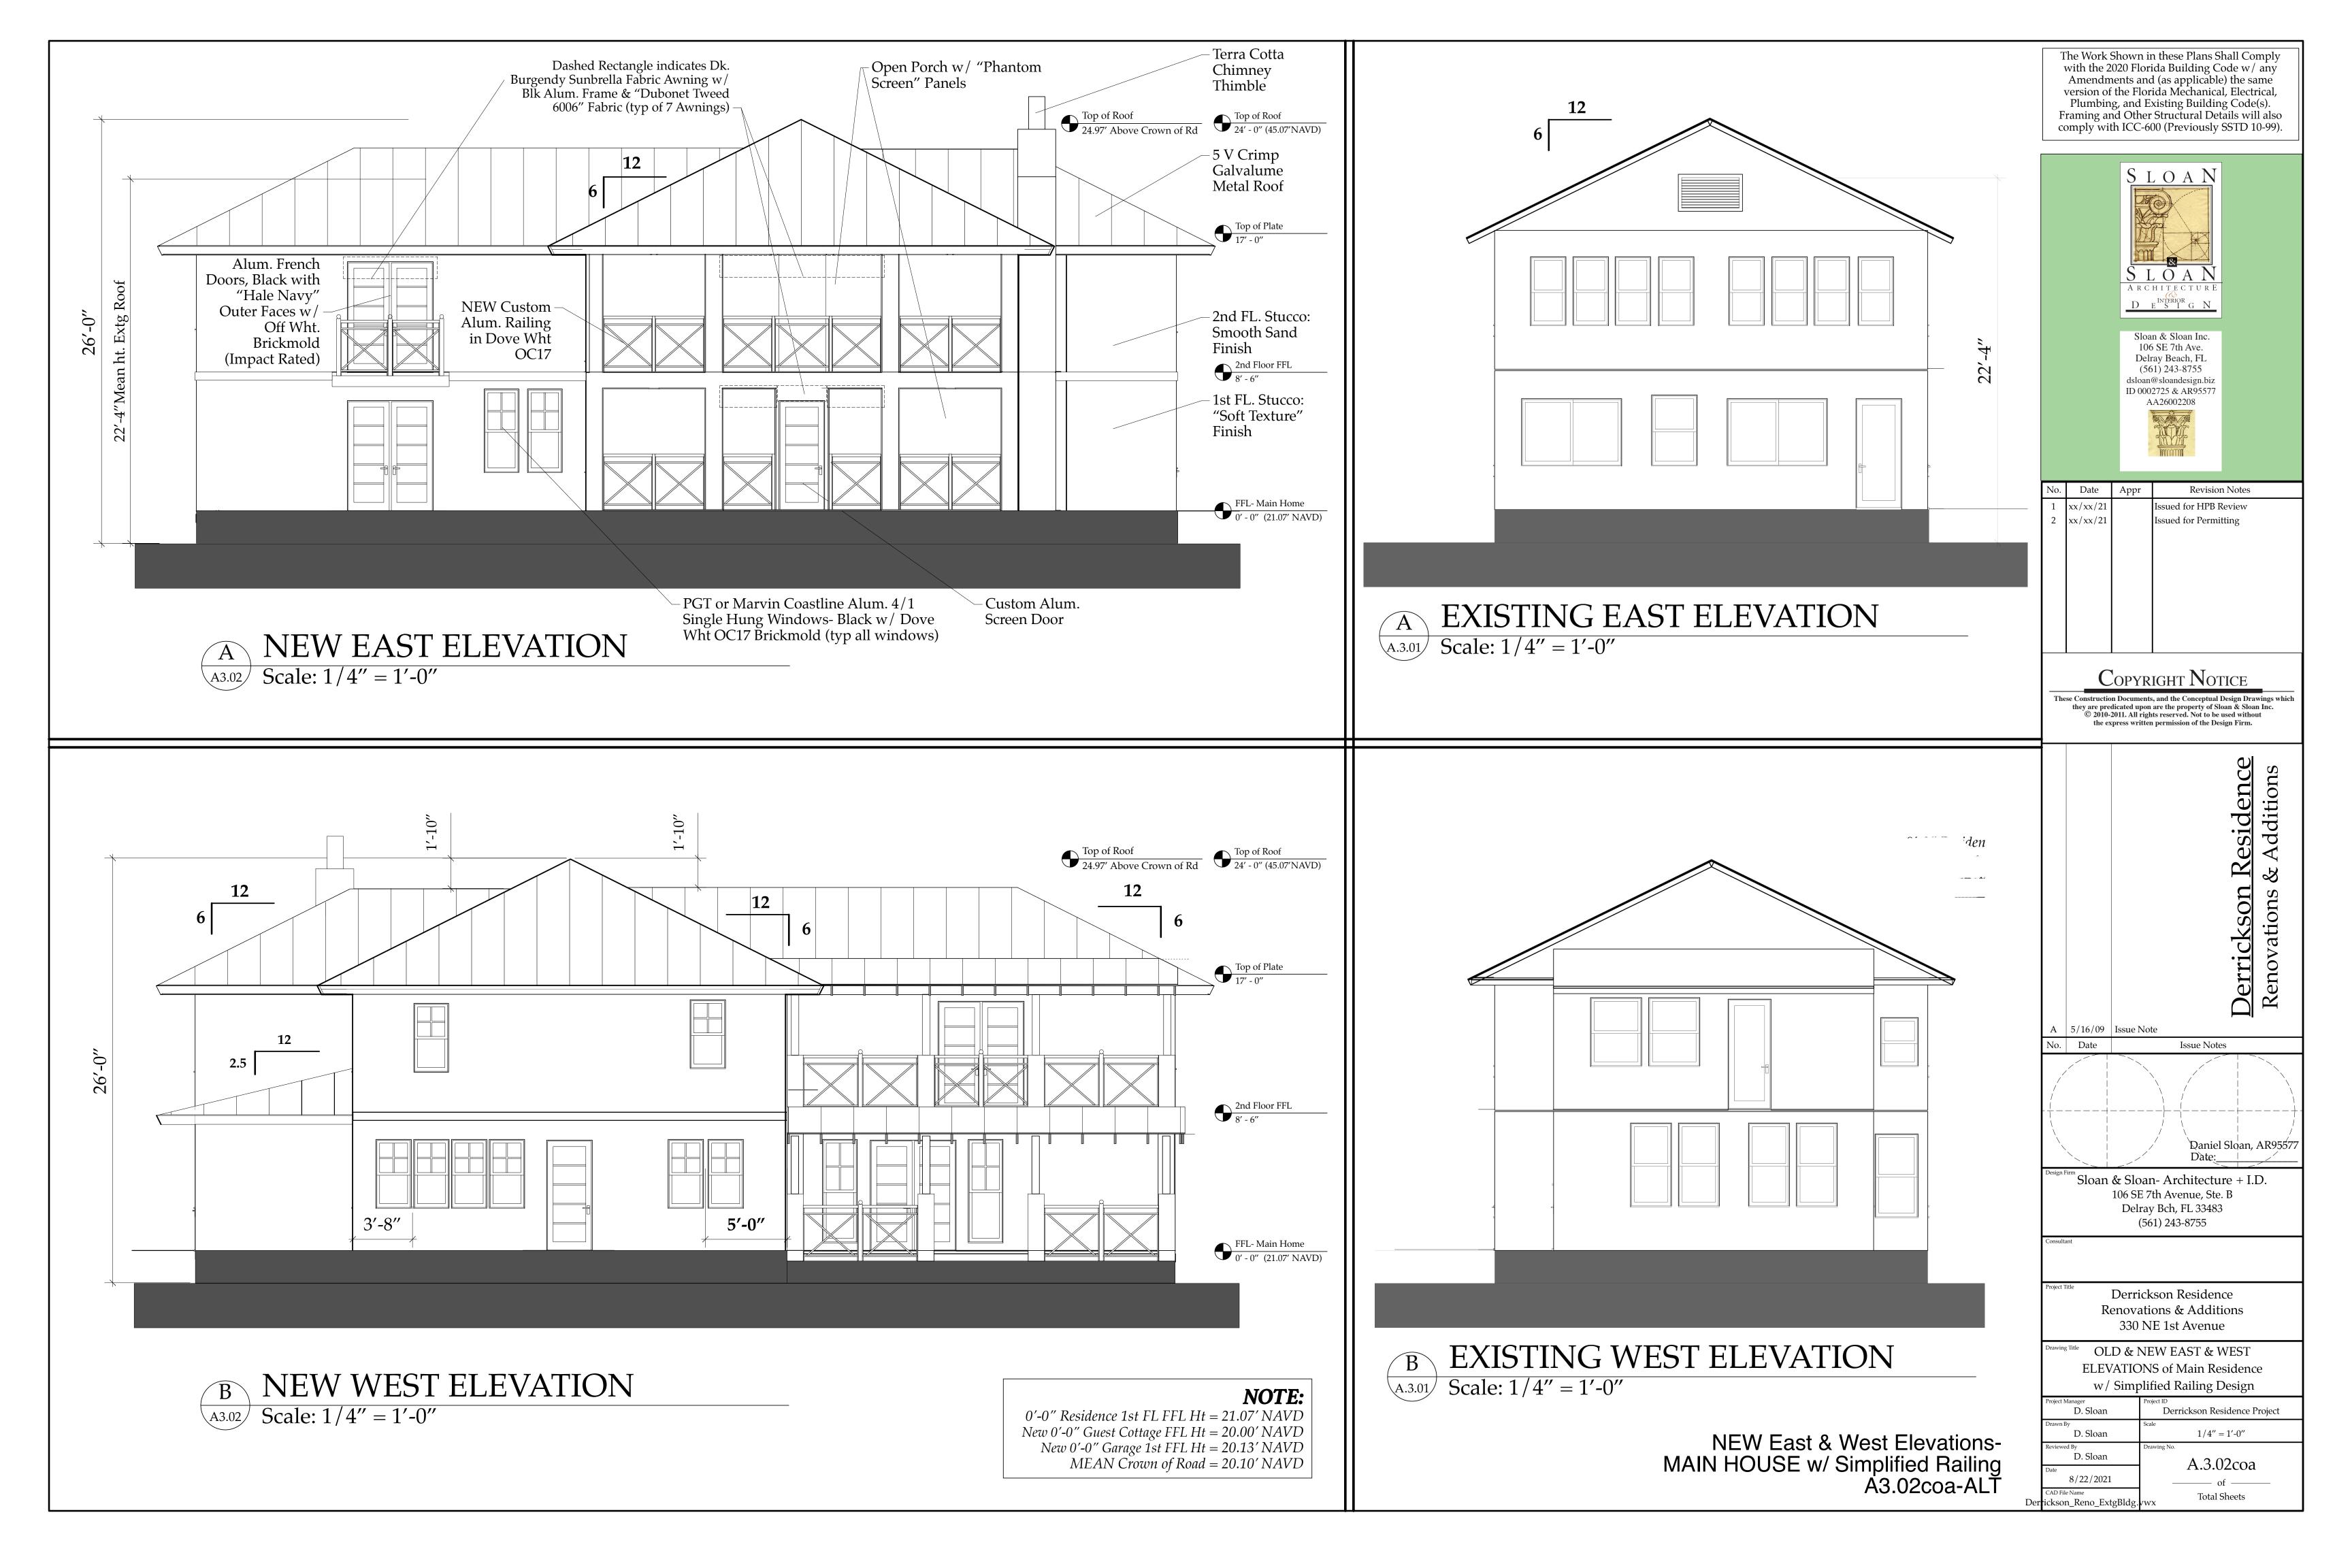



0'-0" Residence 1st FL FFL Ht = 21.07' NAVD New 0'-0" Guest Cottage FFL Ht = 20.00' NAVD New 0'-0" Garage 1st FFL Ht = 20.13' NAVD MEAN Crown of Road = 20.10' NAVD The Work Shown in these Plans Shall Comply with the 2020 Florida Building Code w/ any Amendments and (as applicable) the same version of the Florida Mechanical, Electrical, Plumbing, and Existing Building Code(s). Framing and Other Structural Details will also comply with ICC-600 (Previously SSTD 10-99).

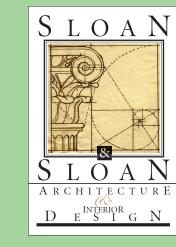

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NEW North & South Elevations-MAIN HOUSE A3.03


		Derrickson Res Renovations & Ad		
Α	5/16/09	Issue Note		
No.	Date	Issue Notes		
		Qaniel Sloan, AR95577 Date:		
Sloan & Sloan- Architecture + I.D. 106 SE 7th Avenue, Ste. B Delray Bch, FL 33483 (561) 243-8755				

Renovations & Additions 330 NE 1st Avenue

Derrickson Residence

NEW NORTH & SOUTH **ELEVATIONS of Main Residence**

oject Manager D. Sloan Derrickson Residence Project D. Sloan 1/4'' = 1'-0''D. Sloan A.3.03 8/22/2021 **Total Sheets**

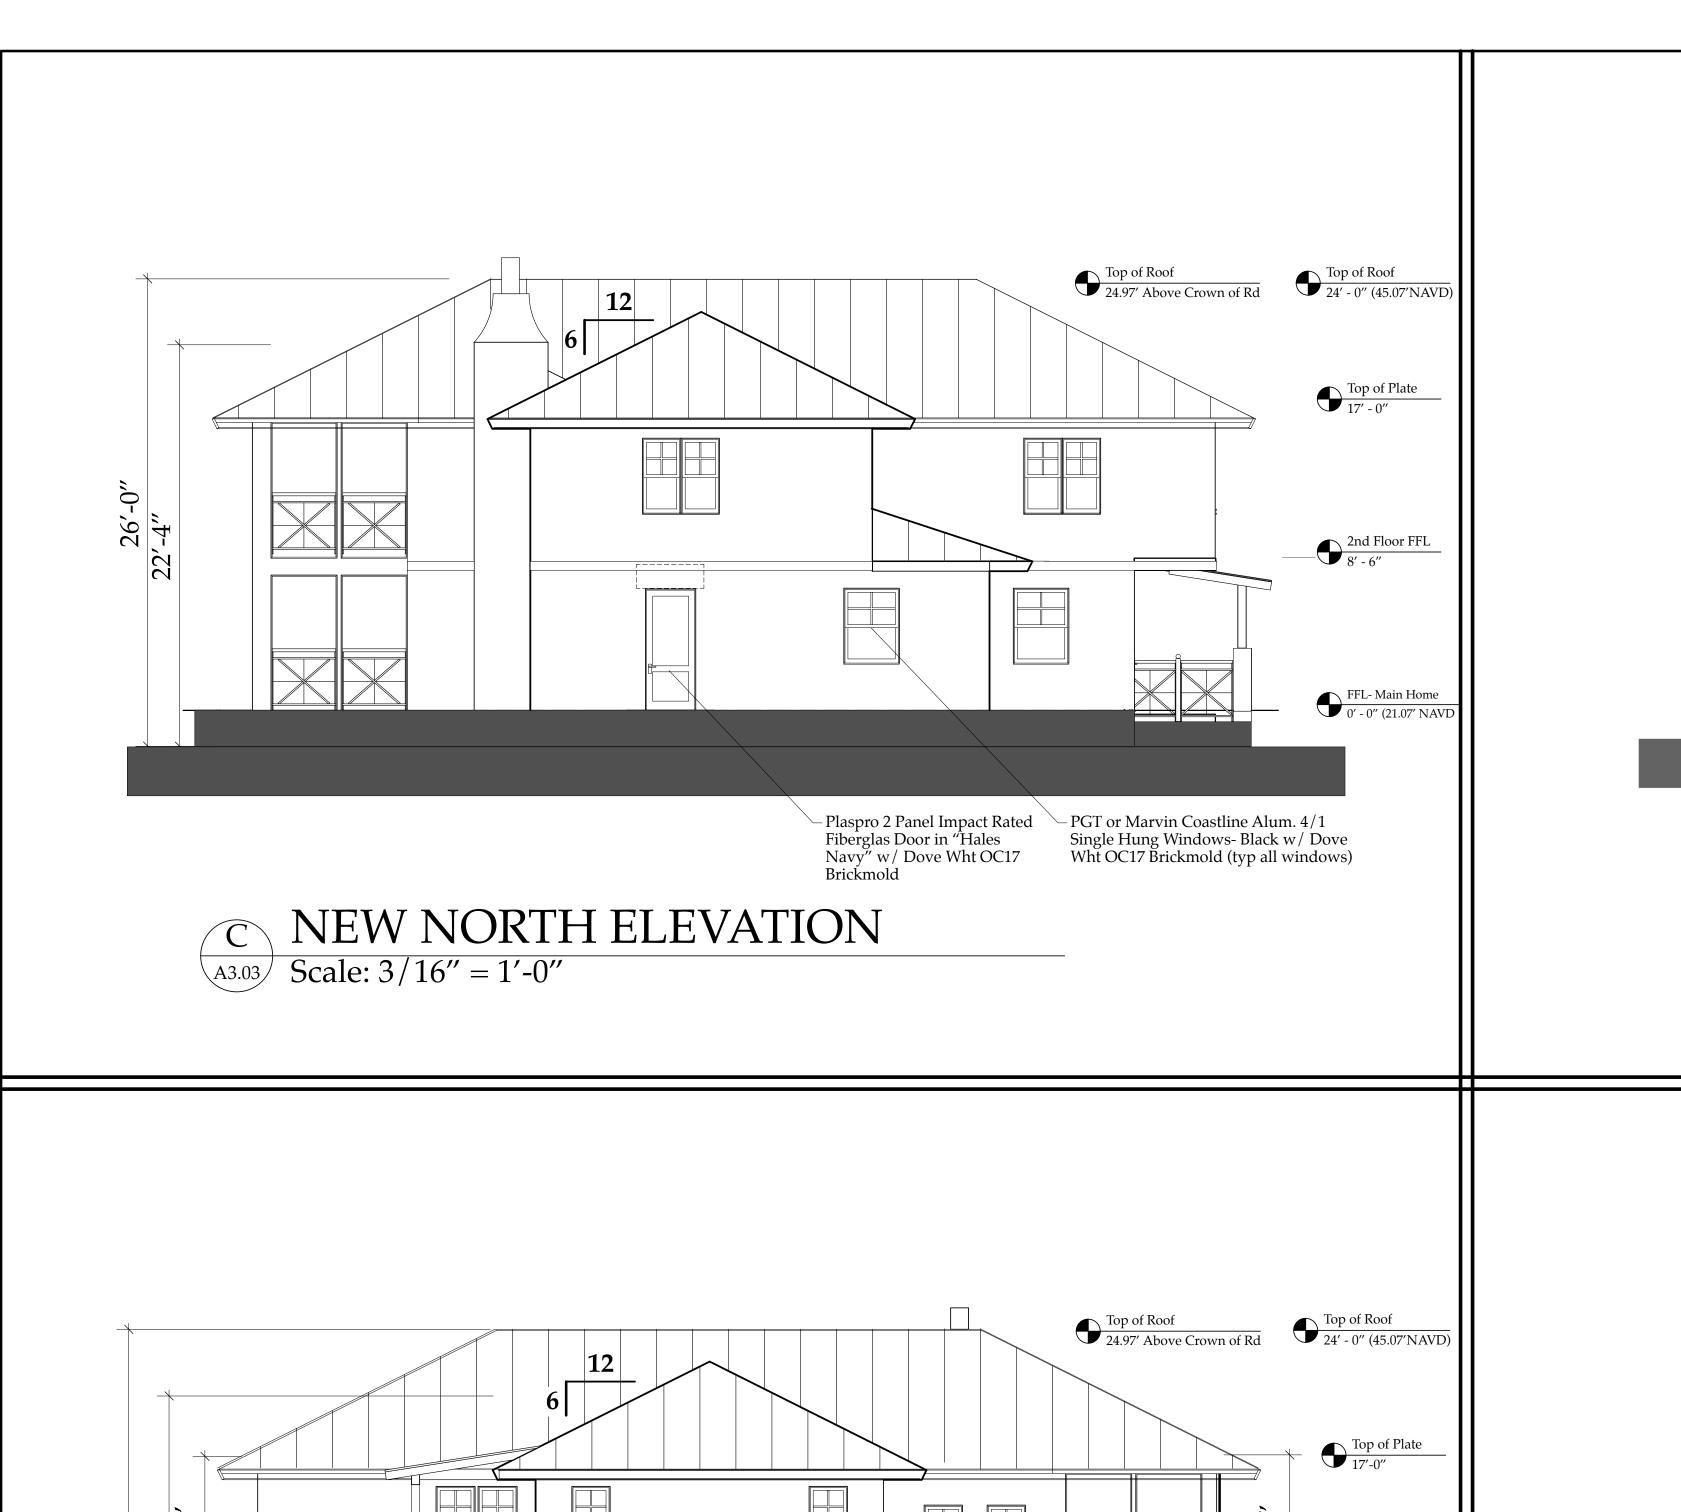


New 0'-0" Guest Cottage FFL Ht = 20.00' NAVD New 0'-0" Garage 1st FFL Ht = 20.13' NAVD MEAN Crown of Road = 19.36' NAVD

EXISTING NORTH ELEVATION C EXISTING N
A.3.01 Scale: 3/16"= 1'-0"

The Work Shown in these Plans Shall Comply with the 2020 Florida Building Code w/ any Amendments and (as applicable) the same version of the Florida Mechanical, Electrical, Plumbing, and Existing Building Code(s). Framing and Other Structural Details will also comply with ICC-600 (Previously SSTD 10-99).

NOTE:

0'-0'' Residence 1st FL FFL Ht = 21.07' NAVD

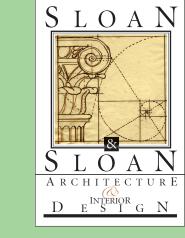


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D NEW SOUTH ELEVATION

A3.03 Scale: 3/16" = 1'-0"



D EXISTING SOUTH ELEVATION

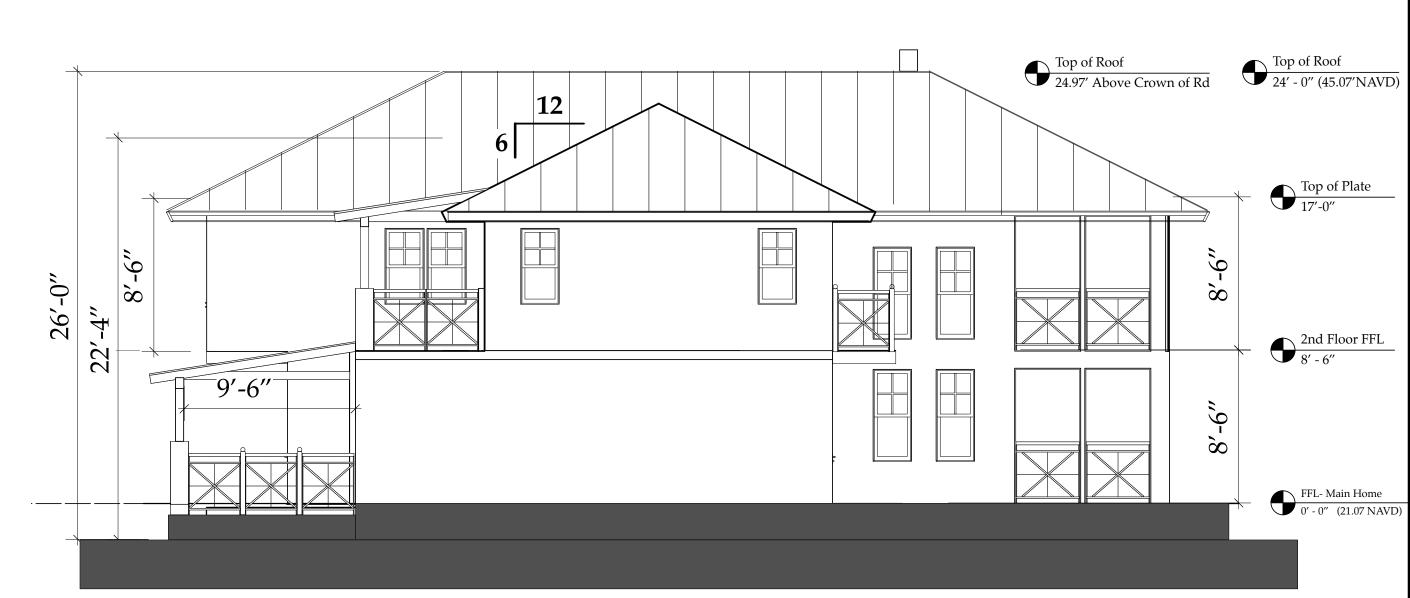A.3.01 Scale: 1/4" = 1'-0"

3/16"

OLD & NEW North & South Elevations-MAIN HOUSE A3.03coa

/00			<u>Derrickson</u> Renovations
/09 :e	Issue Note	Issue Notes	
		Daniel Slo Date:	oan, AR95577


"Sloan & Sloan- Architecture + I.D. 106 SE 7th Avenue, Ste. B Delray Bch, FL 33483 (561) 243-8755


Derrickson_Reno_ExtgBldg.vwx

Derrickson Residence Renovations & Additions 330 NE 1st Avenue

NEW NORTH & SOUTH **ELEVATIONS of Main Residence**

Project Manager	Project ID
D. Sloan	Derrickson Residence Project
Drawn By	Scale
D. Sloan	1/4'' = 1'-0''
Reviewed By	Drawing No.
D. Sloan	A.3.03 coa
Date	A.3.03 C0a
8/22/2021	of
CAD File Name	Total Sheets

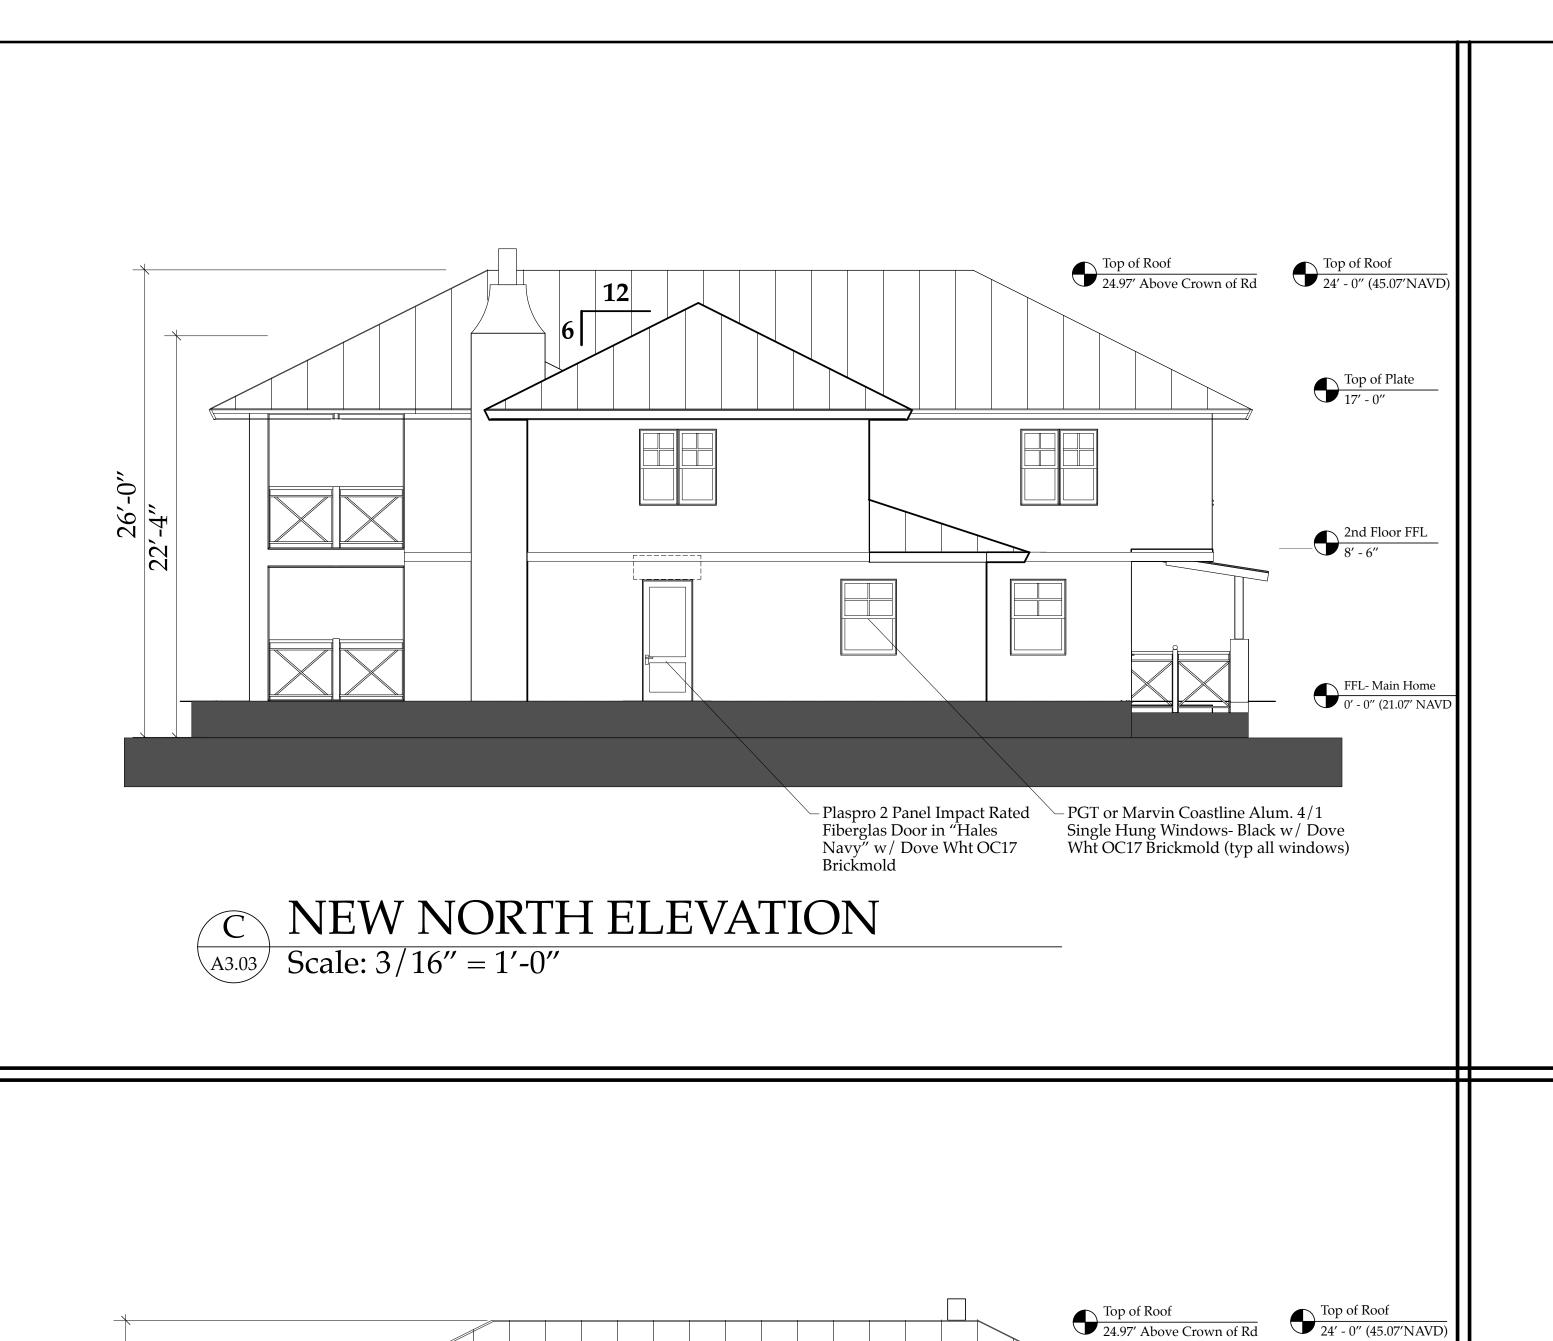


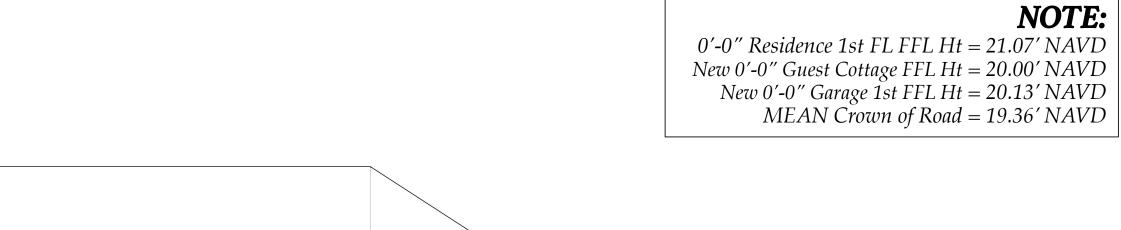



EXISTING NORTH ELEVATION C EXISTING N
A.3.01 Scale: 3/16"= 1'-0"

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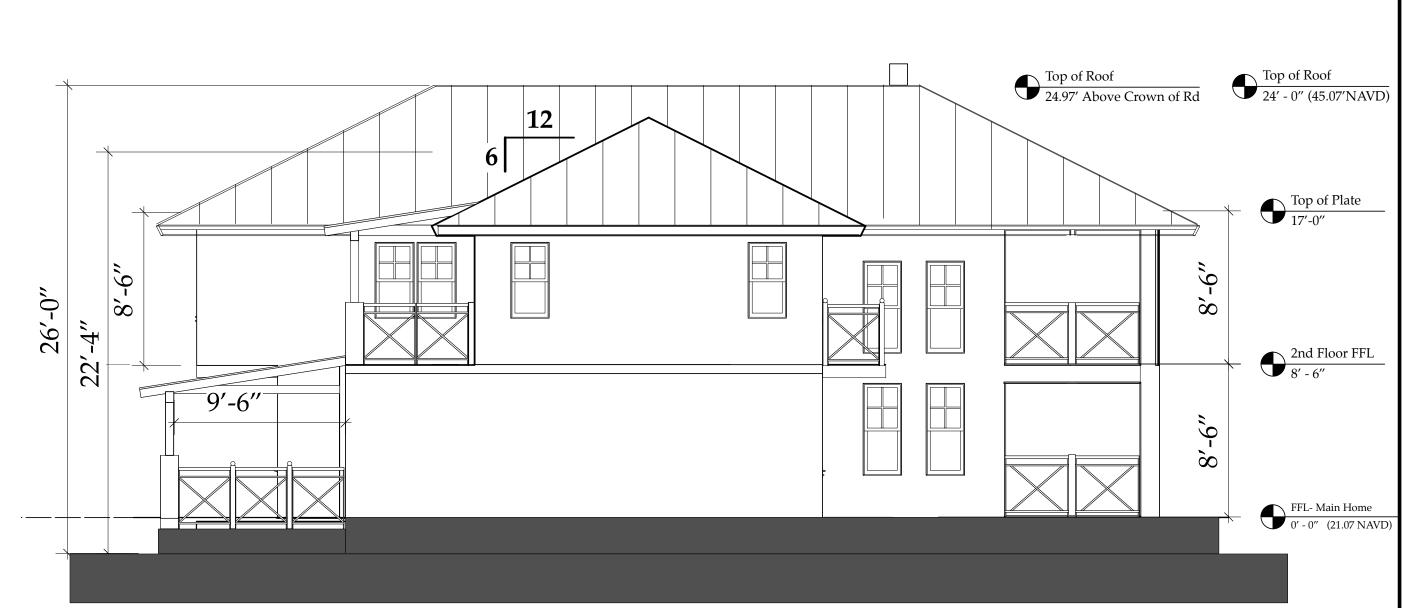
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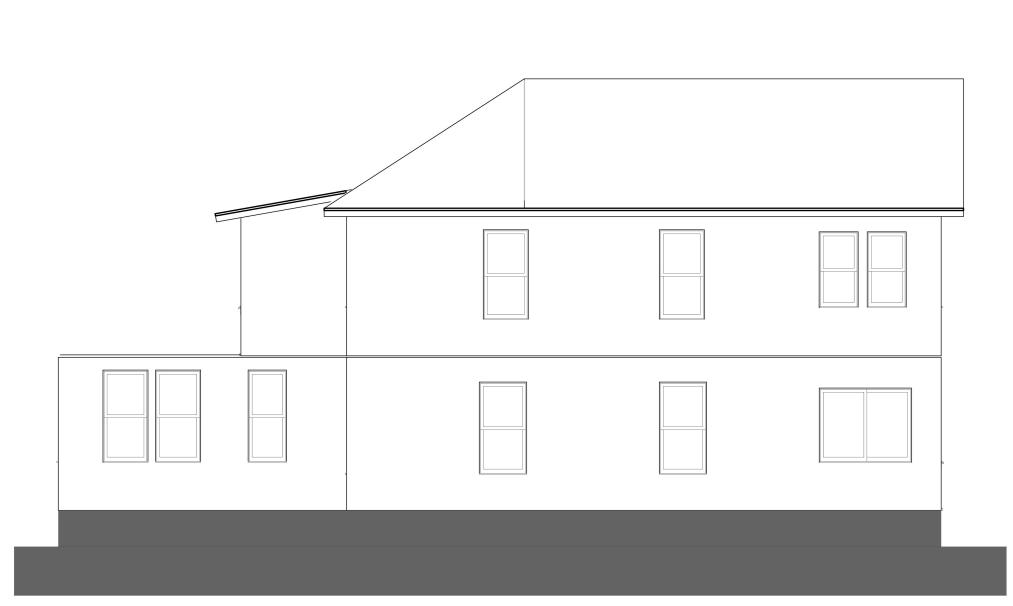
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D EXISTING SOUTH ELEVATION

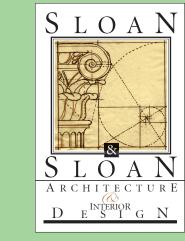A.3.01 Scale: 3/16"= 1'-0"

OLD & NEW North & South Elevations-MAIN HOUSE w/ Simplified Railing A3.03coa-ALT

	<u>Derrick</u> Renovat			
5/16/09	Issue Note			
Date	Issue Notes			
	Daniel Sloan, AR95577 Date:			
Sloan	n & Sloan- Architecture + I.D.			


106 SE 7th Avenue, Ste. B Delray Bch, FL 33483 (561) 243-8755


Derrickson Residence Renovations & Additions 330 NE 1st Avenue


awing Title ALT :: NEW NORTH & SOUTH **ELEVATIONS of Main Residence** w/ Simplified Railing Design

ject Manager	Project ID
D. Sloan	Derrickson Residence Project
awn By	Scale
D. Sloan	1/4'' = 1'-0''
riewed By	Drawing No.
D. Sloan	A.3.03 coa-ALT
te	A.3.03 COa-AL1
8/22/2021	of

Total Sheets

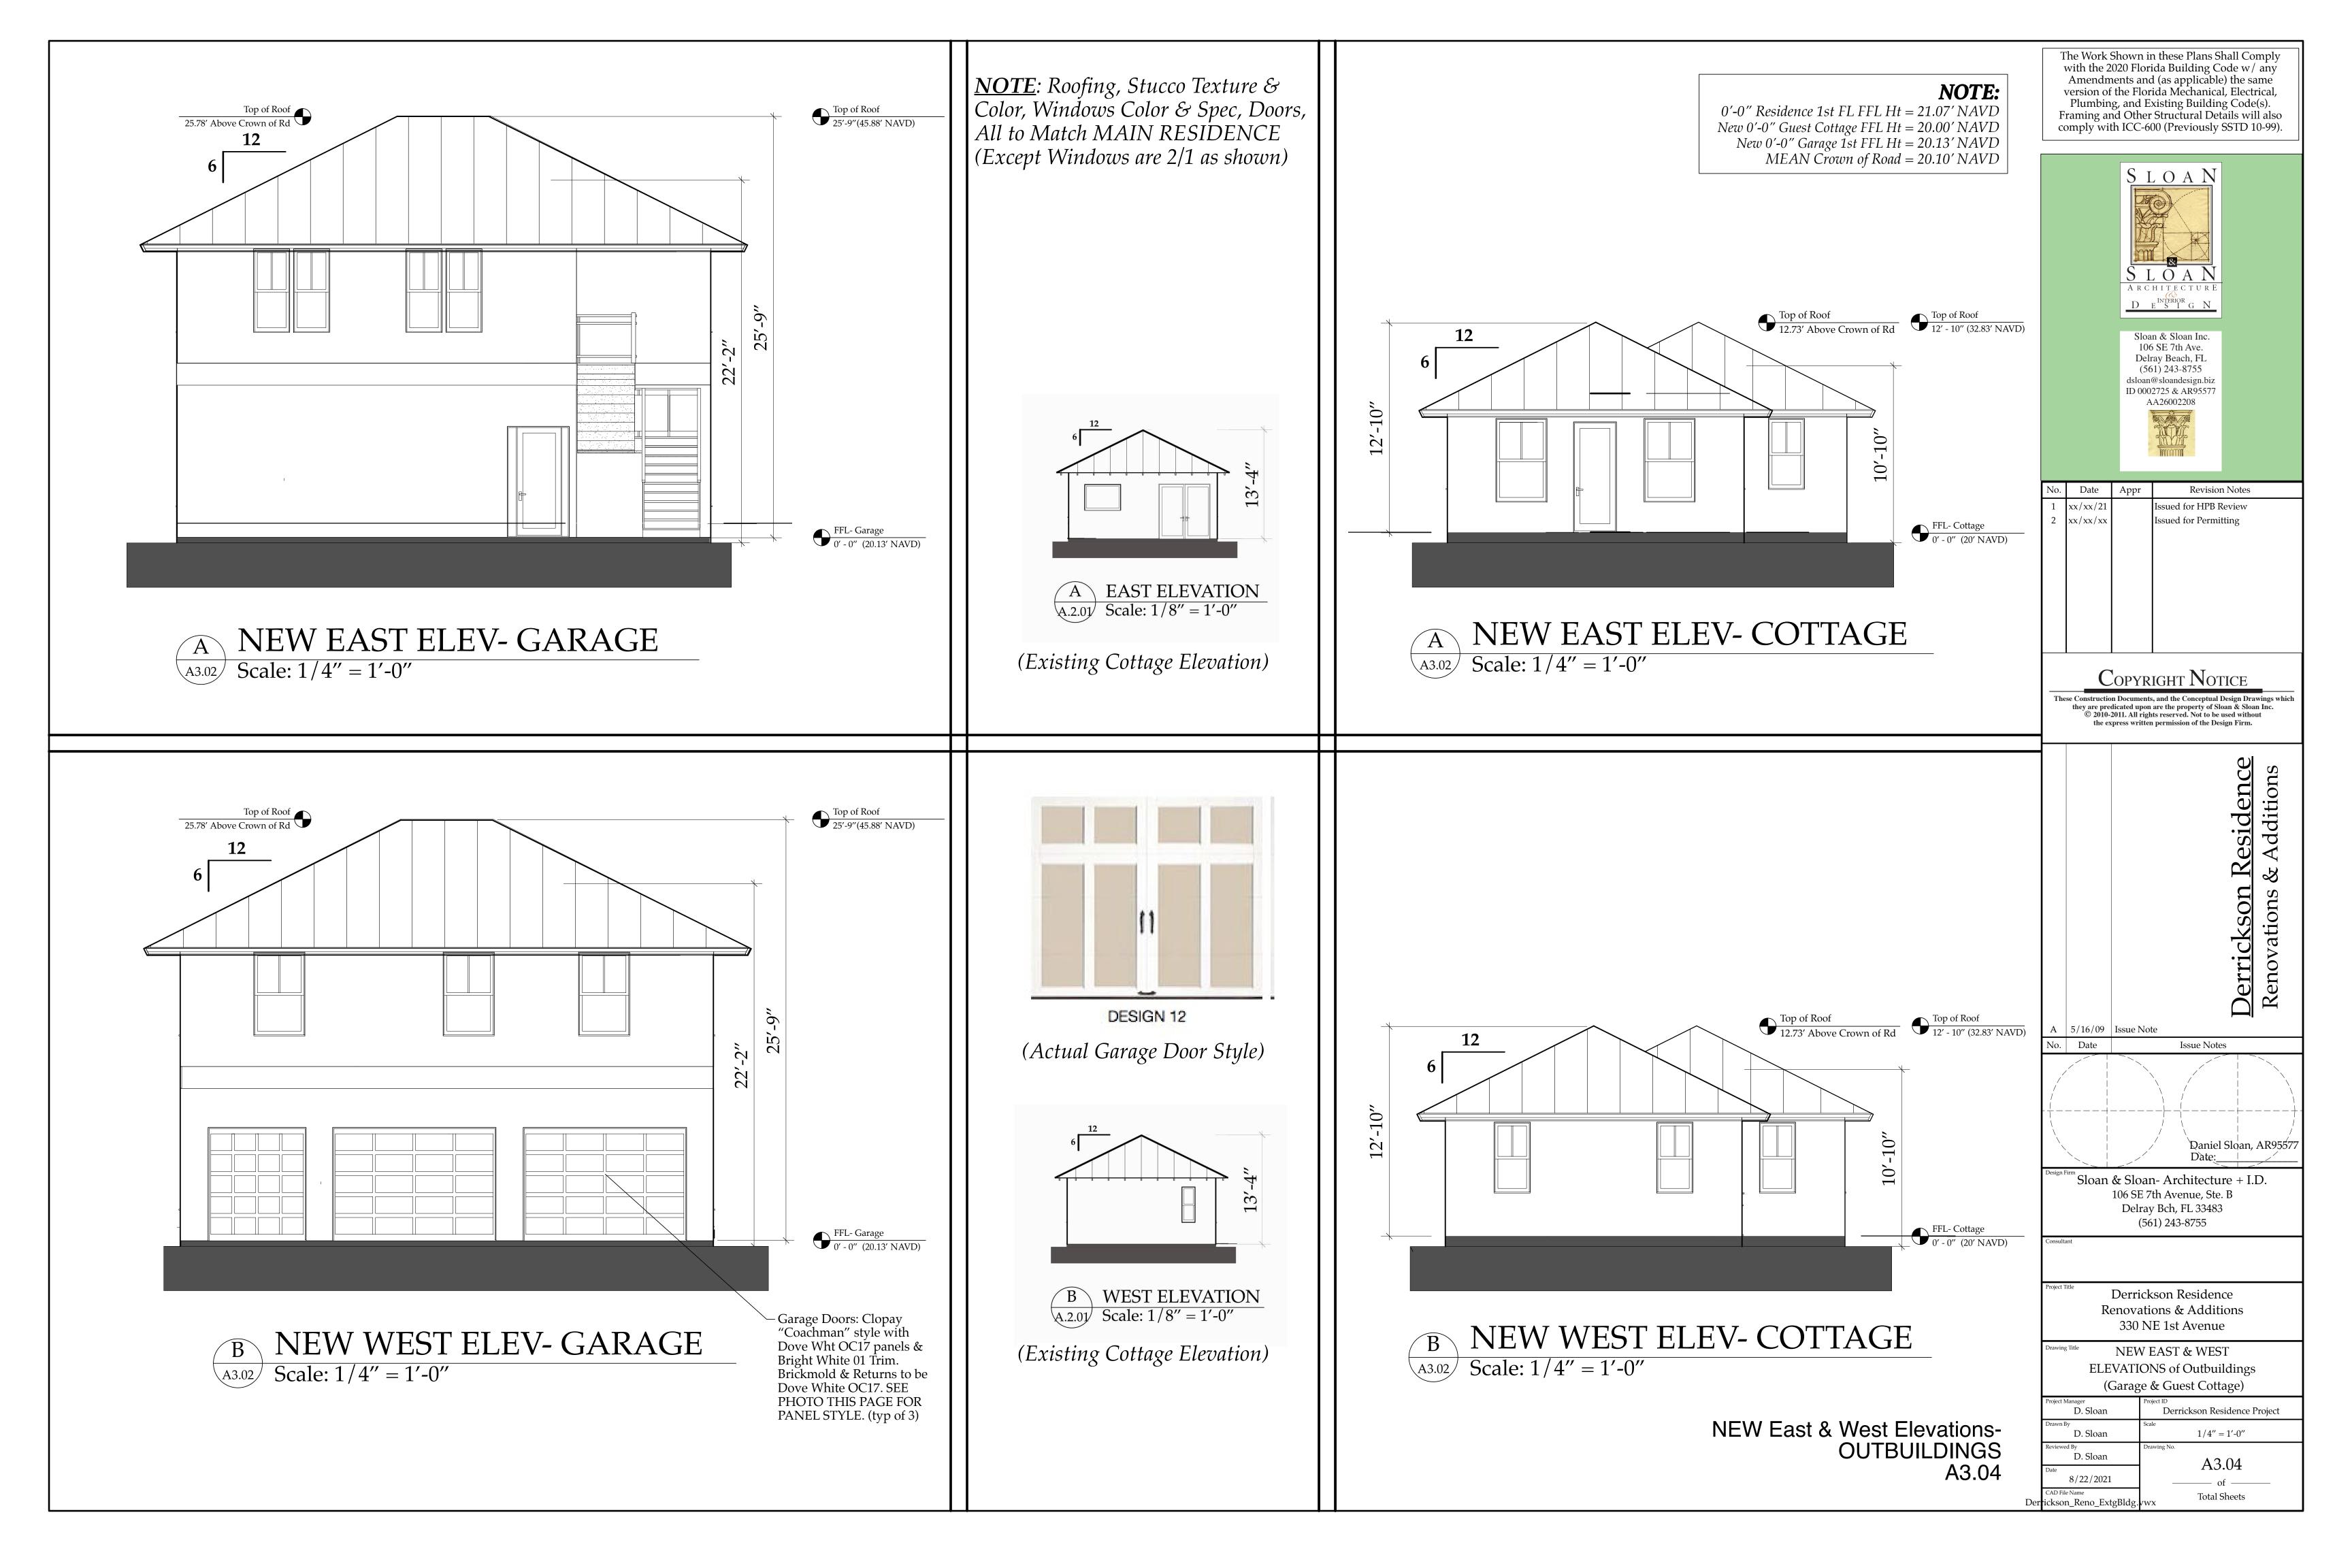

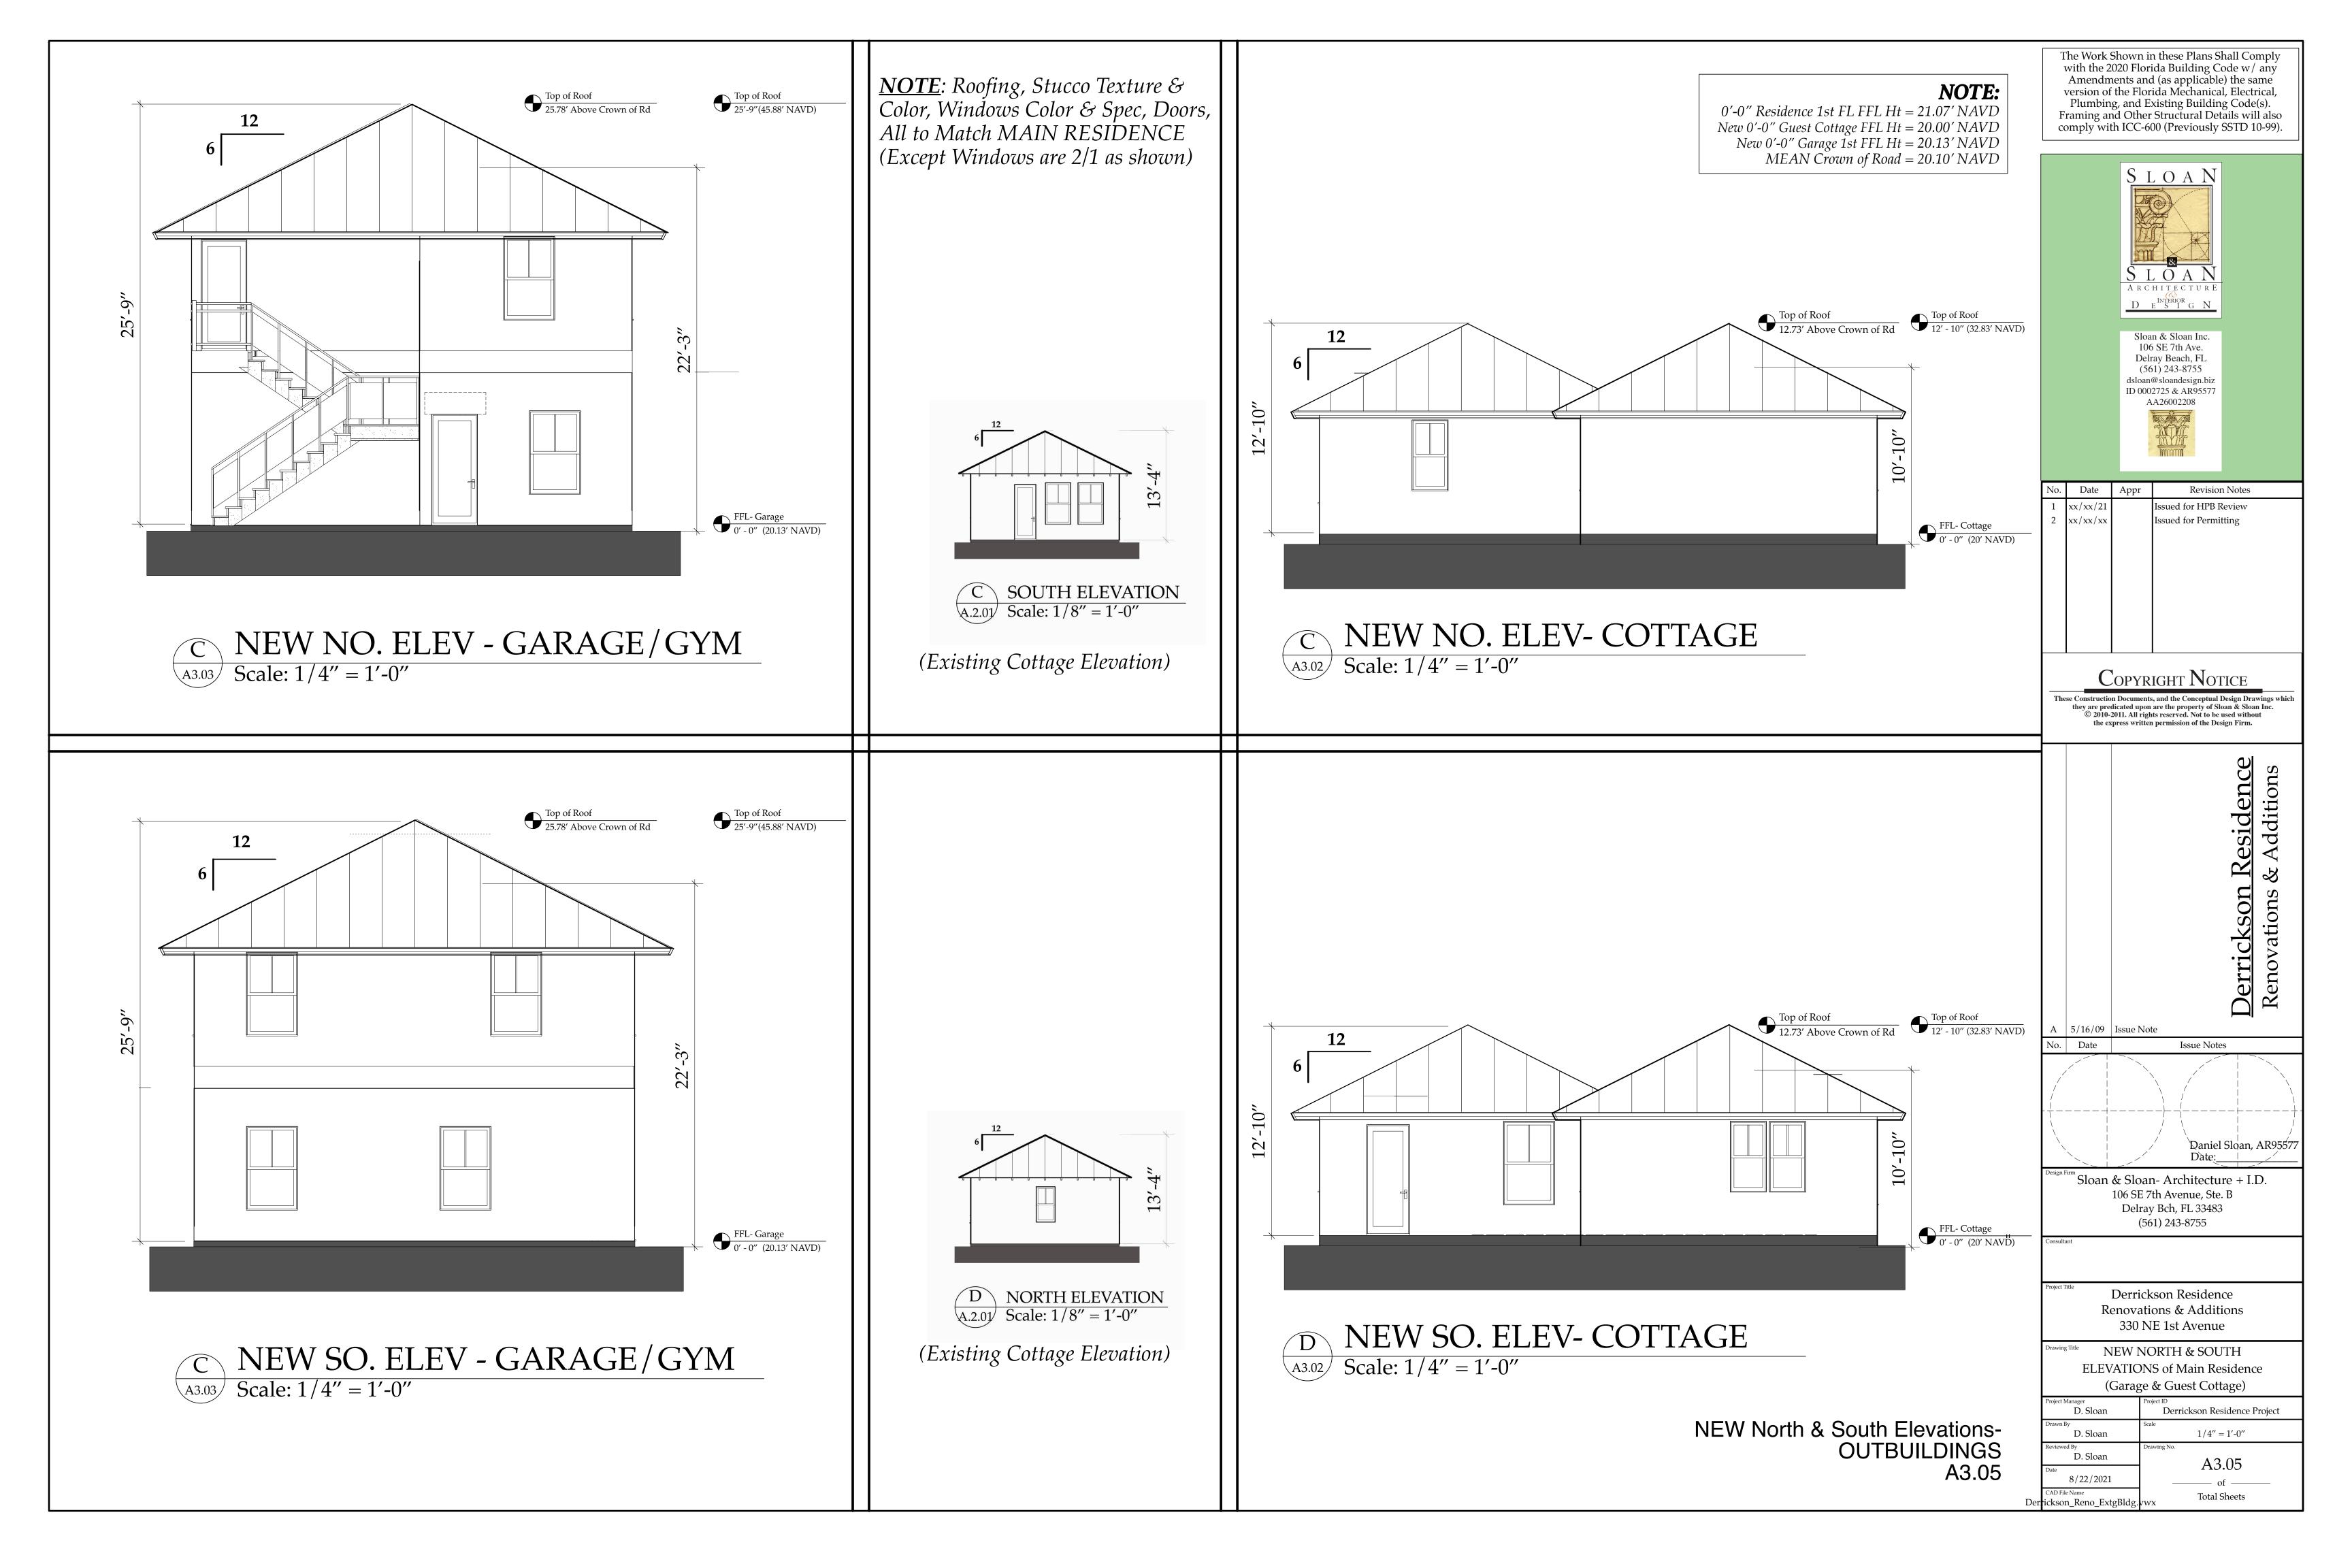

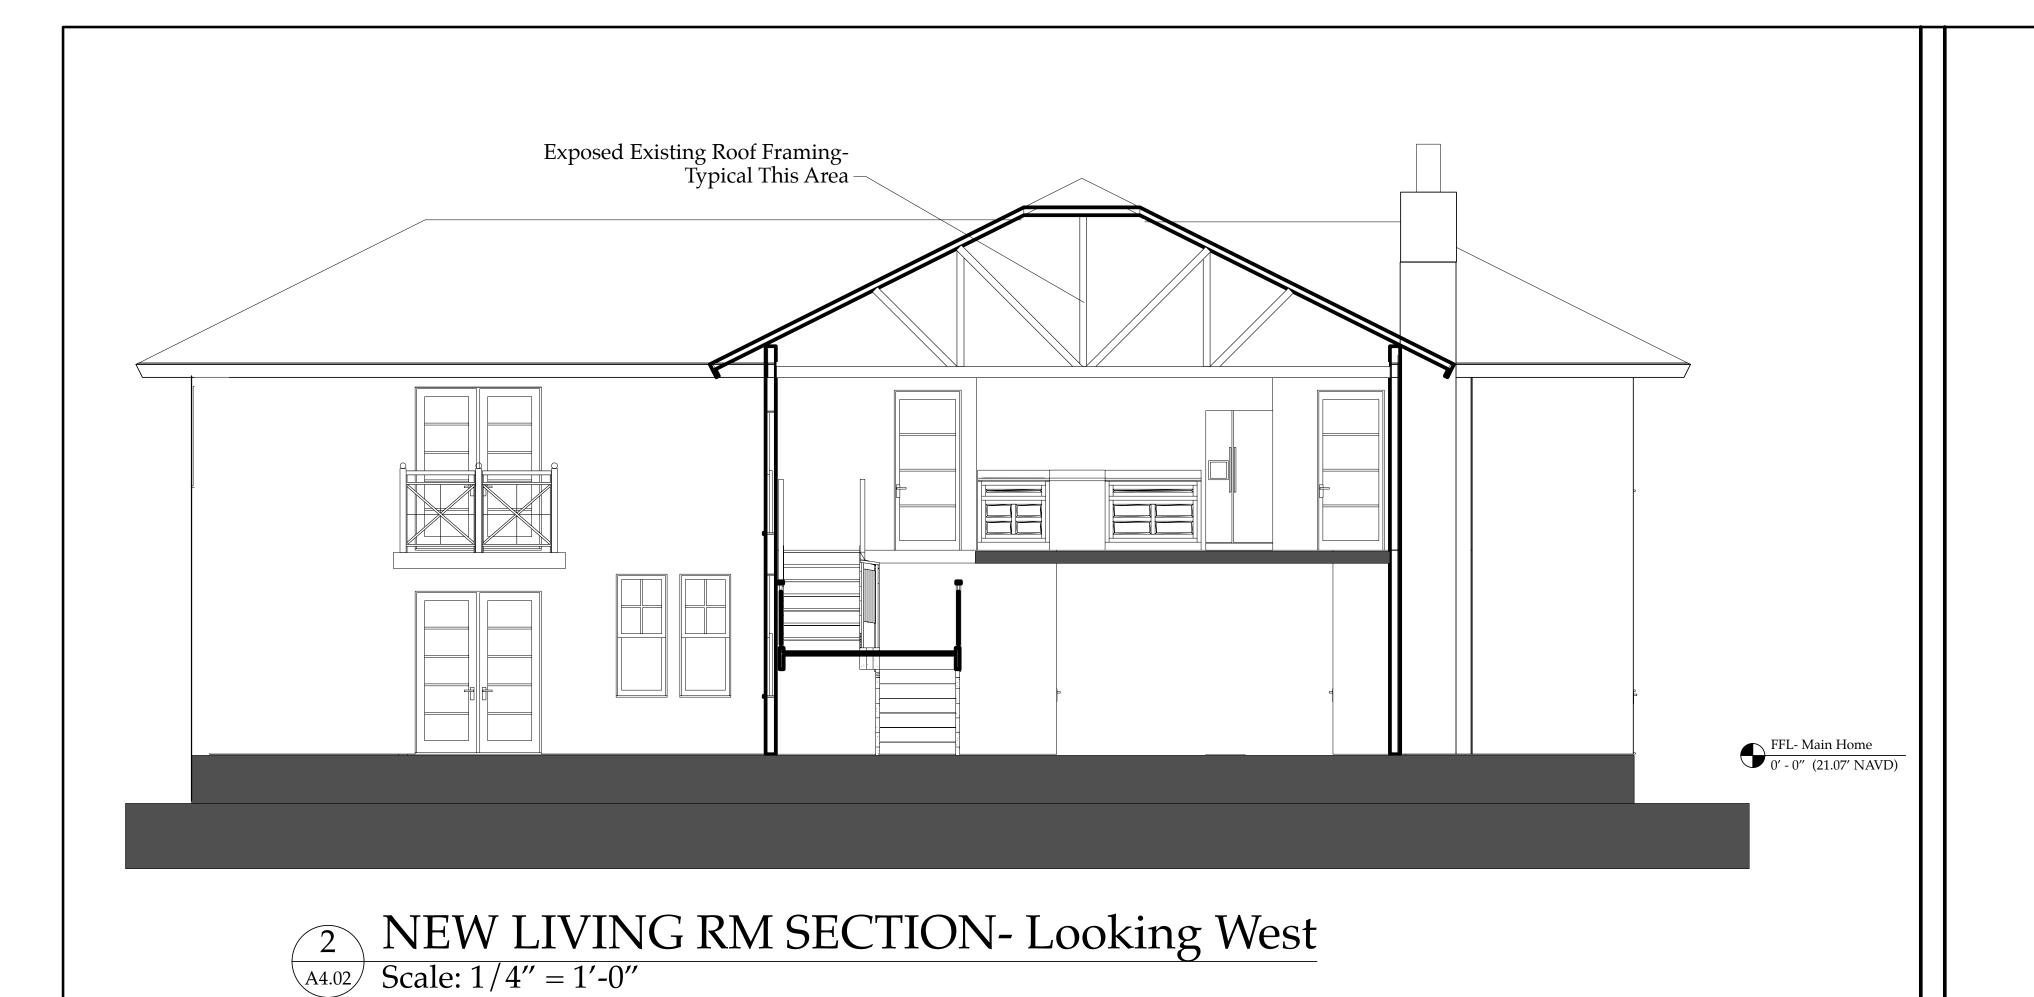

Marvin Coastline Bifold French


Door in Black 9068 Size w/ Impact Rated Laminated, Insulated Glass

(NOTE WILL MATCH 2 SETS OF

FRENCH DOORS IN


APPEARANCE) -

NOTE: SEE IMPORTANT NOTES AND SPECIFICATIONS ON SHEET S8.01

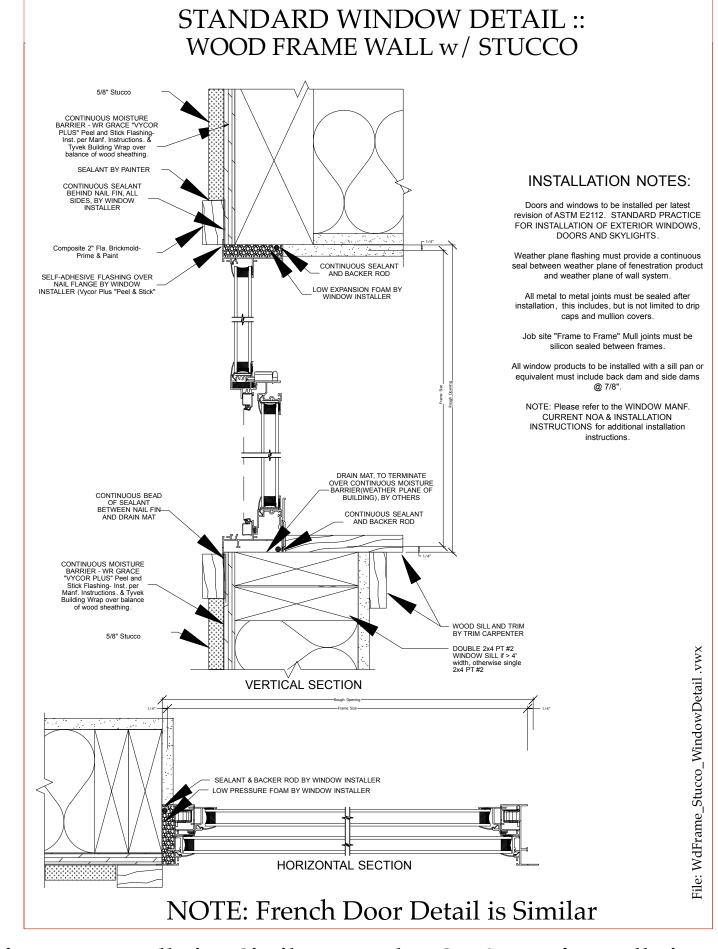

NOTE: Exterior Door Installation Similar- consult NOA & Manf. Installation Directions on Both Window & Door Installation Methods/Proceedures.

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Derrickson Reside
Renovations & Additions & Additions
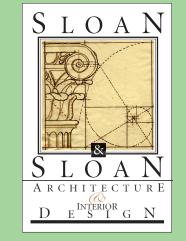
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No. Date

Der ickson_Reno_ExtgBldg

PENNONI, INC., Structural Engineers 601 N. Congress Ave, Ste. 106a Delray Beach, FL. 33445

Derrickson Residence Renovations & Additions 330 NE 1st Avenue

BUILDING SECTIONS:

At Front Porch &
& at Living Room

D. Sloan

Derrickson Residence Project

Drawn By
D. Sloan

Reviewed By
Robert Selinsky, PE
Date

8/22/2021

CAD File Name

A Sloan

Drawing No.

A 4.02

A 5.02

A 5.02

A 5.02

A 5.02

A 5.02

A 6.02

A 7.03

A 7.03

A 7.04

A 7.05

A 7.0

PCT FD750 or Marvin Coastline Alum. French Door in Black Dbl 3068 Size w/ Impact Rated Laminated, Insulated Class (Typ of 4 sets of Doors at Porches)

NEW EAST FRONT PORCH SECTION/ ELEVATION

3 NEW EAST FRONT PORCH SECTION/ ELEVATION

Building Sections A4.02

NOTE: PT #2 = "Southern Yellow Pine #2 or Better"