

Development Services Department

BOARD ACTION REPORT - APPEALABLE ITEM

Project Name: Tesla (2021-197)

Project Location: 3000 S. Federal Hwy **Request:** Class 1 Site Plan Modification

PCN: 12-43-46-29-23-000-0010

Board: Site Plan Review and Appearance Board

Meeting Date: September 22, 2021

Board Vote: (7-0)

Board Action:

Approved the Class 1 Site Plan Modification (7-0 vote) for 3000 S. Federal Hwy, by finding the request is consistent with the Comprehensive Plan and Land Development Regulations.

Project Description:

A Class I Site Plan Modification associated with façade and site improvements such as painting of the two structures; modifications to the mansard roof; updating ADA compliance; addition of a freestanding canopy covering six parking spaces; and the addition of vehicle charging stations for service use only.

Board Comments:

N/A


Public Comments:


N/A


Associated Actions:

N/A

Next Action: The SPRAB action is final unless appealed by the City Commission.

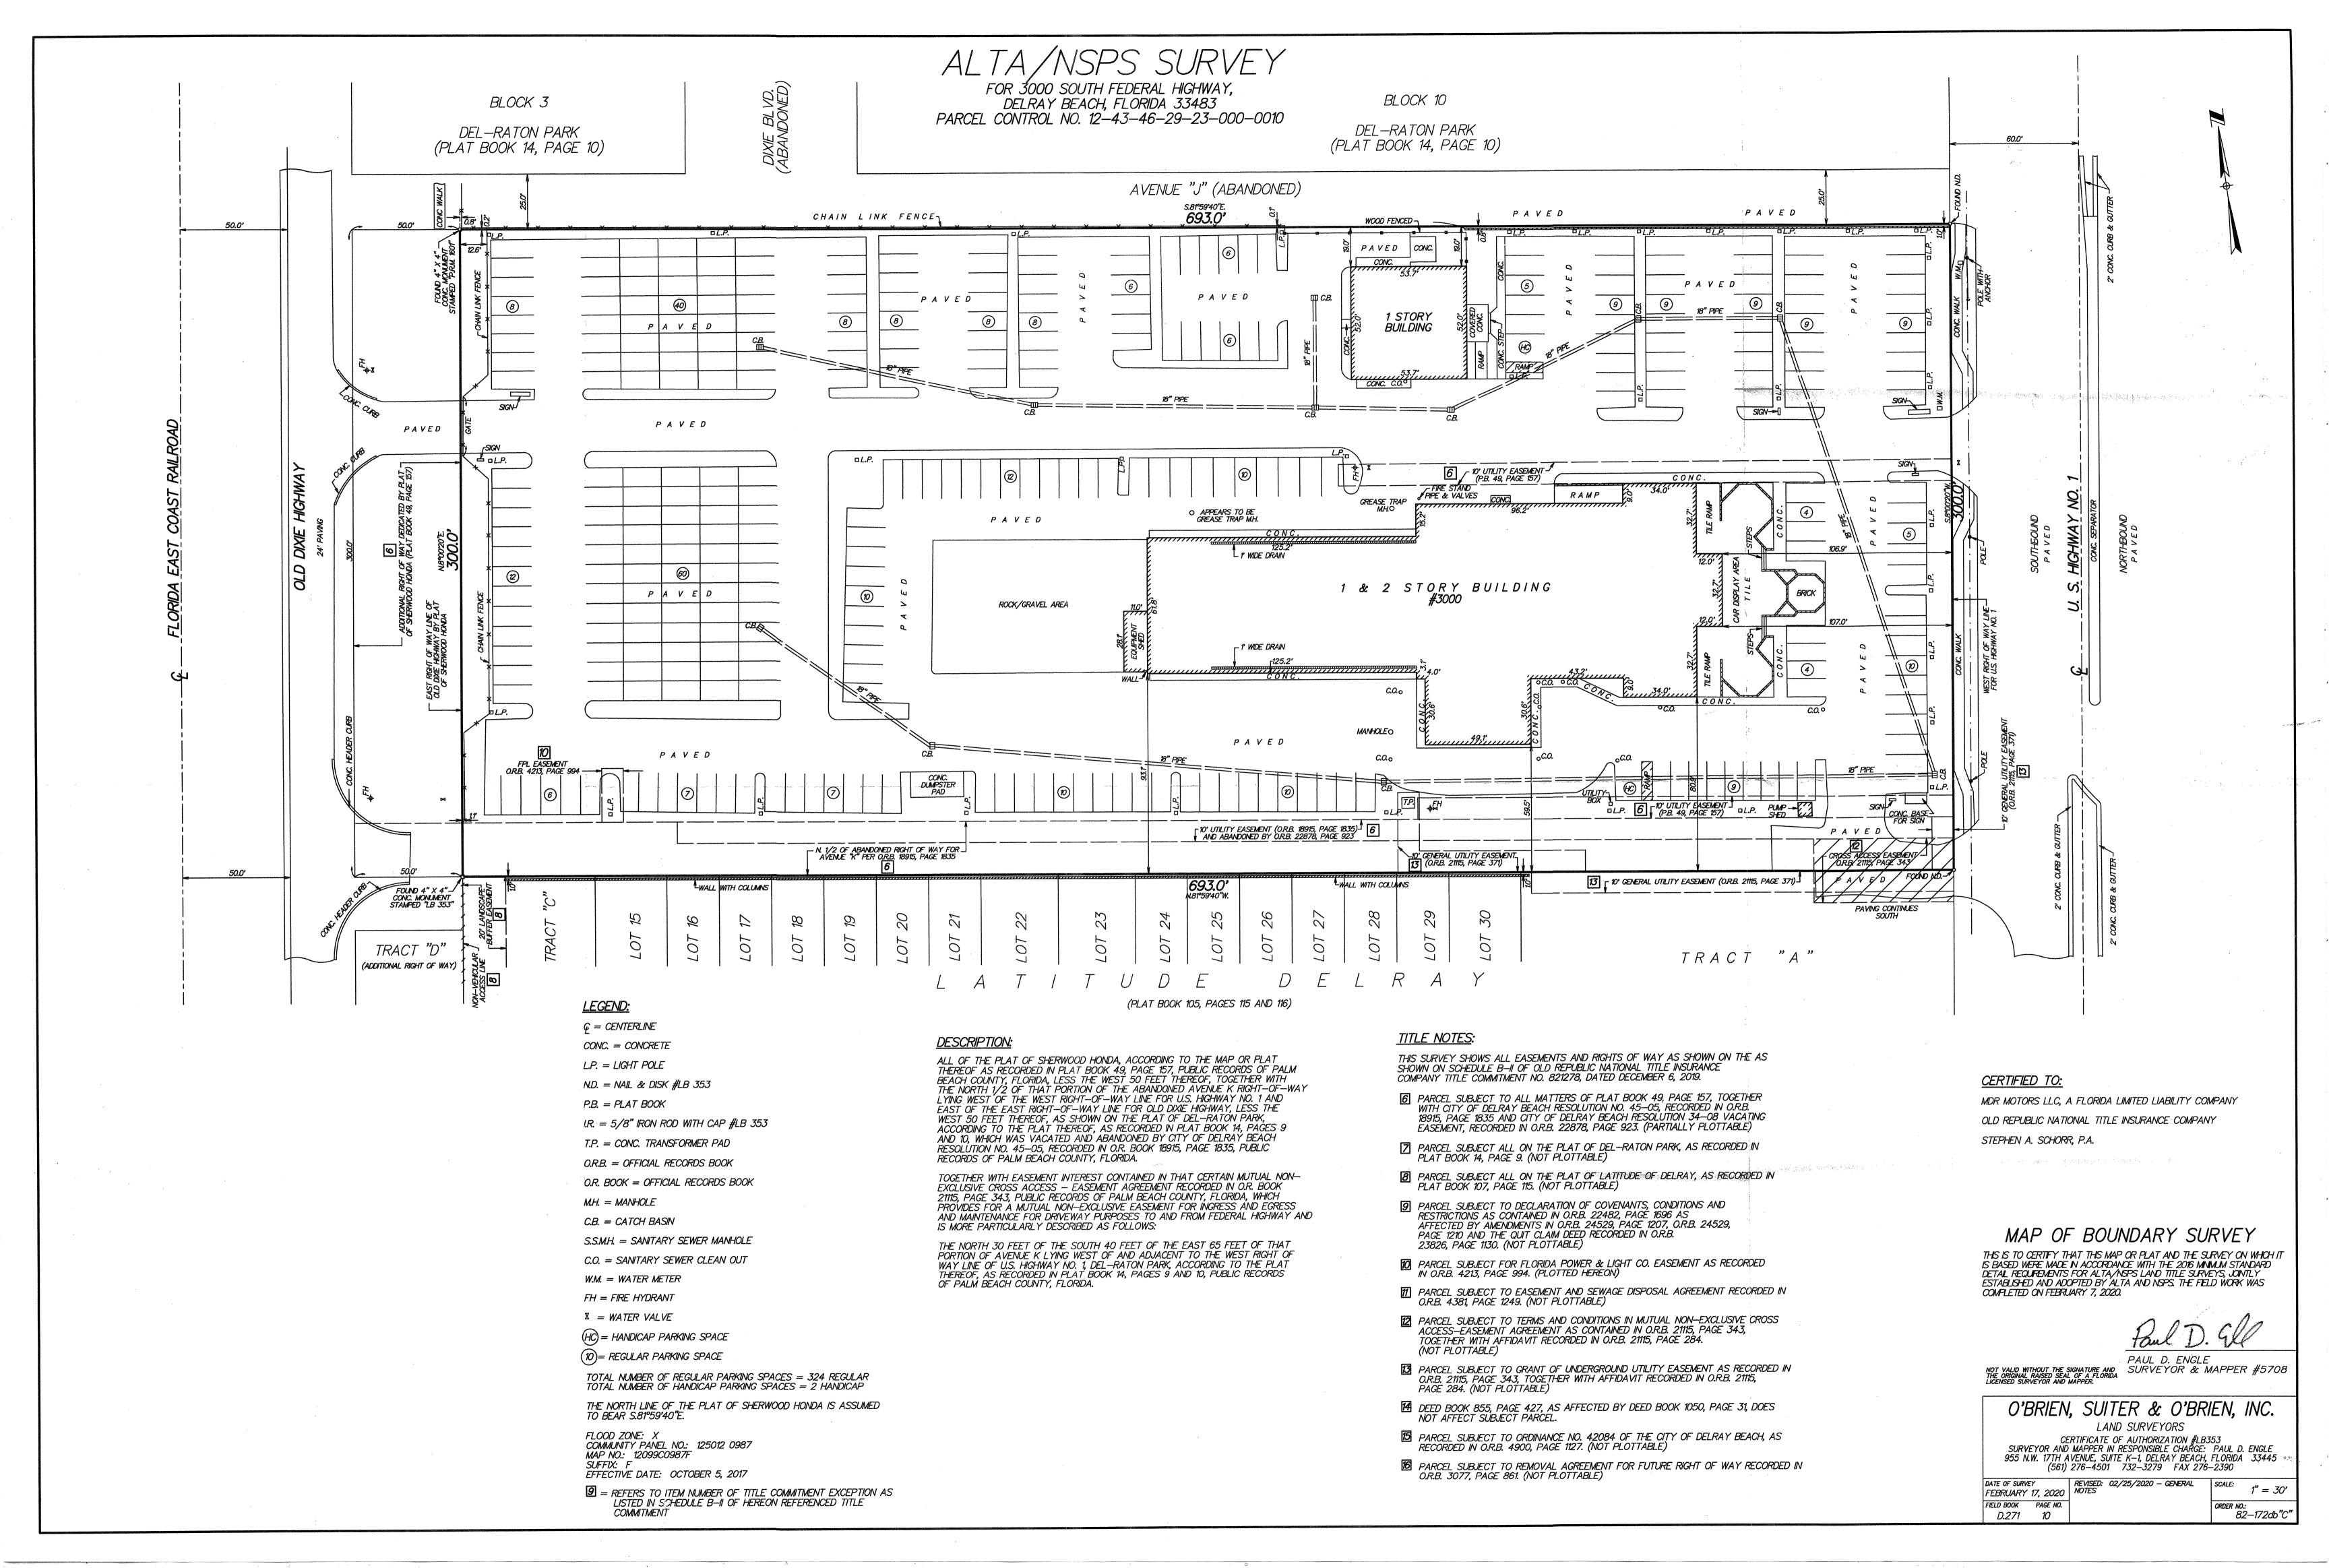

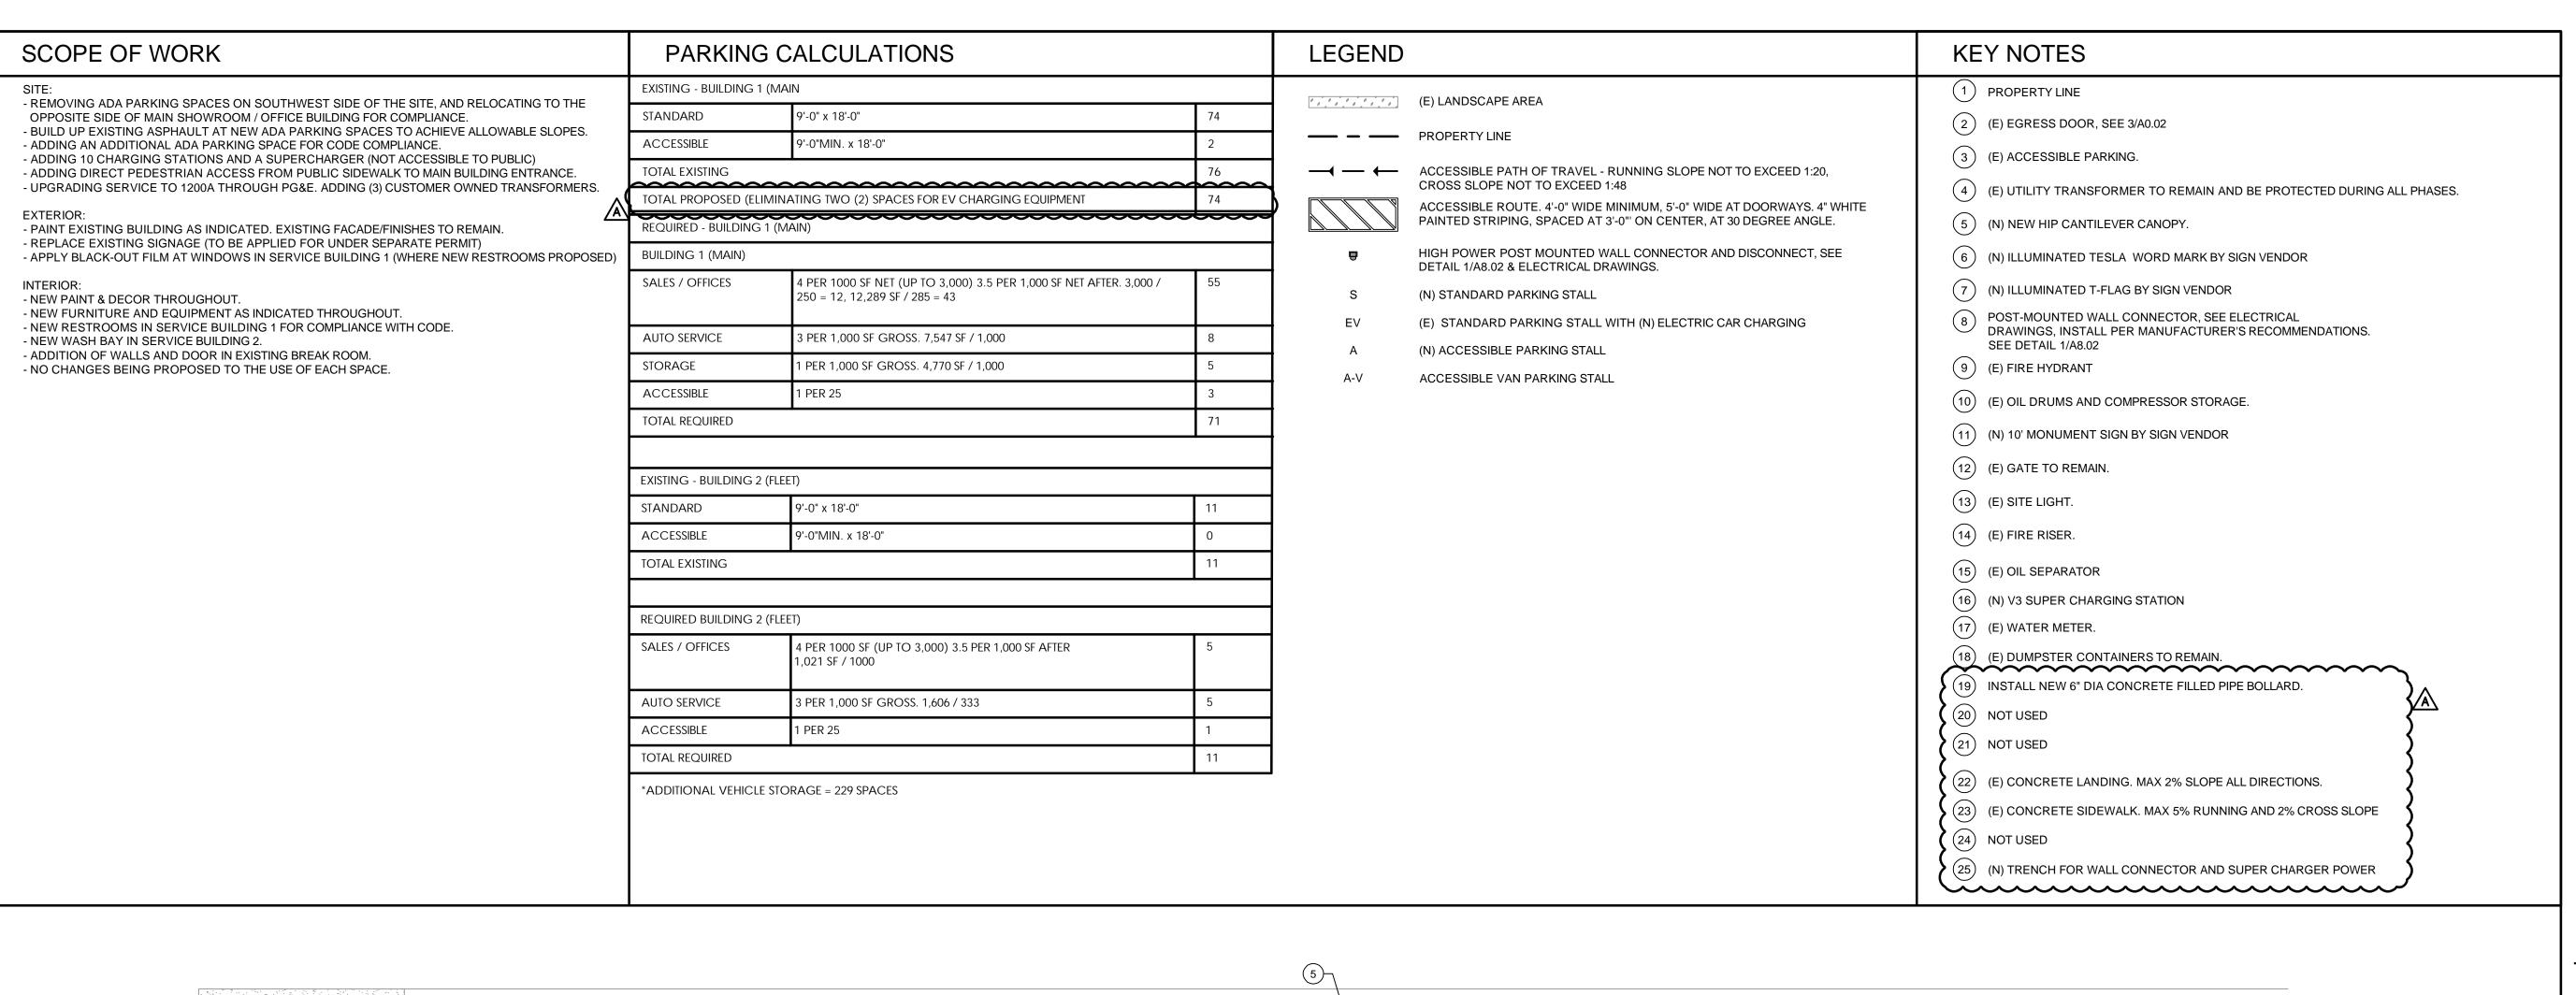

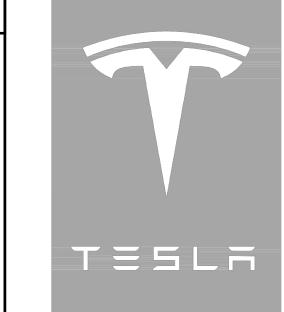

GOGLIA

TESLA SALES, SERVICE, **DELIVERY**

3000 S. FEDERAL HWY. DELRAY BEACH, FL 33483


75% ISSUE
PERMIT ISSUE

SITE PLAN

SCALE: AS NOTED PROJECT NUMBER:

SHEET NUMBER

200473

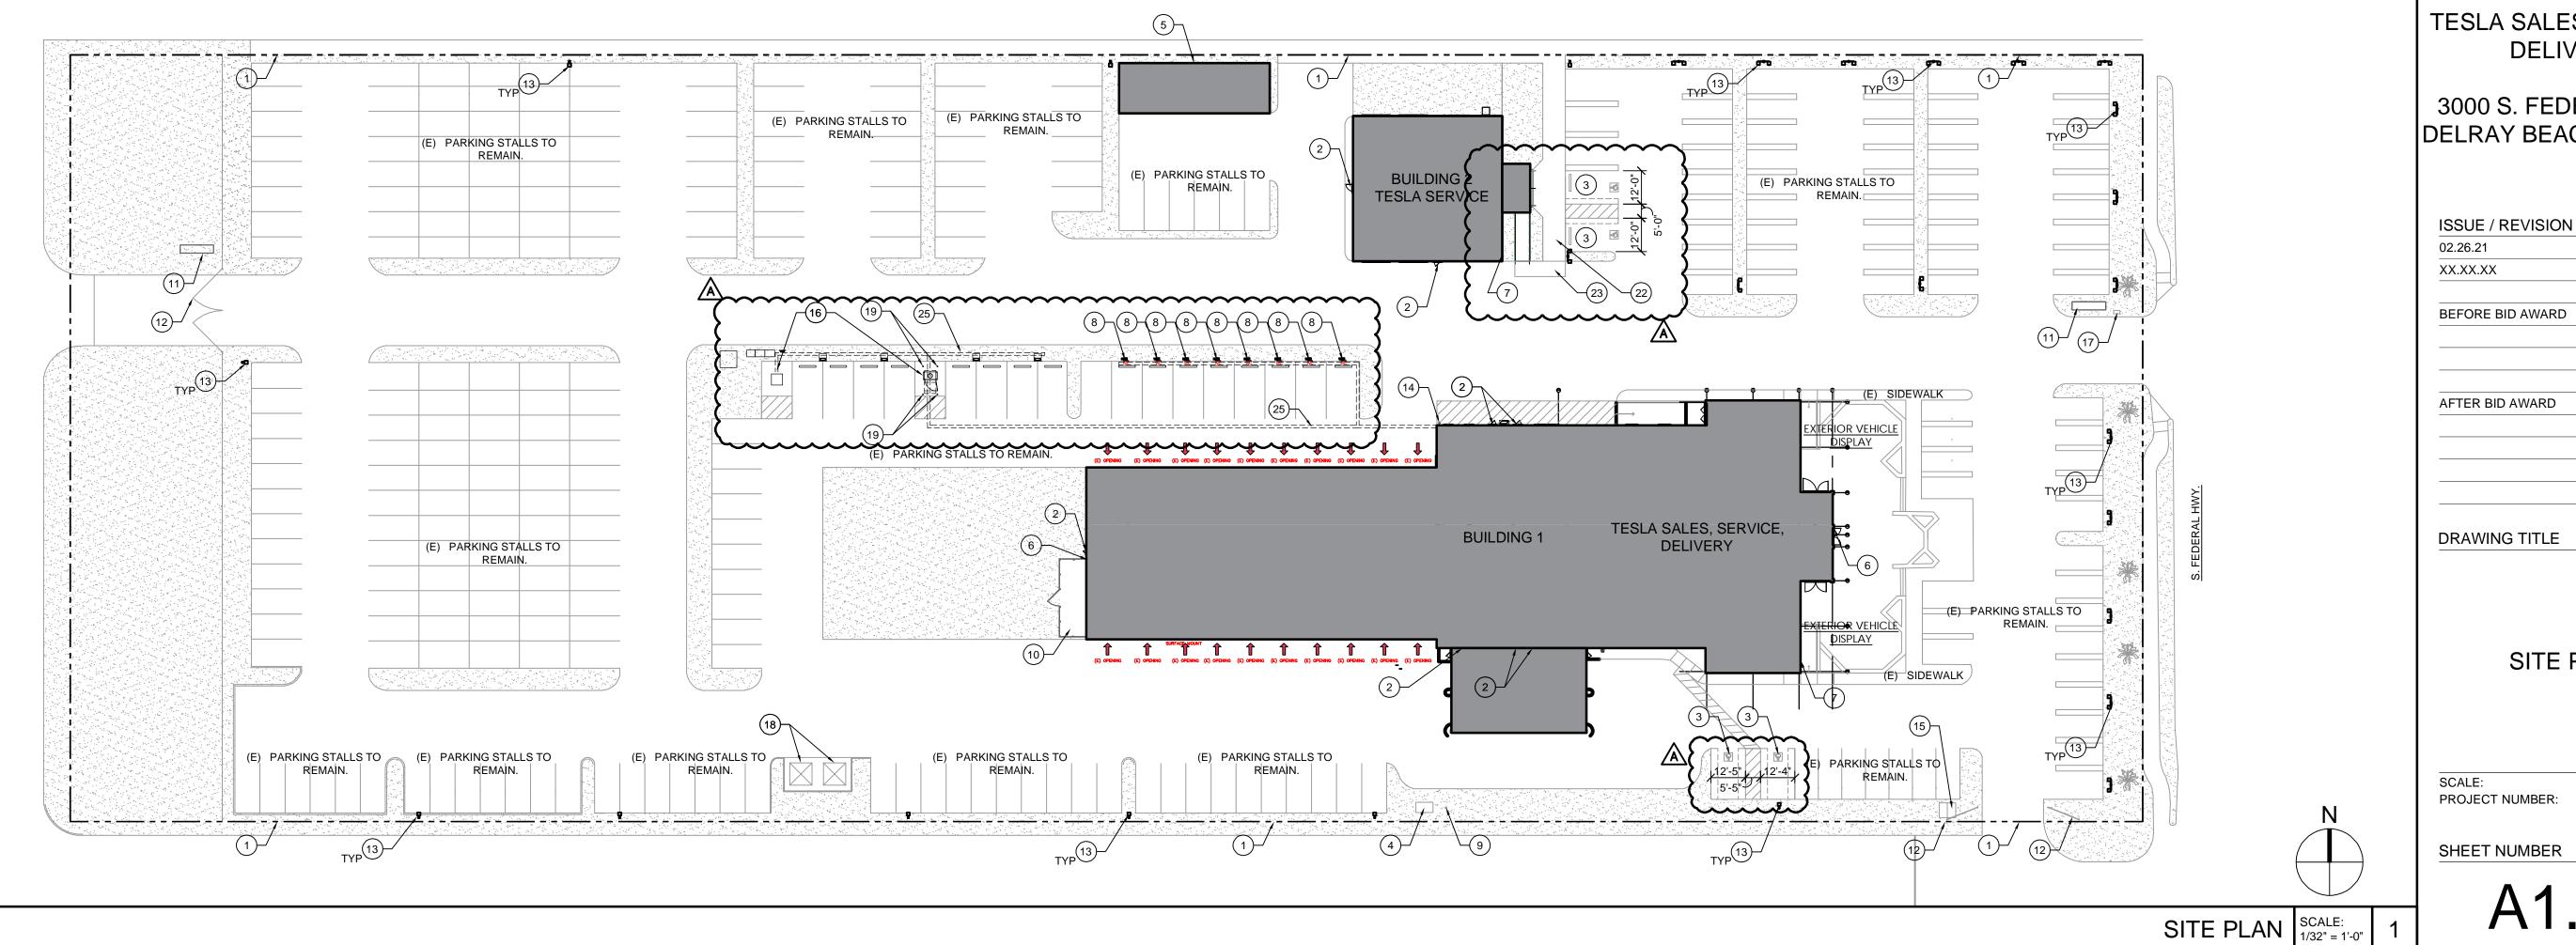




MARCH 2019

SUPERCHARGER CABINET V3 (PN 1450758-00-D)							
	AC Input Power	Input [V _{AC}]	480	440	415	400	380
	·	Peak Power [kVA]	433	TBD	TBD	TBD	TBD
	AC Input Voltage	380 Vac - 480 Vac, 34	AC+N				
AC INPUT	AC Input Current	521 A _{AC} Max.					
[POWER]	Frequency	50 Hz / 60 Hz					
	Power Factor Current THD	≥ 0.99 Pending test					
	Voltage THD	Pending test					
		L1, L2, L3, N: 150 – 4	100mm²	250MC	M – 750	MCM	
AC INPUT [MECHANICAL]	Conductor Size Range	PE: #14 AWG - 2/0		, 2000	700		
	Conductor Material Type	L1, L2, L3, N: Cu, Al PE: Cu					
	Lug Temperature Rating	90° C					
	DC Bus Power	Input [V _{AC}]	480	440	415	400	380
DC BUS		Peak Power [kW]	622	TBD	TBD	TBD	TBD
[POWER]	DC Bus Voltage	898 - 961 V _{DC}					
[. 5.1.2.1.]	DC Bus Current	Input [V _{AC}]	480	440	415	400	380
	202000000	Cont. Current [ADC]	640	TBD	TBD	TBD	TBD
		P, N: 150 – 300mm ² ,			MCM		
DC BUS	Conductor Size Range	Mid: 2.5 – 35mm ² , 14	AWG –	· 1 AWG			
[MECHANICAL]	Occident Material Trans	PE: #14 AWG - 2/0					
	Conductor Material Type Lug Temperature Rating	Pos, Neg. Mid: Cu, A	I PI	E: Cu			
	Post Output Power	258kW Peak					
	Post Output Voltage	180 - 500 V _{DC}					
DC POST	Post Output Current	428A _{DC} Continuous					
[POWER]	Number of Charge Posts	1 - 4					
	Max voltage drop	10 V _{DC}					
	Conductor	V+, V- : 50 – 300mm ²	² , 1/0 - 6	00MCM			
DC POST	Size Range	PE: #14 AWG - 2/0					
[MECHANICAL]	Conductor Material Type	Pos., Neg. : Cu, Al	PE	E: Cu			
	Lug Temperature Rating	90°C					
SYSTEM	Efficiency	96%					
	AC Input side: Class 1	DC Output side: Isola		•			
PROTECTION	Over Voltage/Current/T					ring	
	Short-Circuit Protection	External Electronic T		it Breake	∋r		
	Short Circuit Current Rating Operating Temperature	85 kA RMS symmetri -30°C to 50°C, -22°F		=			
ENVIRONMENTAL	Ingress Protection	IP66 (Electronics), IP			of)		
ENVIRONMENTAL	Ventilation Requirements	Ventilation Not Requi	,	iiiai ito	JI)		
NOISE	Typical noise at 1m	Pending test	.04				
CERTIFICATIONS	• • • • • • • • • • • • • • • • • • • •	, cETL, FCC, ICES-003	3-B pend	ding			
LAYOUT	Max. Distance to Charge Post	100 m, 340 ft.					
WEIGHT	Supercharger Cabinet Weight	1500 kg, 3307 lbs. approximate					
DIMENSIONS	Depth, Width, Height	1000, 1250, 2200 mm; 39 _{12/32} , 49 _{7/8} , 86 _{20/32} in.					
MOUNTING	Per-anchor min. Shear Strength Per-anchor min. Tension Strength	Pending calculation Pending calculation					

MARCH 2019

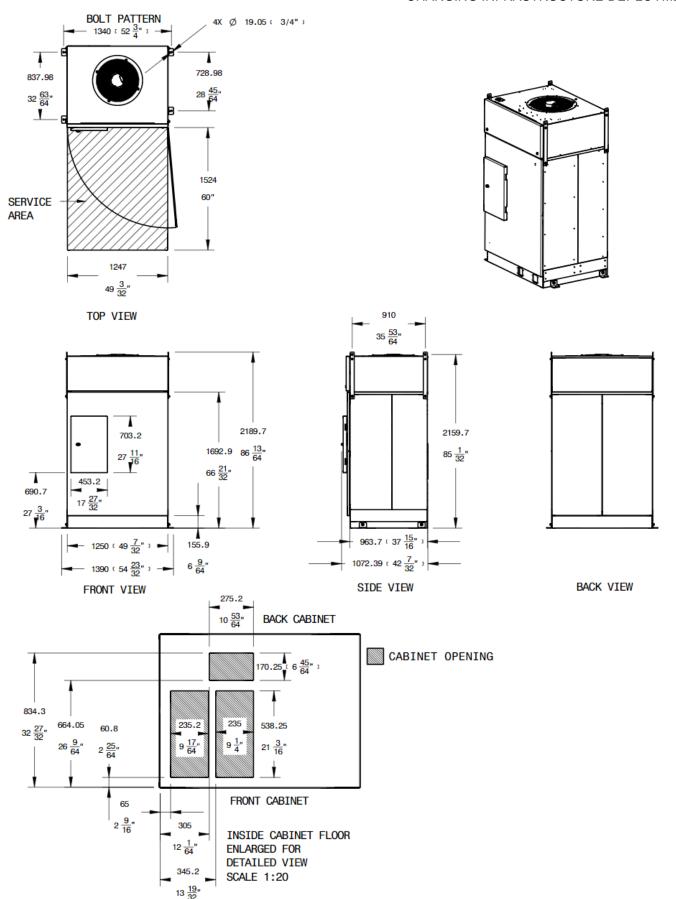

SUPERCHARGER (V3) DATASHEET



MARCH 2019

INDUSTRIAL SITE CONTROLLER (PN 1137202-02-C)						
ELECTRICAL	Input Voltage	120 V _{AC} - 480 V _{AC}				
	Input Power	100 W Max.				
	Frequency	50 Hz / 60 Hz				
	Overvoltage Protection	Category III				
ENVIRONMENTAL	Operating Temperature	-30°C to 50°C, -22°F to 122°F				
	Ingress Protection	IP67, NEMA 4				
	Relative Humidity	100% condensing, wet location rated				
COMMUNICATION	Protocols	Modbus TCP, DNP3, Rest API				
	Backhaul	Ethernet, 4G LTE				
CERTIFICATIONS	UL 61010-1, CSA-22.2, IEC-61010-1					
MECHANICAL	Dimensions	L: 255 mm (10 in) W: 530 mm (20.9 in) H: 730 mm (28.7 in)				
	Weight	21.4 kg (47.2 lbs)				

































































SUPERCHARGER (V3) DATASHEET



MARCH 2019

SUPERCHARGER CHARGE POST VER. 3 (PN 1088585-00-D)						
POST INPUT/OUTPUT [POWER]	Post Power	250 kW peak				
	Post Voltage	180 - 500 V _{DC}				
	Post Current	350 A _{DC} cont. @ 35°C				
DC INPUT [MECHANICAL]	Conductor	V+, V- (2x/pole): 70 - 185mm ² , 2/0 - 350 MCM				
	Size Range	PE: 25 - 50mm ² , 3AWG - 1/0				
	Conductor Material Type	V+, V- : Cu, Al PE: Cu				
	Lug Temperature Rating	90° C				
PROTECTION	Over Current/Temperature, Uneven Current Split					
ENVIRONMENTAL	Operating Temperature	-40°C to 50°C, -40°F to 122°F				
	Ingress Protection	IP44				
CERTIFICATIONS	UL 2202, CSA 22.2 NO 107.1-16 pending					
LAYOUT	Max. Distance to Cabinet	100 m, 340 ft.				
WEIGHT	Charge Post Weight	64 kg, 140 lbs. approximate				
DIMENSIONS	Depth, Width, Height	250, 810, 1687 mm; 9 _{27/32} , 31 _{7/8} , 66 _{13/32} in.				
MOUNTING	Per-anchor min. Shear Strength Per-anchor min. Tension Strength	Pending calculation Pending calculation				



MARCH 2019

